

# 2827-2831 Chippewa Street Renovation

## New Orleans, Louisiana 70115

OWNER: JONATHON & MADELINE CRISCO  
2218 BIENVILLE STREET  
NEW ORLEANS, LOUISIANA 70119

ARCHITECT: ARCHETYPE, LLC  
ATTN: LACEY WOTRING  
LACEY.WOTRING@GMAIL.COM  
337.280.1089

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### BUILDING INFORMATION:

**BUILDING ADDRESS:**  
2827-2831 CHIPPEWA STREET  
NEW ORLEANS, LA 70115

**PROJECT DESCRIPTION:** RENOVATION OF AN EXISTING TWO-FAMILY RESIDENCE. NEW CAMELBACK AND REAR ADDITION. INTERIOR WORK INCLUDES MINOR INTERIOR DEMOLITION, NEW INTERIOR FINISHES, INCLUDING NEW BATHROOMS, AND NEW KITCHEN. NEW MECHANICAL, ELECTRICAL, AND PLUMBING SYSTEMS.

**PARCEL:** SQ. 81 LOT 4 A8'X182'= 8,736 SF

**BUILDING AREA**  
**EXISTING CONDITIONED SPACE:** 2,636 SF  
**ADDED CONDITIONED SPACE:** 733 SF  
**TOTAL CONDITIONED SPACE:** 3,396 SF

**EXISTING COVERED PORCH AREA:** 222 SF  
**ADDED COVERED PORCH AREA:** 576 SF

**FLOOD ZONE/FIRE DISTRICT**  
**FLOOD ZONE:** X  
**FIRE DISTRICT:** NO

**FOUNDATION:** EXISTING PIER FOUNDATION TO REMAIN - NEW TO MATCH EXISTING

**ZONING - CITY OF NEW ORLEANS**  
**ZONING DISTRICT:** HU-RD2  
**ZONING DESCRIPTION:** HISTORIC URBAN TWO- FAMILY RESIDENTIAL DISTRICT


**APPLICABLE CODES AND REGULATIONS:**  
(NOT LIMITED TO THE FOLLOWING)  
INTERNATIONAL RESIDENTIAL CODE, 2015 EDITION W/ NEW ORLEANS AMENDMENTS

**NO AUTOMATIC SPRINKLER SYSTEM**


**CONSTRUCTION TYPE**  
IBC TYPE VA  
NFPA TYPE V (111)

### LEGEND:

#### SYMBOLS

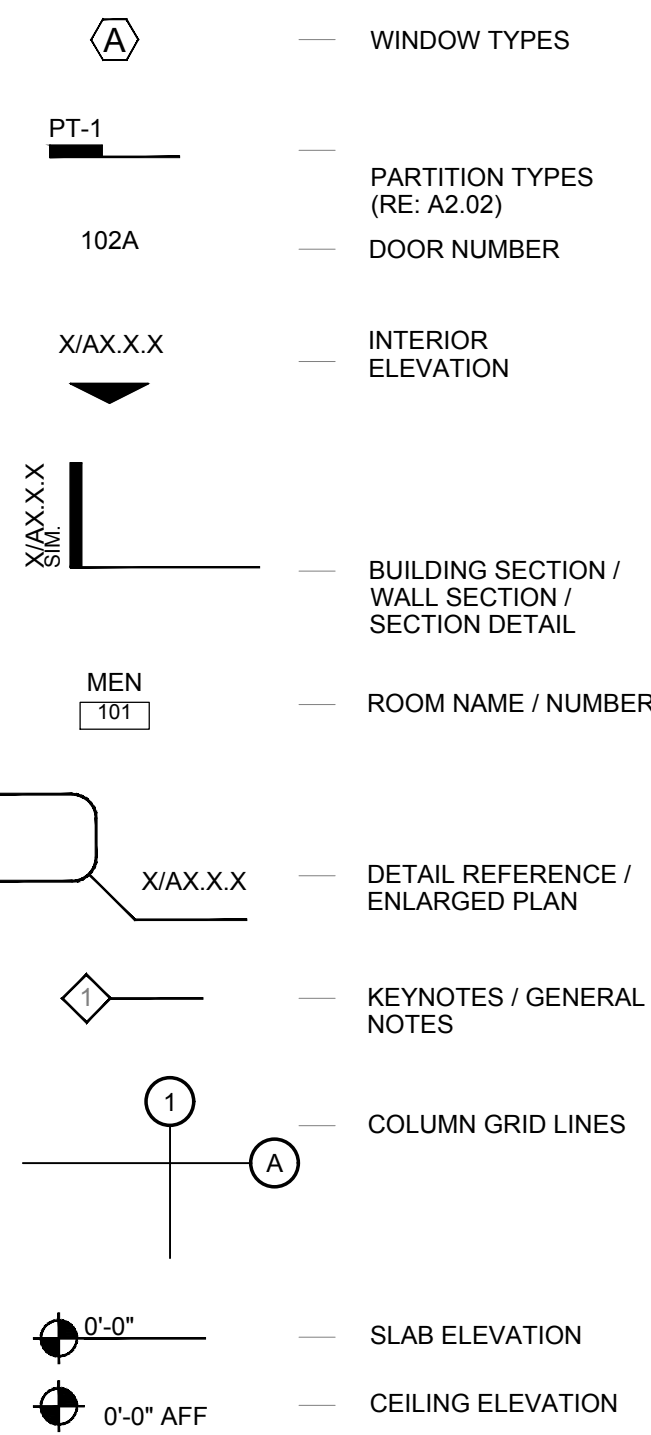

#### HATCH PATTERNS

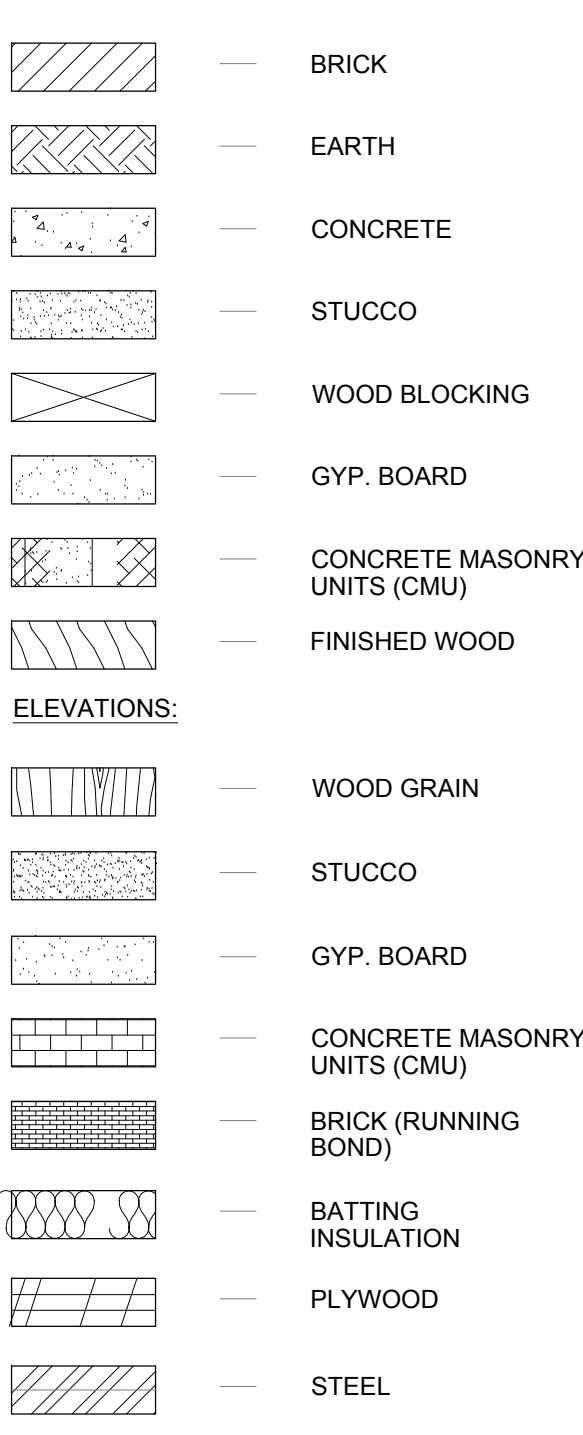

|                    |   |
|--------------------|---|
| ACT                | ACOUSTIC TILE CEILING                   |
| A.F.F.             | ABOVE FINISHED FLOOR                    |
| ALUM. /TEMP. GLASS | ALUMINUM TEMPERED GLASS                 |
| ANO. ALUM.         | ANODIZED ALUMINUM                       |
| BD.                | BOARD                                   |
| B.F.F              | BELOW FINISHED FLOOR                    |
| CPT                | CARPET                                  |
| CONC.              | CONCRETE                                |
| DIA.               | DIAMETER                                |
| F.O.B              | FACE OF BOARD                           |
| GYP.               | GYPSUM                                  |
| H.M.               | HOLLOW METAL                            |
| O.C.               | ON CENTER                               |
| PTD.               | PAINTED                                 |
| PTD. GYP.          | PAINTED GYPSUM BOARD                    |
| PTD. MR. GYP.      | PAINTED MOISTURE RESISTANT GYPSUM BOARD |
| SIM.               | SIMILAR                                 |
| S.C. WOOD          | SOLID CORE WOOD                         |
| T & G              | TONGUE AND GROOVE                       |
| TH.                | THICK                                   |
| TYP.               | TYPICAL                                 |
| VCT                | VINYL COMPOSITE TILE                    |
| V.O.F.             | VERIFY ON JOB                           |

#### GENERAL NOTES:

- SEE OTHER SHEETS FOR ADDITIONAL NOTES & SPECIFIC CONSTRUCTION NOTES.
- THE GENERAL CONTRACTOR AND SUBCONTRACTORS SHALL VISIT THE PROJECT SITE AND BECOME GENERALLY FAMILIAR WITH THE PROJECT AND WITH THE IMPACT OF THE NEW WORK ON EXISTING CONDITIONS. ANY AREAS OF CONCERN SHALL BE BROUGHT TO THE ATTENTION OF THE ARCHITECT PRIOR TO SUBMITTING A PROPOSAL. NO ADDITIONAL CHARGE TO THE OWNER WILL BE APPROVED WHICH IS ATTRIBUTABLE TO THE CONTRACTOR'S FAILURE TO MEET THIS REQUIREMENT.
- SURVEY EXISTING ARCHITECTURAL, MECHANICAL, ELECTRICAL, AND STRUCTURAL SYSTEM LOCATIONS AND COORDINATE WITH THE DOCUMENTS PRIOR TO SUBMITTING A PROPOSAL FOR THE WORK. VERIFY THAT ALL NEW CONSTRUCTION AND EQUIPMENT INSTALLATIONS ARE COMPATIBLE WITH BOTH THE CONTRACT DOCUMENTS AND FIELD CONDITIONS. ALL COST OF RELOCATING OR MODIFYING EQUIPMENT SHALL BE REFLECTED IN THE CONTRACTOR'S PROPOSAL. CHANGE ORDERS OR JOB EXTRAS FOR WORK SHALL NOT BE CONSIDERED IF VERIFICATION OF JOB CONDITIONS COULD HAVE BEEN MADE PRIOR TO SUBMITTING THE PROPOSAL.
- PROVIDE POSITIVE SEPARATION OF DIS-SIMILAR MATERIALS.
- WORK ONLY FROM THE WRITTEN DIMENSIONS SHOWN. DO NOT SCALE DRAWINGS. DETAIL DIMENSIONS TAKE PRECEDENCE OVER PLAN DIMENSIONS. LOCATION AND DIMENSIONS SHALL BE PER ARCHITECTURAL DRAWINGS. EXISTING CONDITIONS INDICATED ARE APPROXIMATE AND SHALL BE FIELD VERIFIED BY THE CONTRACTOR PRIOR TO PROCEEDING WITH ANY WORK. DISCREPANCIES MUST BE BROUGHT TO THE ATTENTION OF THE ARCHITECT BEFORE THE START OF WORK OR IMMEDIATELY UPON DISCOVERY.
- THE GENERAL CONTRACTOR SHALL KEEP THE CONSTRUCTION AREA CLEAN AND SAFE AND PROTECT ADJACENT AREAS OUTSIDE THE WORK AREA FROM THE WORK OF THIS CONTRACT.
- REMOVE AND LEGALLY DISPOSE OF DEBRIS, RUBBISH AND OTHER MATERIALS RESULTING FROM CONSTRUCTION OPERATIONS.
- THE GENERAL CONTRACTOR IS FULLY RESPONSIBLE FOR THE CONSTRUCTION, MATERIALS AND WORKMANSHIP OF THE PROJECT DESCRIBED IN THESE DRAWINGS AND NOTES, AND IS TO COMPLY WITH THE INTENT AS WELL AS THE LETTER IN WHICH THEY WERE WRITTEN.
- THE GENERAL CONTRACTOR SHALL PROVIDE ALL NECESSARY PROTECTION FOR HIS WORK UNTIL TURNED OVER TO THE OWNER.
- THE GENERAL CONTRACTOR IS RESPONSIBLE FOR COORDINATION WITH HIS SUBCONTRACTORS. ANY CONFLICTS WITH THEIR WORK, EQUIPMENT PLACEMENT, ETC. ARE TO BE RESOLVED PRIOR TO INSTALLATION OF THE WORK.
  - THE CONTRACTOR SHALL COORDINATE AND LOCATE ELECTRICAL DEVICES, DATA AND PHONE RECEPTACLES, SWITCHES, ETC. TO AVOID CONFLICTS WITH CASEWORK, DOORS AND OTHER TRADES.
  - THE CONTRACTOR SHALL VERIFY & COORDINATE, WITH ALL TRADES, THE SIZES AND LOCATIONS OF ALL OPENINGS FOR MECHANICAL, PLUMBING AND ELECTRICAL EQUIPMENT, EQUIPMENT PADS, OR BASES AS WELL AS POWER, WATER AND DRAIN INSTALLATIONS BEFORE PROCEEDING WITH THE WORK.
  - THE CONTRACTOR SHALL PROVIDE COORDINATION DRAWINGS FOR PROPER PLACEMENT OF ALL TRADES WORK. ALL CONCERNS, SPACE LIMITATIONS OR STRUCTURAL CONFLICTS SHALL BE BROUGHT TO THE IMMEDIATE ATTENTION OF THE ARCHITECT.
- CONTRACTOR SHALL SUBMIT SHOP DRAWINGS AND FINISH SAMPLES FOR ALL CASEWORK, MILLWORK, HARDWARE, FINISHES, AND SPECIALTY ITEMS TO ARCHITECT FOR REVIEW PRIOR TO FABRICATION.
- INSTALL ALL MANUFACTURED ITEMS, MATERIALS AND EQUIPMENT IN STRICT ACCORDANCE WITH MANUFACTURER'S RECOMMENDED SPECIFICATIONS.
- VARIATIONS FROM WORK SPECIFIED DUE TO AVAILABILITY OF MATERIALS, FIELD CONDITIONS, VARIATIONS IN EQUIPMENT SPECS, ETC. SHALL BE MADE WITH THE APPROVAL OF THE ARCHITECT AND OWNER.
- ALL WORK SHALL BE PERFORMED IN COMPLETE COMPLIANCE WITH ALL NATIONAL, STATE AND LOCAL CODES AND ORDINANCES AND IN ACCORDANCE WITH THE AGENCIES HAVING JURISDICTION. THE CONTRACTOR SHALL OBTAIN ALL NECESSARY PERMITS AND INSPECTIONS FOR THE WORK.
- IT IS THE INTENT OF THE DOCUMENTS TO PROVIDE FOR COMPLETE FINISHED WORK. ALL MISCELLANEOUS COMPONENTS, PARTS, ANCHORS, AND OTHER INCIDENTAL ITEMS REQUIRED FOR COMPLETE ASSEMBLY, FUNCTIONING AND OPERATION OF AN ITEM OR SYSTEM SHALL BE PROVIDED. THE CONTRACTOR SHALL INCLUDE ALL COMPONENTS THAT ARE NORMALLY INCIDENTAL TO THE WORK. THOSE COMPONENTS WHICH ARE NOT SHOWN ON THE DRAWINGS OR CALLED FOR IN THE SPECIFICATION, BUT WHICH ARE REQUIRED AS ESSENTIAL AESTHETICS OR FUNCTIONAL COMPONENT OF THE WORK, SHALL BE INCLUDED AS IF IT WERE DRAWN OR SPECIFIED.
- IT IS THE RESPONSIBILITY OF THE GENERAL CONTRACTOR TO PROVIDE IN A TIMELY MANNER, AT NO ADDITIONAL COST TO THE OWNER, ACCURATE AND COMPLETE DRAWINGS, SKETCHES, AND PHOTOGRAPHS SUFFICIENT TO CLEARLY DESCRIBE DISCREPANCIES, CONFLICTS AND CONCEALED OR OTHERWISE UNANTICIPATED EXISTING CONDITIONS ENCOUNTERED THAT AFFECTS THE NEW CONSTRUCTION.
- SECURE ALL PERMITS AND COMPLY WITH ALL APPLICABLE CODES AND REGULATIONS FOR SAFETY AND PROTECTION OF ADJACENT BUILDINGS AND OCCUPIED AREAS, DUST CONTROL, UTILITY DISCOVERED HAZARDS AND DISPOSAL. CONTACT APPROPRIATE AGENCIES PRIOR TO ANY BELOW GRADE EXCAVATIONS. NOTIFY OWNER AND PROTECT FROM DISTURBANCE ANY DISCOVERY OF SUSPECTED HAZARDOUS MATERIALS.
- FURNITURE INDICATED ON PLANS IS FOR REFERENCE AND COORDINATION PURPOSES.
- PROTECT ADJACENT PROPERTY AND PERSONS FROM THE WORK. WORKING OUTSIDE THE DESIGNATED LIMITS IS PROHIBITED UNLESS APPROVED BY THE CLIENT/USER.
- LIMIT NOISE TO NORMAL CONSTRUCTION OPERATIONS AND REGULATIONS.
- TO ESTABLISH THE COMPLETE SCOPE OF ITS WORK AND TO AFFECT CLOSE COORDINATION WITH THE OTHER TRADES, EACH TRADE SHALL VISIT THE SITE AND COMPLETELY REVIEW THE DRAWINGS NOT ONLY FOR ITS RESPECTIVE TRADE, BUT THE WORK OF OTHER RELATED TRADES AS WELL.
- IT IS THE RESPONSIBILITY OF THE CONTRACTOR TO IDENTIFY POINTS OF ACCESS TO THE SITE AND BUILDING AND TO VERIFY MINIMUM CLEARANCES AVAILABLE FOR USE IN TRANSPORTING NECESSARY CONSTRUCTION MACHINERY, EQUIPMENT, MATERIALS AND COMPONENTS INTO THE BUILDING AND ON THE SITE.
- THE CONTRACTOR SHALL PROTECT EXISTING UTILITIES AND SERVICES AGAINST INTERRUPTION DUE TO THIS WORK. NECESSARY DISRUPTIONS MUST BE COORDINATED IN ADVANCE OF NEED.
- VERIFY PROPERTY LINES, CONDITIONS, SERVICES AND DIMENSIONS BEFORE COMMENCING THE WORK.
- CONTRACTOR SHALL PROVIDE ALL SHORING AND STABILIZING BRACING AS REQUIRED TO PROTECT FROM STRUCTURAL FAILURE OR COLLAPSE. PROVIDE INTERIOR AND EXTERIOR BRACING OR SUPPORT TO PREVENT MOVEMENT, SETTLEMENT, OR COLLAPSE OF AREA BEING WORKED IN AND ADJACENT AREAS. CEASE OPERATIONS AND NOTIFY ARCHITECT IMMEDIATELY IF SAFETY OF STRUCTURE APPEARS TO BE ENDANGERED. TAKE PRECAUTIONS TO SUPPORT STRUCTURE UNTIL DETERMINATION IS MADE TO CONTINUE OPERATIONS.
- PROVIDE SECURITY AND FACILITIES TO PROTECT SITE AREA, EXISTING FACILITY AND EQUIPMENT FROM UNAUTHORIZED ENTRY, VANDALISM OR THEFT DURING THE WORK. CONTRACTOR SHALL BE SOLELY RESPONSIBLE FOR THE SECURITY OF HIS/HER OWN EQUIPMENT AND TOOLS.
- THE COST FOR CONNECTION TO AND POWER LINES FROM AVAILABLE POWER SOURCE SHALL BE AT CONTRACTOR'S SOLE EXPENSE.
- PROVIDE TEMPORARY LIGHTING AS REQUIRED; CONNECT TO TEMPORARY ELECTRIC SERVICE.
- PROVIDE TEMPORARY VENTILATION TO PROTECT WORKERS AS REQUIRED.
- CONNECT TO EXISTING WATER SOURCE FOR TEMPORARY WATER SERVICE. IF UTILITY IS CAPPED, COORDINATE WITH OWNER.
- PROVIDE TEMPORARY SANITARY FACILITIES.
- MAINTAIN FIRE SAFETY/CONTROL AT ALL TIMES.



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CRISCO RESIDENCE  
2827-2831 CHIPPEWA STREET  
NEW ORLEANS, LOUISIANA 70115

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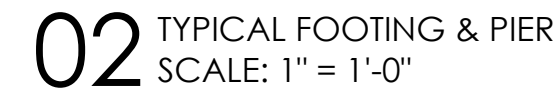
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1. ALL PILES SHALL BE 36" OOT TREATED TIMBER PILES CONFORMING TO ASTM D25 WITH A MINIMUM TIP DIAMETER OF 6 INCHES AND A NATURAL TAPER TO THE BUTT. DESIGN LOAD IS 4 TONS PER PILE IN ACCORDANCE WITH SOIL TYPE 1.
2. ALL CONCRETE SHALL BE STANDARD WEIGHT AND SHALL BE SET AT 3000 PSI AT 28 DAYS. IT SHALL BE IN ACCORDANCE WITH THE LATEST EDITIONS OF ACI 301 AND 318.
3. REINFORCING STEEL SHALL BE NEW BILLET ASTM A615 GRADE 60. DETAIL REINFORCING AND PROVIDE 3D ACCESSORIES IN ACCORDANCE WITH THE LATEST ACI MANUAL OF STANDARD PRACTICE. PROVIDE 3D DIAMETER LAP SPLICES AT ALL DISCONTINUOUS TOP BARS. PROVIDE CORNER BARS SAME SIZE AND NUMBER AS OUTSIDE BEAM BARS WITH 3D DIAMETER LAP EACH WAY.
4. REINFORCING CLEARANCES ARE REQUIRED AS FOLLOWS:
  - SLAB: 1" CLEAR BOTTOM AND 3/4" CLEAR TOP
  - BEAMS: 1 1/2" CLEAR IF FORMED AND 3" CLEAR IF EARTH FORMED
5. PLACE ONE LAYER OF 10 MIL POLYETHYLENE VAPOR/MOISTURE BARRIER BENEATH ALL SLABS AND BEAMS ON GRADE.


01 FOUNDATION PLAN  
SCALE: 1/4" = 1'-0"

CHRISTOPHER RESIDENCE  
2827-2831 CHIPPEWA STREET  
NEW ORLEANS, LOUISIANA 70115

# S1.0




02 SECOND FLOOR FRAMING PLAN  
SCALE: 1/4" = 1'-0"

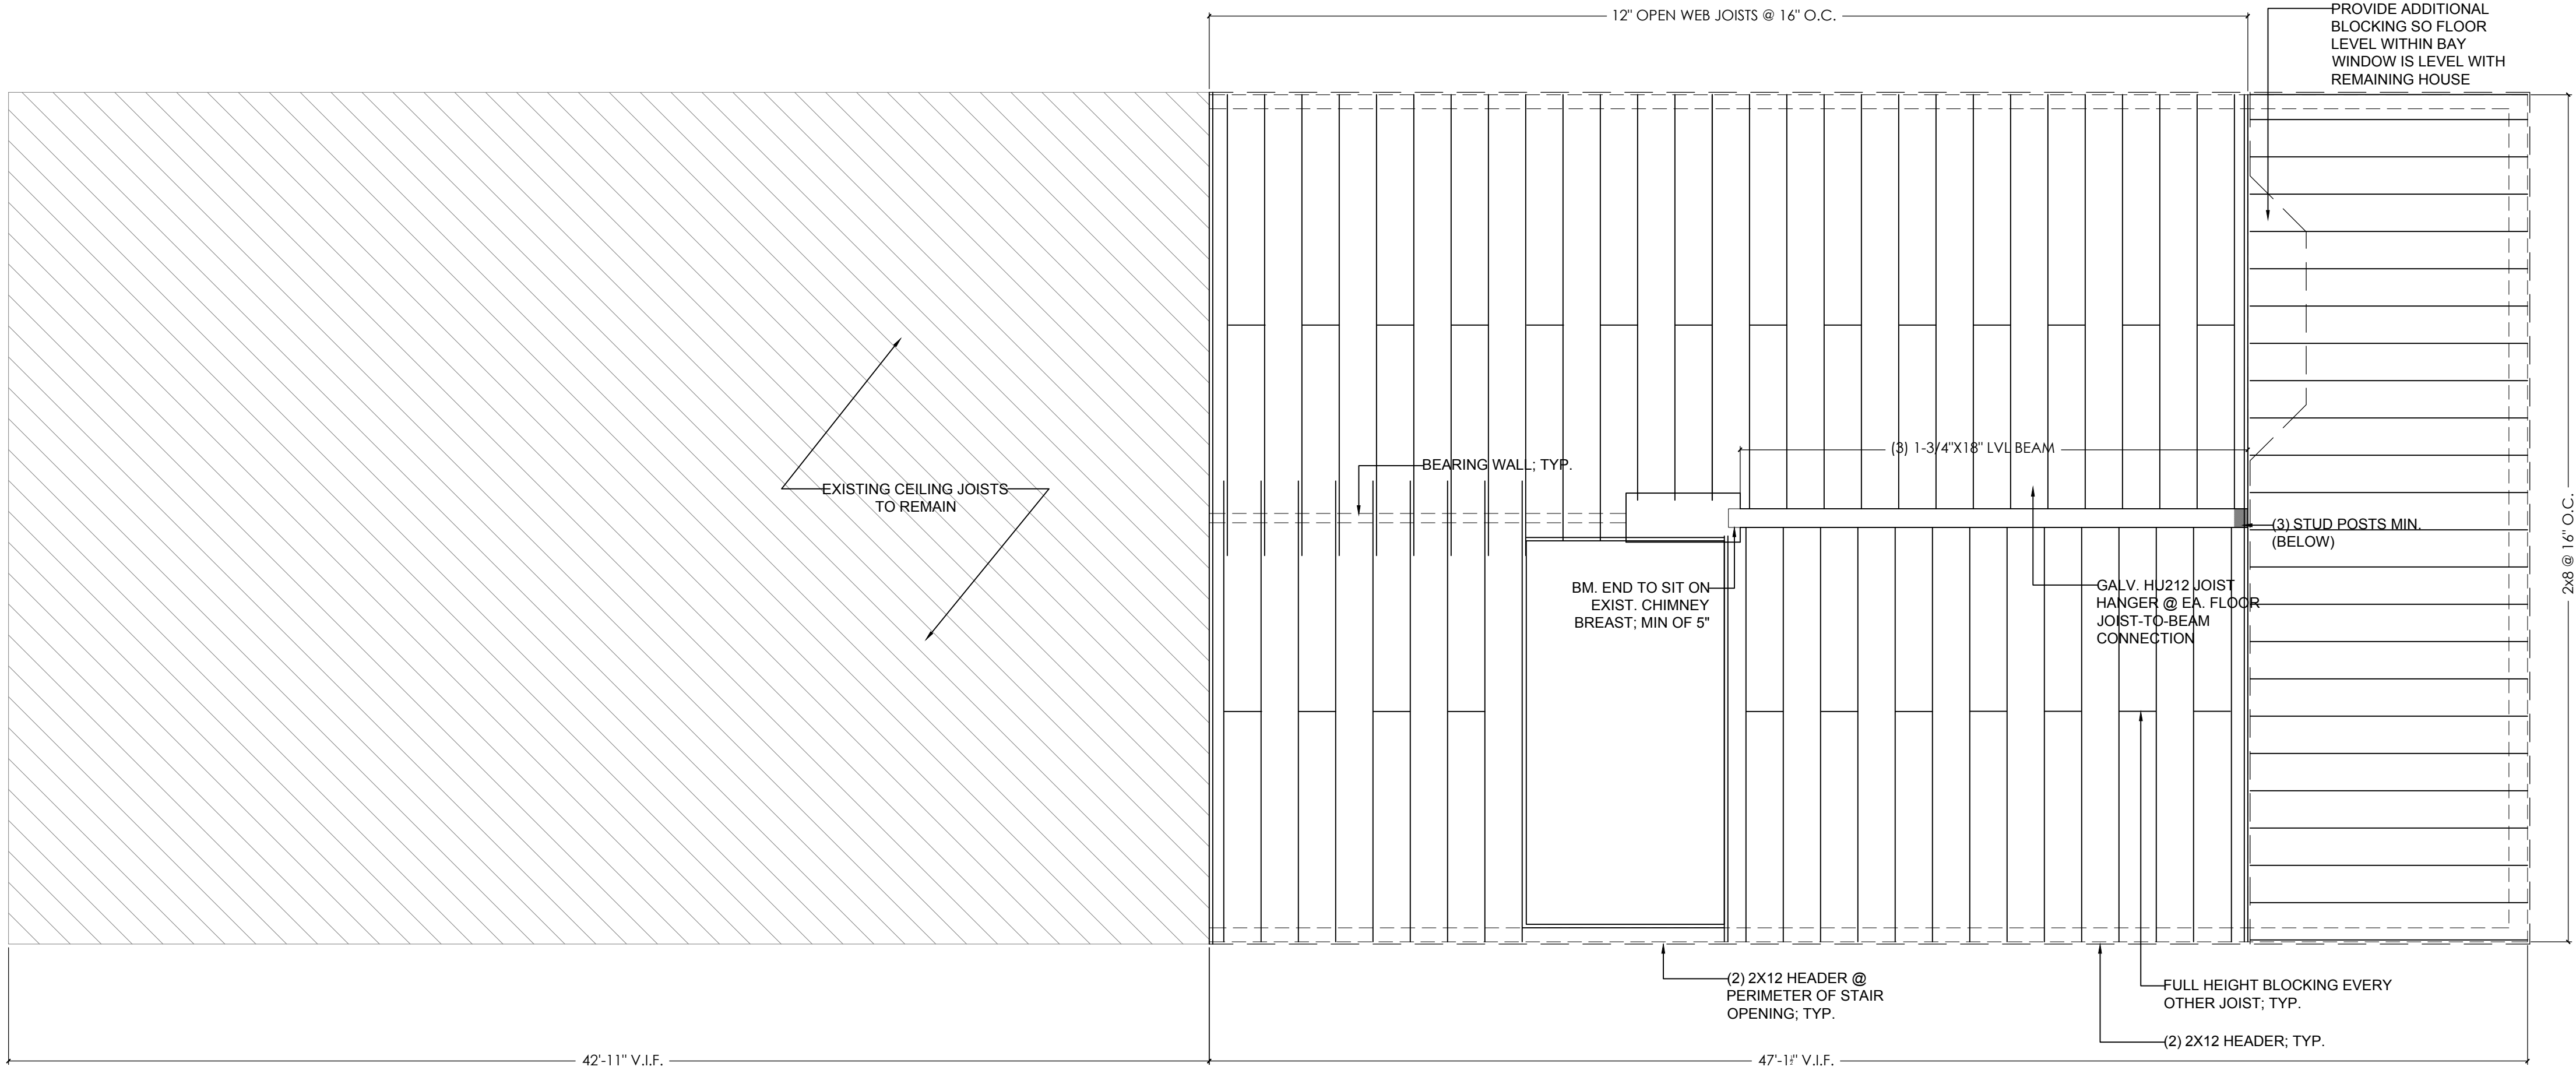

FRAMING NOTES:

1. ALL WOOD CONNECTIONS SHALL BE IN ACCORDANCE WITH THE FASTENING SCHEDULE OF THE INTERNATIONAL RESIDENTIAL BUILDING CODE
2. LUMBER IN CONTACT CONCRETE OR MASONRY SHALL BE TREATED
3. FRAMING LUMBER SHALL BE SOUTHERN YELLOW PINE S4S NO. 2 MAX MOISTURE CONTENT OF 15%, UNLESS OTHERWISE SPECIFIED
4. STUD WALLS AND PARTITIONS SHALL BE SIZED AS FOLLOWS, UNLESS OTHERWISE SPECIFIED:  
EXTERIOR WALLS 2X4 @ 16" O.C.  
FLOOR PARTITIONS 2X4 @ 16" O.C.  
WET WALLS 2X6 @ 16" O.C.
5. BLOCK ALL STUDS AT THE MIDPOINT
6. FULL HEIGHT BLOCKING AT FLOOR JOIST MIDPOINT WHERE INDICATED
7. PROVIDE WOOD COLLAR BRACES AT EACH RAFTER 12" BELOW CROWN OR ROOF
8. PLYWOOD SHEATHING TO BE APA RATED 24/0,  $\frac{5}{8}$ " THICK. NAIL WITH 8D NAILS SPACED AT 6" O.C. AT PANEL EDGES AND 12" O.C. AT INTERMEDIATE SUPPORTS. PROVIDE PLY CLIPS AT UNSUPPORTED EDGES BETWEEN ROOF JOISTS
9. WIND BRACING TO BE APA RATED 4'X8'X $\frac{5}{8}$ " PLYWOOD ON ALL EXTERIOR WALL CORNERS. NAIL PLYWOOD EDGES WITH 8D NAILS AT 4" O.C. AT PANEL EDGES AND 12" O.C. AT INTERMEDIATE SUPPORTS. PROVIDE SOLID BLOCKING AT PANEL EDGES
10. COORDINATE FRAMING WITH HVAC DUCTS, ELECTRICAL, AND PLUMBING EQUIPMENT REQUIREMENTS

01 FIRST FLOOR FRAMING PLAN  
SCALE: 1/4" = 1'-0"

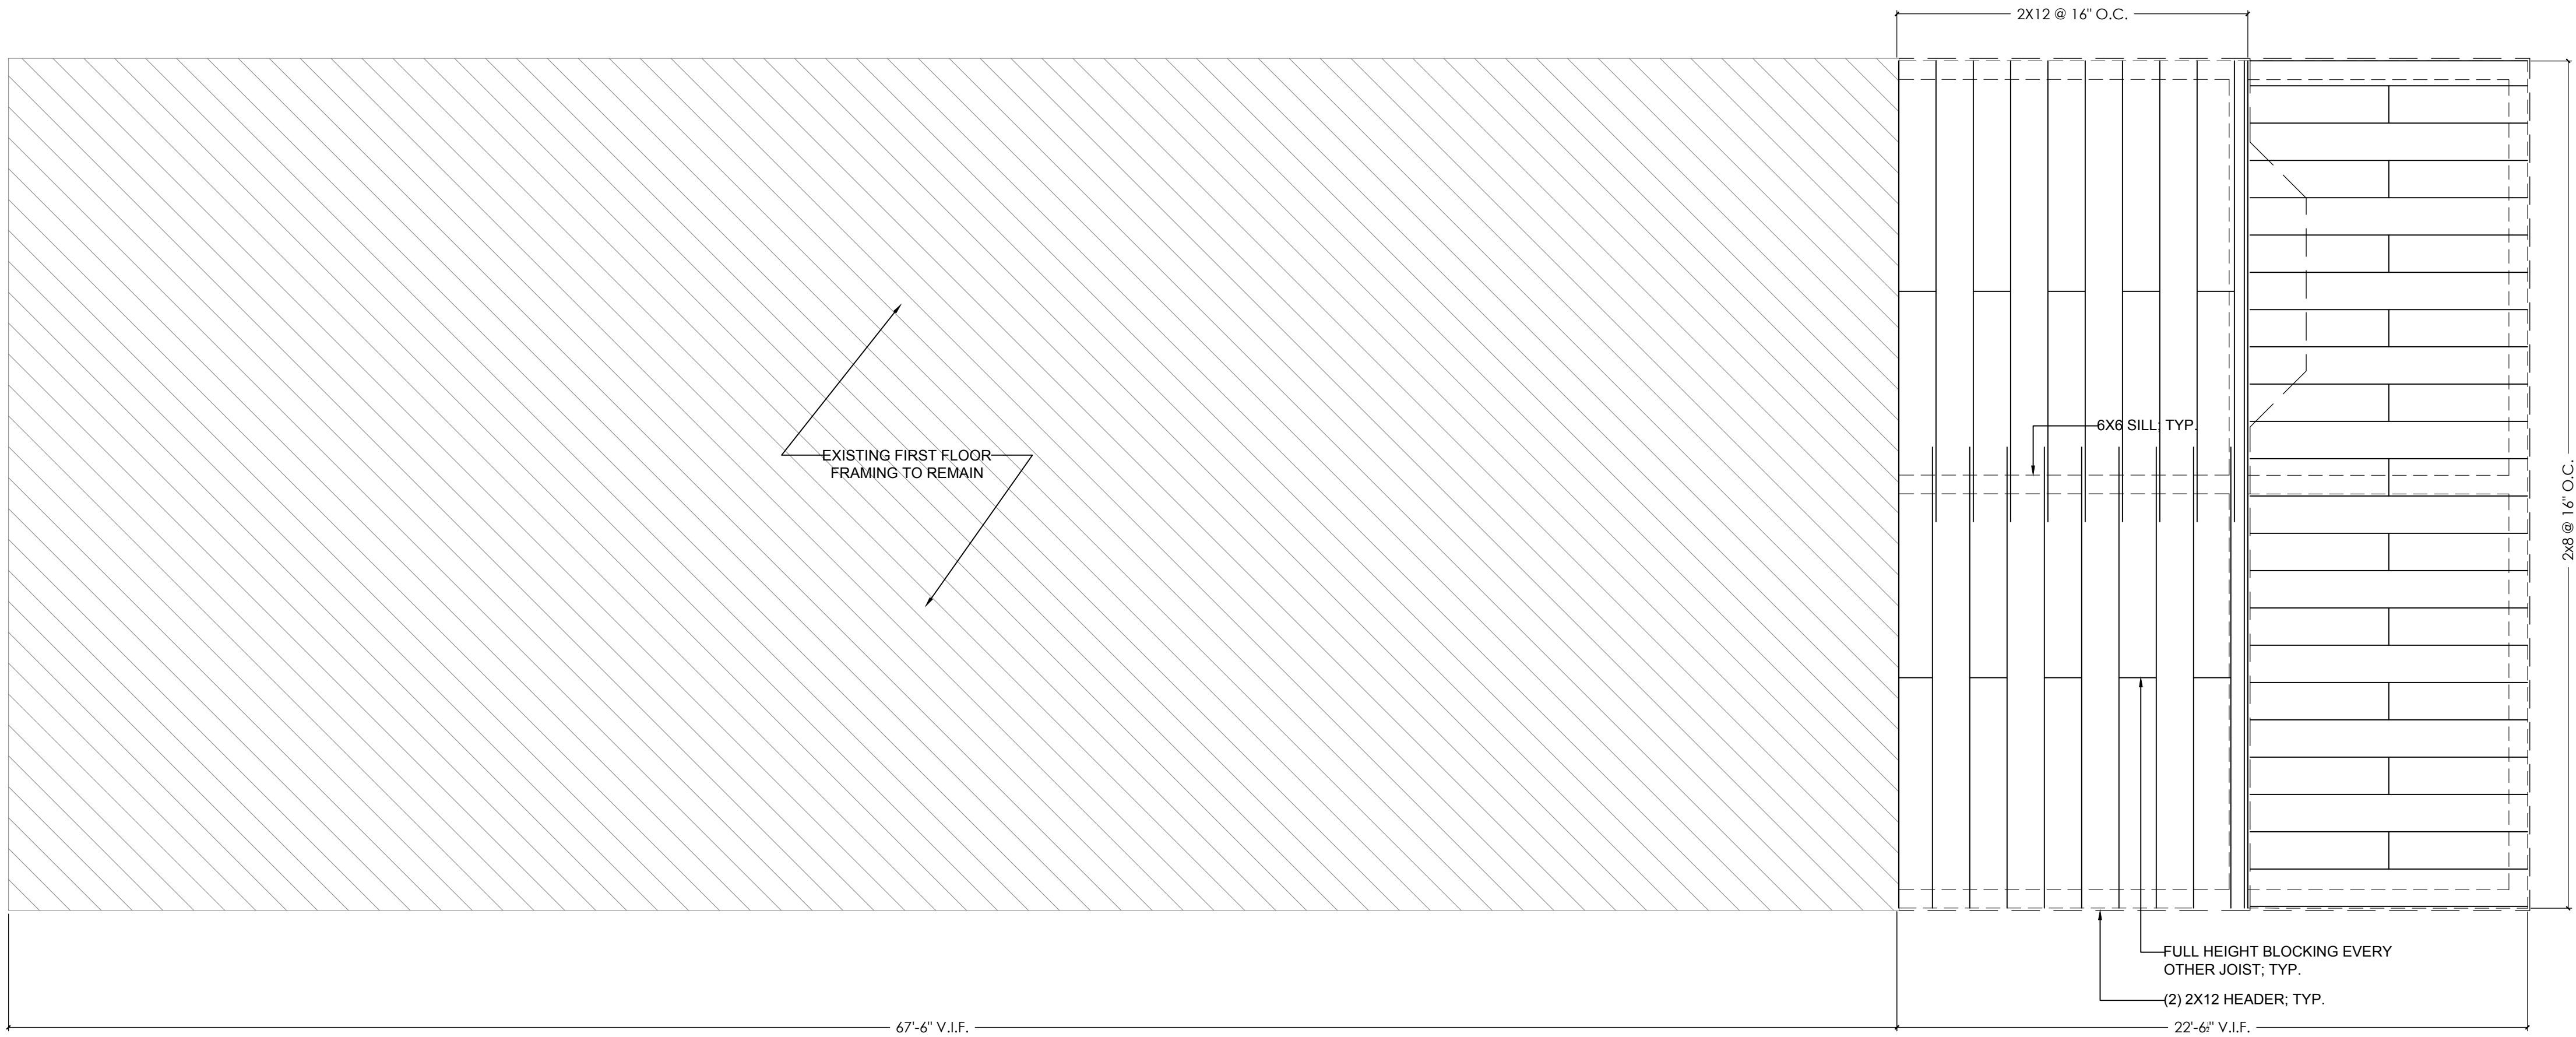

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FRAMING PLANS


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02 ROOF FRAMING PLAN

SCALE: 1/4" = 1'-0"




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10. COORDINATE FRAMING WITH HVAC DUCTS, ELECTRICAL, AND PLUMBING EQUIPMENT REQUIREMENTS

01 SECOND FLOOR CEILING FRAMING PLAN

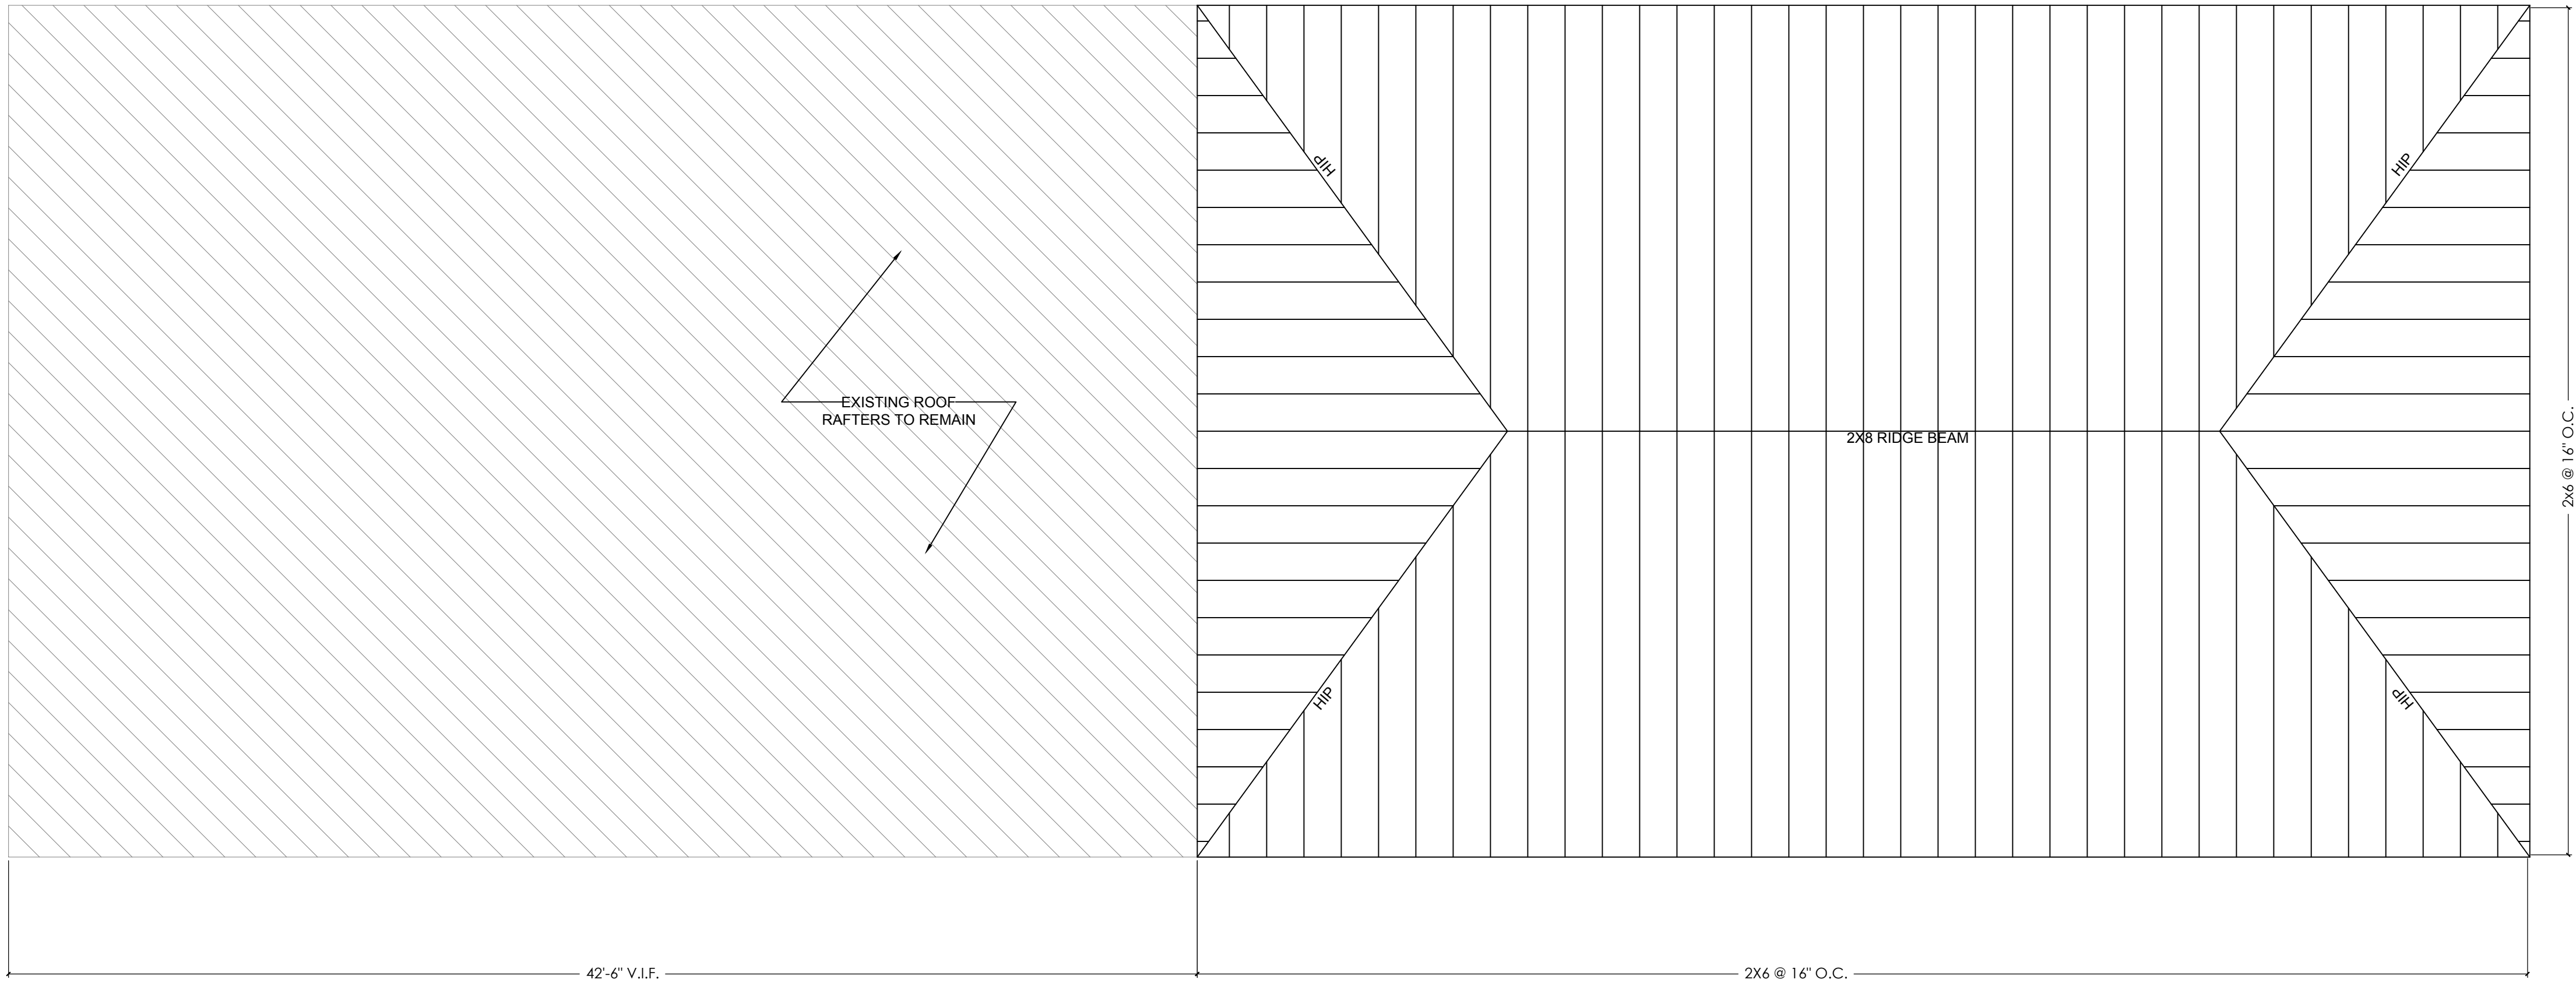SCALE: 1/4" = 1'-0"

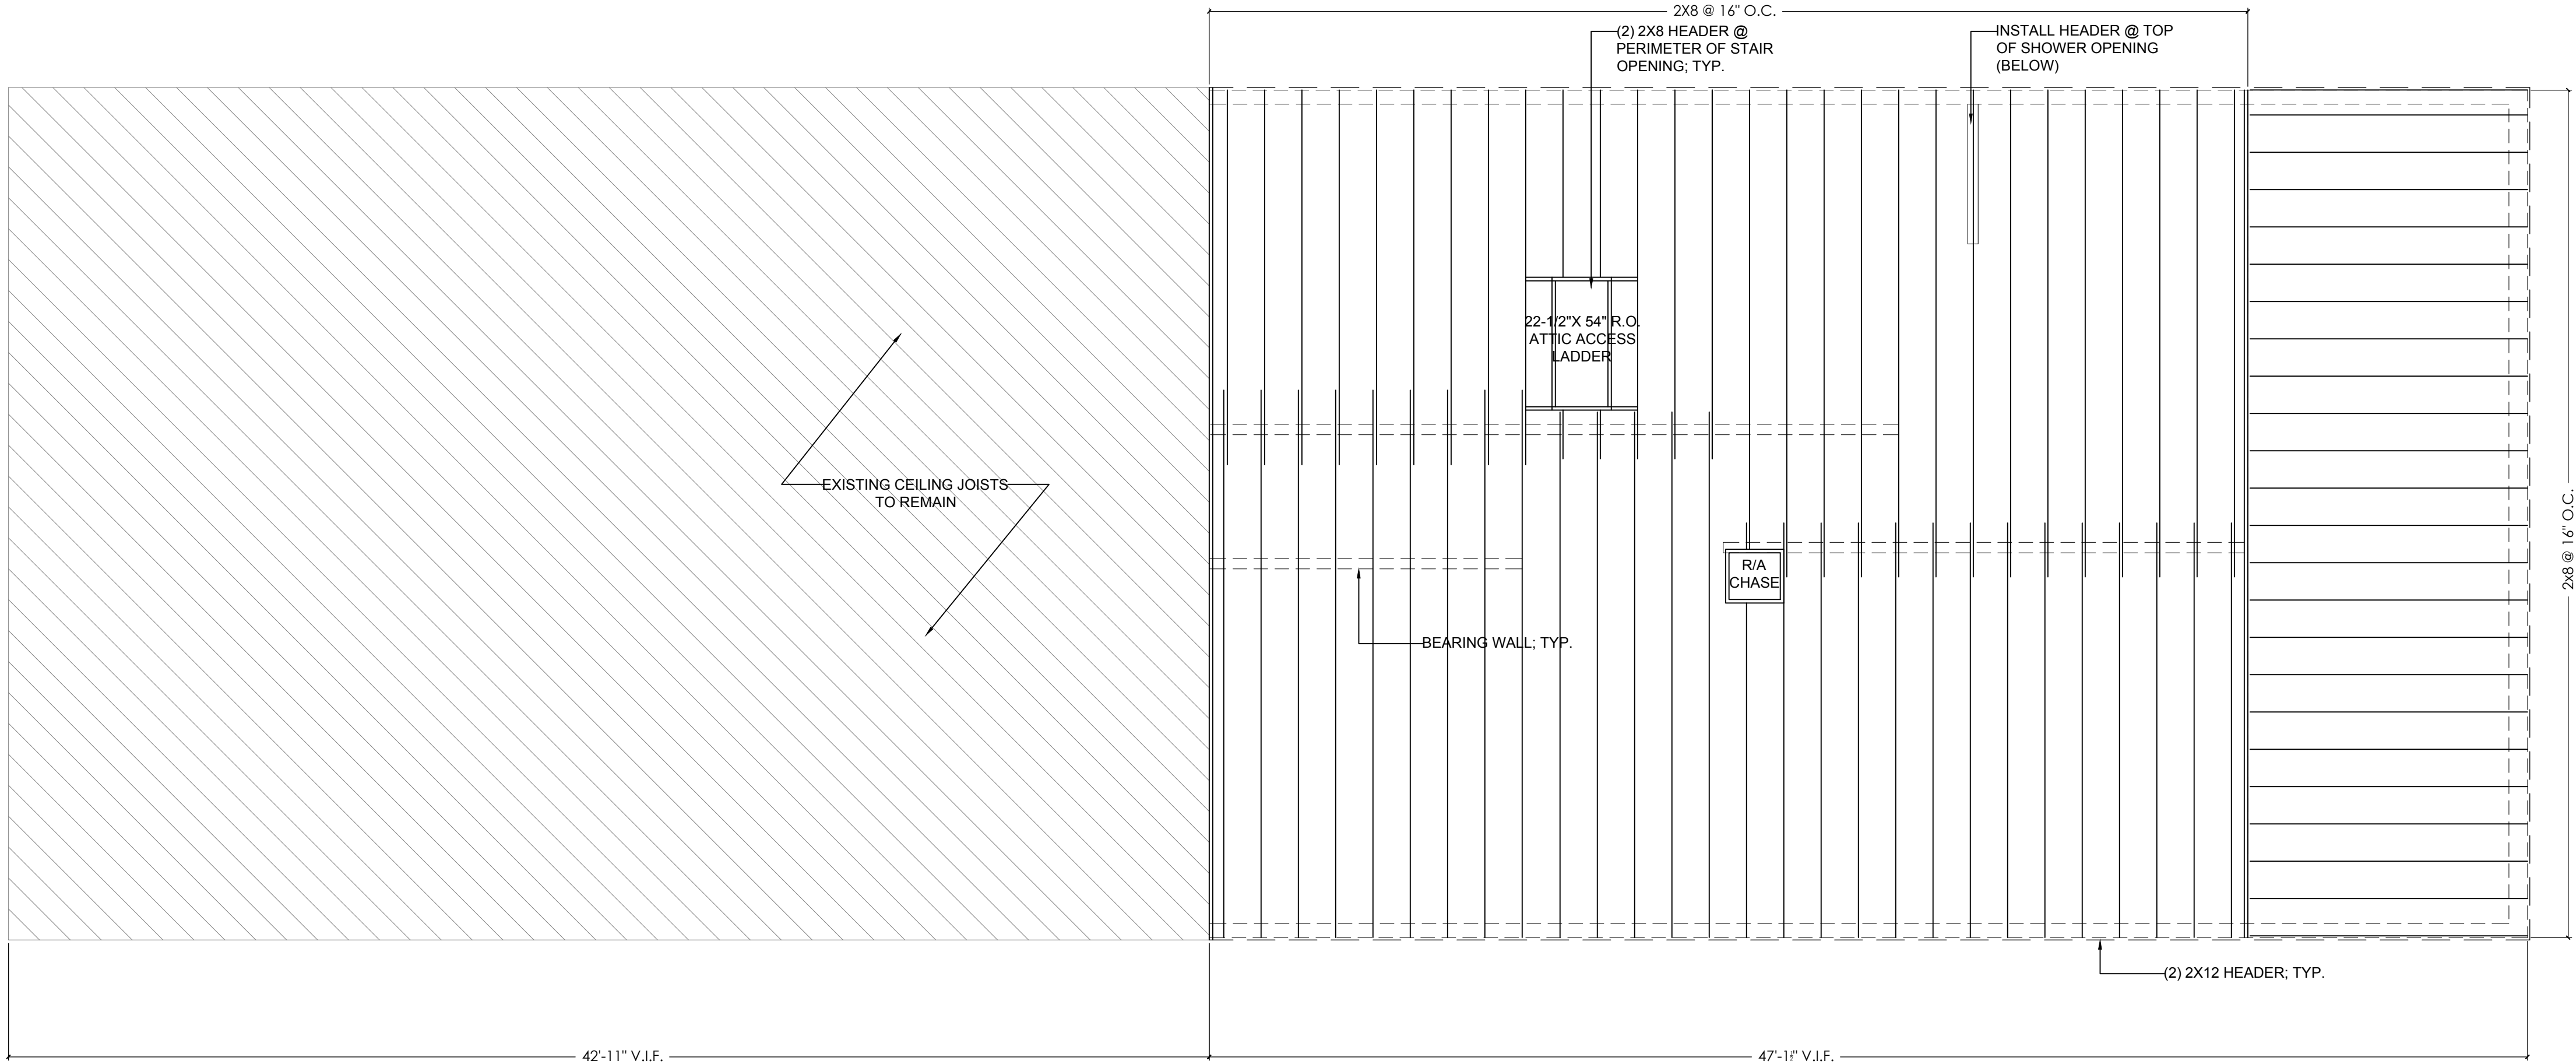

ARCHETYPE

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NEW ORLEANS, LOUISIANA 70115

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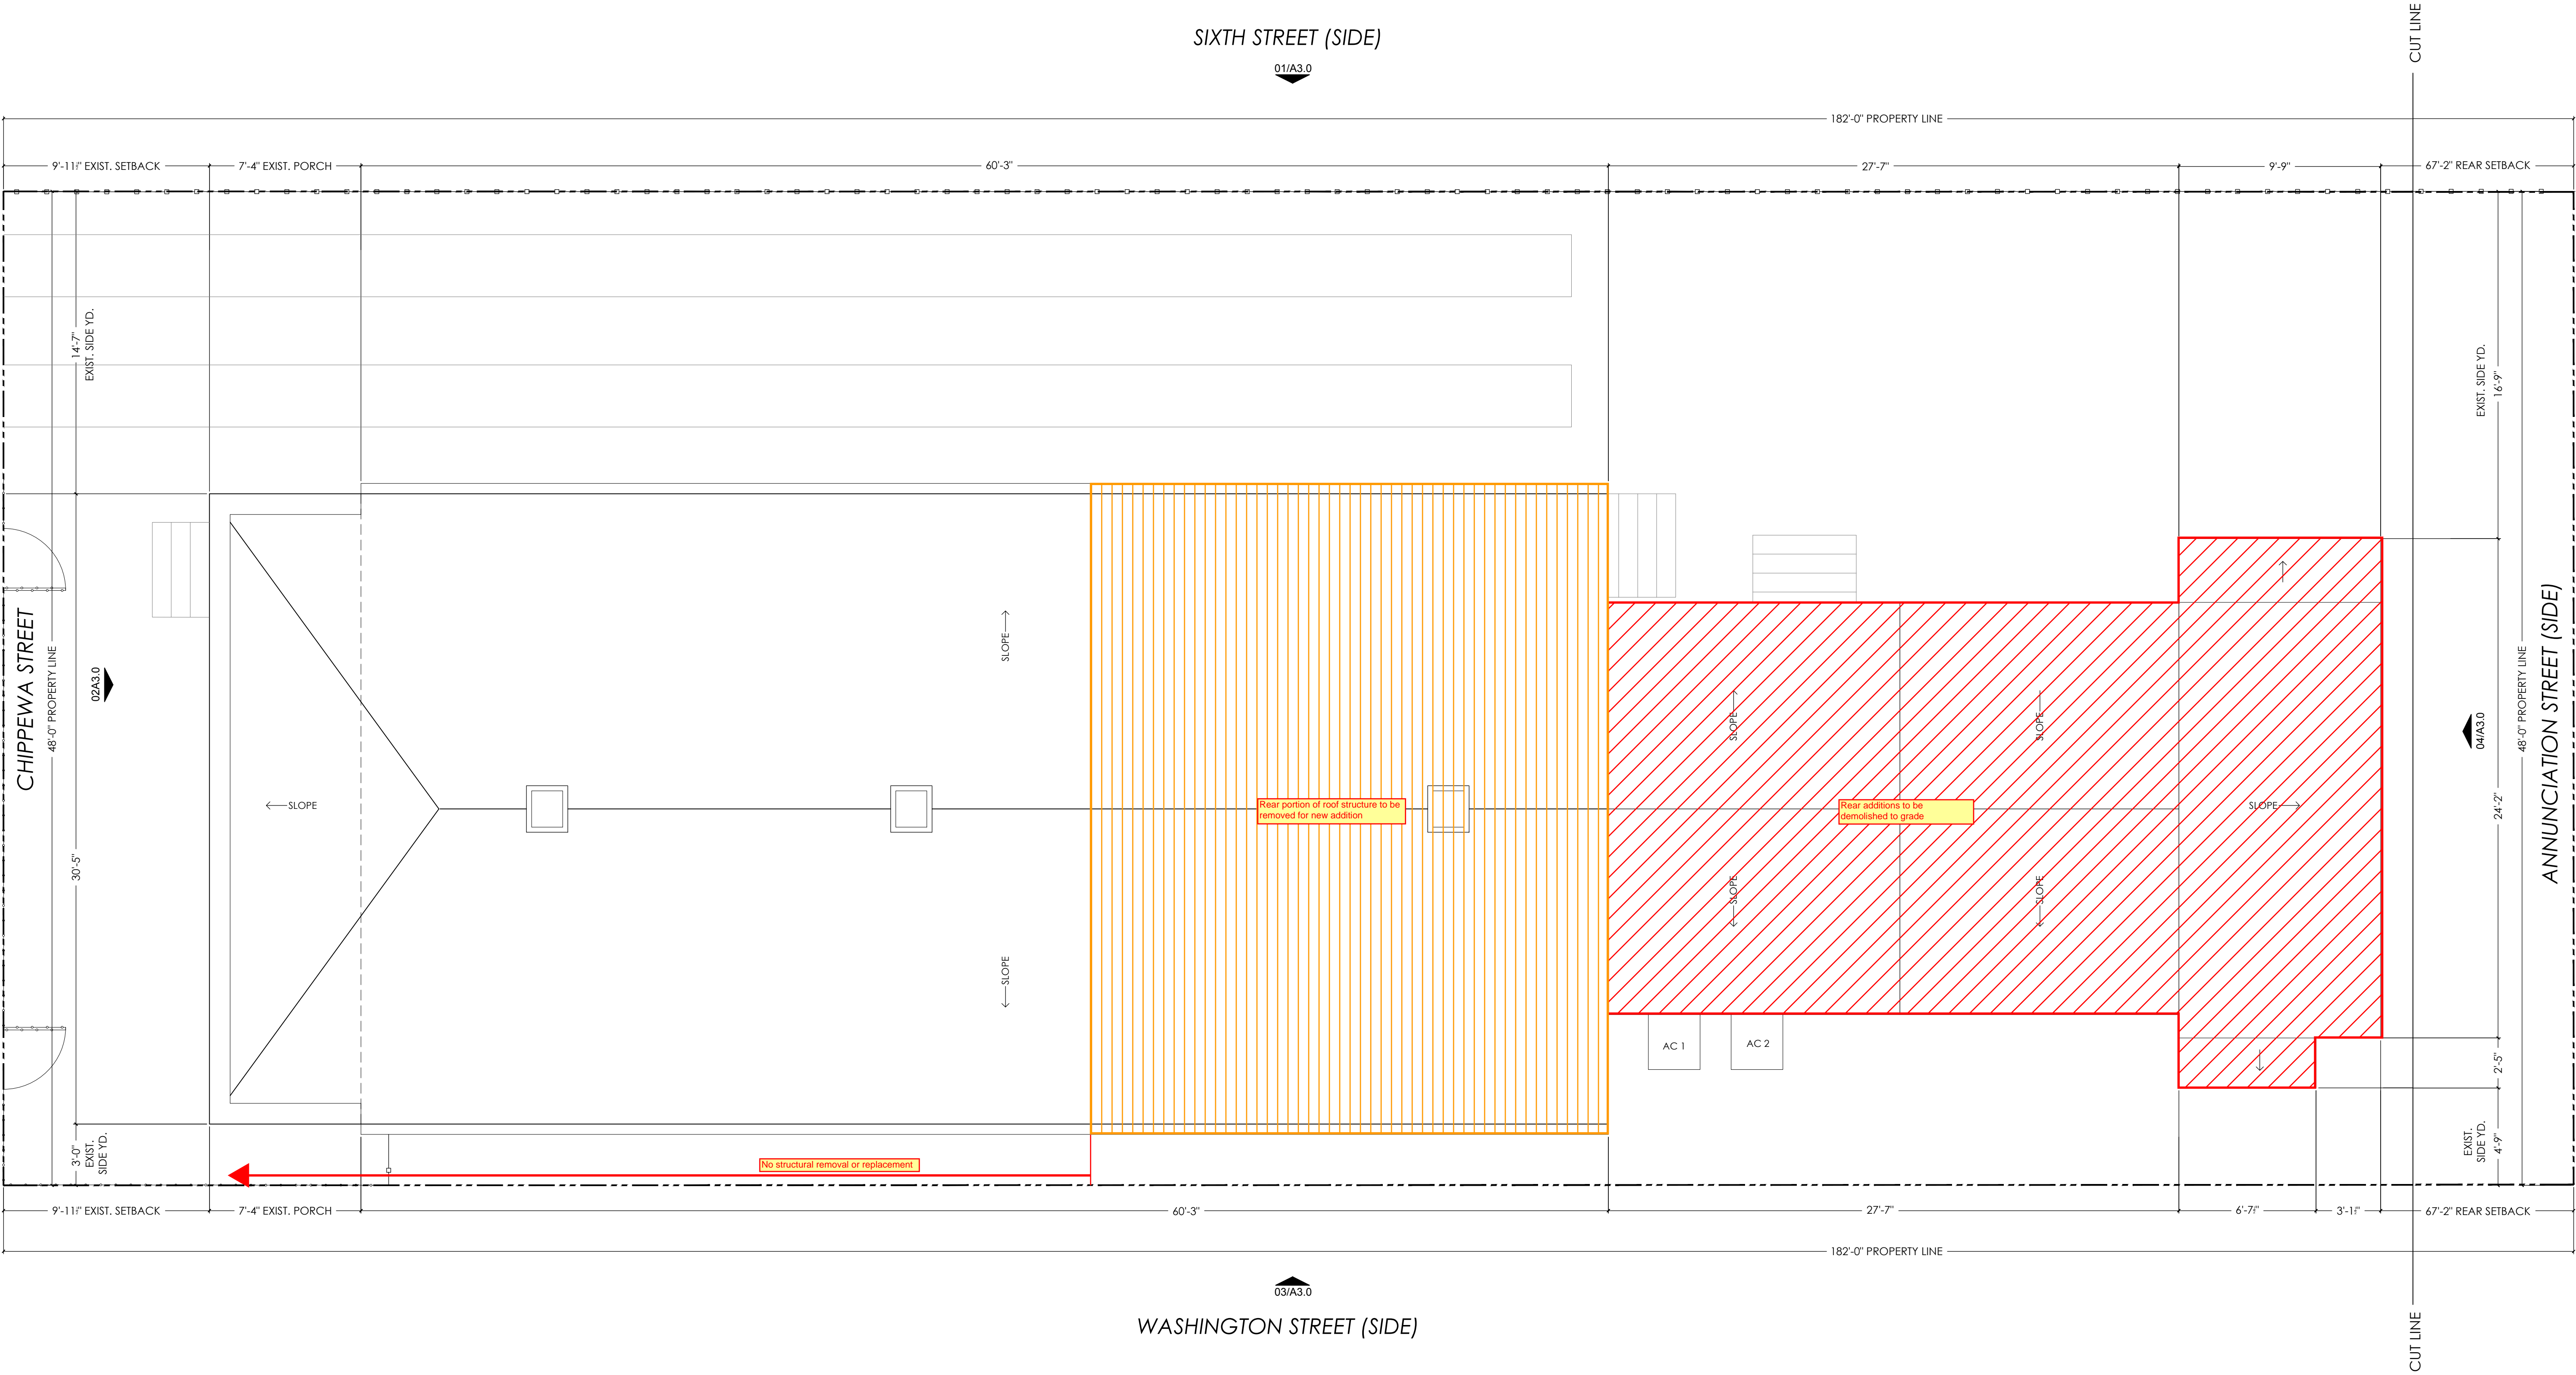
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FRAMING PLANS

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EXISTING ROOF PLAN

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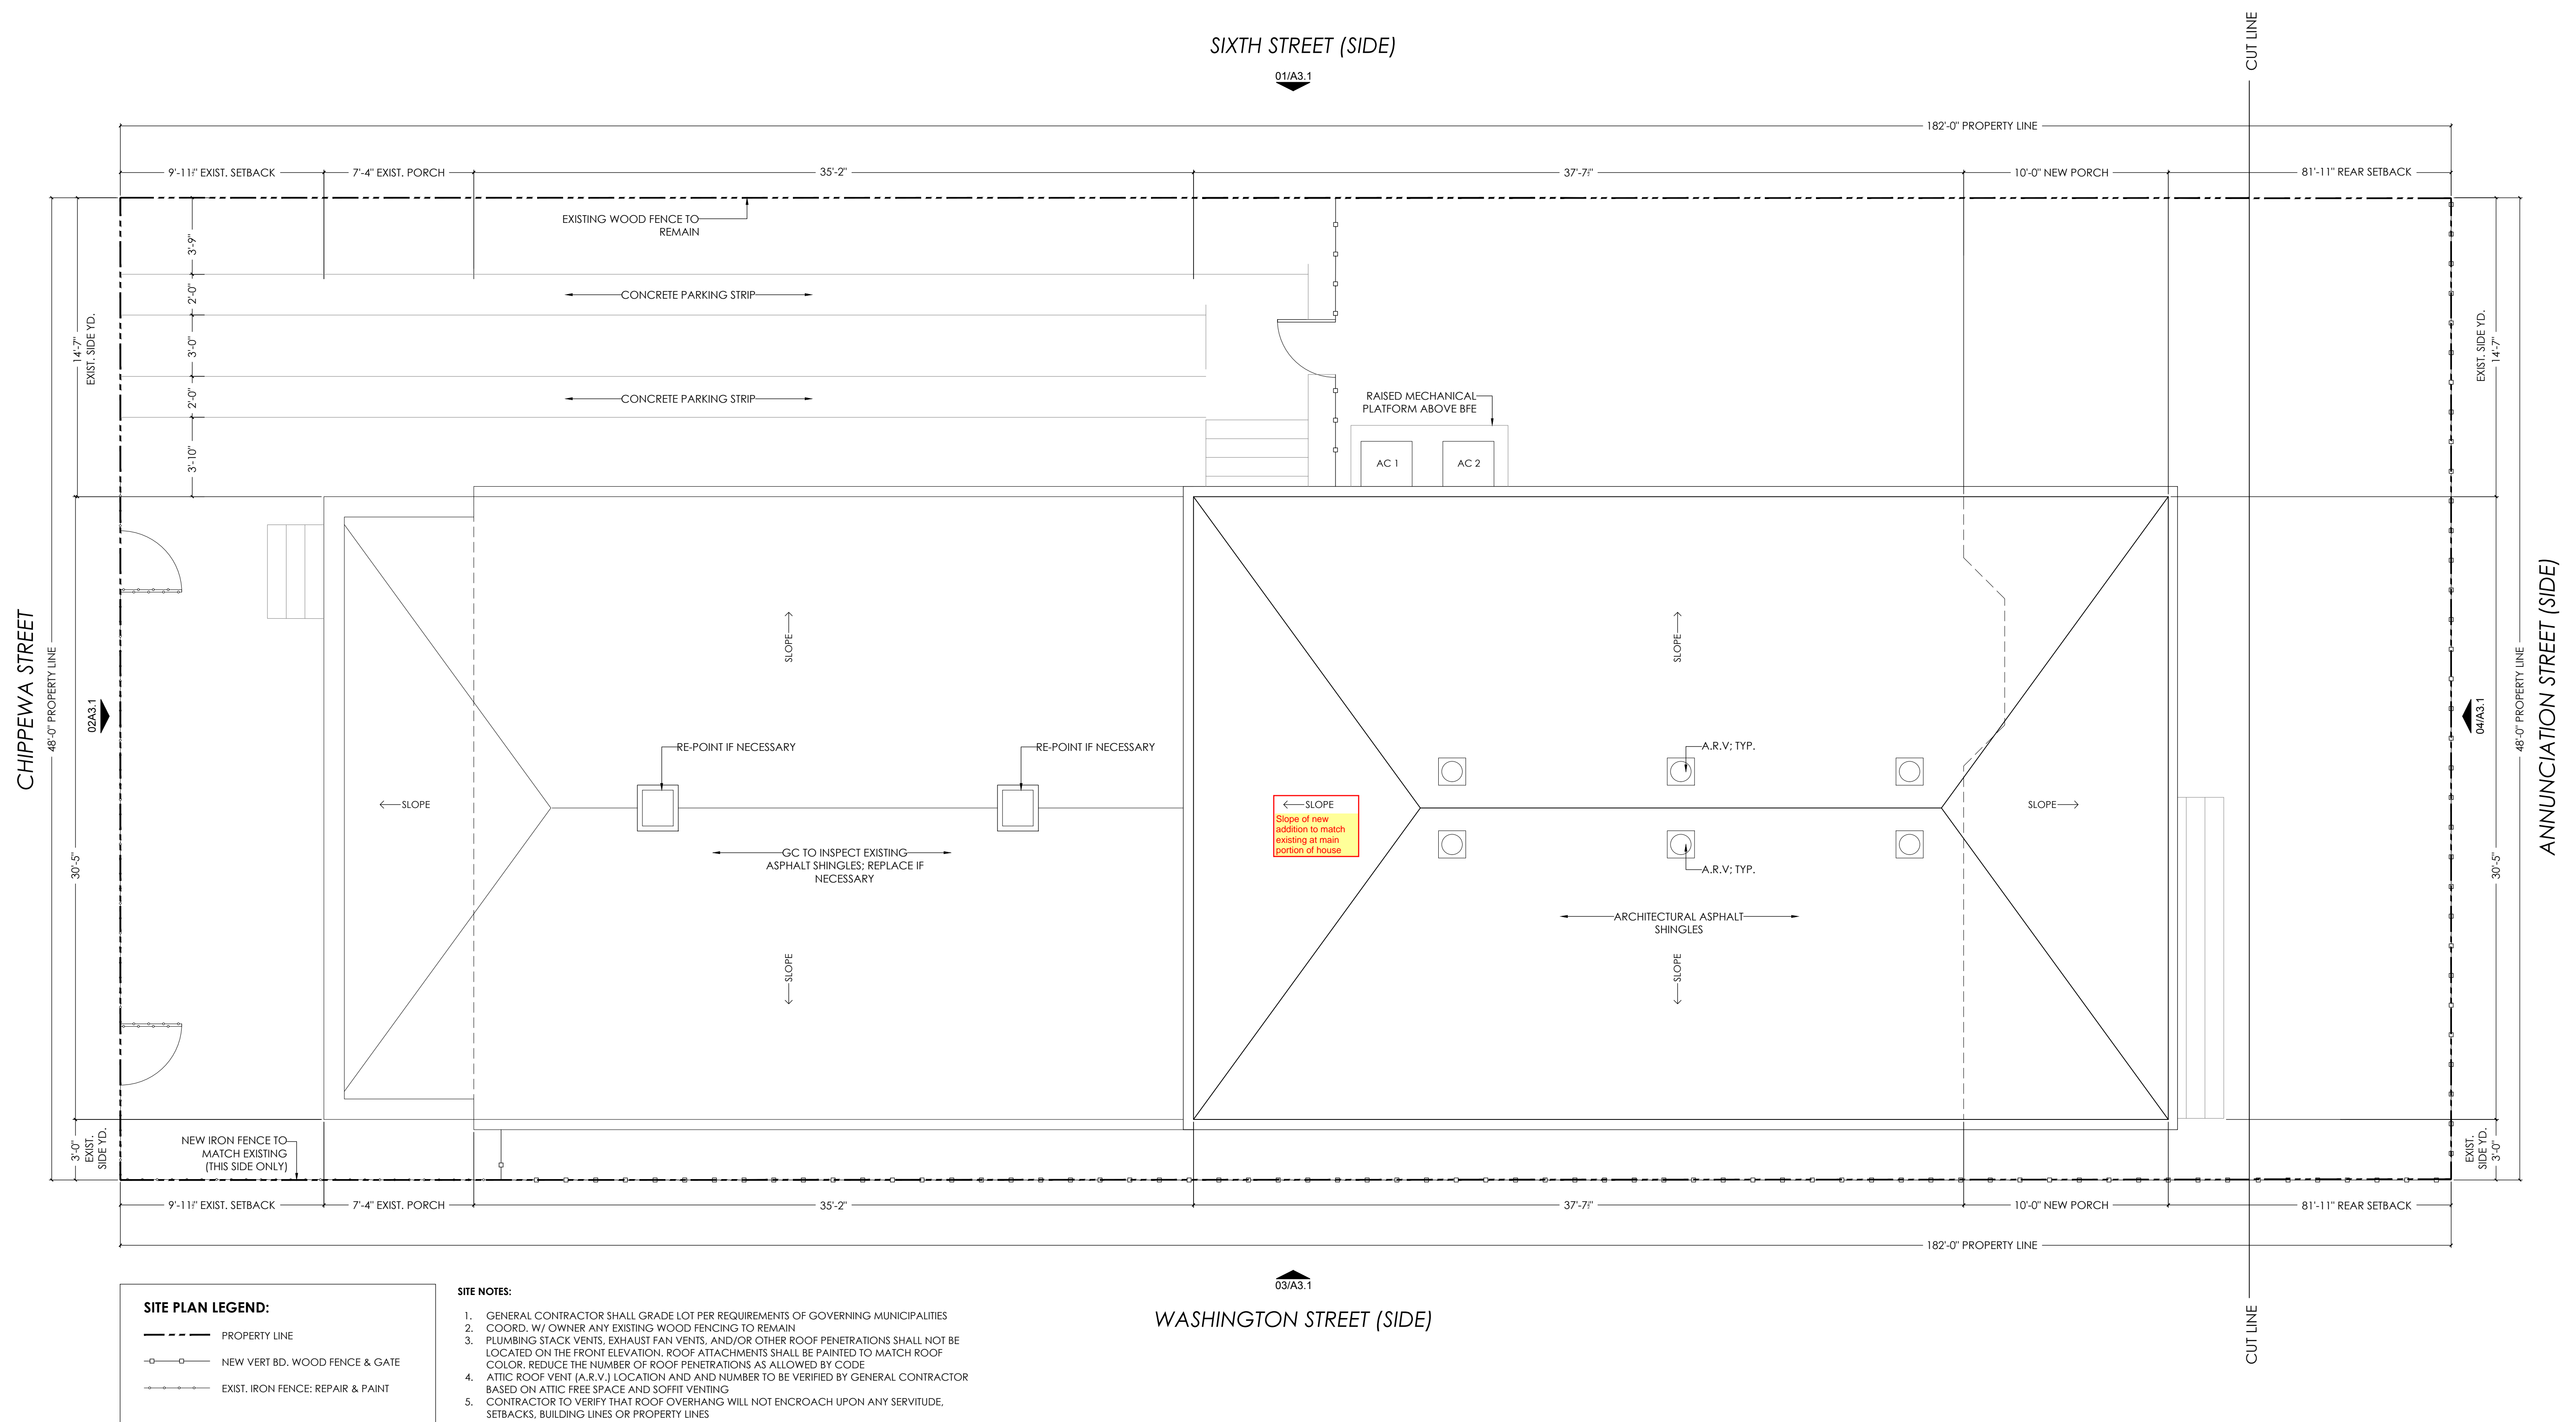


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PROPOSED ROOF PLAN

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**SITE PLAN LEGEND:**

 PROPERTY LINE  
 NEW VERT BD. WOOD FENCE & GATE  
 EXIST. IRON FENCE: REPAIR & PAINT

**SITE NOTES:**

1. GENERAL CONTRACTOR SHALL GRADE LOT PER REQUIREMENTS OF GOVERNING MUNICIPALITIES
2. COORD. W/ OWNER ANY EXISTING WOOD FENCING TO REMAIN
3. PLUMBING STACK VENTS, EXHAUST FAN VENTS, AND/OR OTHER ROOF PENETRATIONS SHALL NOT BE LOCATED ON THE FRONT ELEVATION. ROOF ATTACHMENTS SHALL BE PAINTED TO MATCH ROOF COLOR. REDUCE THE NUMBER OF ROOF PENETRATIONS AS ALLOWED BY CODE
4. ATTIC ROOF VENT (A/E) LOCATION AND NUMBER TO BE VERIFIED BY GENERAL CONTRACTOR BASED ON ATTIC FREE SPACE AND SOFFIT VENTING
5. CONTRACTOR TO VERIFY THAT ROOF OVERHANG WILL NOT ENCRATCH UPON ANY SERVITUDE, SETBACKS, BUILDING LINES OR PROPERTY LINES

01 PROPOSED ROOF PLAN  
SCALE: 1/4" = 1'-0"





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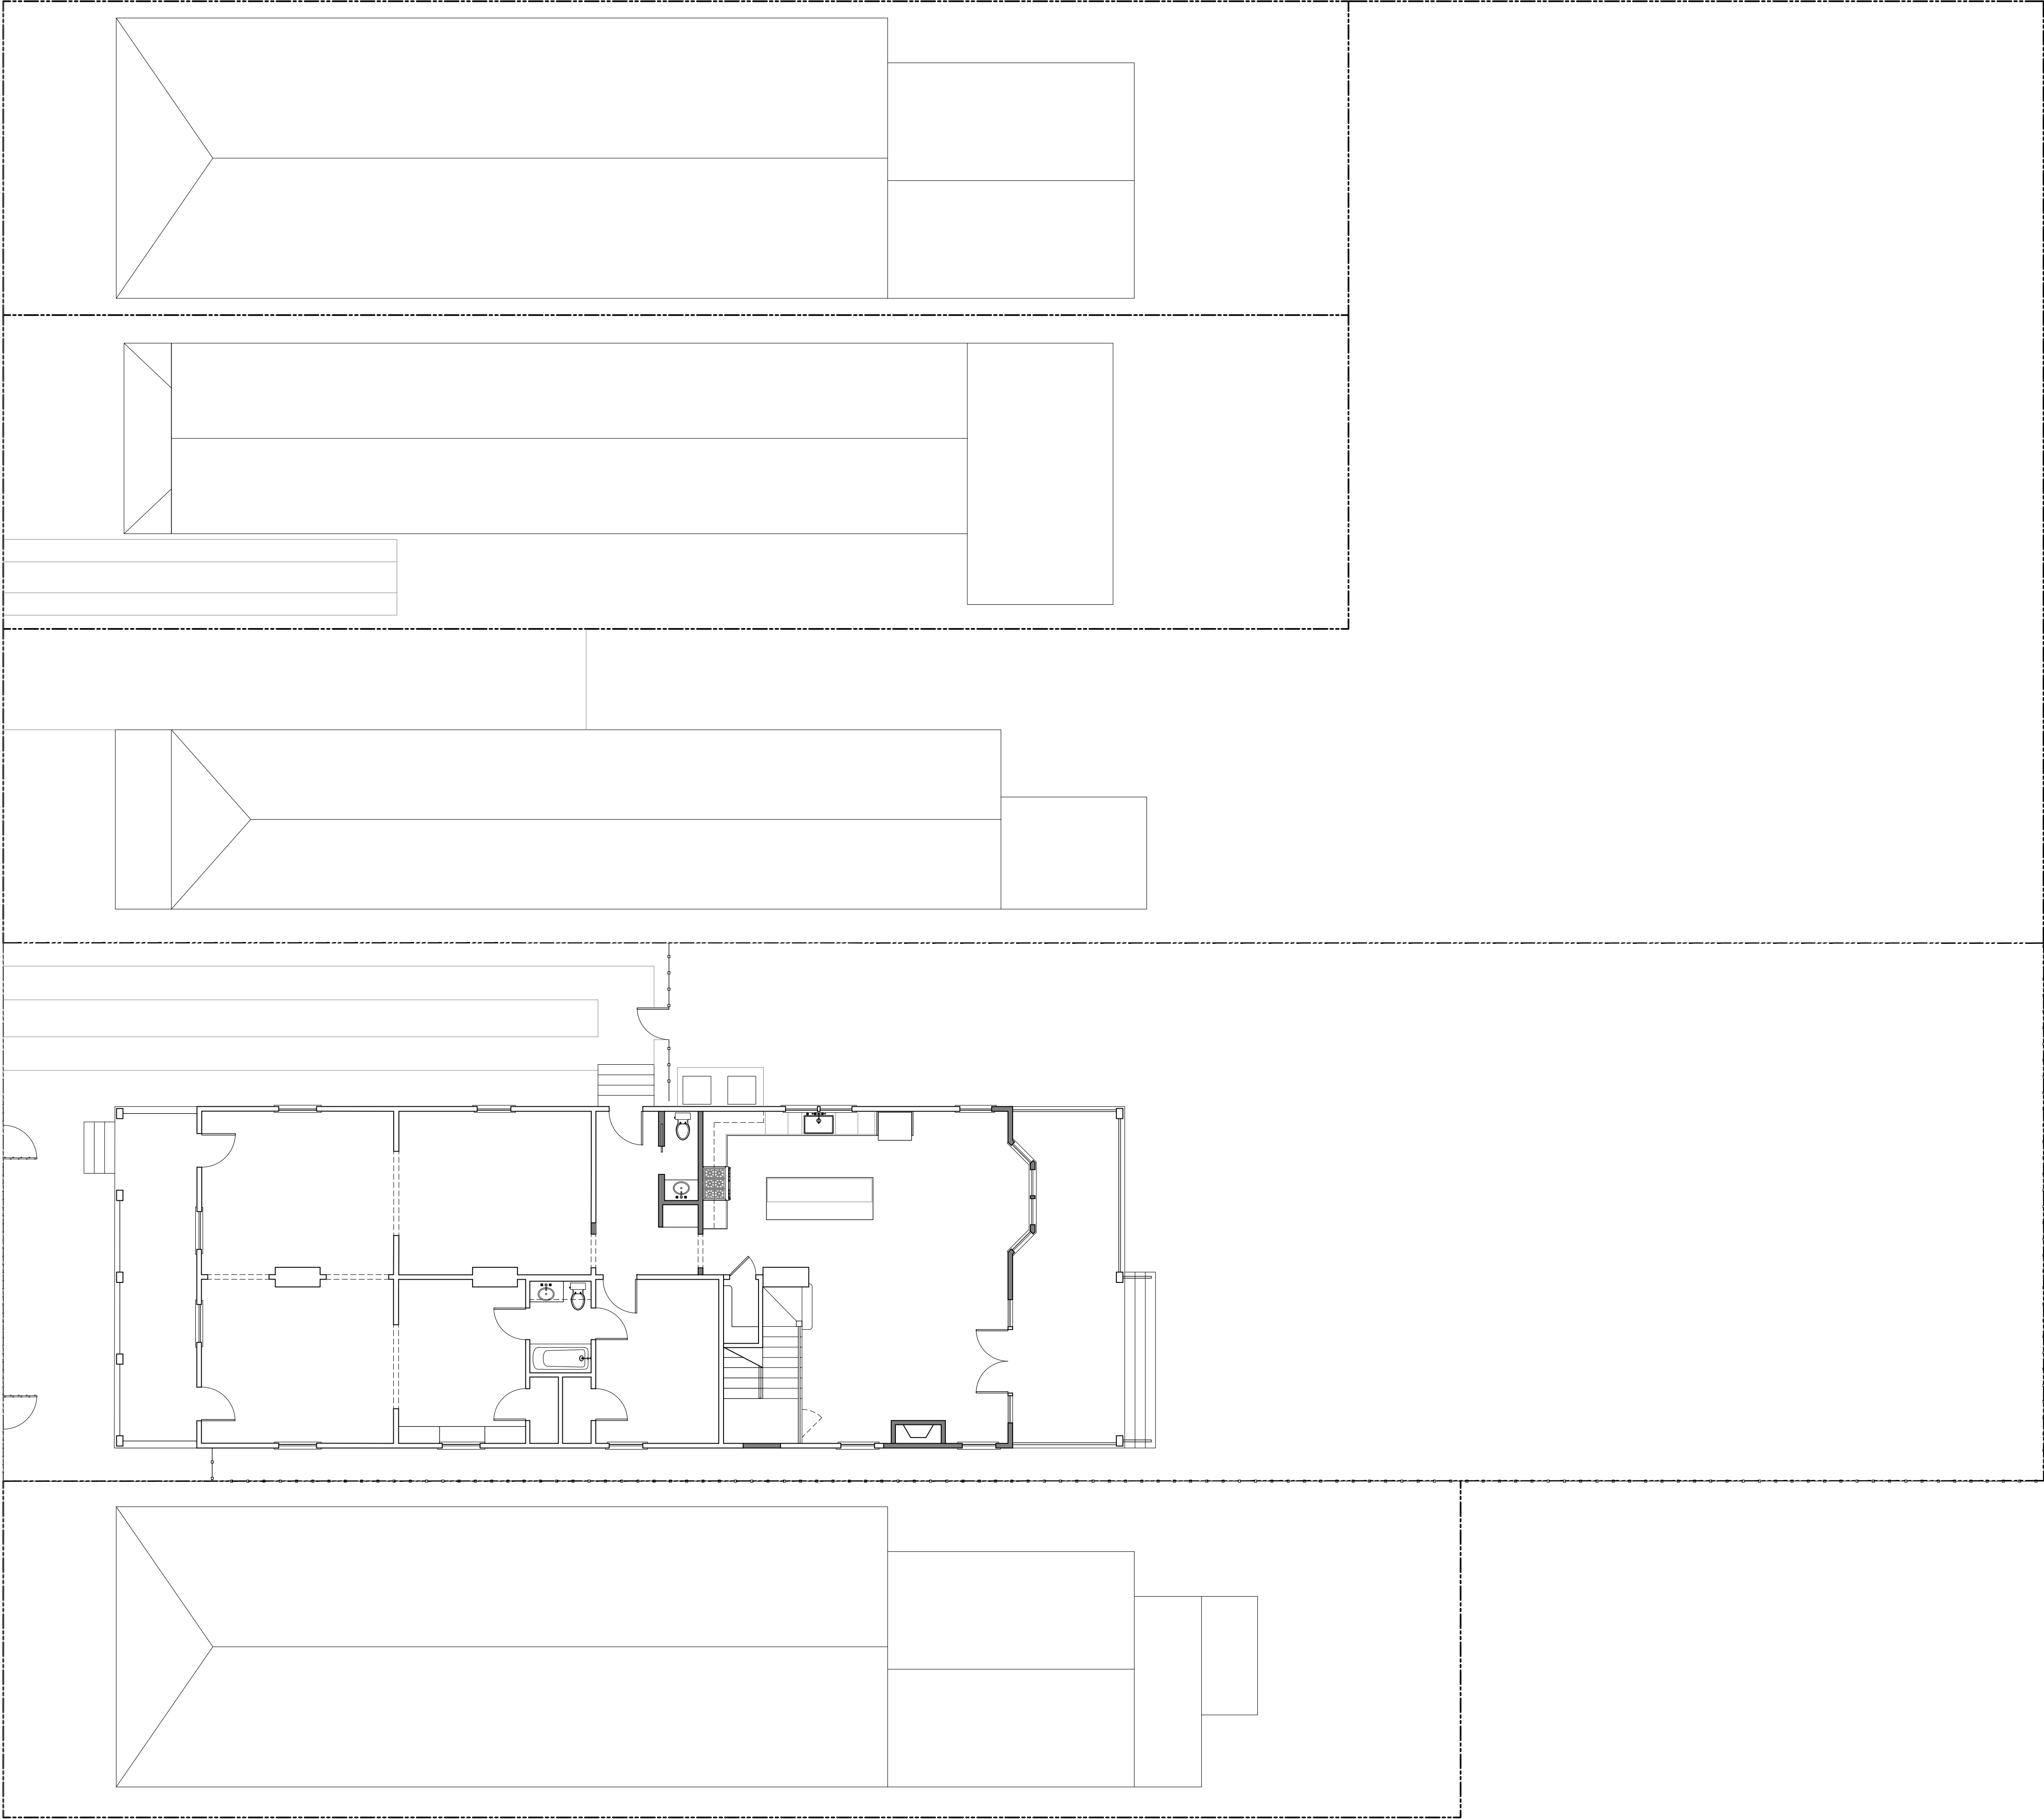
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PROPOSED SITE PLAN

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CHIPPEWA STREET  
01/A3.2



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CRISCO RESIDENCE  
2827-2831 CHIPPEWA STREET  
NEW ORLEANS, LOUISIANA 70115

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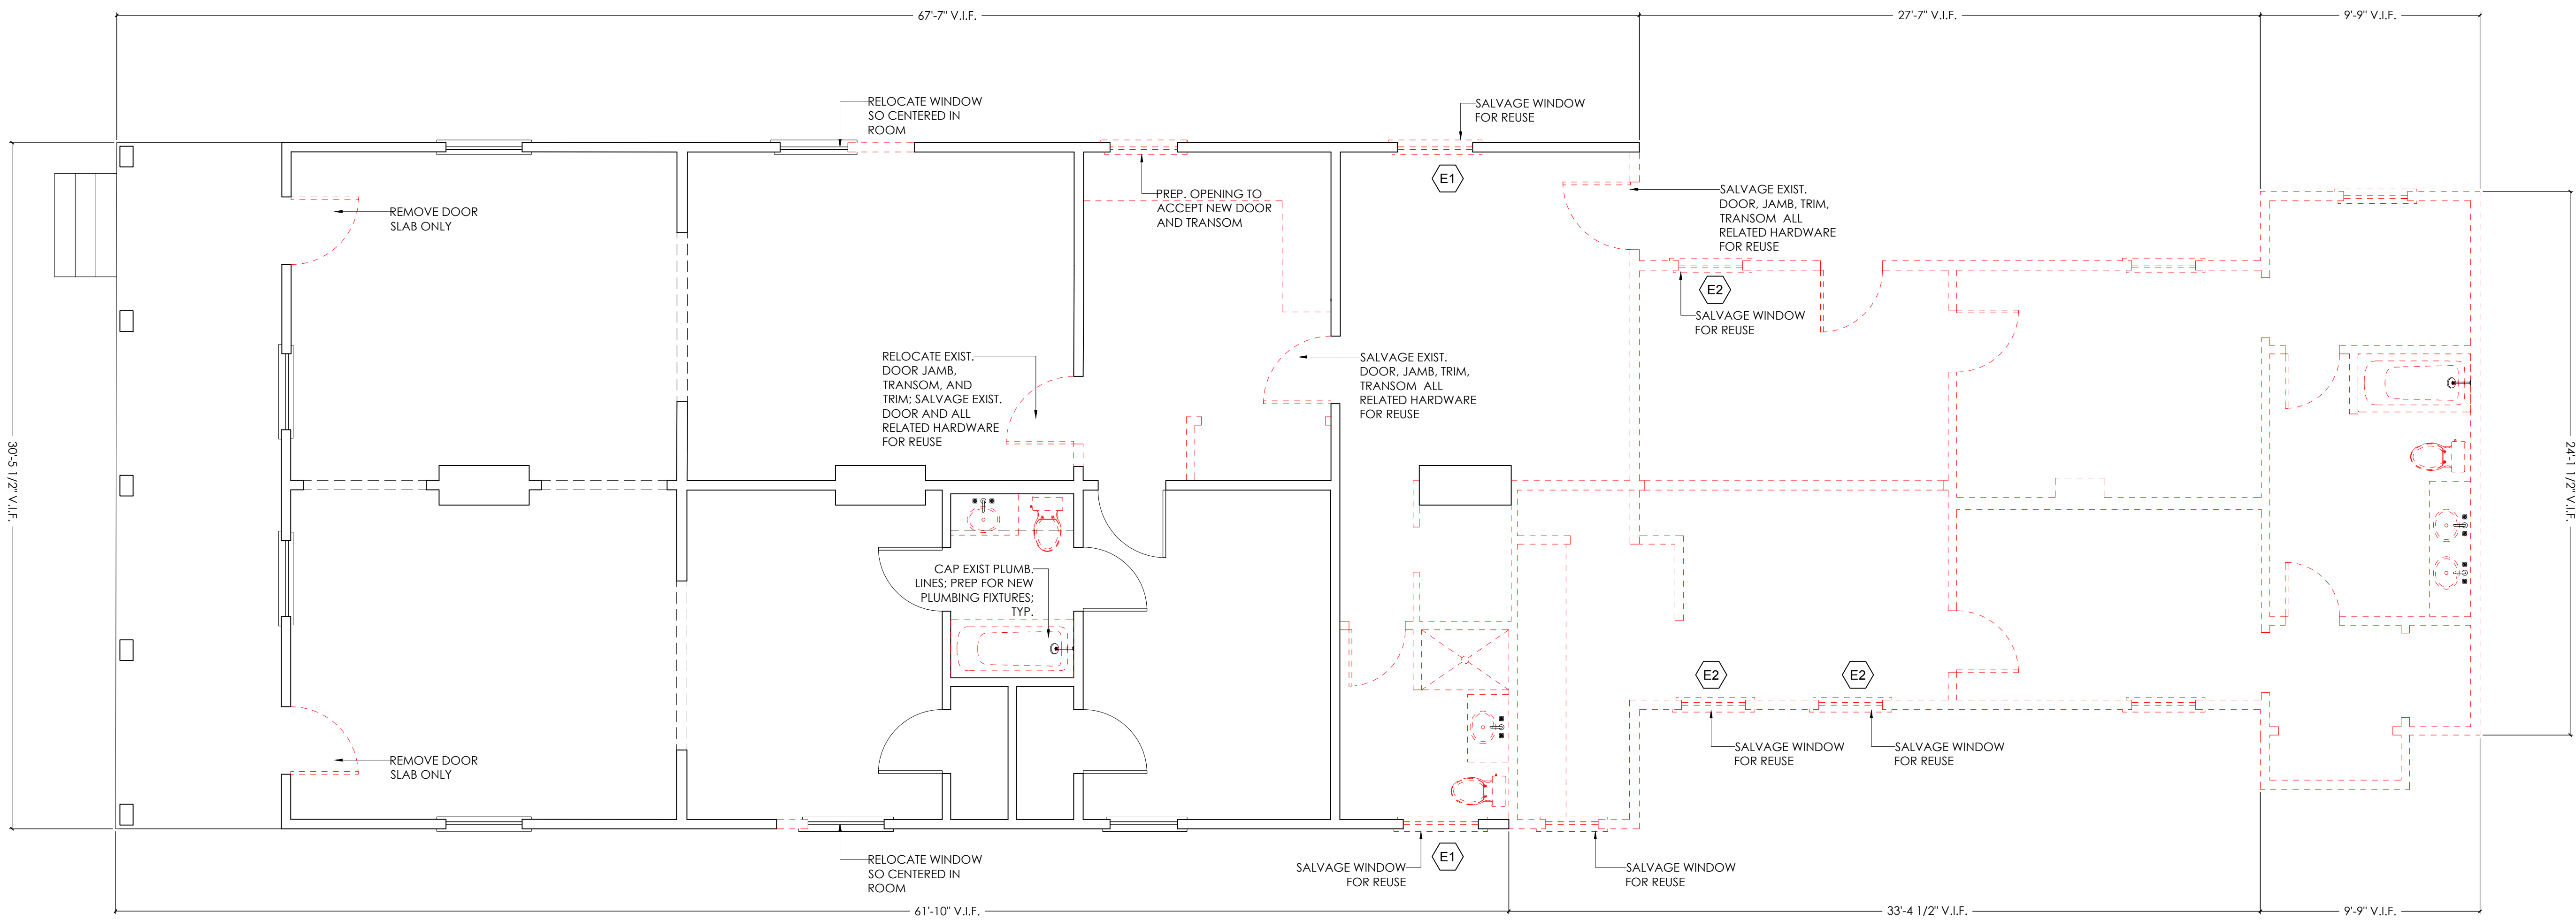


DATE: OCTOBER 05, 2022

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EXISTING FLOOR PLAN

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## A1.1



**DEMOLITION NOTES:**

1. RED DASHED LINES INDICATE SCOPE OF DEMO WORK TO BE REMOVED
2. GC TO VERIFY WITH OWNER ANY ITEMS NOT INDICATED
3. GC TO SALVAGE AND SAFELY STORE ALL ITEMS INDICATED

01 EXISTING FLOOR PLAN  
SCALE: 1/4" = 1'-0"





ARCHETYPE

CRISCO RESIDENCE  
2827-2831 CHIPPEWA STREET  
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SEAL:




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PROPOSED FLOOR PLAN

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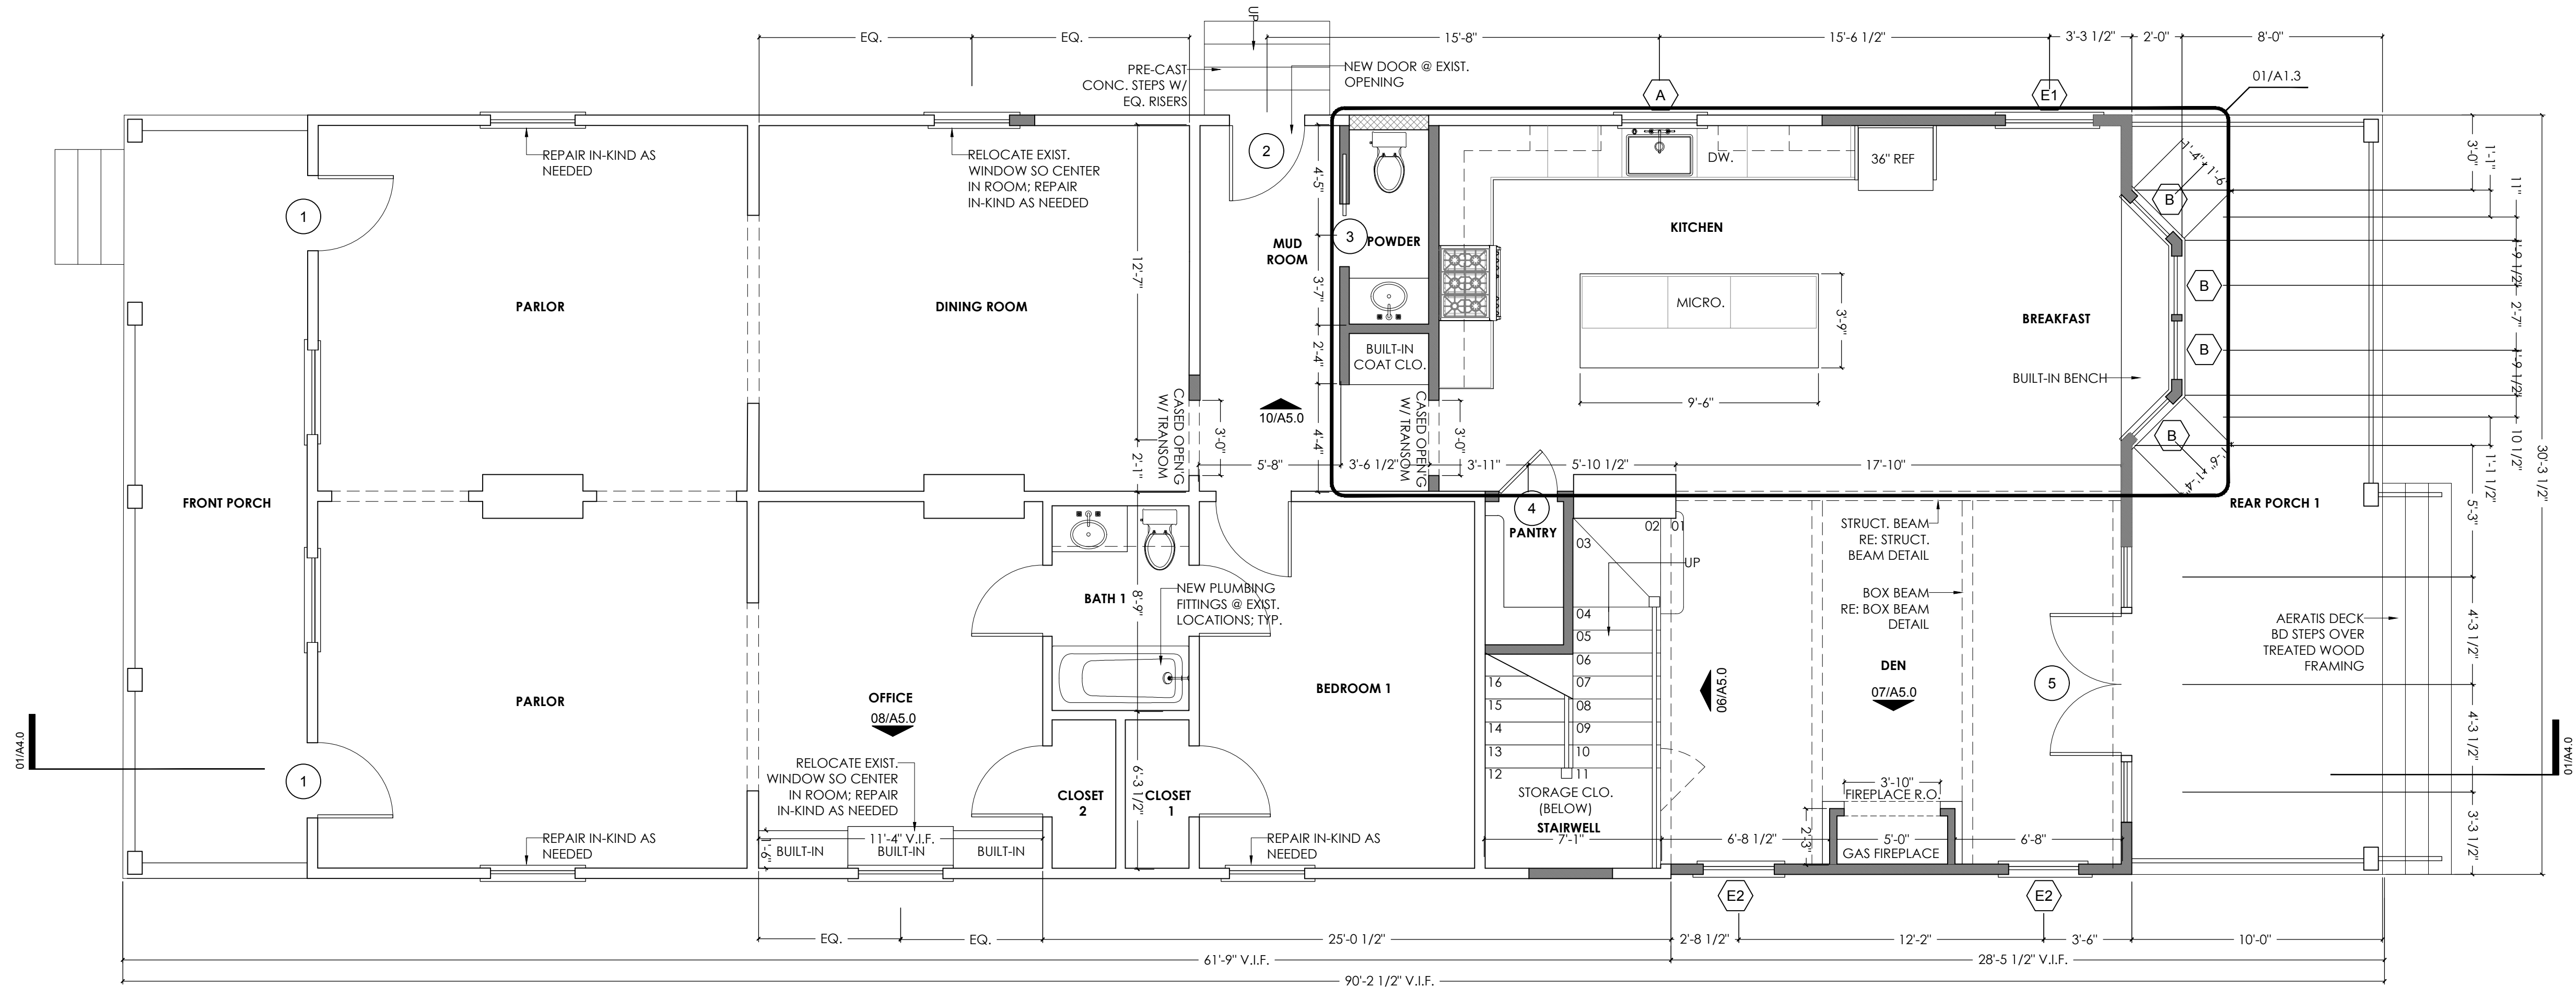
A1.2

02 PROPOSED SECOND FLOOR PLAN  
SCALE: 1/4" = 1'-0"



- WALL LEGEND:**
- 2X6 @ 16" O.C. W/ PTD. 1/2" GYP. BOARD (1/2" CEM. BD. WHERE TILE INDICATED)
  - 2X4 @ 16" O.C. W/ PTD. 1/2" GYP. BOARD (1/2" CEM. BD. WHERE TILE INDICATED)
  - 2X4 @ 16" O.C. W/ STUDS TURNED 90° W/ PTD. 1/2" GYP. BOARD (1/2" CEM. BD. WHERE TILE INDICATED)

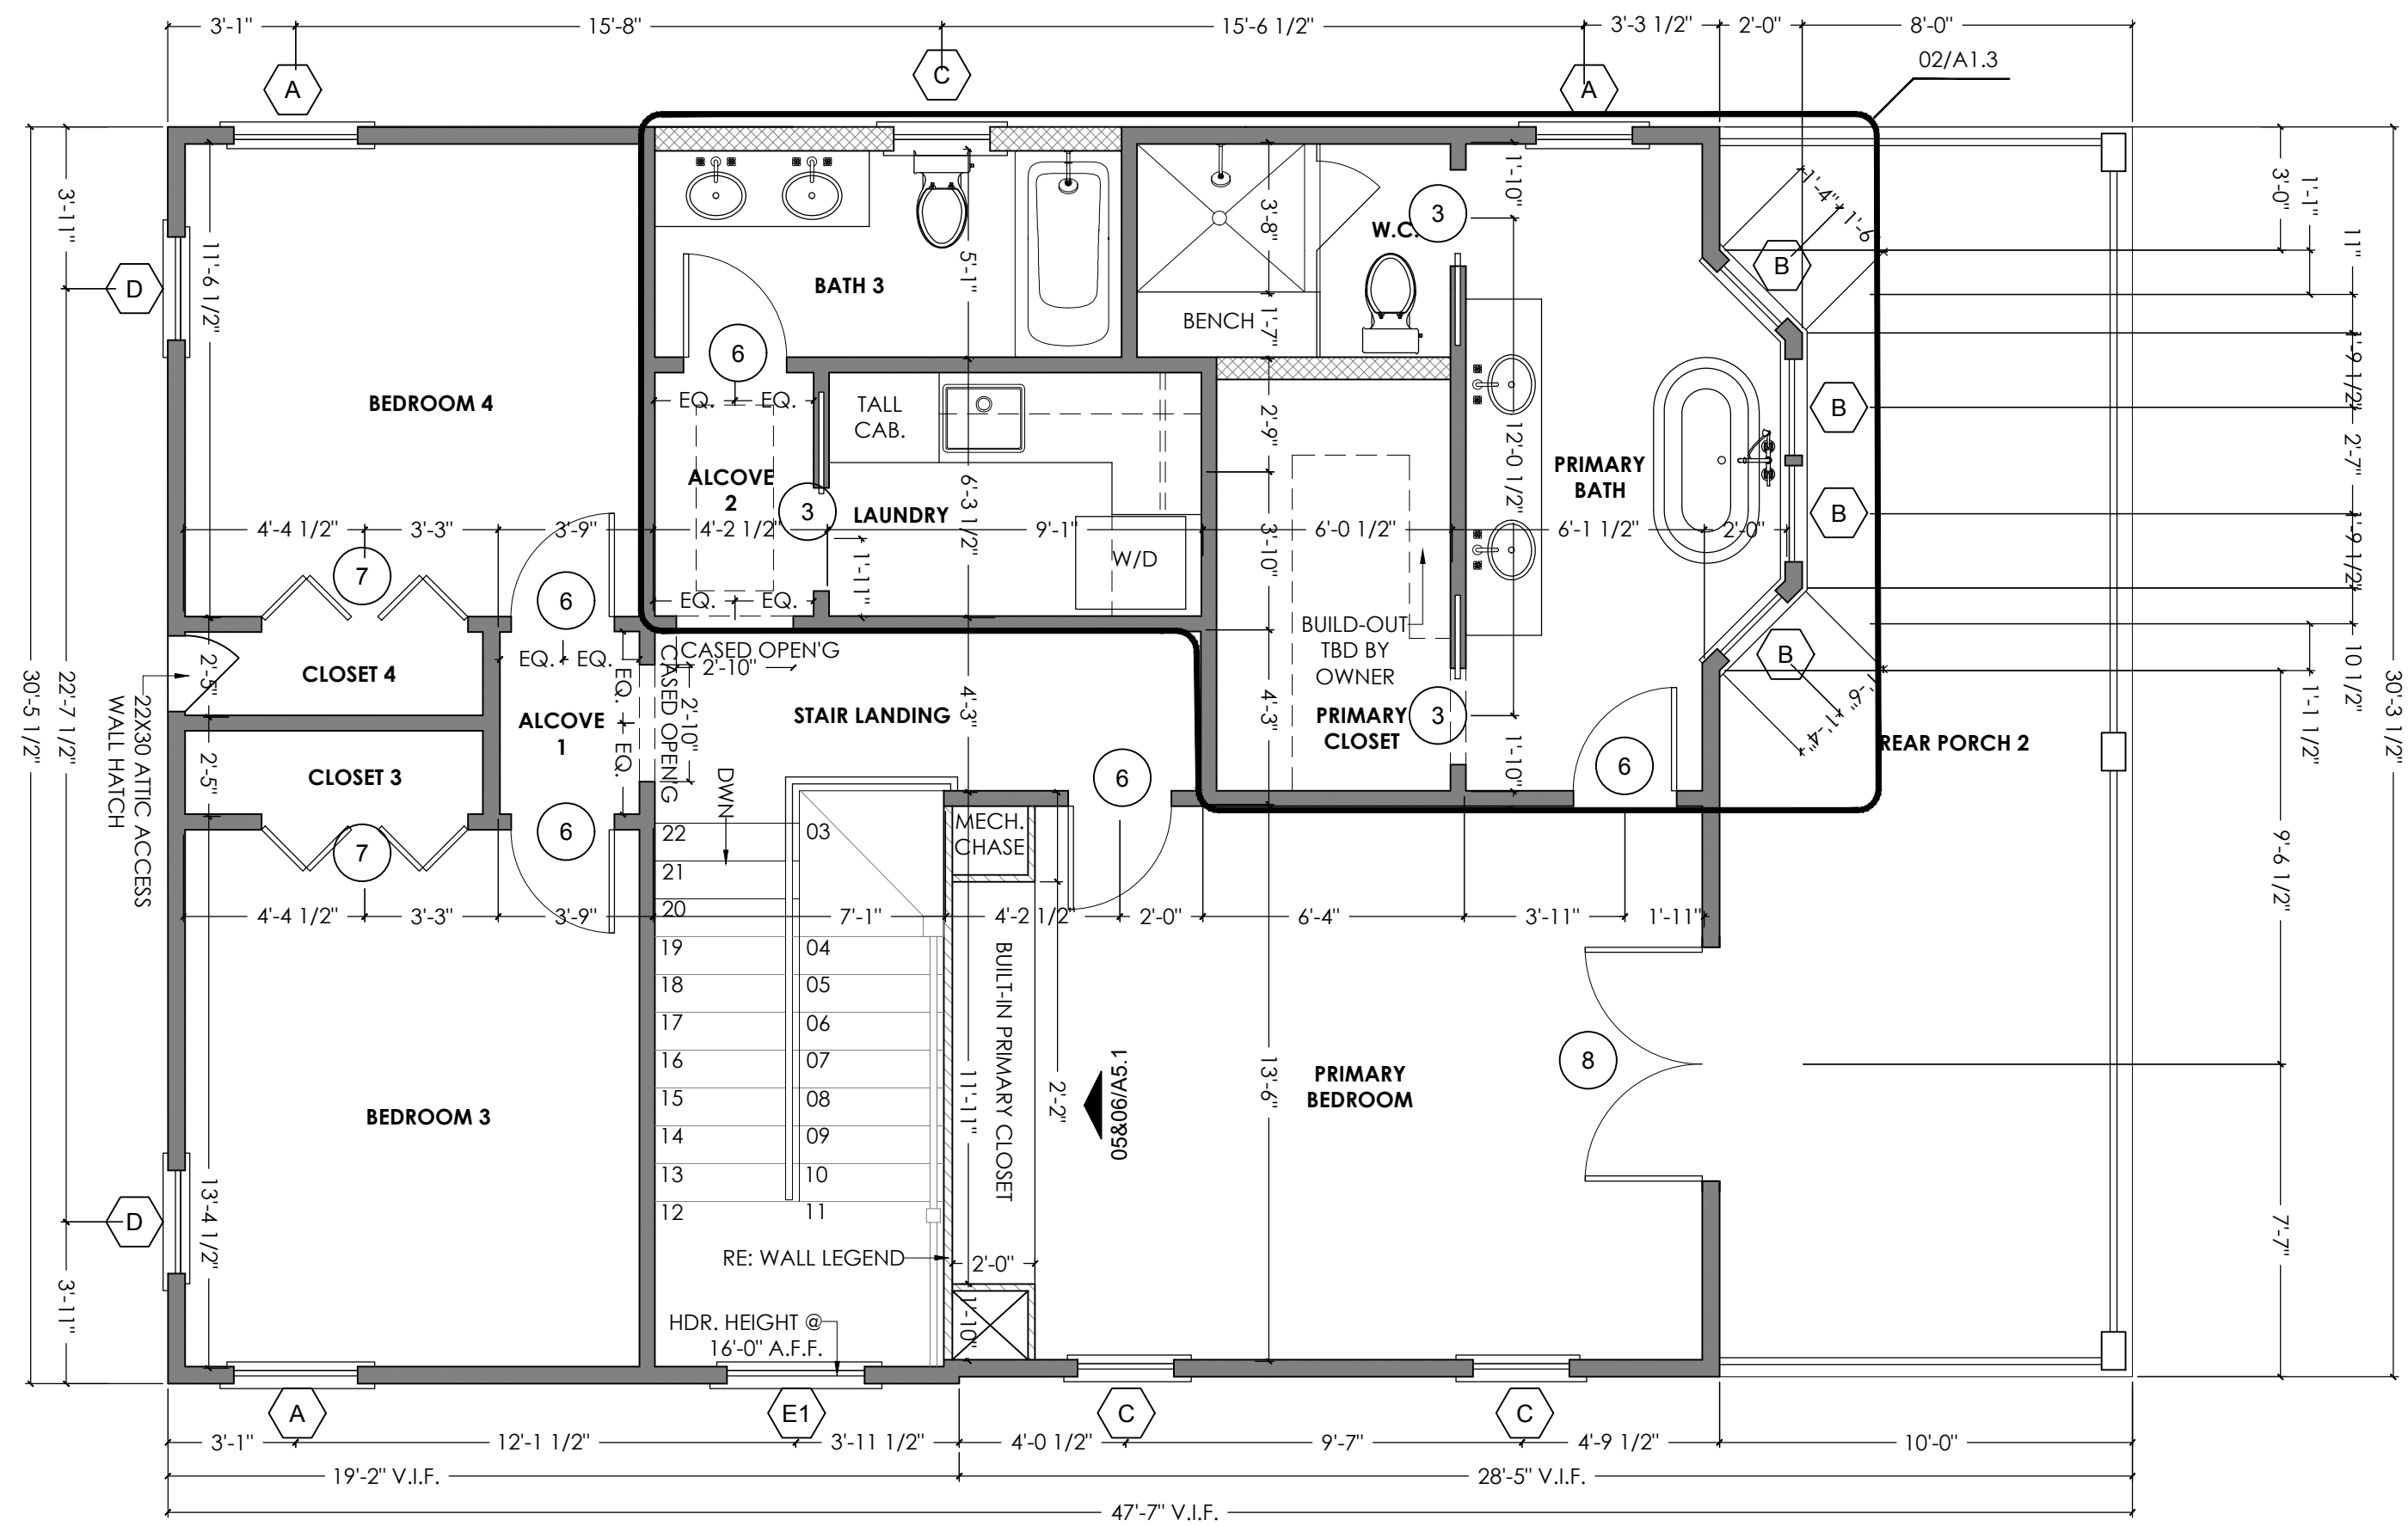01 PROPOSED FIRST FLOOR PLAN  
SCALE: 1/4" = 1'-0"



**GENERAL NOTES:**

- PLAN DIMENSIONS AT ALL PARTITIONS ARE TO FACE OF STUD UNLESS OTHERWISE INDICATED. DIMENSIONS DO NOT TAKE APPLIED FINISHES INTO ACCOUNT.
- PLAN DIMENSIONS AT ALL EXTERIOR WALLS ARE TO FACE OF SHEATHING UNLESS OTHERWISE INDICATED. DIMENSIONS DO NOT TAKE APPLIED FINISHES INTO ACCOUNT.
- PLAN DIMENSIONS TO DOORS AND WINDOWS ARE TO CENTER OF OPENINGS.
- SEE FRAMING PLANS AND ARCHITECTURAL SECTIONS FOR FRAMING DIMENSIONS.
- PER SEC. R318, IRC 2015 ED., CONTRACTOR TO ENSURE THE FOLLOWING PEST CONTROL MEASURES ARE TAKEN:
  - 2.1 SEAL ALL EXTERNAL CRACKS, JOINTS, PENETRATIONS, EDGES, AND ENTRY POINTS WITH CAULKING OR SPRAY FOAM
  - 2.2 SEPARATE ALL WOOD TO CONCRETE CONNECTIONS WITH METAL OR WATERPROOFING TAPE
- SMOKE DETECTORS ARE TO BE PROVIDED IN ALL SLEEPING AREAS AND IN HALLWAYS OUTSIDE OF SLEEPING AREAS PER R313, IRC 2015
- ALL MEP EQUIPMENT SHALL BE LOCATED ABOVE THE BASE FLOOD ELEVATION.
- BATHROOMS ARE TO BE MECHANICALLY VENTILATED TO EXTERIOR





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| REVISIONS |  | No. | Date | Scope |
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CRISCO RESIDENCE  
2827-2831 CHIPPEWA STREET  
NEW ORLEANS, LOUISIANA 70115

SEAL:




ISSUE DATE:  
OCTOBER 05, 2022


DRAWING TITLE:  
ENLARGED FLOOR PLANS

DRAWING NUMBER:

A1.3

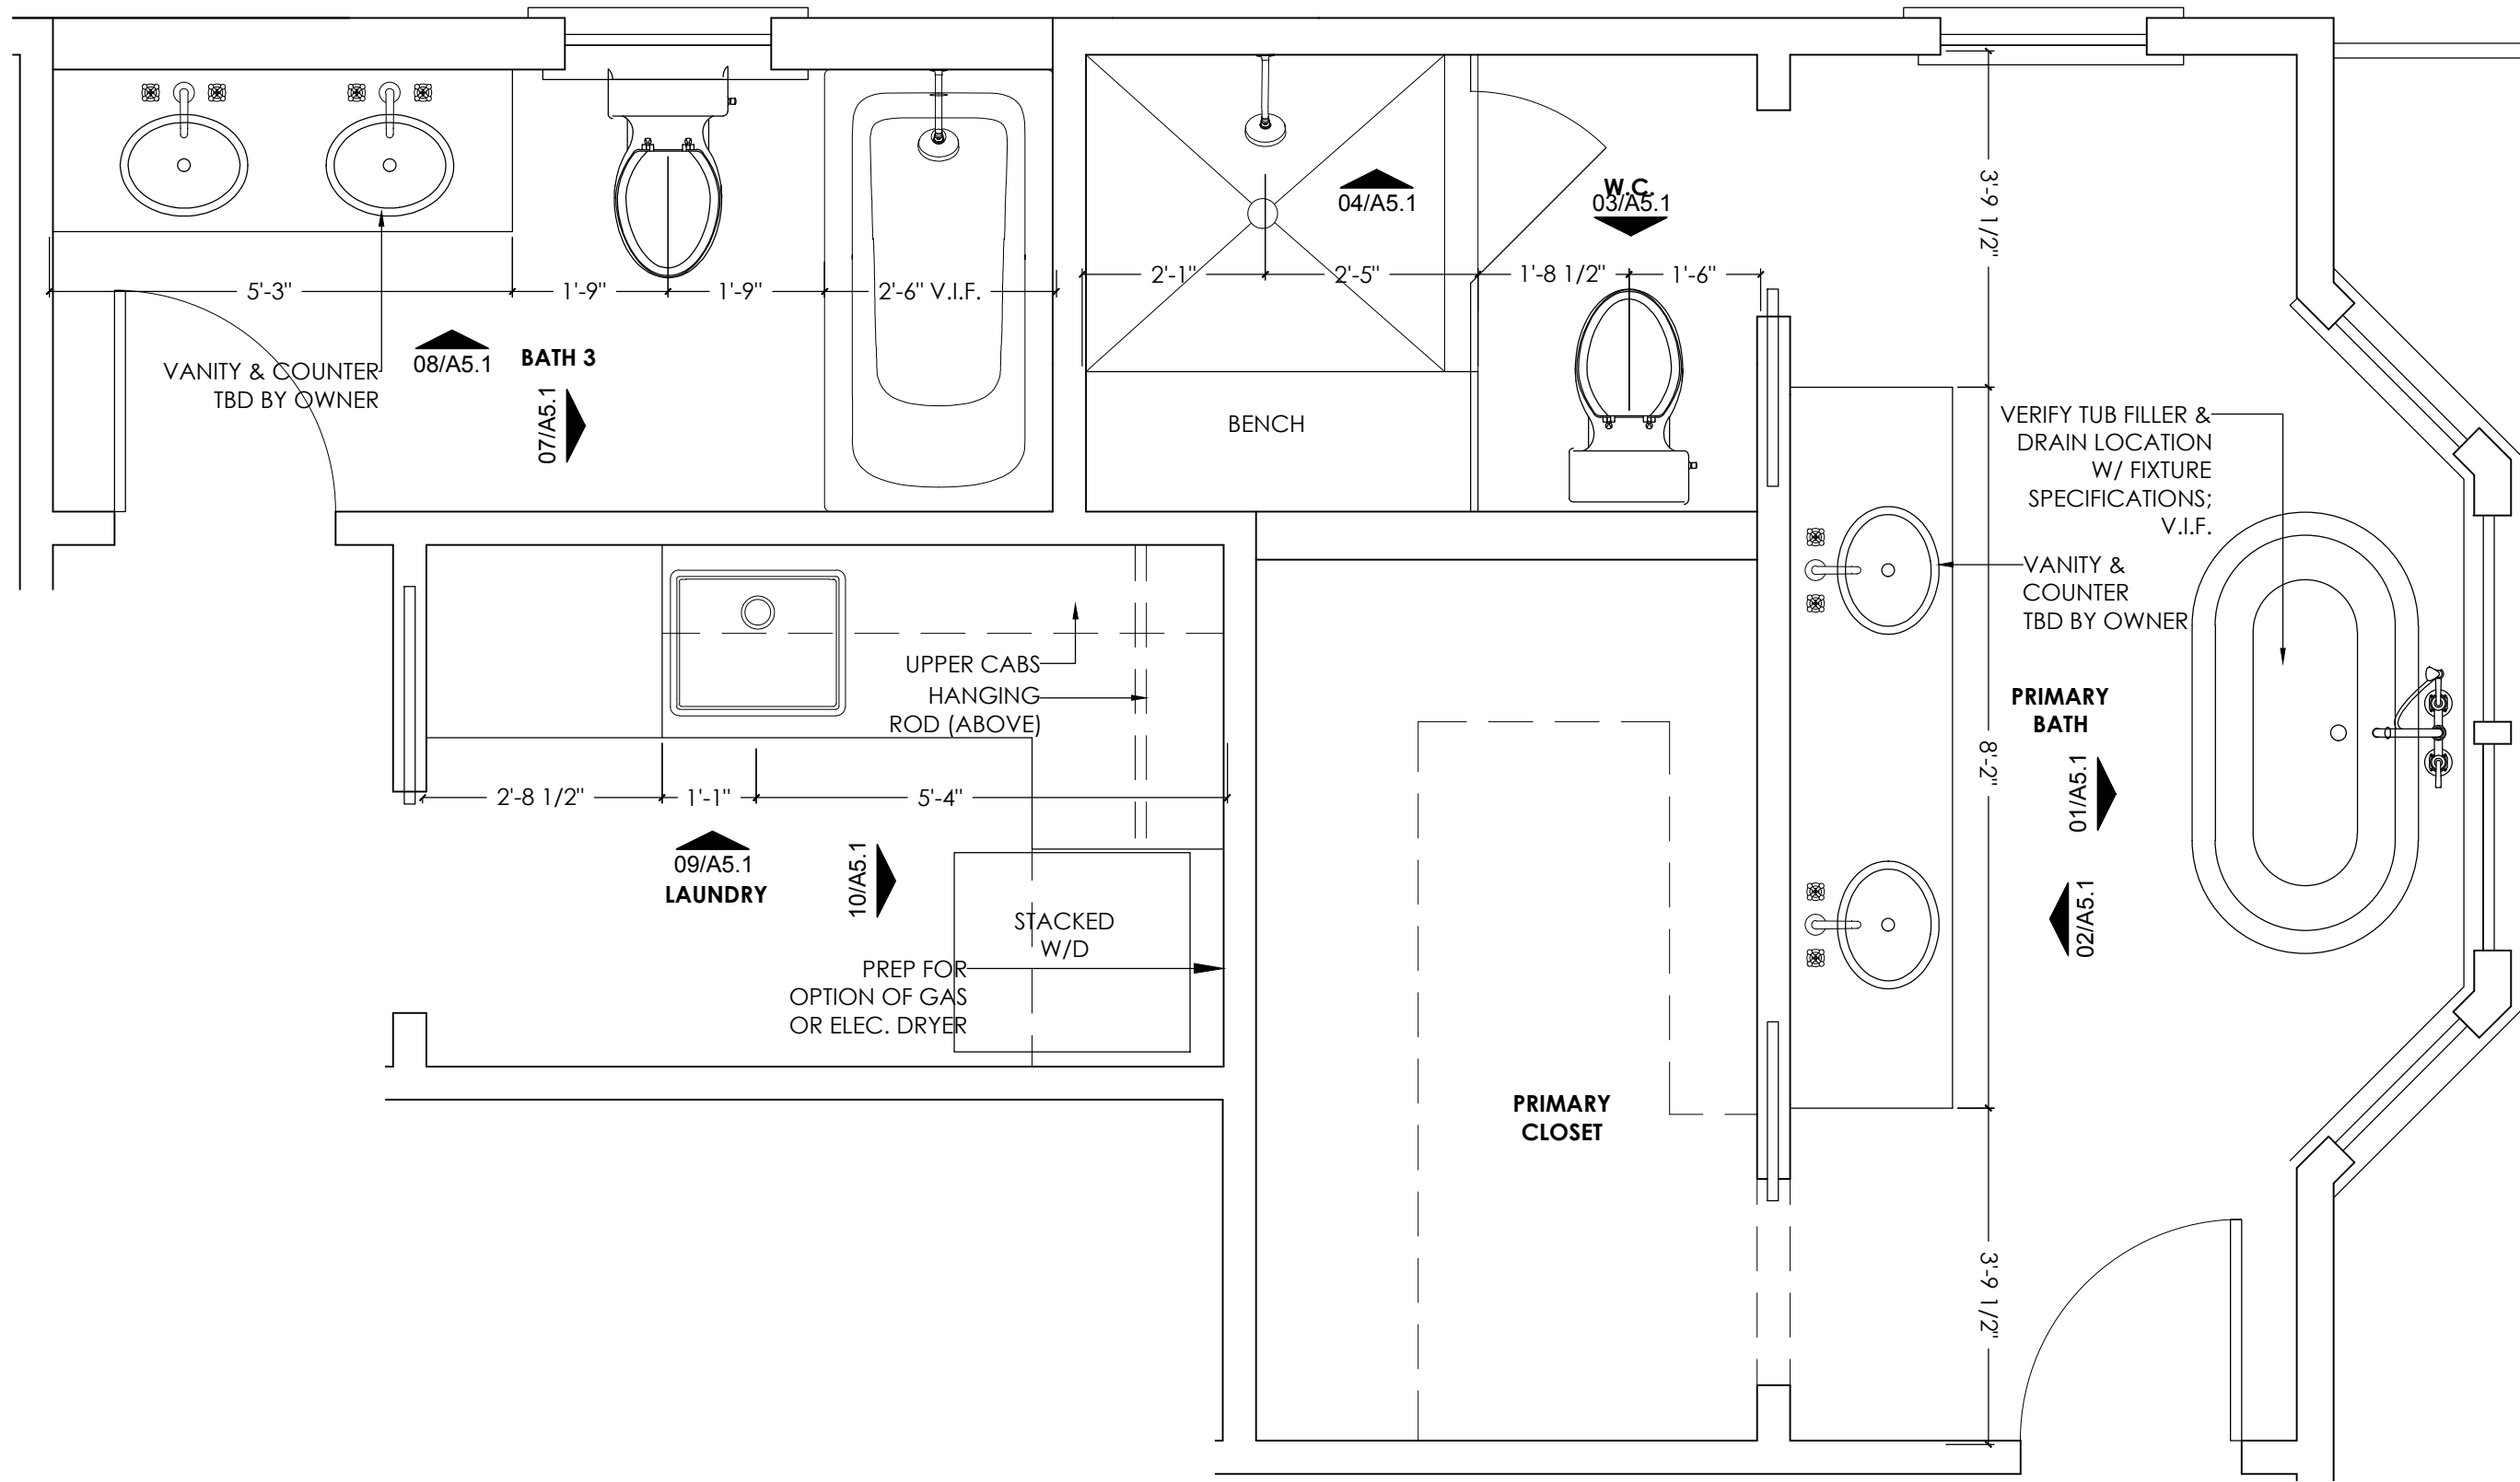

02 ENLARGED PLAN @ LAUNDRY, BATH 3, PRIMARY BATH & W.C.  
SCALE: 1/2" = 1'-0"

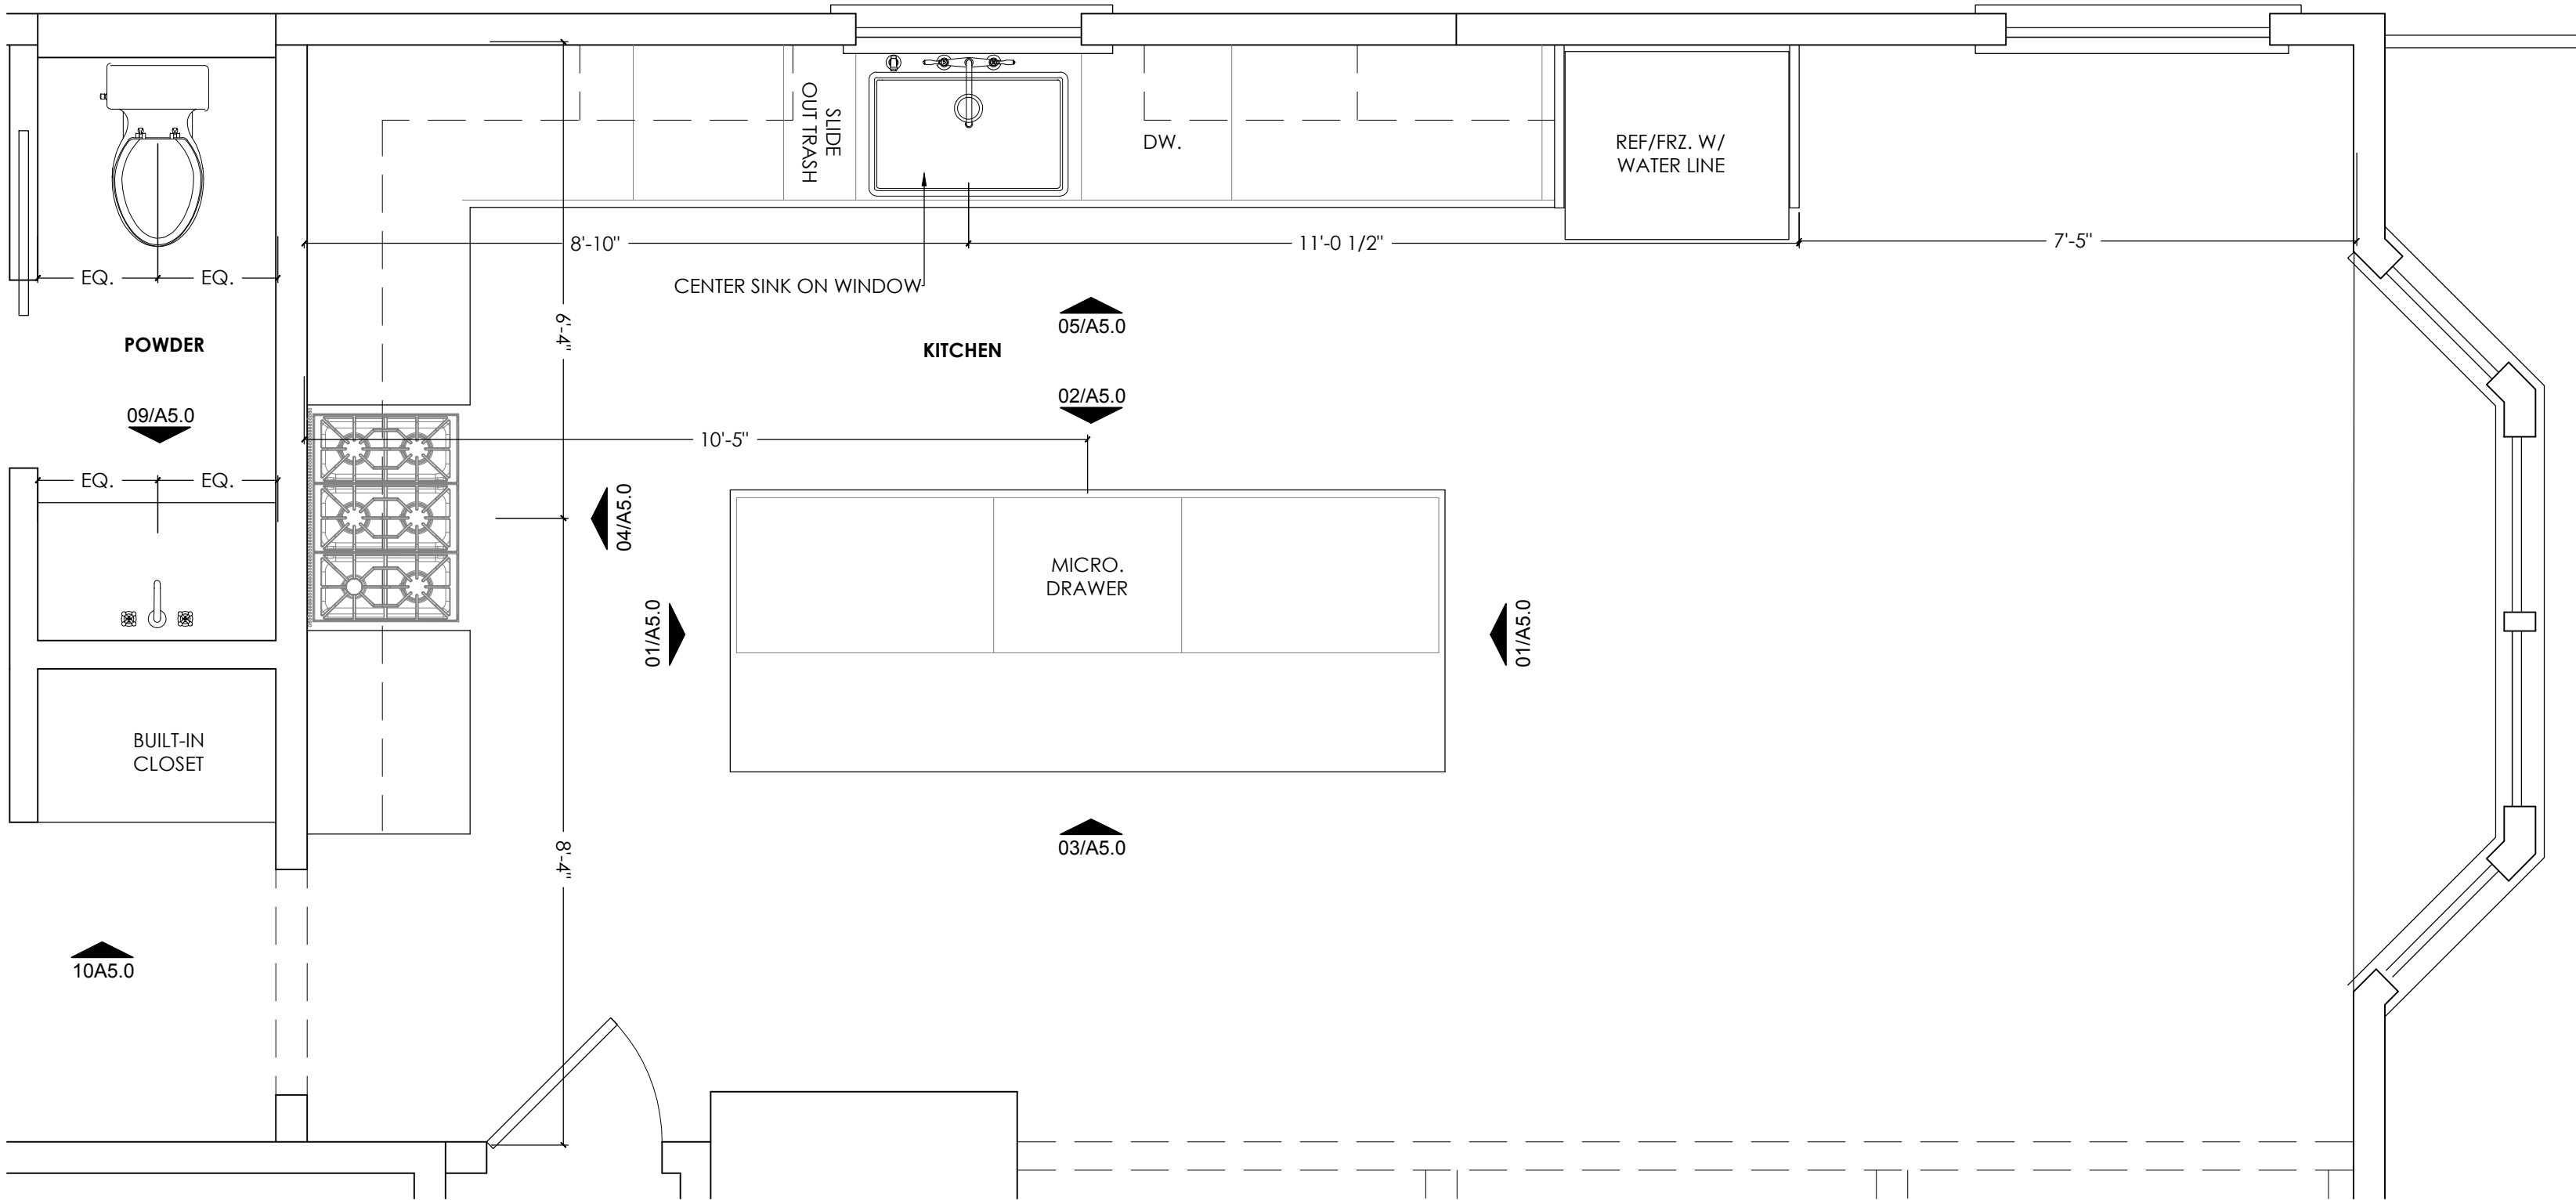

01 ENLARGED PLAN @ POWDER & KITCHEN  
SCALE: 1/2" = 1'-0"




**All new windows and exterior doors to be submitted to HDLC prior to purchase and installation.**

| DOOR SCHEDULE |      |                                       |              |                      |               |                |              |               |  |   |
|---------------|------|---------------------------------------|--------------|----------------------|---------------|----------------|--------------|---------------|--|---|
| NO.           | QTY. | DOOR WIDTH                            | DOOR HEIGHT  | OVERALL OPENING      | DOOR MATERIAL | FRAME MATERIAL | MANUFACTURER | DOOR TYPE     | HARDWARE                                 | DESCRIPTION   |
| 1             | 2    | 3'-0" V.I.F.                          | 8'-0" V.I.F. | EXISTING             | WOOD          | WOOD           | TBD          | HINGED        | ENTRY SET                                | NEW SOLID WD. <b>Pane-over-panel</b> W/ EXIST FRAME & TRANSOM. TRIM TO MATCH EXIST. |
| 2             | 1    | 3'-0" V.I.F.                          | 8'-0" V.I.F. | EXISTING             | WOOD          | WOOD           | TBD          | HINGED        | ENTRY SET                                | NEW SOLID WD. <b>Pane-over-panel</b> W/ EXIST FRAME & TRANSOM. TRIM TO MATCH EXIST. |
| 3             | 4    | 2'-6"                                 | 8'-0"        | 2'-6" X 8'-0"        | WOOD          | WOOD           | TBD          | POCKET        | PRIVACY PULLS                            | NEW SOLID WOOD FOUR-PANEL POCKET DOOR   |
| 4             | 1    | 2'-4"                                 | 8'-0"        | 2'-4" X 8'-0"        | WOOD          | WOOD           | TBD          | HINGED        | PASSAGE KNOB                             | NEW SOLID WOOD FOUR-PANEL DOOR  |
| 5             | 1    | 5'-10" (2 EQ.) &<br>2'-10" SIDE LITES | 8'-0"        | 11'-10" X 9'-10"     | TBD           | WOOD           | TBD          | DOUBLE HINGED | PRIVACY KNOB & DEADBOLT & (2) FLUSHBOLTS | NEW WOOD TEN LITE DOOR W/ SIDE LITES & TRANSOM. TRIM TO MATCH EXIST.                |
| 6             | 5    | 2'-6"                                 | 8'-0"        | 2'-6" X 7'-0" V.I.F. | WOOD          | WOOD           | TBD          | HINGED        | PRIVACY KNOB                             | NEW SOLID WOOD FOUR-PANEL DOOR  |
| 7             | 2    | 5'-0" (4 EQ. LEAF)                    | 8'-0"        | 5'-0" X 8'-0"        | WOOD          | WOOD           | TBD          | BIFOLD        | PASSAGE PULLS                            | NEW SOLID WOOD BI-FOLD DOORS  |
| 8             | 1    | 5'-10" (2 EQ.)                        | 8'-0"        | 5'-10" X 9'-10"      | WOOD          | WOOD           | TBD          | DOUBLE HINGED | PRIVACY KNOB & DEADBOLT & (2) FLUSHBOLTS | NEW WOOD TEN LITE DOOR. TRIM TO MATCH EXIST.  |


| WINDOW SCHEDULE |      |               |               |                       |            |                |              |             |   |  |
|-----------------|------|---------------|---------------|-----------------------|------------|----------------|--------------|-------------|---|--|
| MARK            | QTY. | WINDOW WIDTH  | WINDOW HEIGHT | OVERALL OPENING       | MATERIAL   | FRAME MATERIAL | MANUFACTURER | TYPE        | GLAZING                                   | DESCRIPTION  |
| A               | 4    | 3'-0"         | 5'-10"        | 3'-0" X 5'-10"        | FIBERGLASS | WOOD           | TBD          | Double HUNG | LAMINATED IMPACT RESIST. W/ LOW-E GLAZING | MATCH EXISTING HISTORIC WINDOW TRIM, SILL & APRON; SIMULATED DIVIDED LITES TO MATCH EXISTING HISTORIC MUNTIN, TYP. |
| B               | 8    | 2'-0"         | 5'-10"        | 2'-0" X 5'-10"        | FIBERGLASS | WOOD           | TBD          | SINGLE HUNG | LAMINATED IMPACT RESIST. W/ LOW-E GLAZING | MATCH EXISTING HISTORIC WINDOW TRIM, SILL & APRON; SIMULATED DIVIDED LITES TO MATCH EXISTING HISTORIC MUNTIN, TYP. |
| C               | 3    | 2'-4"         | 4'-10"        | 2'-4" X 4'-10"        | FIBERGLASS | WOOD           | TBD          | Double HUNG | LAMINATED IMPACT RESIST. W/ LOW-E GLAZING | MATCH EXISTING HISTORIC WINDOW TRIM, SILL & APRON; SIMULATED DIVIDED LITES TO MATCH EXISTING HISTORIC MUNTIN, TYP. |
| D               | 2    | 2'-10"        | 3'-0"         | 2'-10" X 3'-0"        | FIBERGLASS | WOOD           | TBD          | CASEMENT    | LAMINATED IMPACT RESIST. W/ LOW-E GLAZING | MATCH EXISTING HISTORIC WINDOW TRIM, SILL & APRON; SIMULATED DIVIDED LITES TO MATCH EXISTING HISTORIC MUNTIN, TYP. |
| E1              | 2    | 3'-5" V.I.F.  | 7'-3" V.I.F.  | 3'-5" X 7'-3" V.I.F.  | WOOD       | WOOD           | EXISTING     | DOUBLE HUNG | EXISTING                                  | INSTALL SAVAGED EXISTING WINDOW PER PROPOSED FLOOR PLAN.   |
| E2              | 2    | 2'-10" V.I.F. | 6'-6" V.I.F.  | 2'-10" X 6'-6" V.I.F. | WOOD       | WOOD           | EXISTING     | DOUBLE HUNG | EXISTING                                  | INSTALL SAVAGED EXISTING WINDOW PER PROPOSED FLOOR PLAN  |

Windows to be more rectangular, per ARC. Final window size to be submitted to HDLC

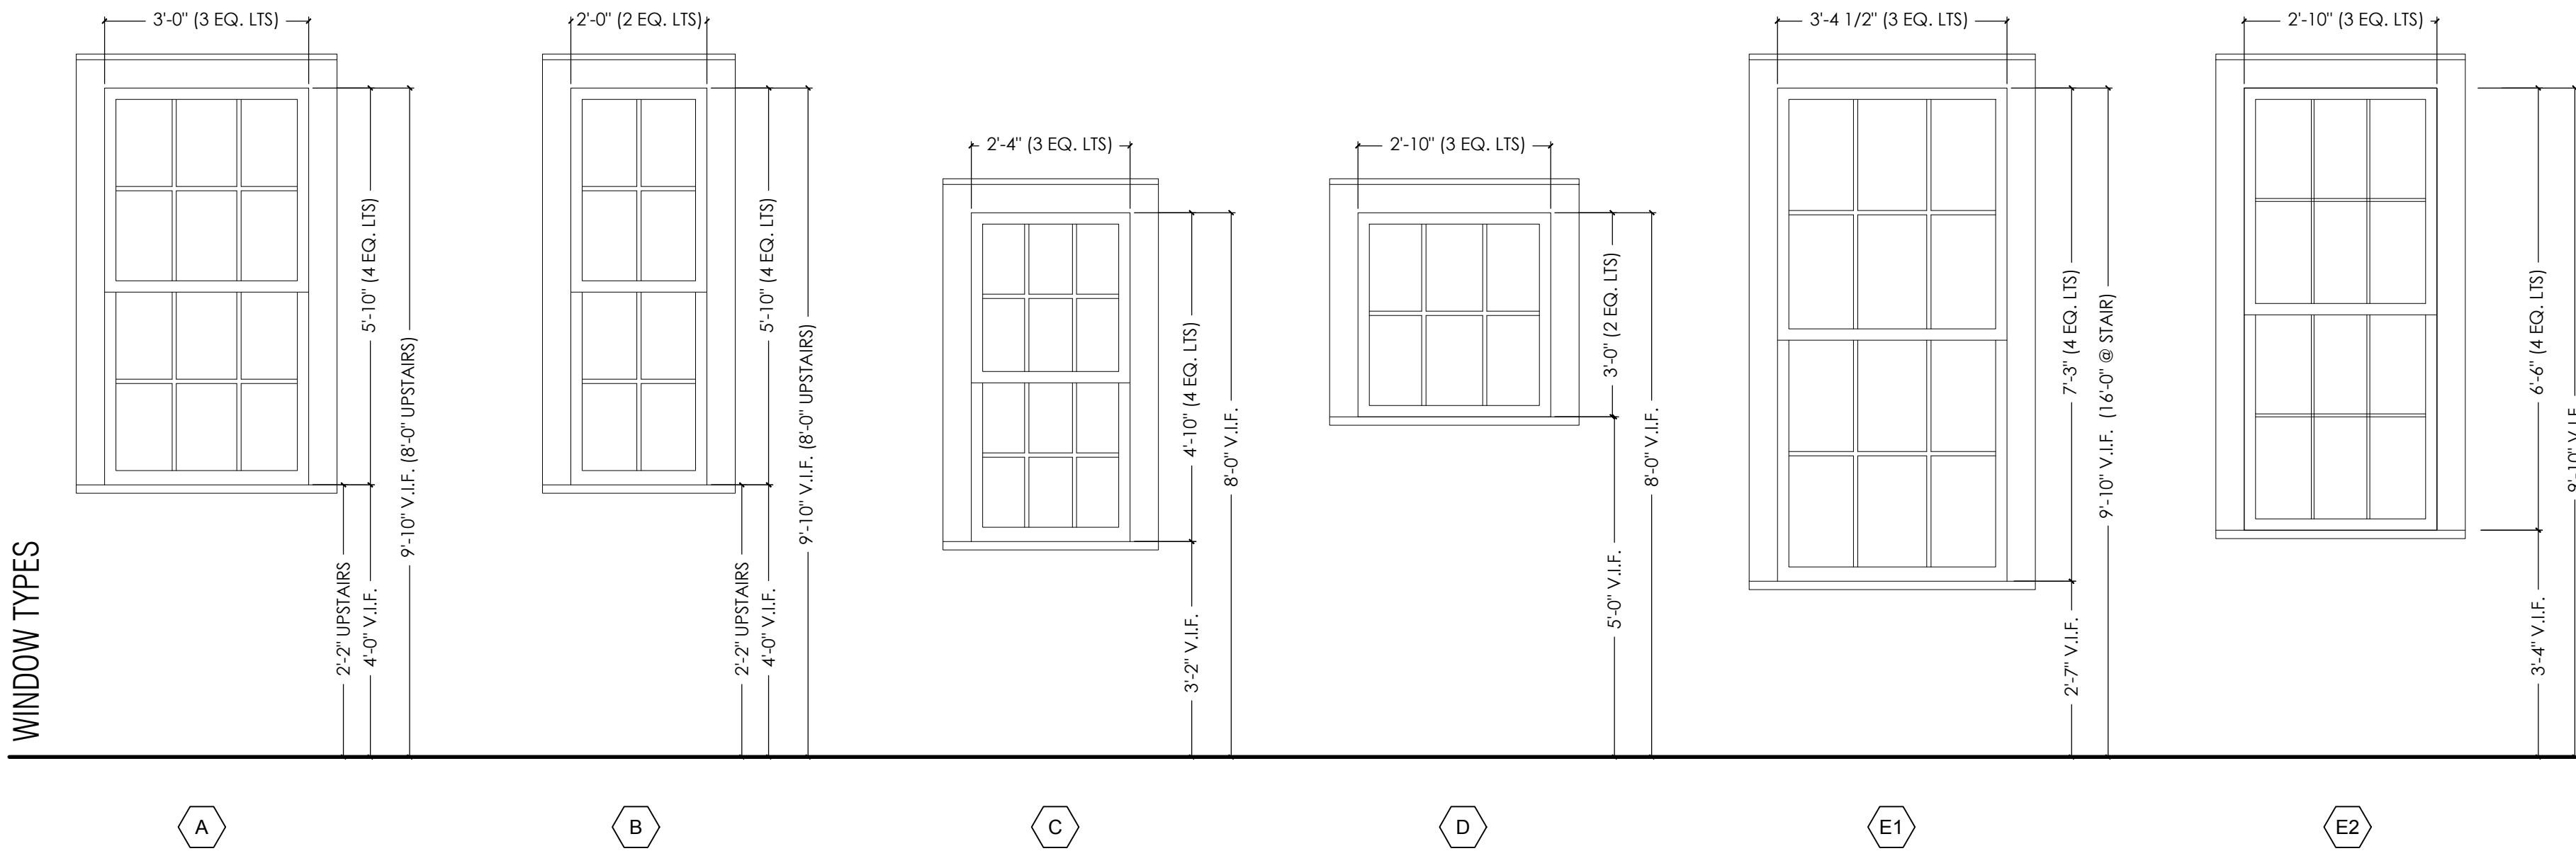

## 02 WINDOW TYPES

SCALE: 1/2" = 1'-0"

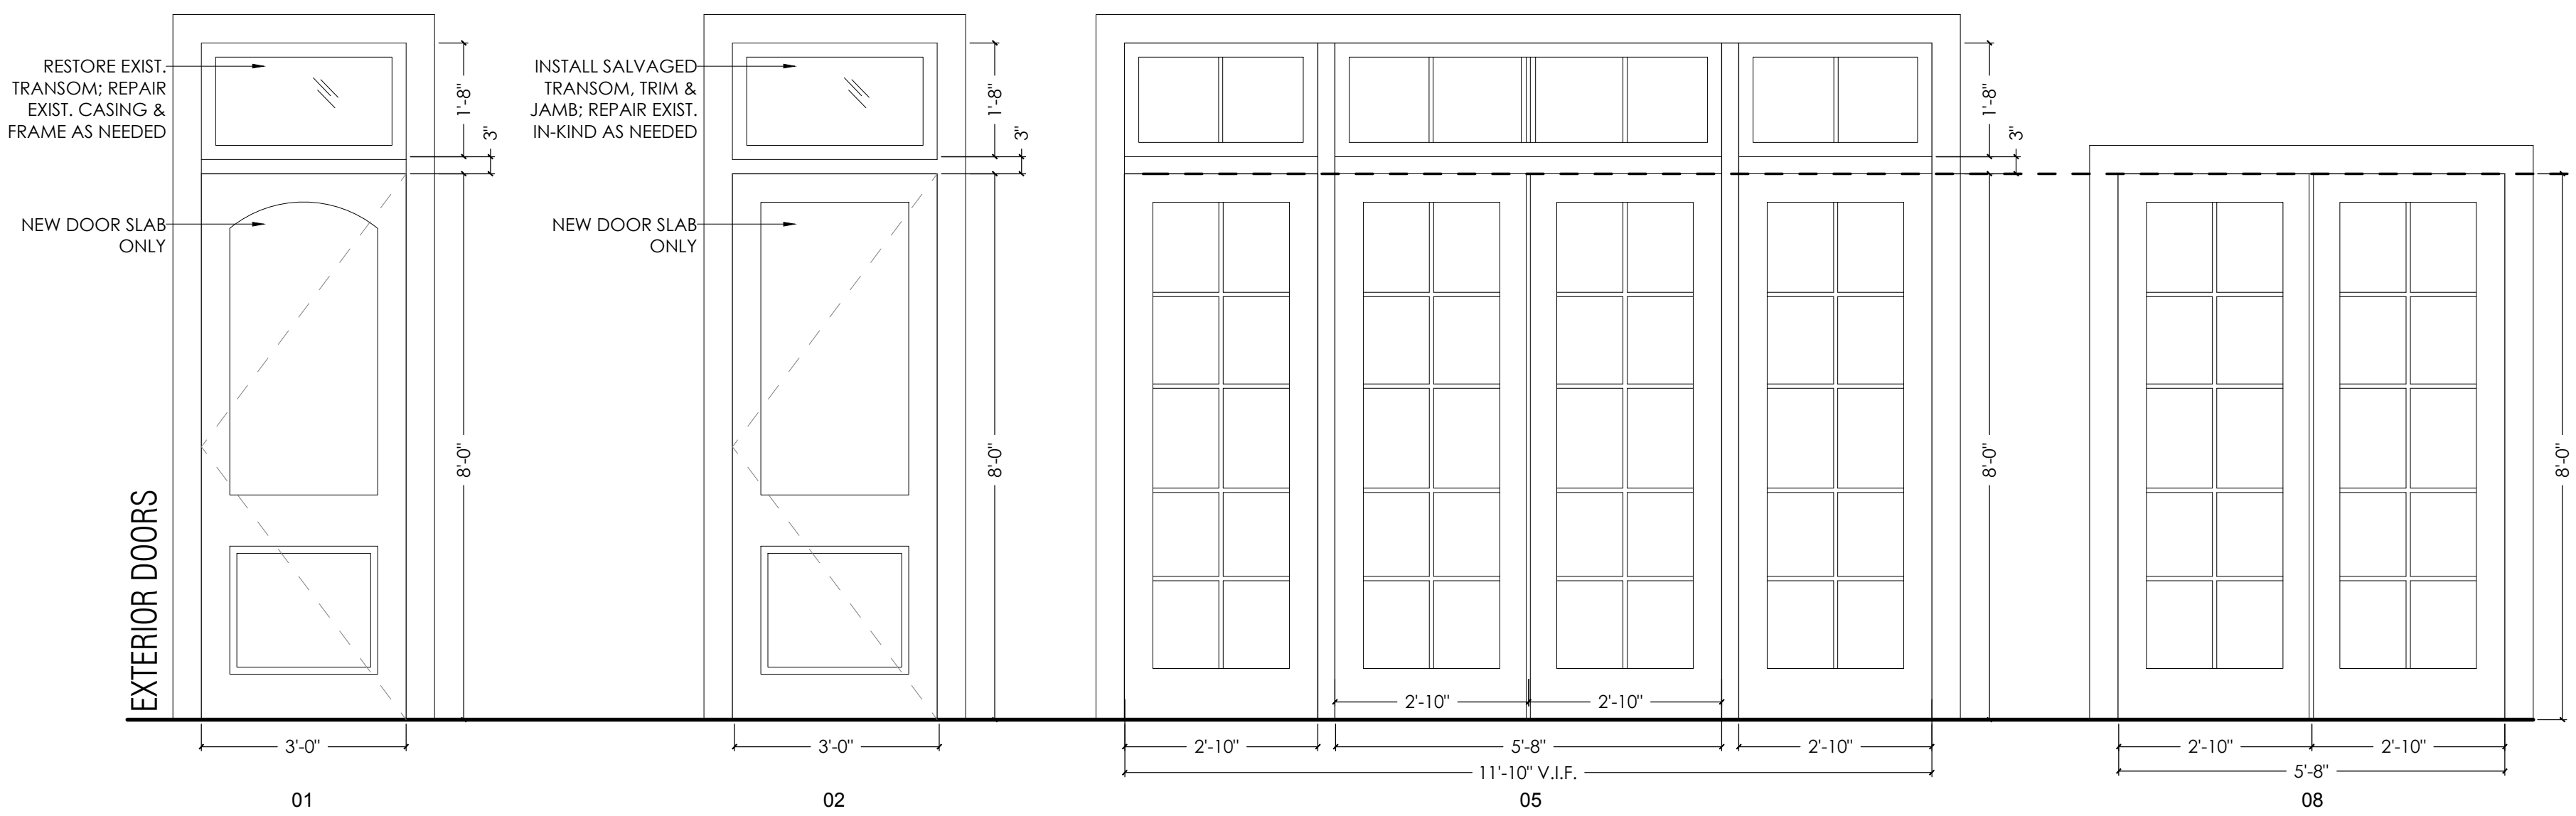

## 01 DOOR TYPES

SCALE: 1/2" = 1'-0"

**CARPENTRY NOTES:**


**EXTERIOR TRIM NOTES:**

1. WINDOW DRIP EDGE & FLASHING TO BE INSTALLED AT HEAD OF ALL WINDOWS & EXTERIOR DOORS. SILL DAM TO BE INSTALLED AT SILLS.
2. ALL SLEEPING AREAS TO HAVE AT LEAST ONE WINDOW THAT MEETS EGRESS REQUIREMENTS OF IRC 2015 - 5.7 SF OPEN AREA.
3. FULLY CASE ALL WINDOWS WITH 1X4 HARDIE TRIM ON EXTERIOR.
4. GC TO PROVIDE ½" PLYWOOD PANELS SIZED TO FIT EACH WINDOW OPENING FOR OWNER TO STORE ON SITE


**INTERIOR TRIM NOTES:**

5. FINGER-JOIN, PAINTED WOOD BASE BOARD AT ALL FLOORS; SEE  
BASE TRIM DETAIL 02/A3.4

6. WOOD CASING ON INTERIOR PROFILE TO MATCH EXISTING - MITER  
ALL TRIM CORNERS

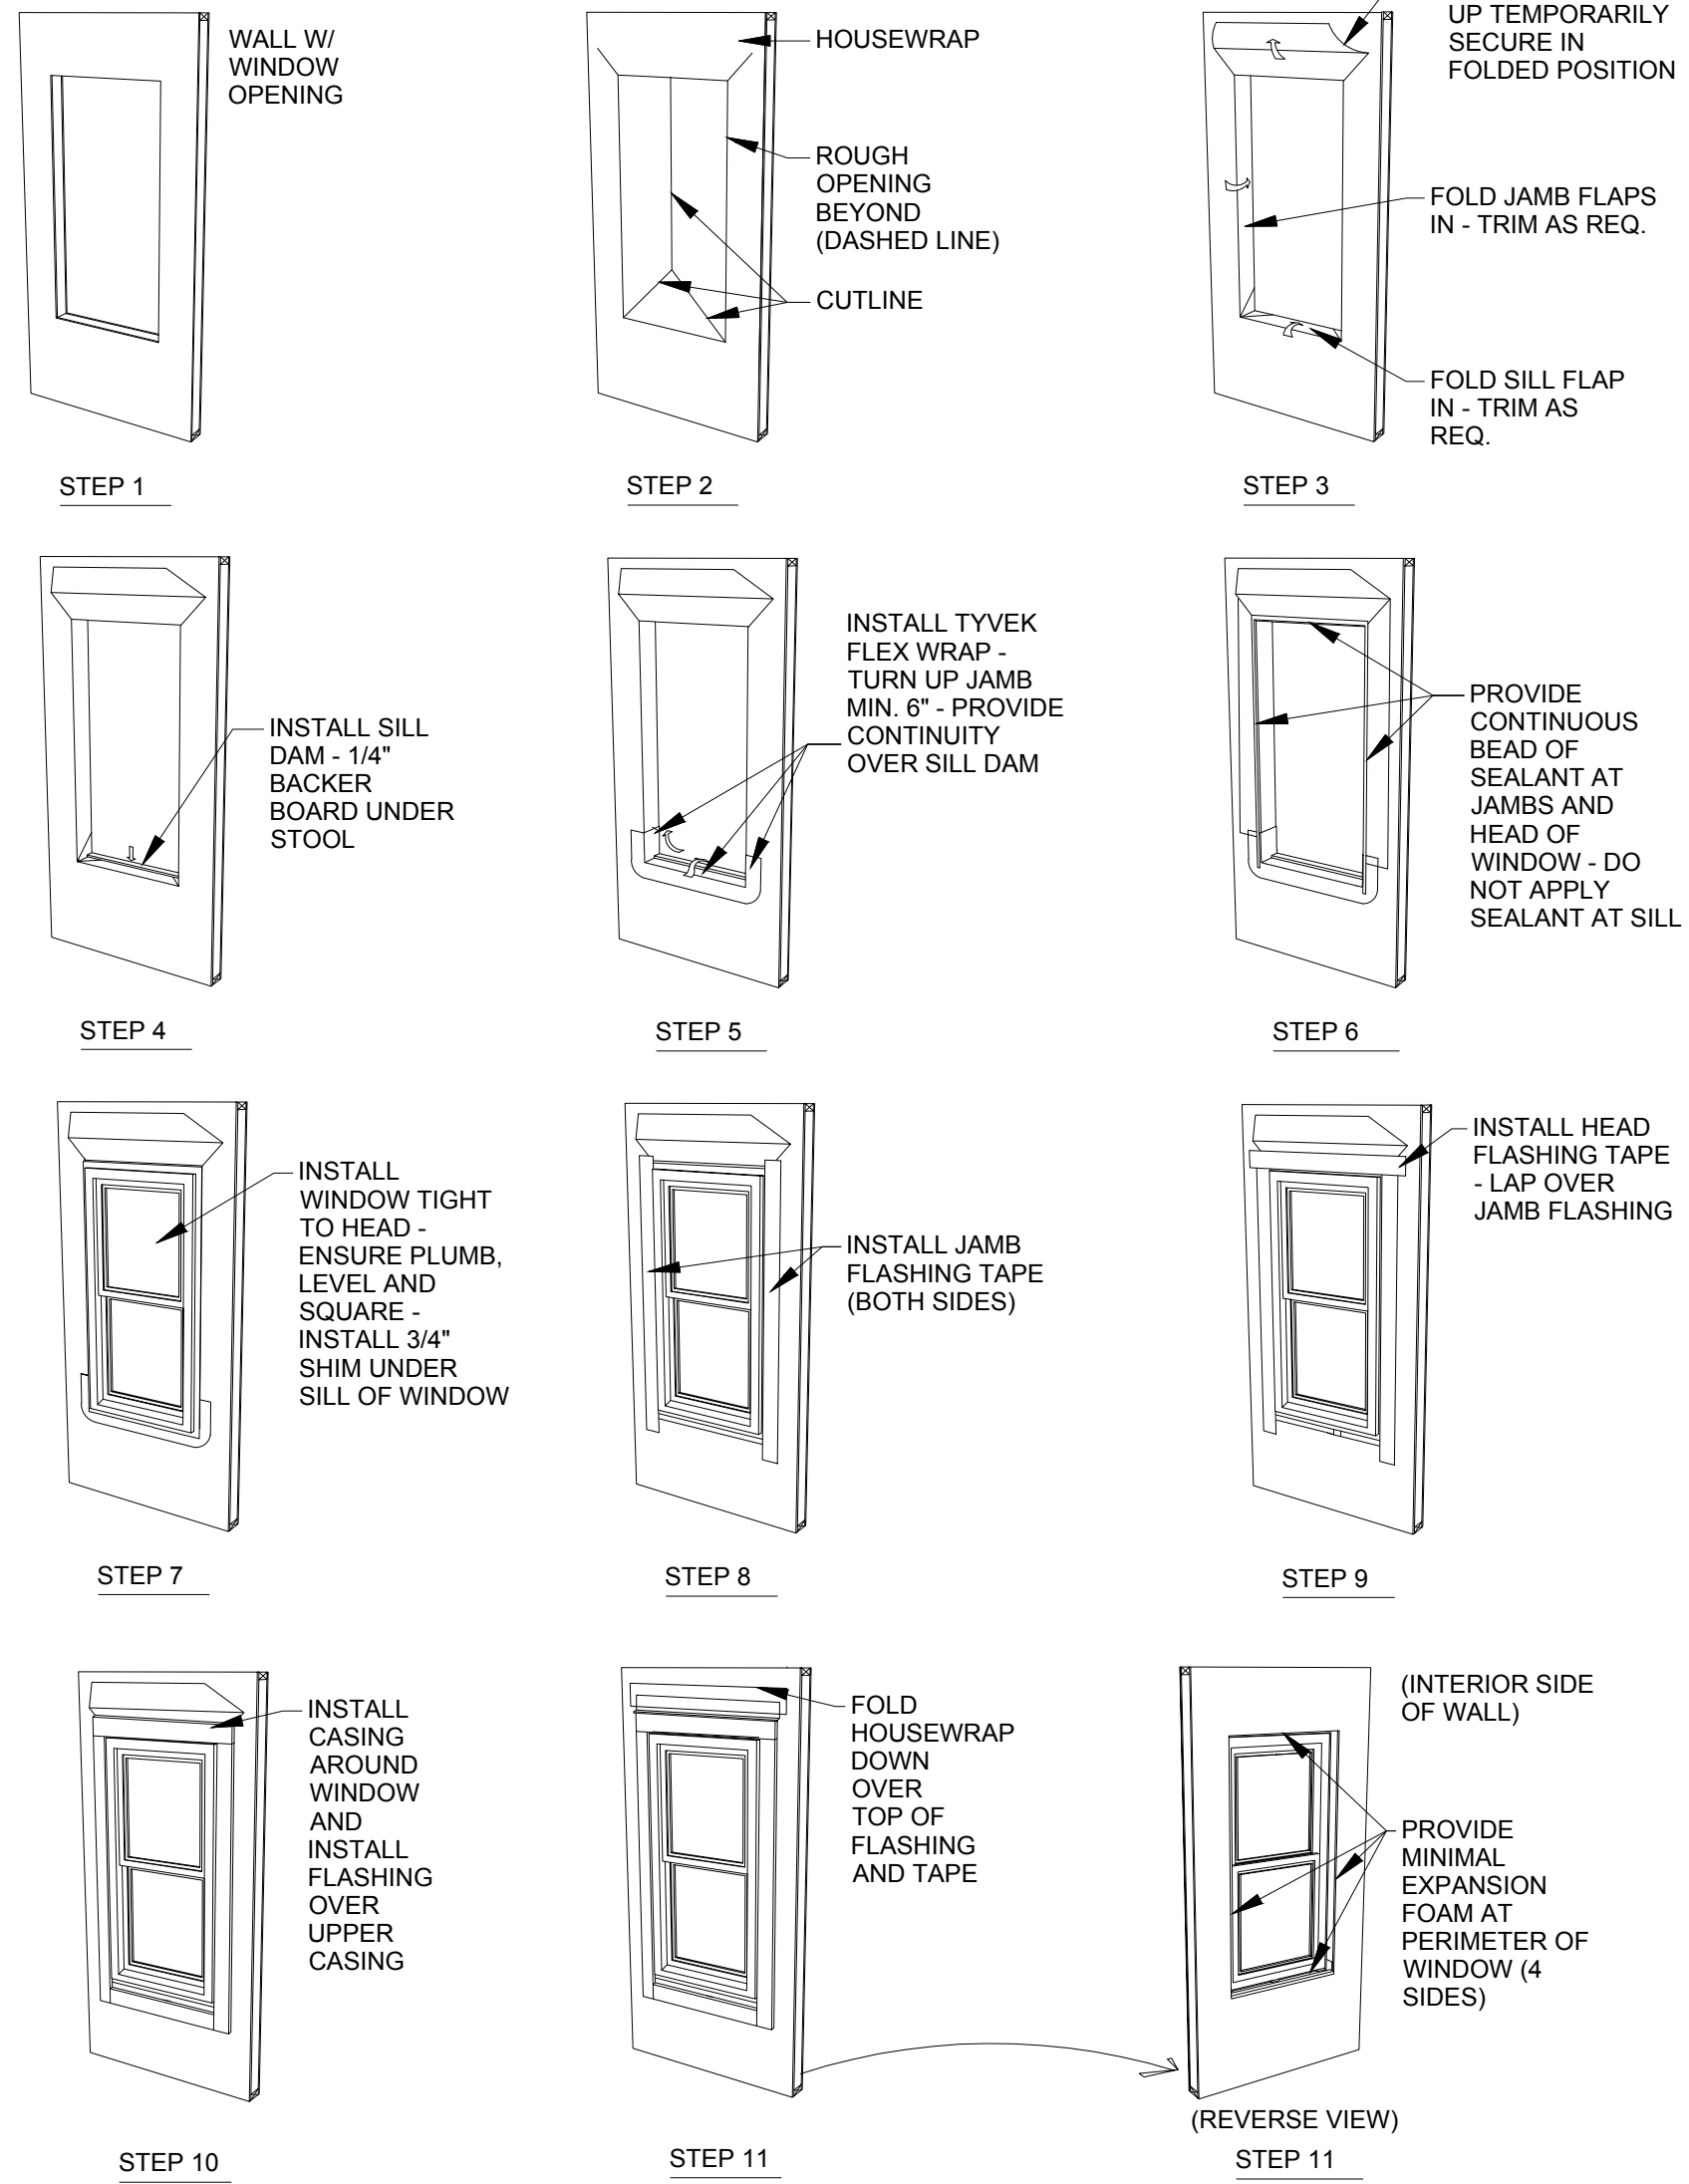

03 TYPICAL WINDOW INSTALLATION  
SCALE: N.T.S.

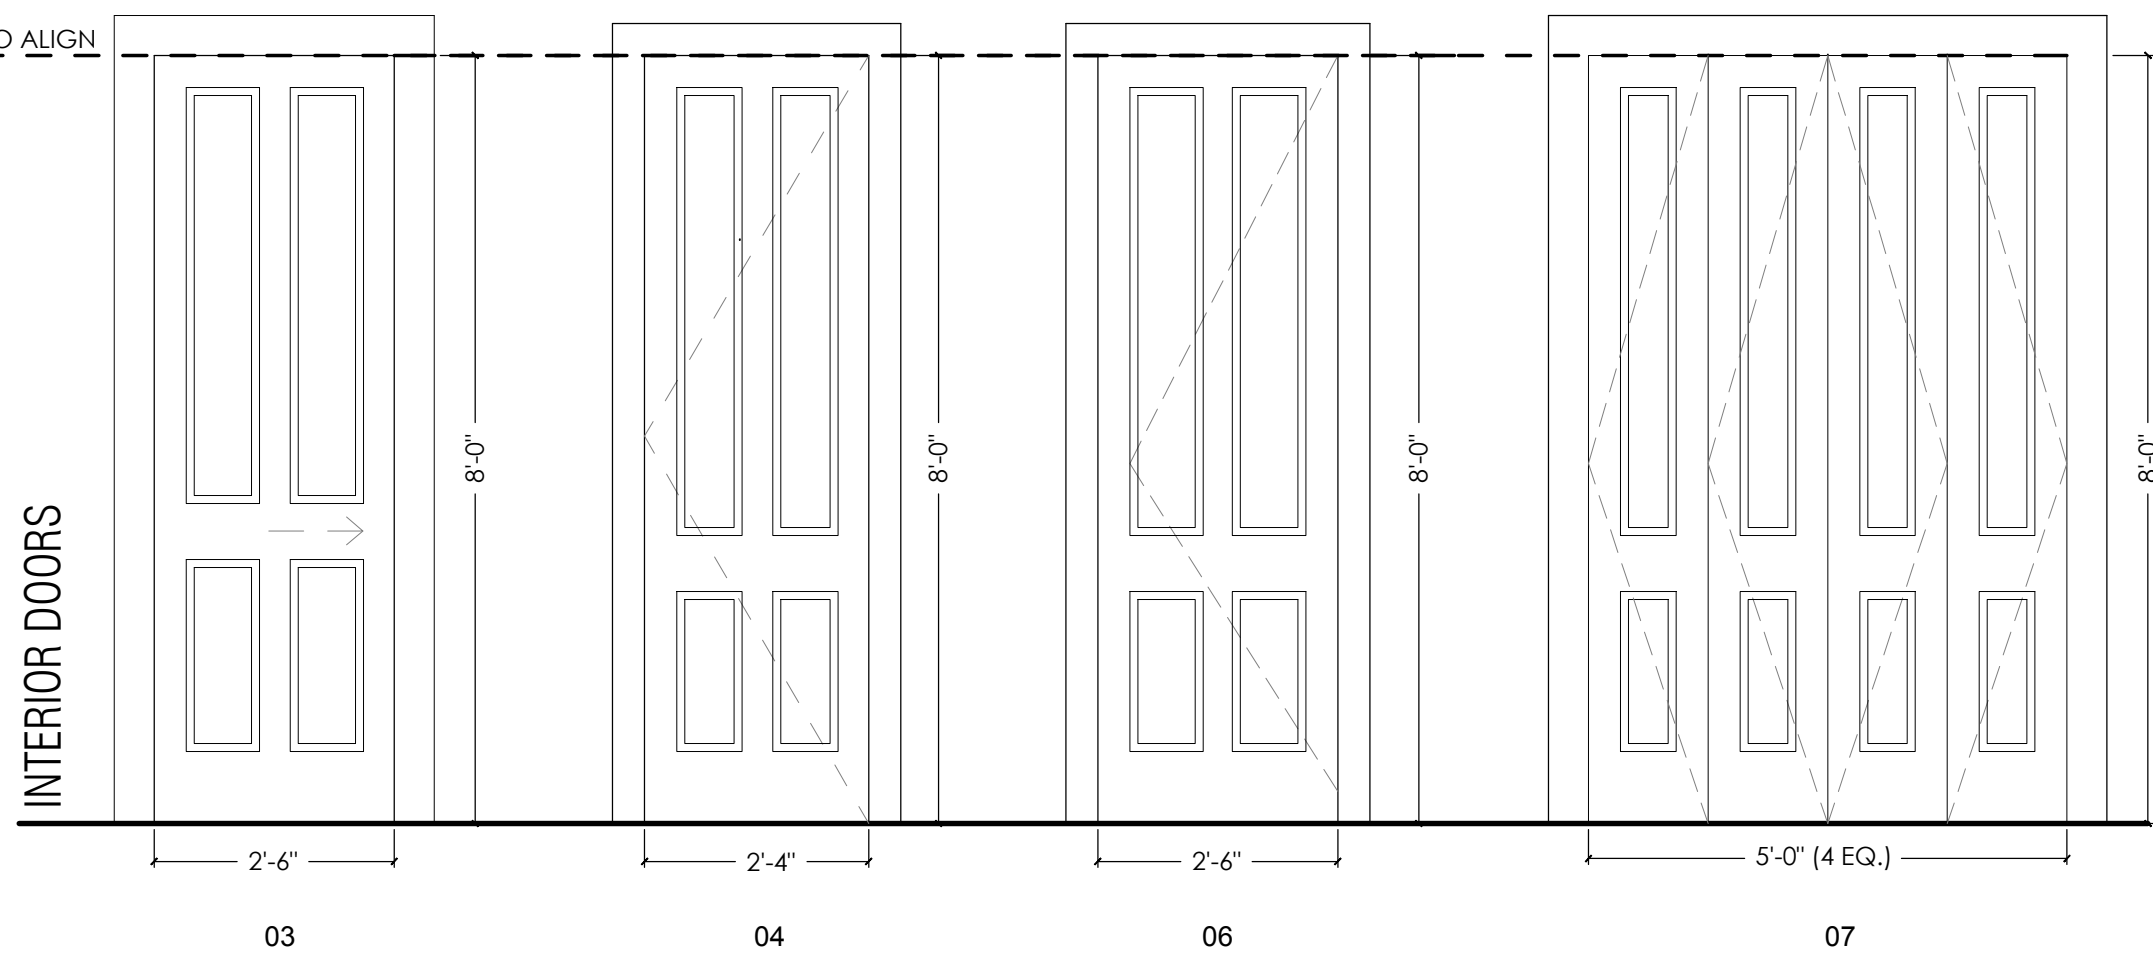

# ARCHETYPE

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CRISCO RESIDENCE  
2827-2831 CHIPPEWA STREET  
NEW ORLEANS, LOUISIANA 70115

SEAL:



ISSUE DATE:  
OCTOBER 05, 2022

DRAWING TITLE:  
OPENING SCHEDULES  
& TYPES

DRAWING NUMBER:

## A2.0





ARCHETYPE

| REVISIONS |  | No. | Date | Scope |
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CRISCO RESIDENCE  
2827-2831 CHIPPEWA STREET  
NEW ORLEANS, LOUISIANA 70115

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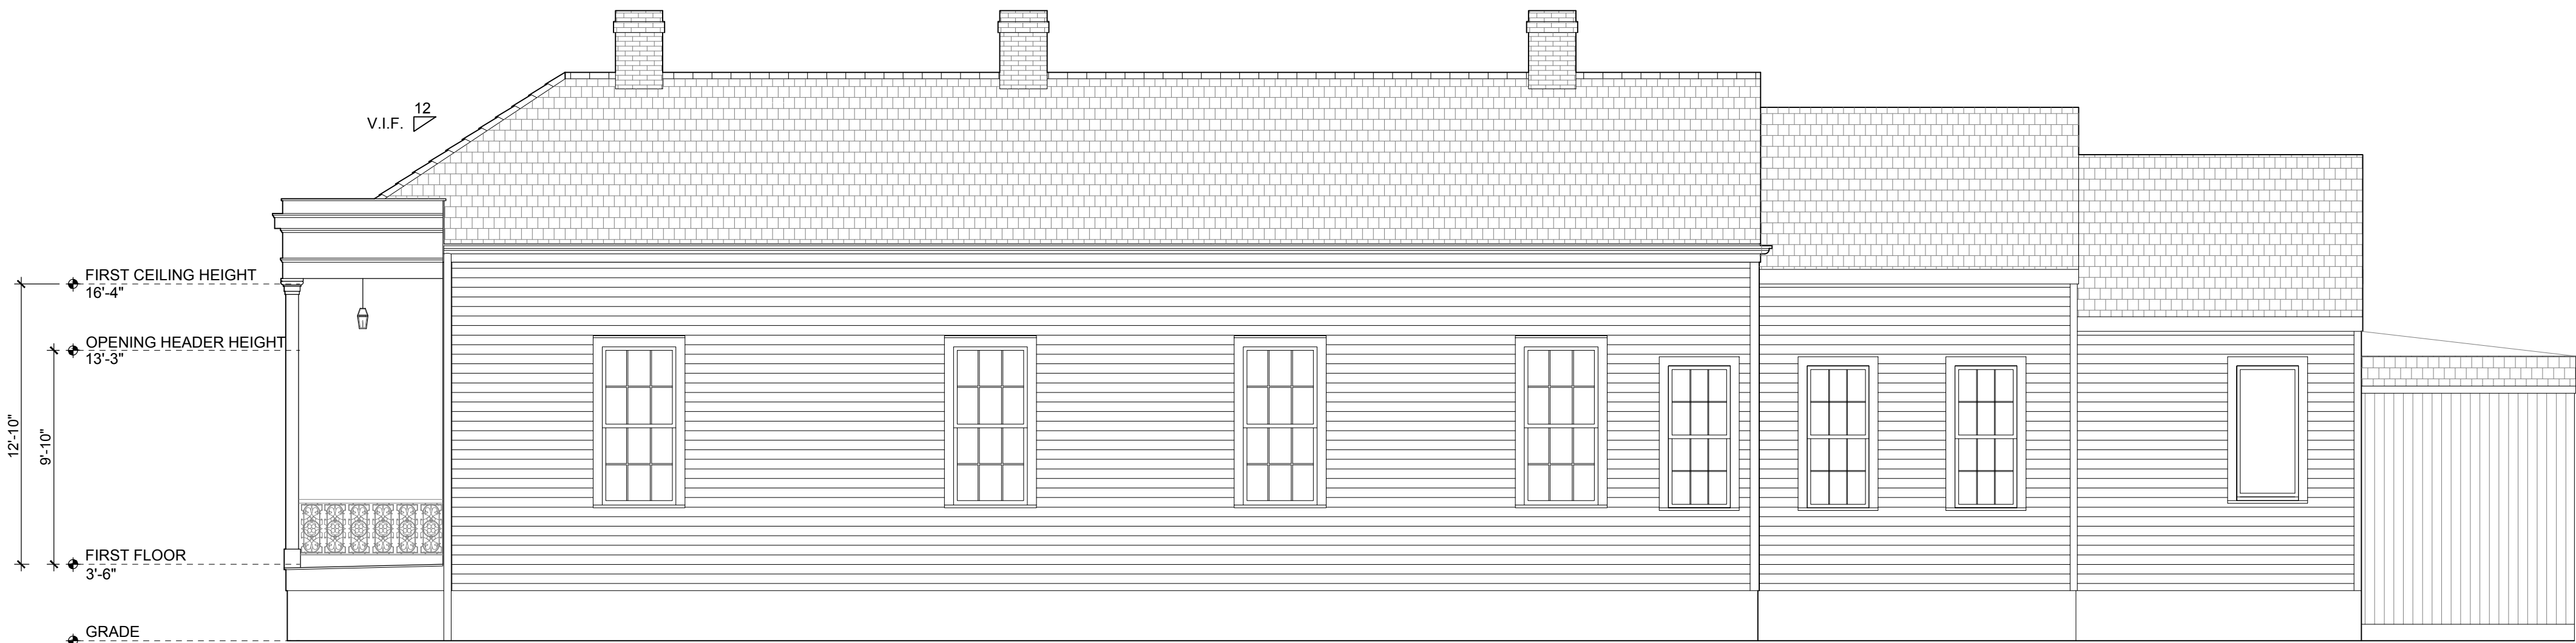


ISSUE DATE:  
OCTOBER 05, 2022

DRAWING TITLE:  
EXISTING  
EXTERIOR ELEVATIONS

DRAWING NUMBER:

A3.0




03 WASHINGTON AVENUE (SIDE) ELEVATION  
SCALE: 3/16" = 1'-0"



04 ANNUNCIATION STREET (SIDE) ELEVATION  
SCALE: 3/16" = 1'-0"



01 SIXTH STREET (SIDE) ELEVATION  
SCALE: 3/16" = 1'-0"

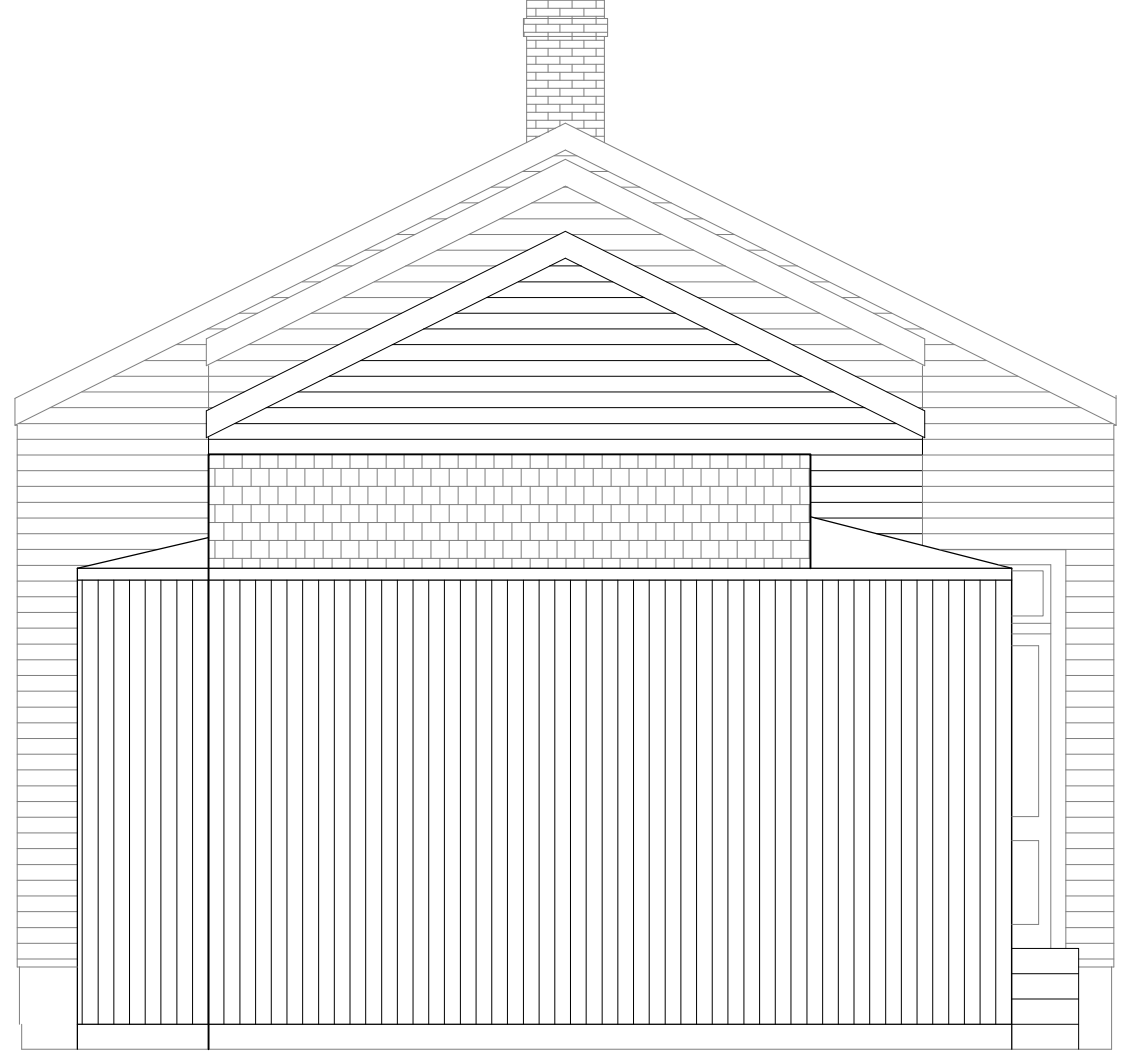


02 CHIPPEWA STREET ELEVATION  
SCALE: 3/16" = 1'-0"





ARCHETYPE

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2827-2831 CHIPPEWA STREET  
NEW ORLEANS, LOUISIANA 70115

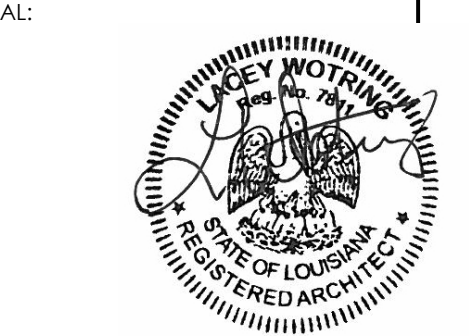


ISSUE DATE:  
OCTOBER 05, 2022  
DRAWING TITLE:  
PROPOSED  
EXTERIOR ELEVATIONS  
DRAWING NUMBER:

A3.1



03 WASHINGTON AVENUE (SIDE) ELEVATION  
SCALE: 3/16" = 1'-0"

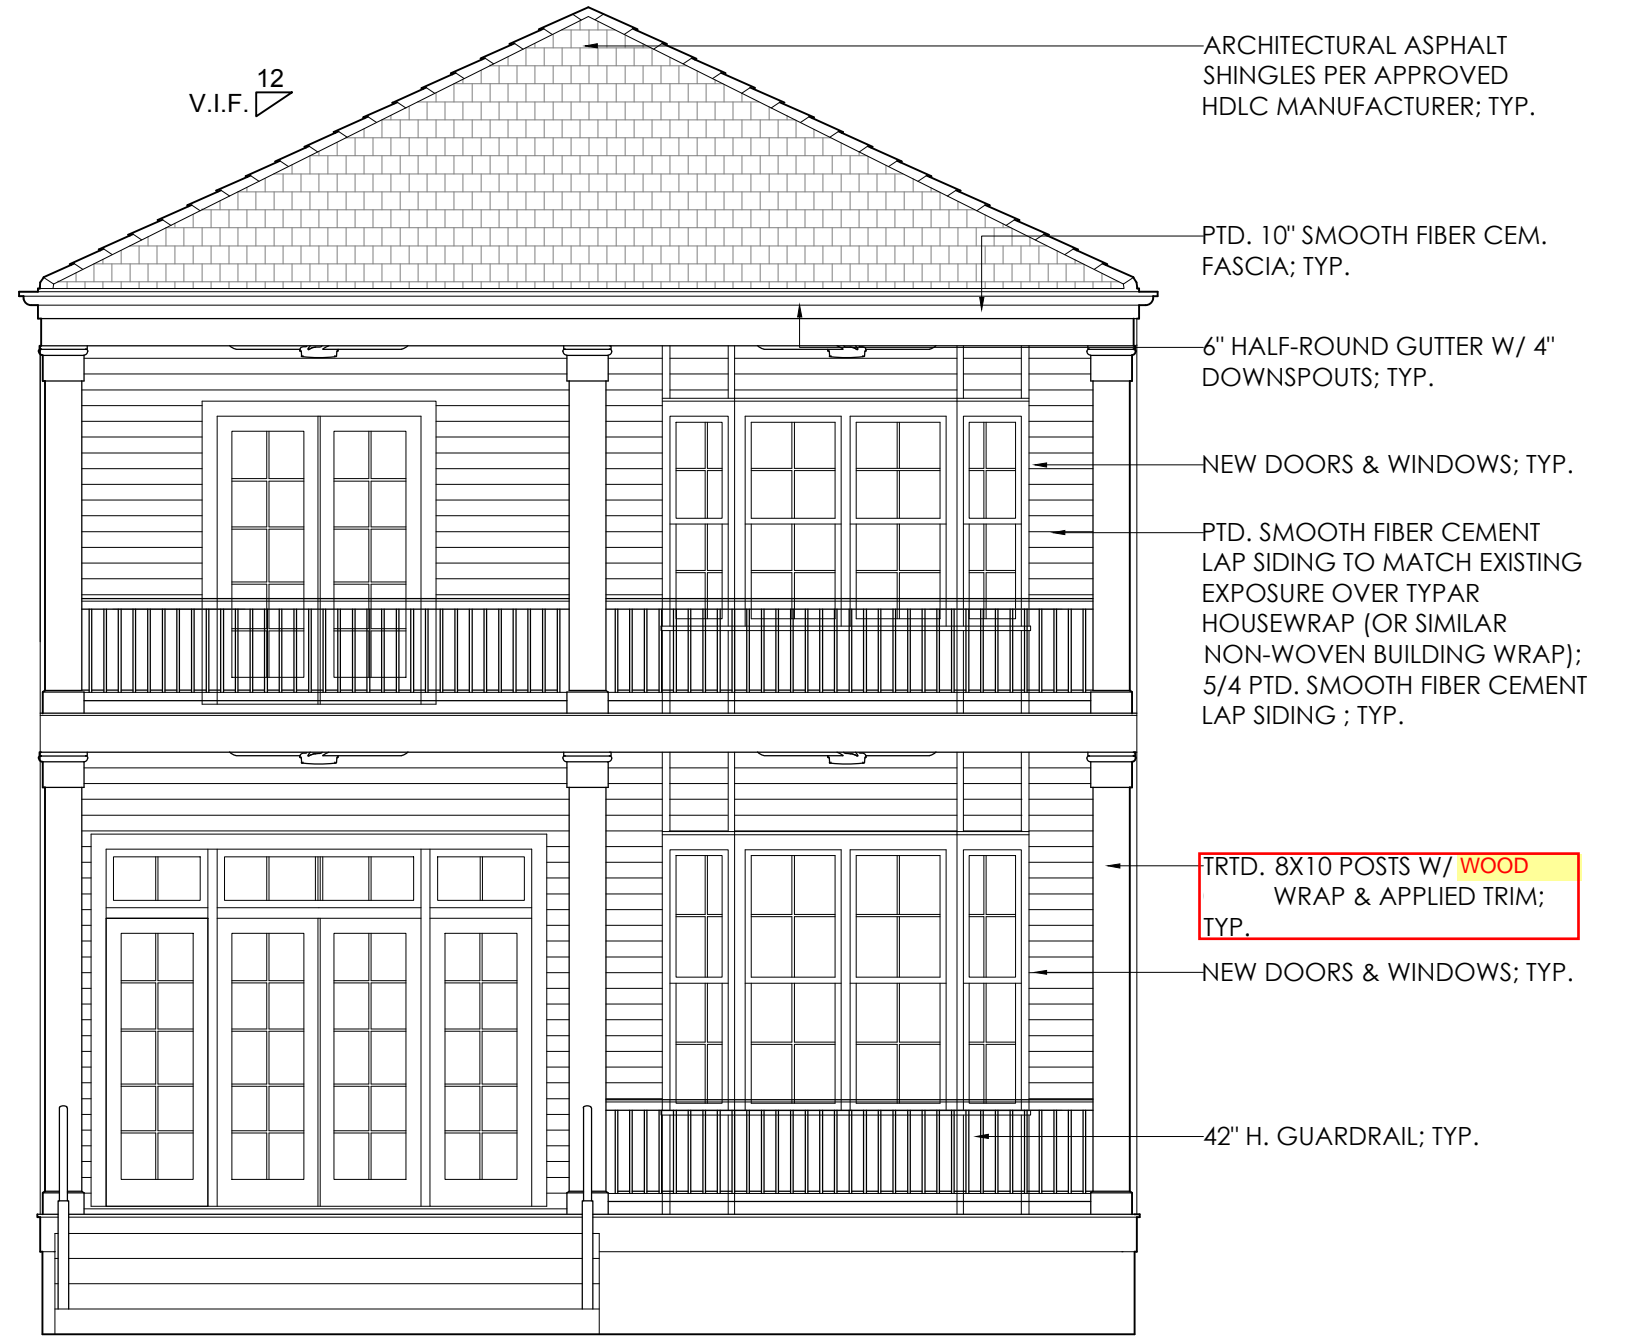

04 ANNUNCIATION STREET (SIDE) ELEVATION  
SCALE: 3/16" = 1'-0"



01 SIXTH STREET (SIDE) ELEVATION  
SCALE: 3/16" = 1'-0"



02 CHIPPEWA STREET ELEVATION  
SCALE: 3/16" = 1'-0"





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CRISCO RESIDENCE  
2827-2831 CHIPPEWA STREET  
NEW ORLEANS, LOUISIANA 70115

SEAL:




ISSUE DATE:  
OCTOBER 05, 2022

DRAWING TITLE:  
BUILDING SECTION &  
PORCH DETAIL

DRAWING NUMBER:

A4.0

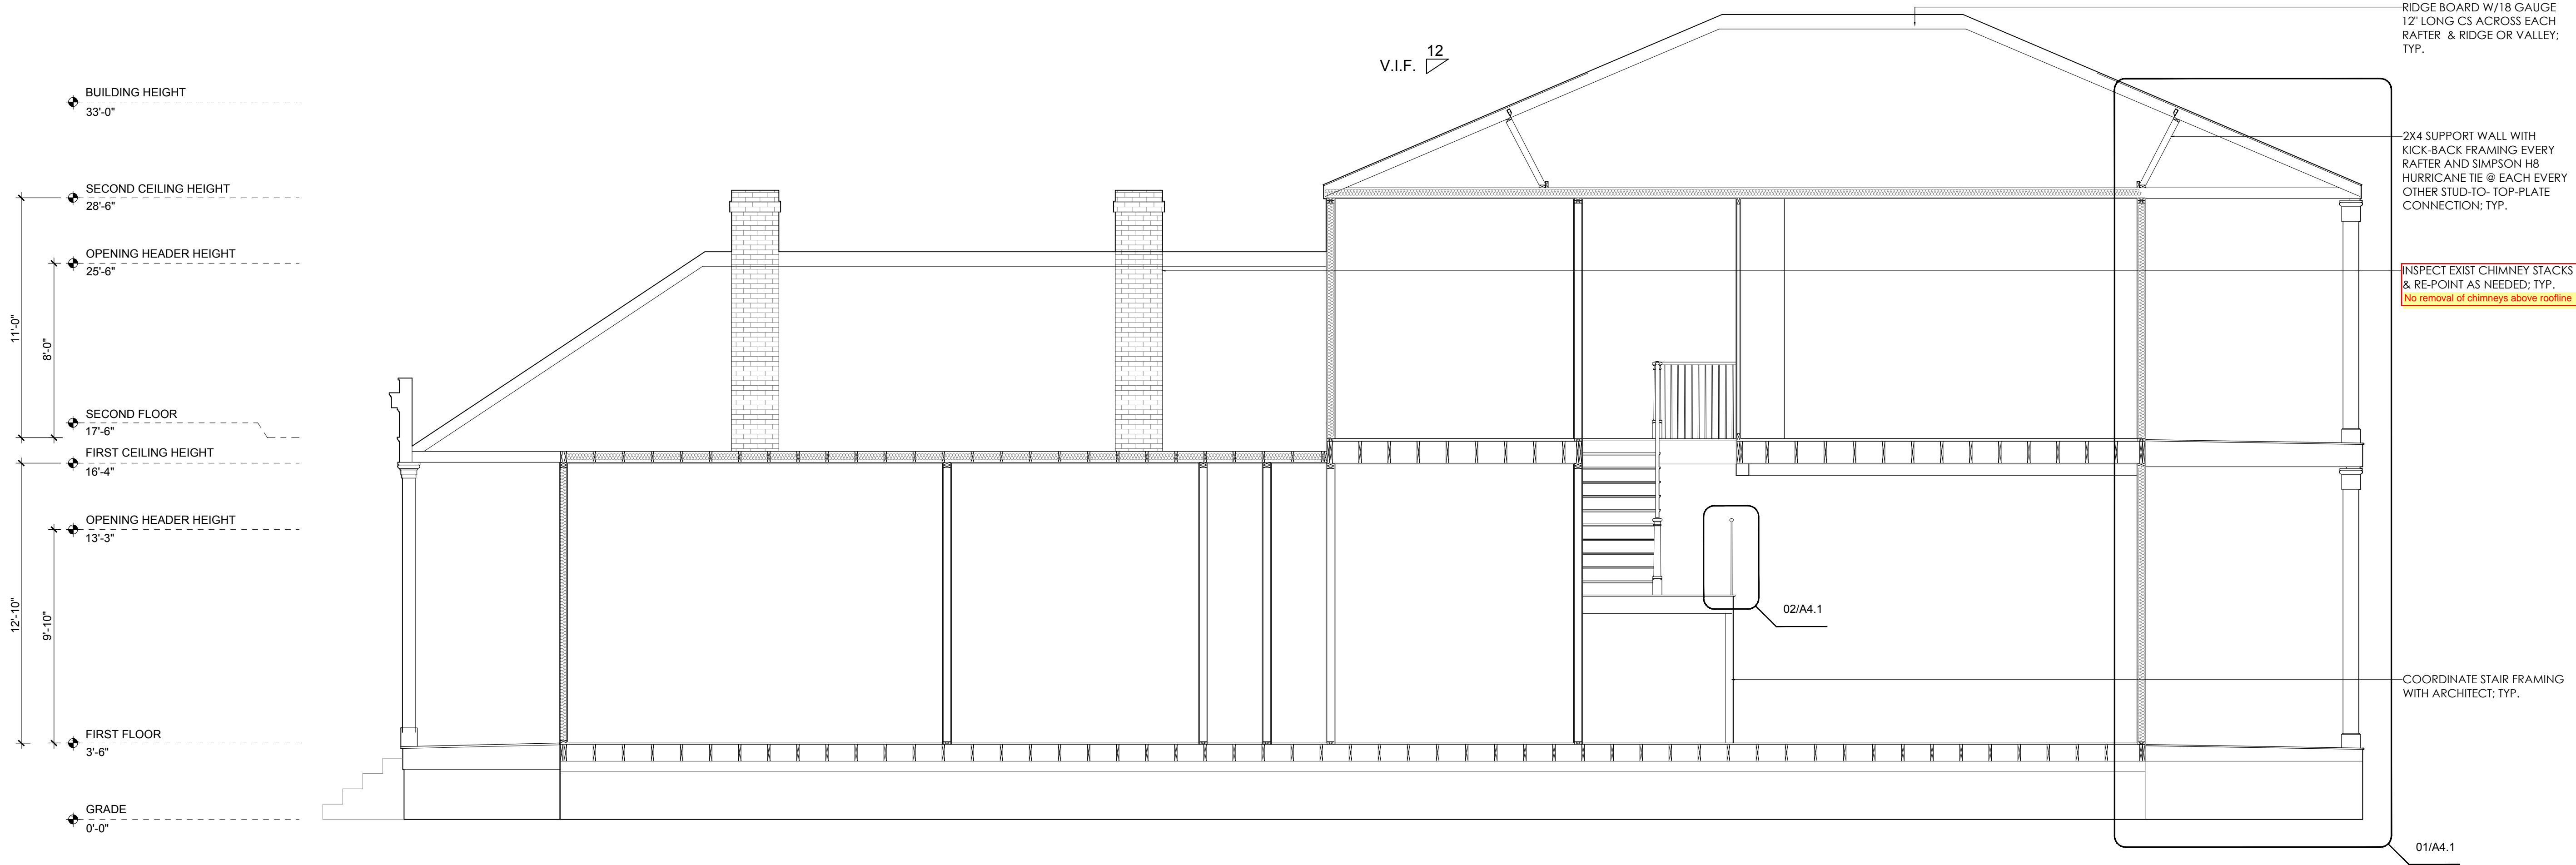

01 BUILDING SECTION  
SCALE: 1/4" = 1'-0"





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CRISCO RESIDENCE  
2827-2831 CHIPPEWA STREET  
NEW ORLEANS, LOUISIANA 70115

DRAWING NUMBER:

## A4.1



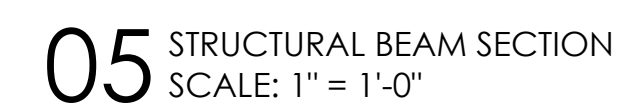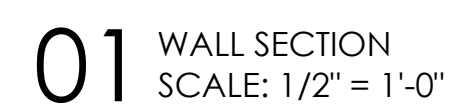





ARCHETYPE




07 DEN  
SCALE: 1/2" = 1'-0"

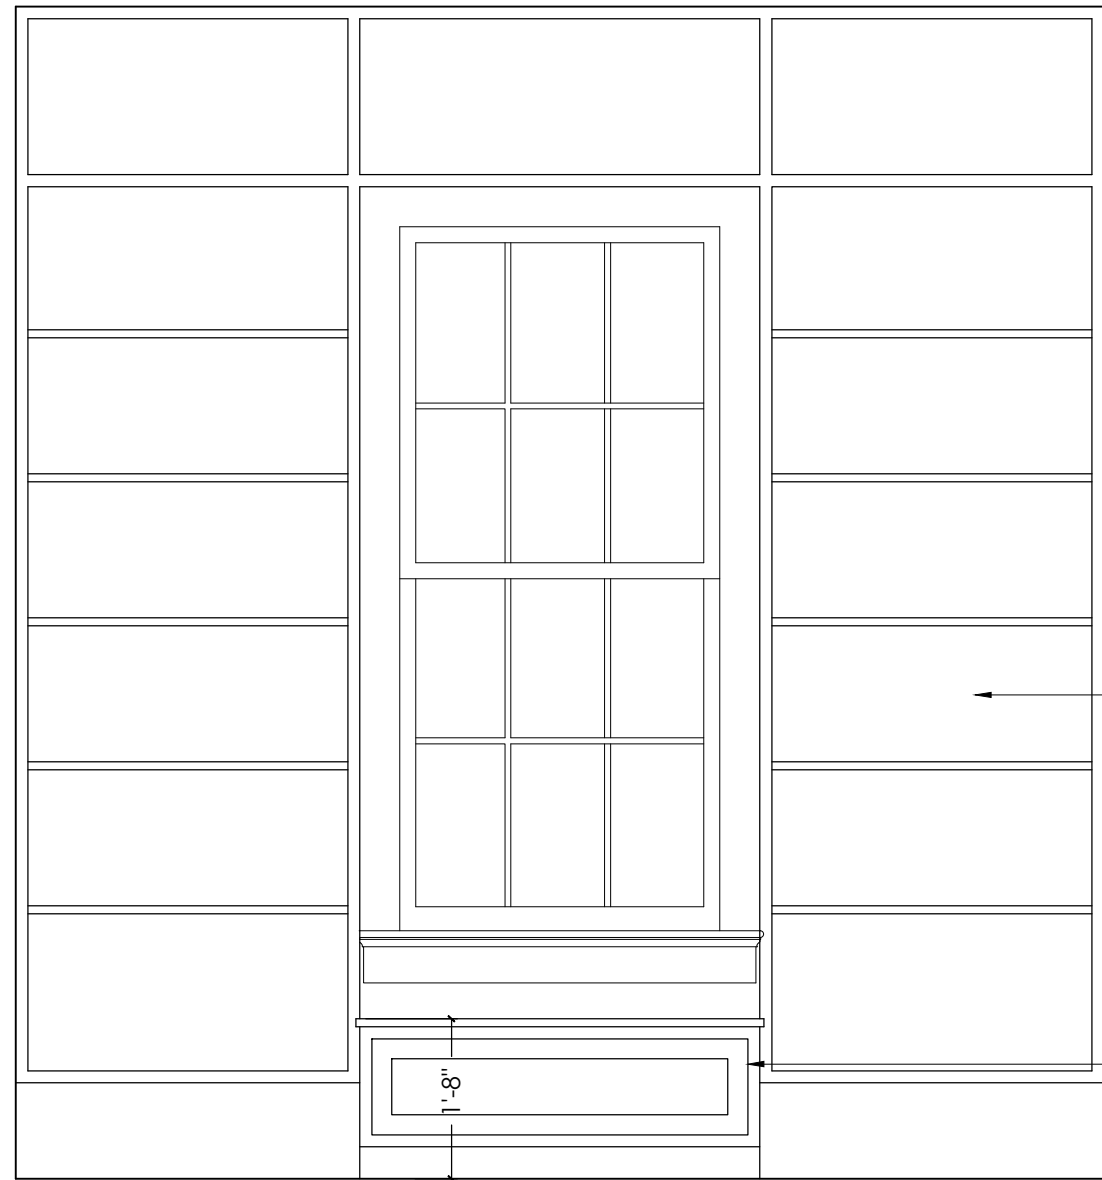

08 OFFICE  
SCALE: 1/2" = 1'-0"

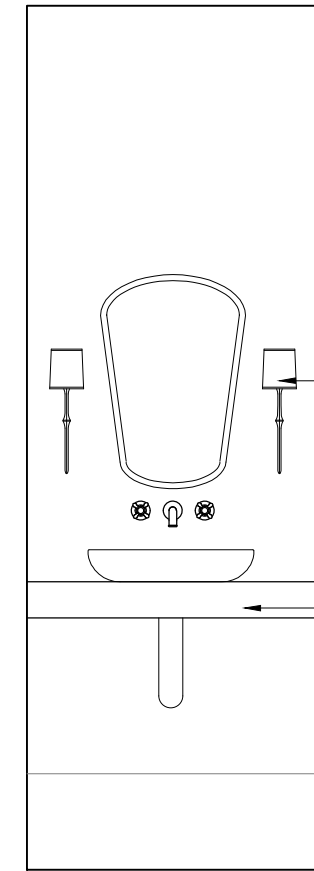


09 POWDER  
SCALE: 1/2" = 1'-0"

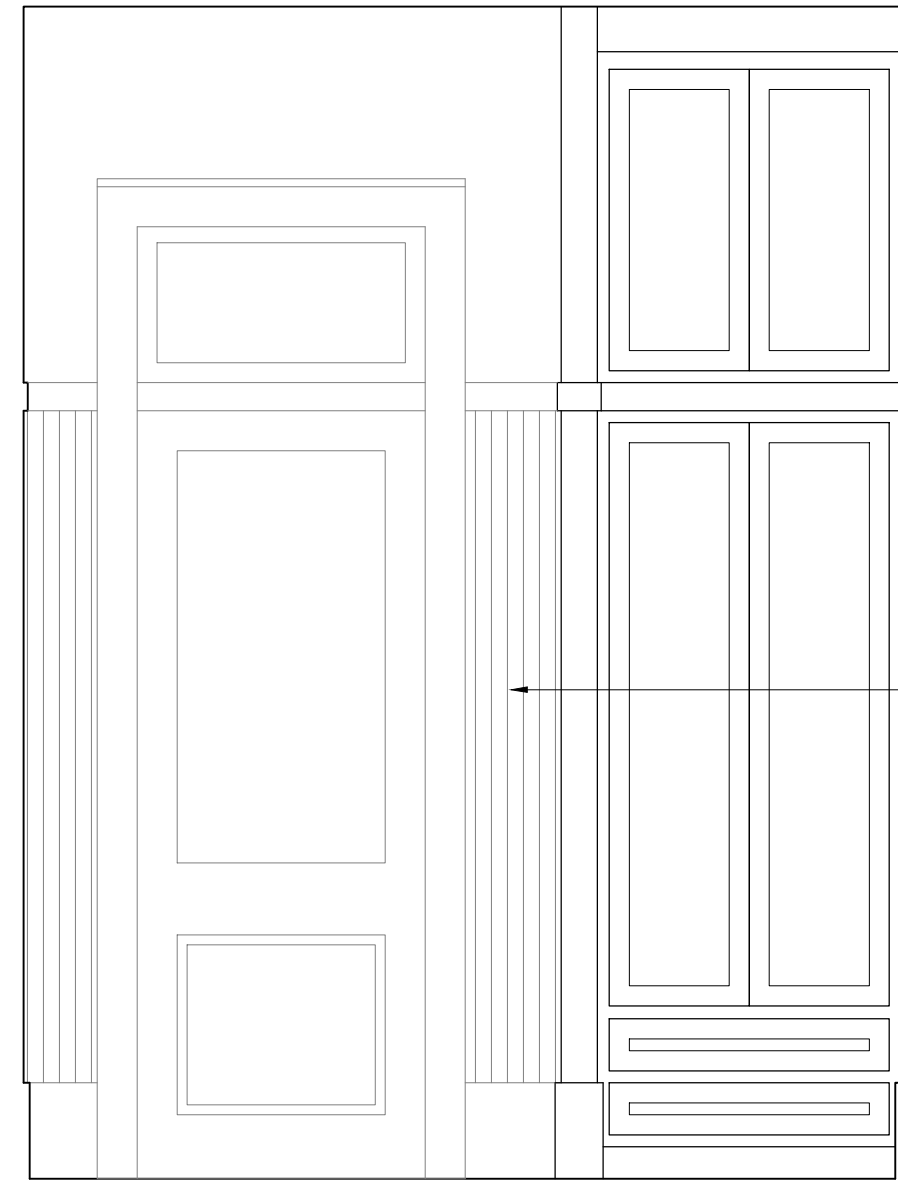

10 MUD ROOM  
SCALE: 1/2" = 1'-0"




04 KITCHEN  
SCALE: 1/2" = 1'-0"

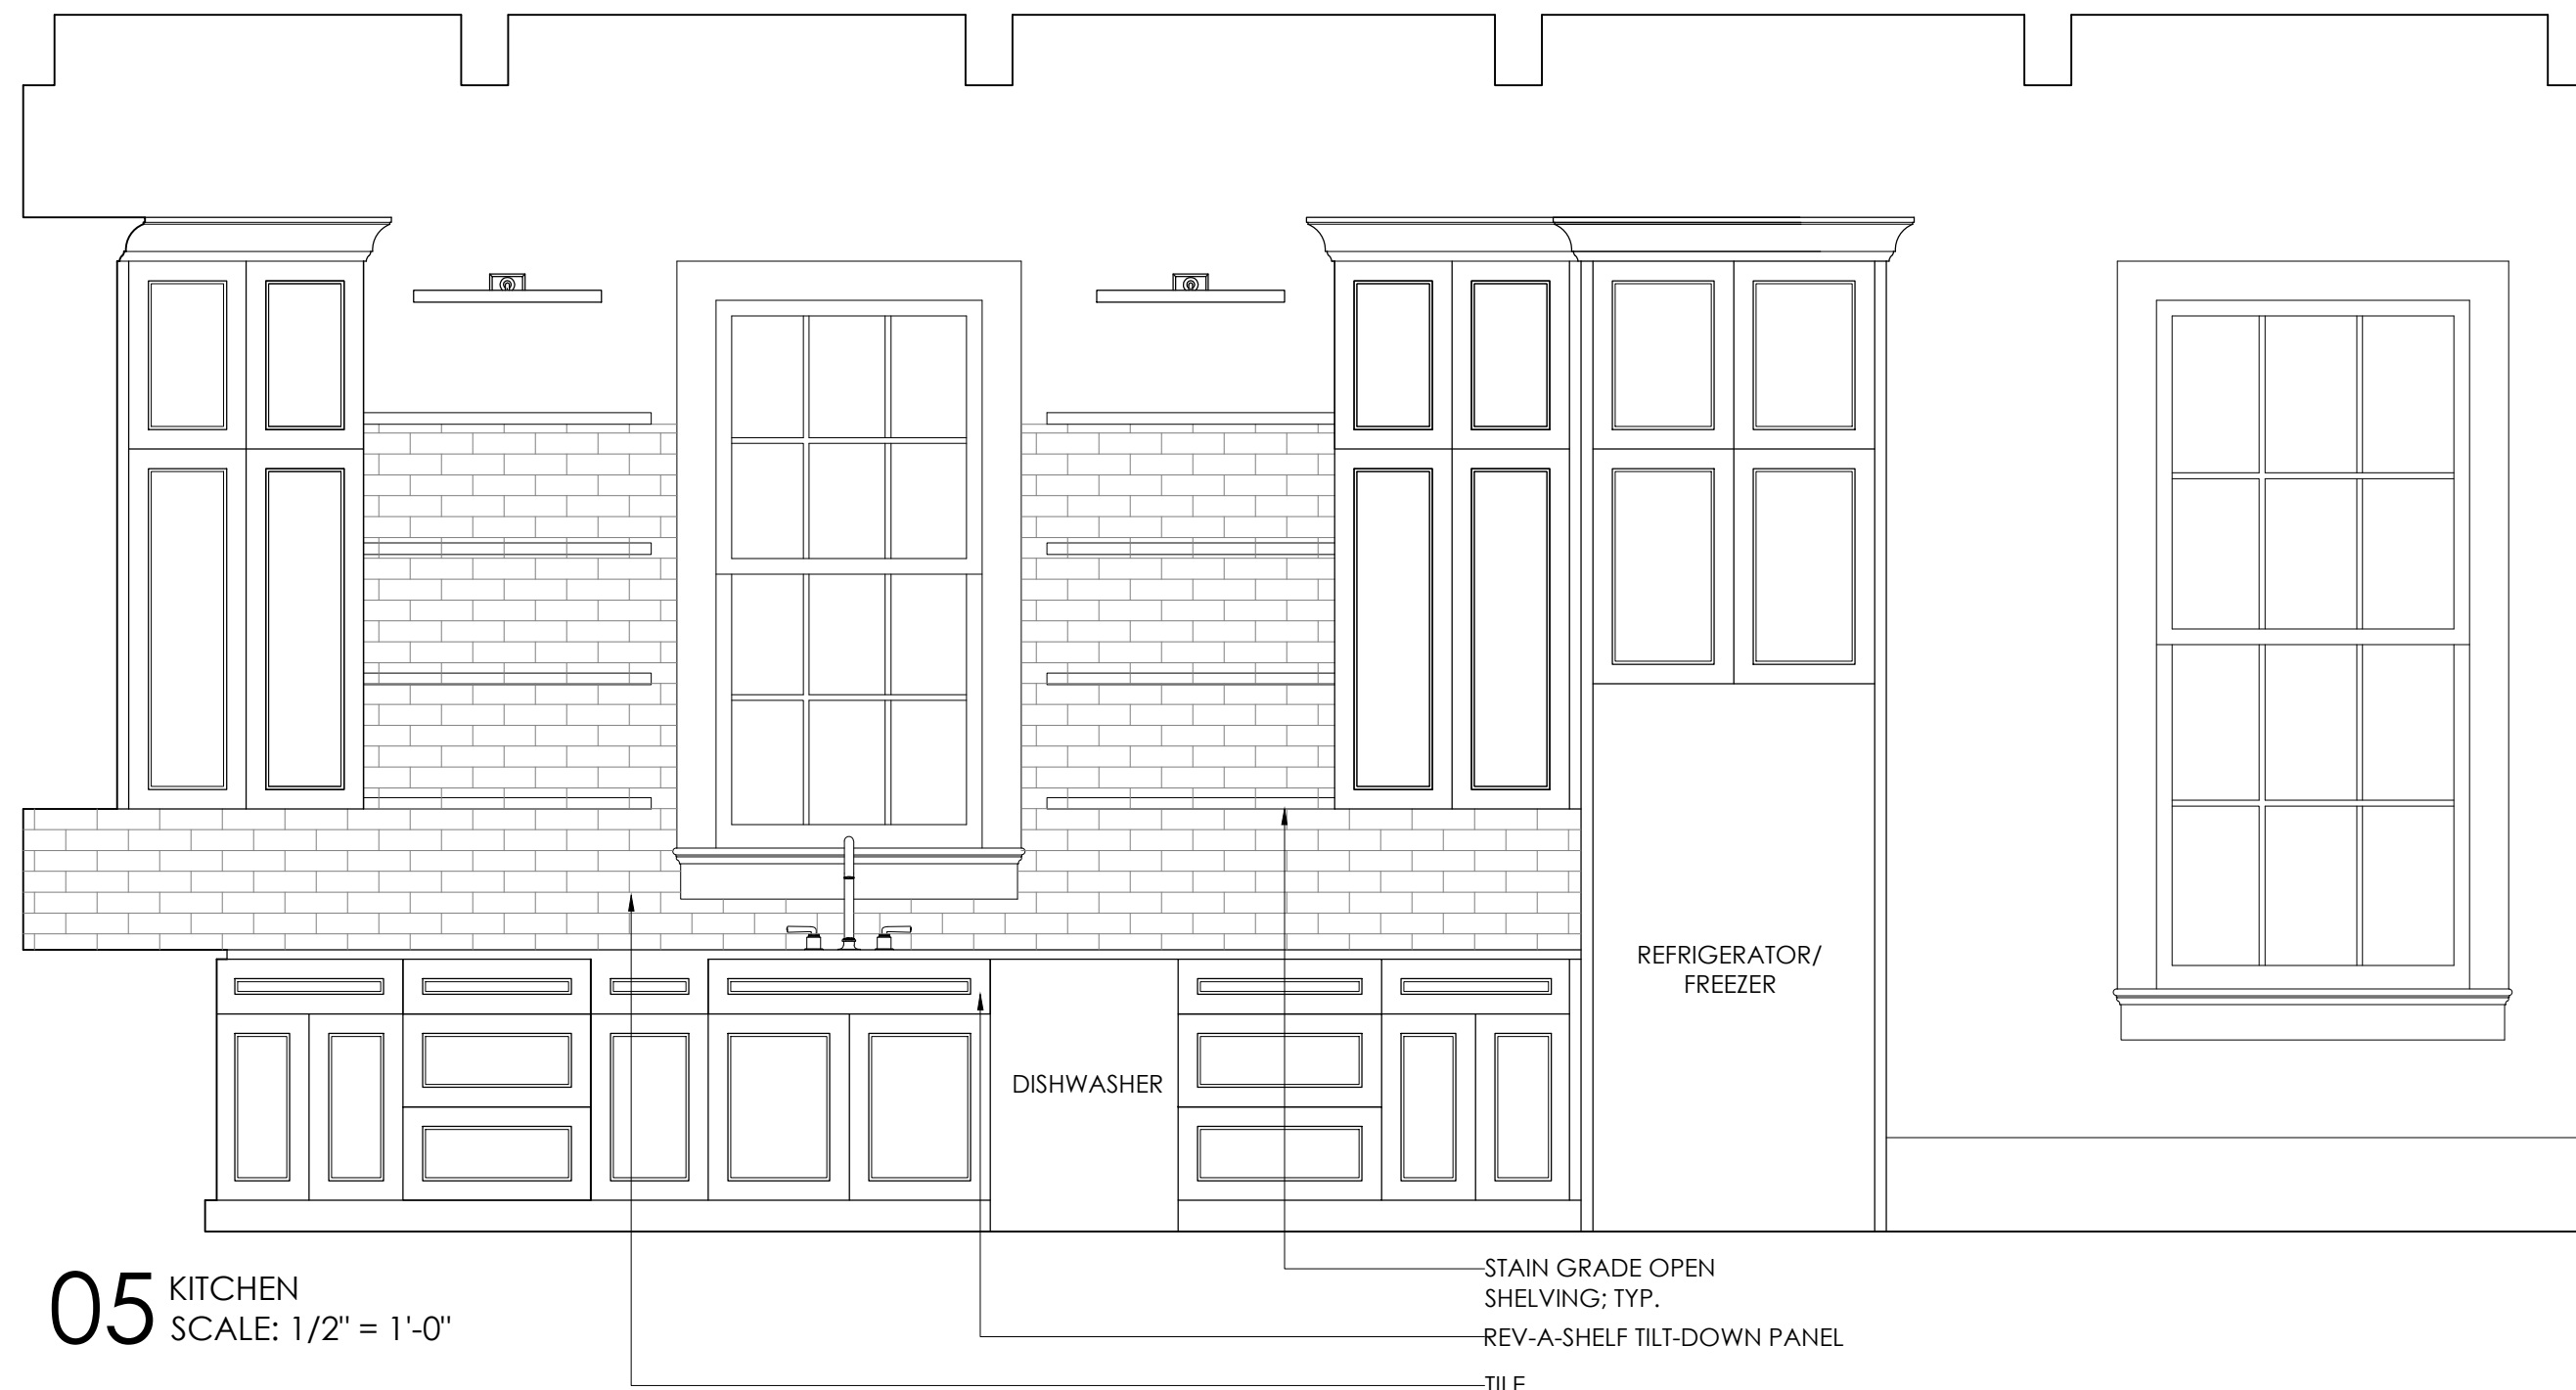


05 KITCHEN  
SCALE: 1/2" = 1'-0"




06 DEN  
SCALE: 1/2" = 1'-0"

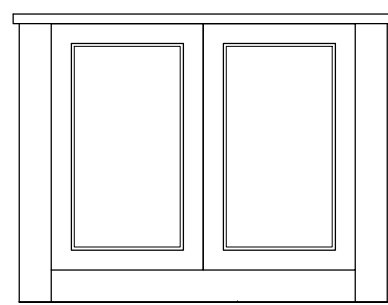

01 KITCHEN ISLAND  
SCALE: 1/2" = 1'-0"

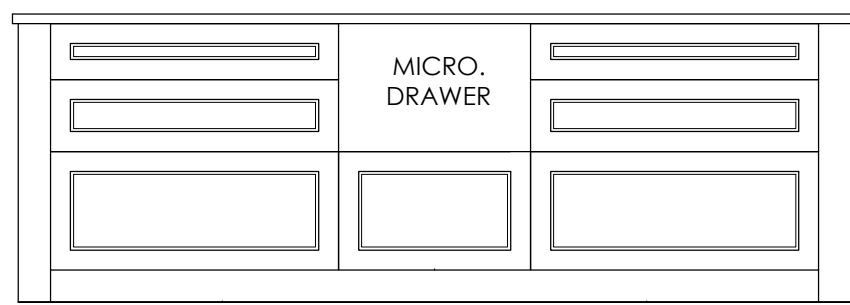

02 KITCHEN ISLAND  
SCALE: 1/2" = 1'-0"

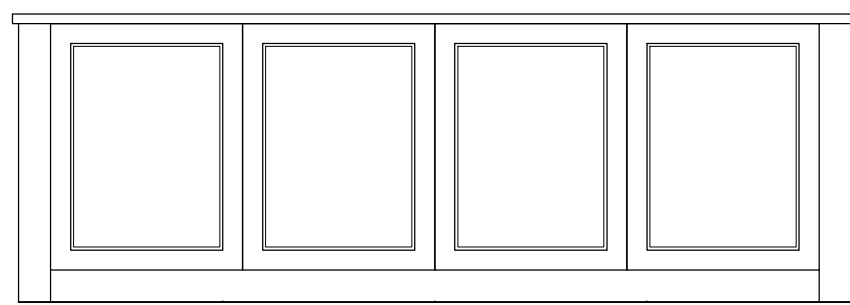

03 KITCHEN ISLAND  
SCALE: 1/2" = 1'-0"

CRISCO RESIDENCE  
2827-2831 CHIPPEWA STREET  
NEW ORLEANS, LOUISIANA 70115

SEAL:



ISSUE DATE:  
OCTOBER 05, 2022

DRAWING TITLE:  
INTERIOR ELEVATIONS


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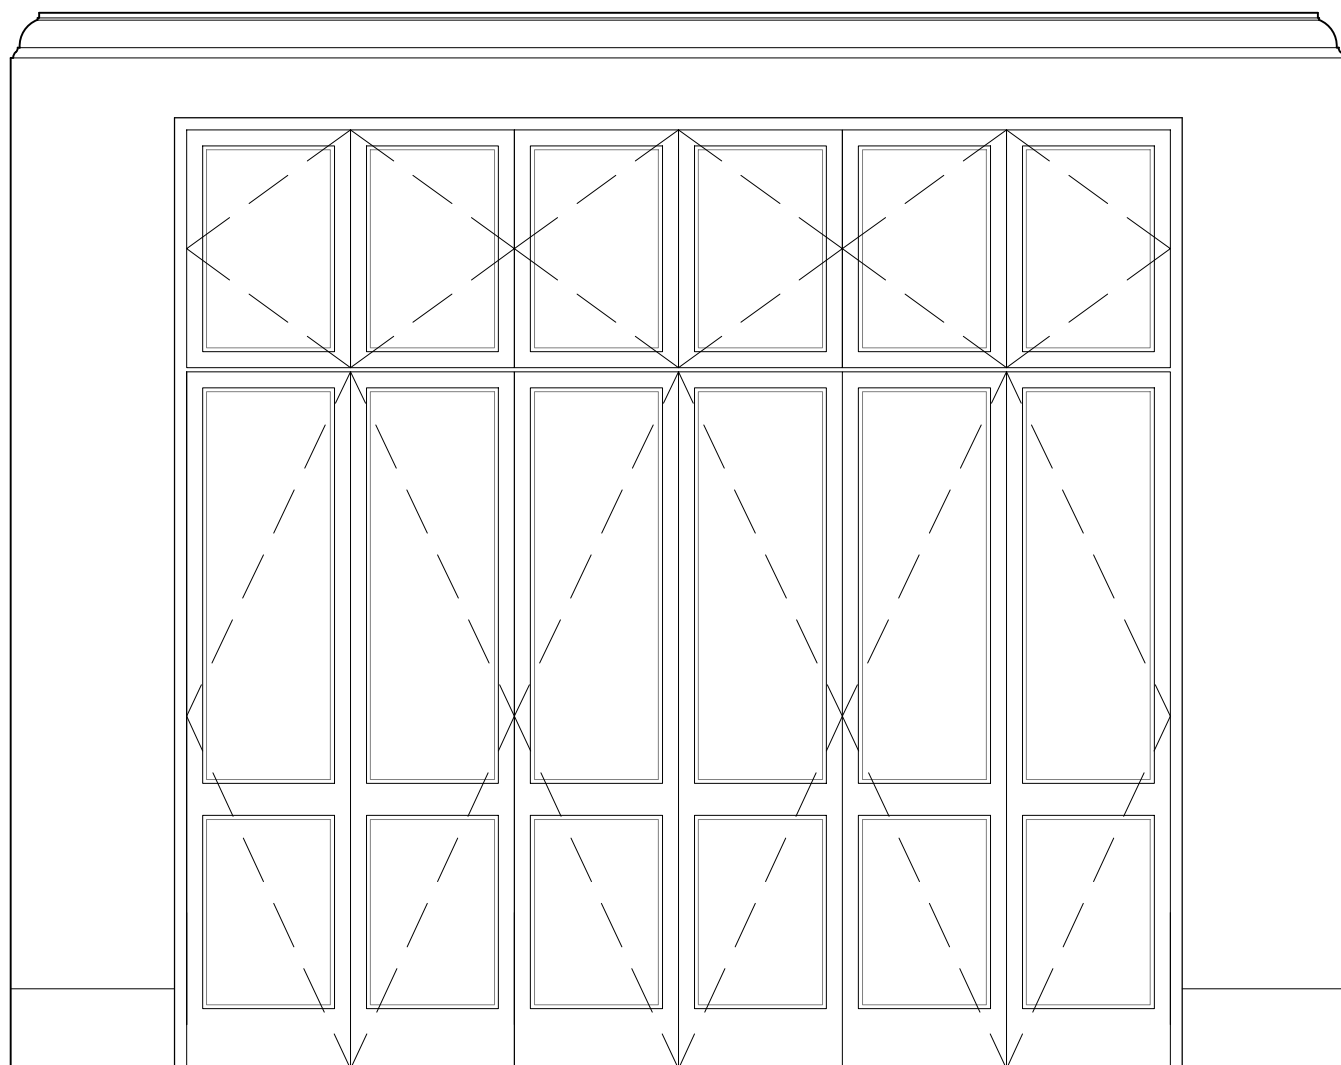


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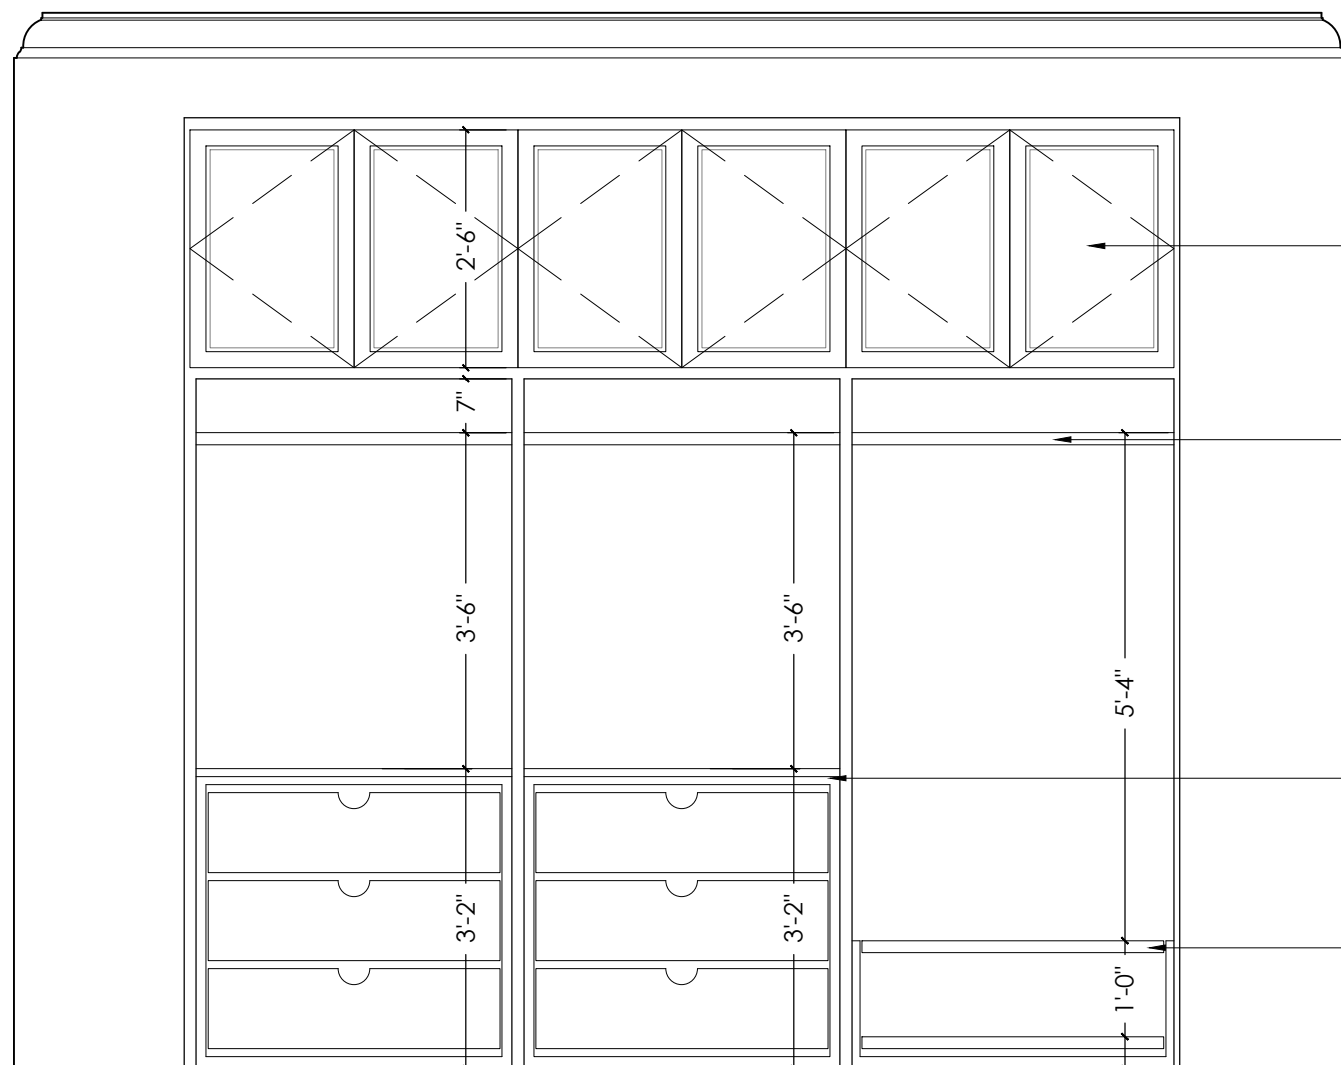


09 LAUNDRY  
SCALE: 1/2" = 1'-0"

10 LAUNDRY  
SCALE: 1/2" = 1'-0"

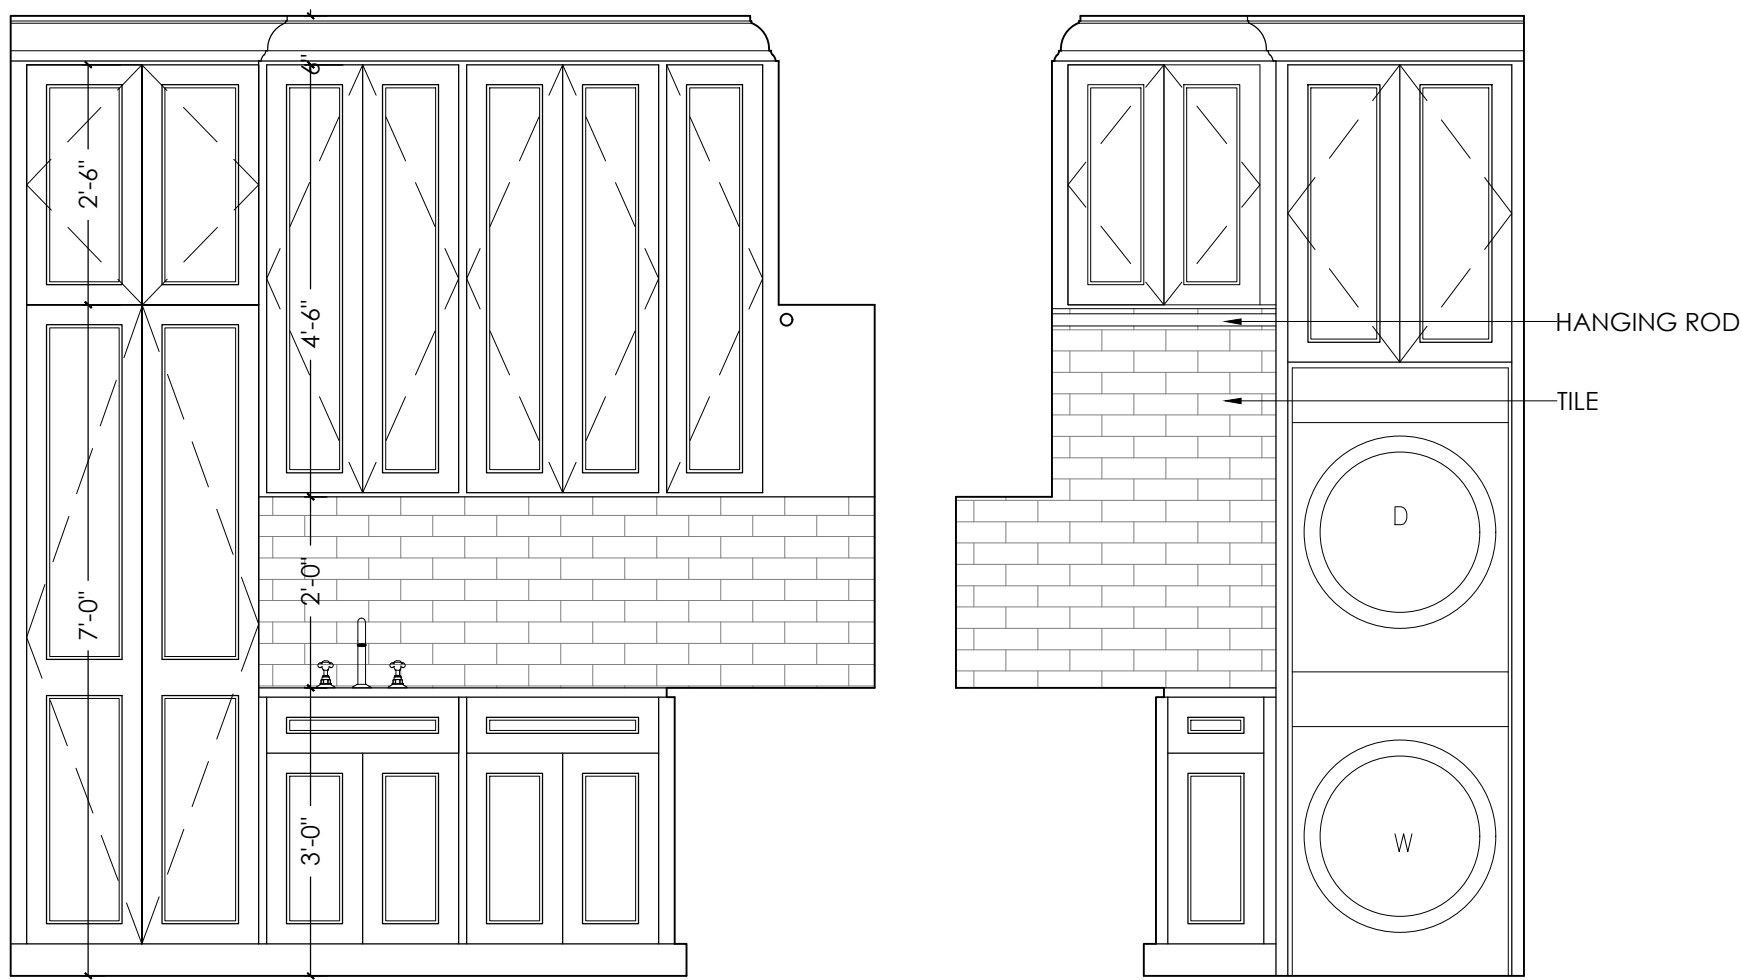

05 PRIMARY BEDROOM @ PRIMARY CLOSET (DOORS CLOSED)  
SCALE: 1/2" = 1'-0"




06 PRIMARY BEDROOM @ PRIMARY CLOSET (DOORS OPEN)  
SCALE: 1/2" = 1'-0"

ADJUSTABLE  
SHELVING @ UPPER  
CABS.; TYP.


FIXED HANGING  
ROD; TYP.

3 EQ. DRAWERS  
CONSTRUCTED W/ BIRCH  
LINED PLY. W/ FULL  
EXTENSION SOFT CLOSE  
SLIDES; TYP.


2 SLIDE OUT SHOE SHELVES  
CONSTRUCTED W/ BIRCH  
LINED PLY. W/ FULL  
EXTENSION SOFT CLOSE  
SLIDES; TYP.

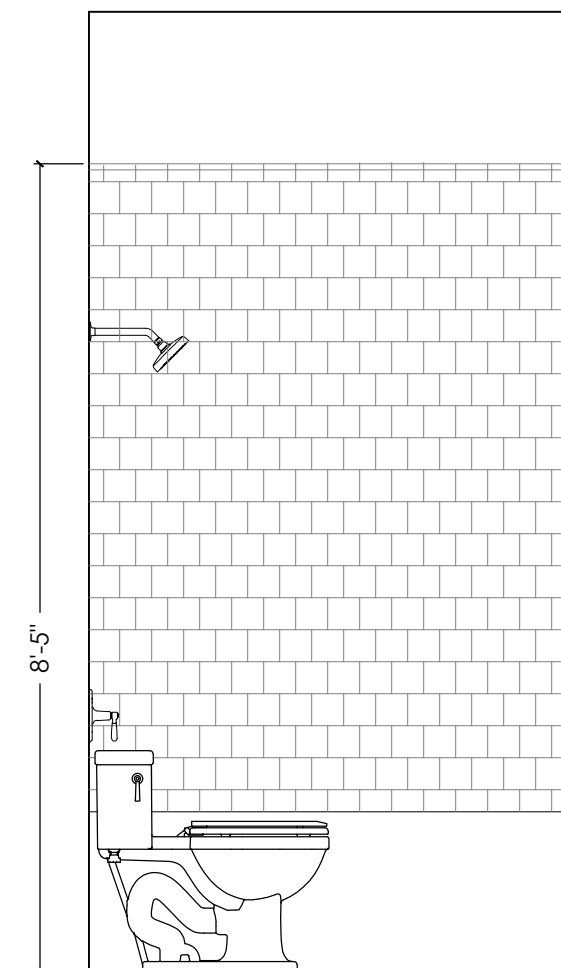


07 BATHROOM 3  
SCALE: 1/2" = 1'-0"

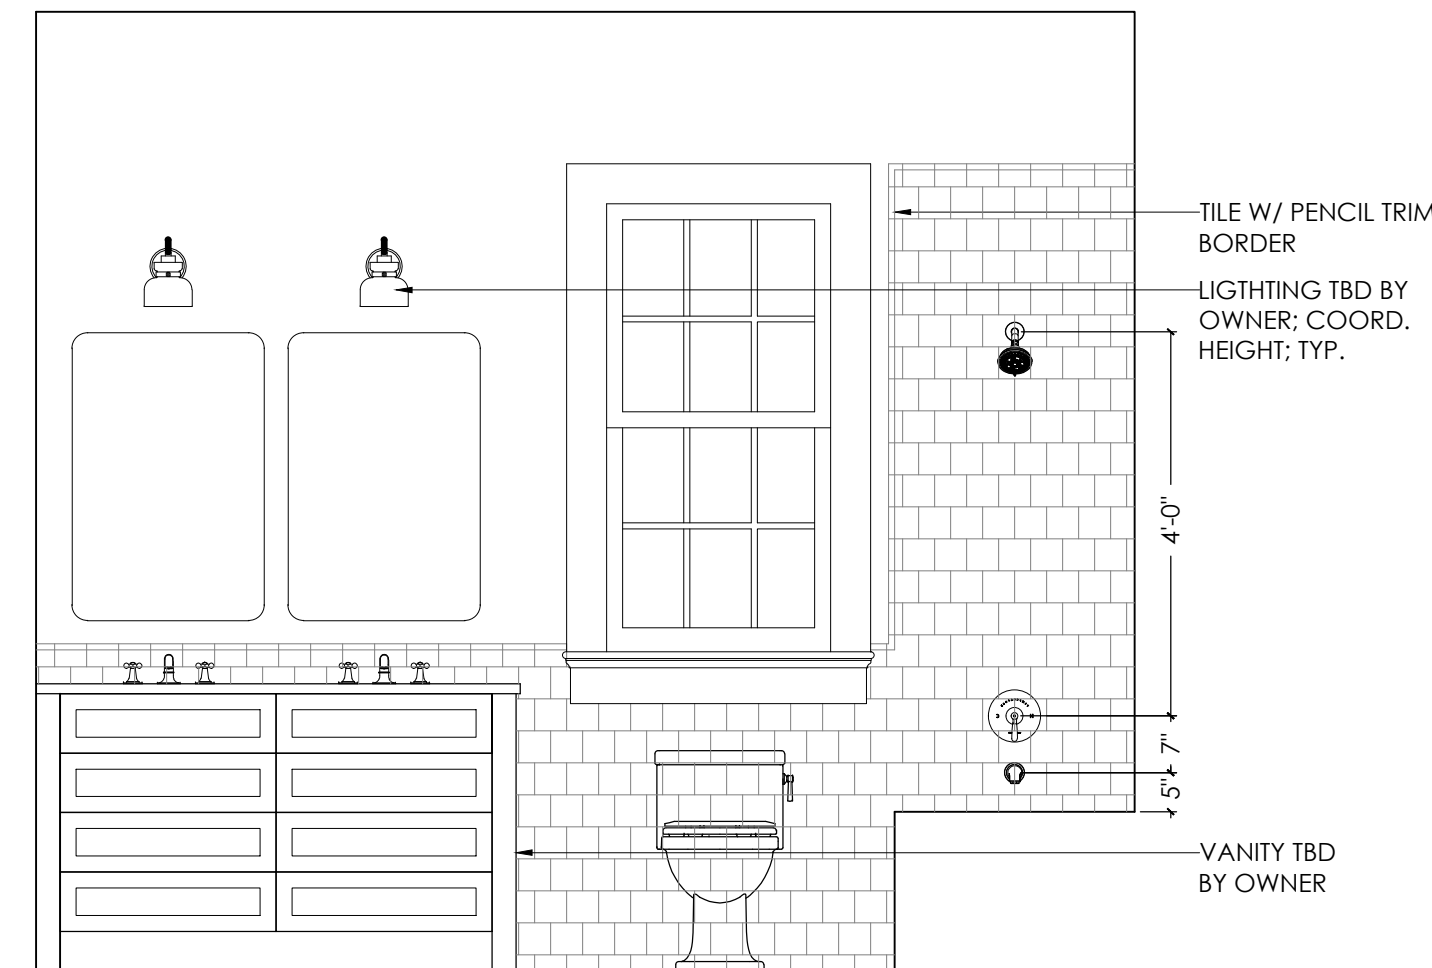


08 BATHROOM 3  
SCALE: 1/2" = 1'-0"

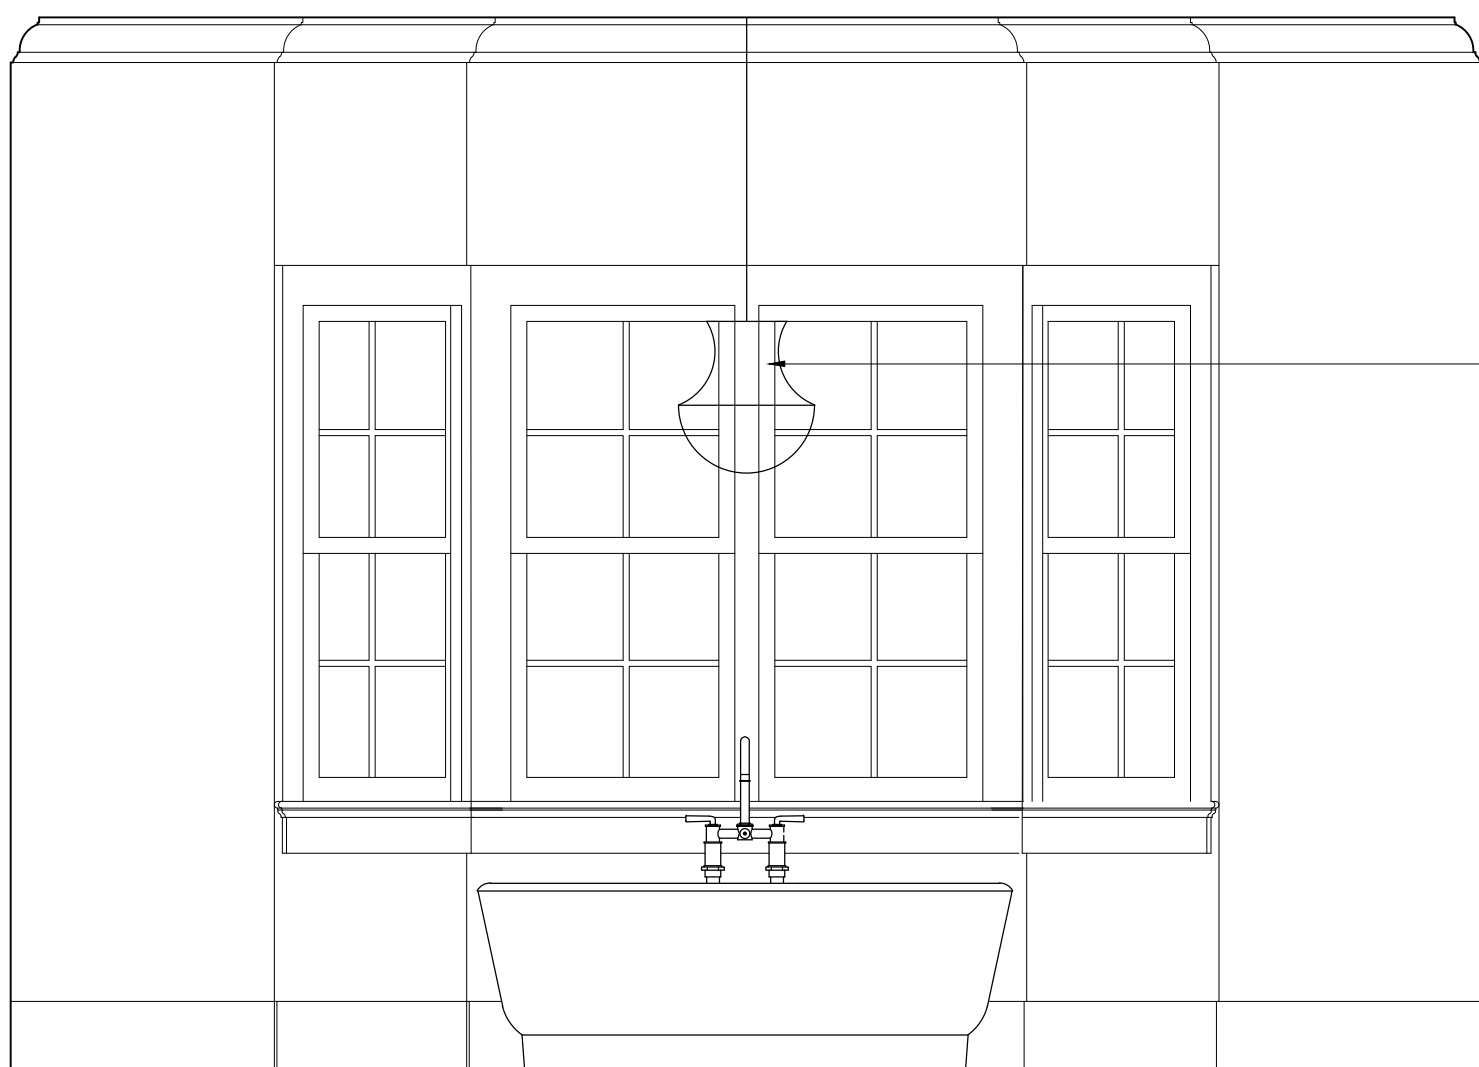


01 PRIMARY BATH  
SCALE: 1/2" = 1'-0"

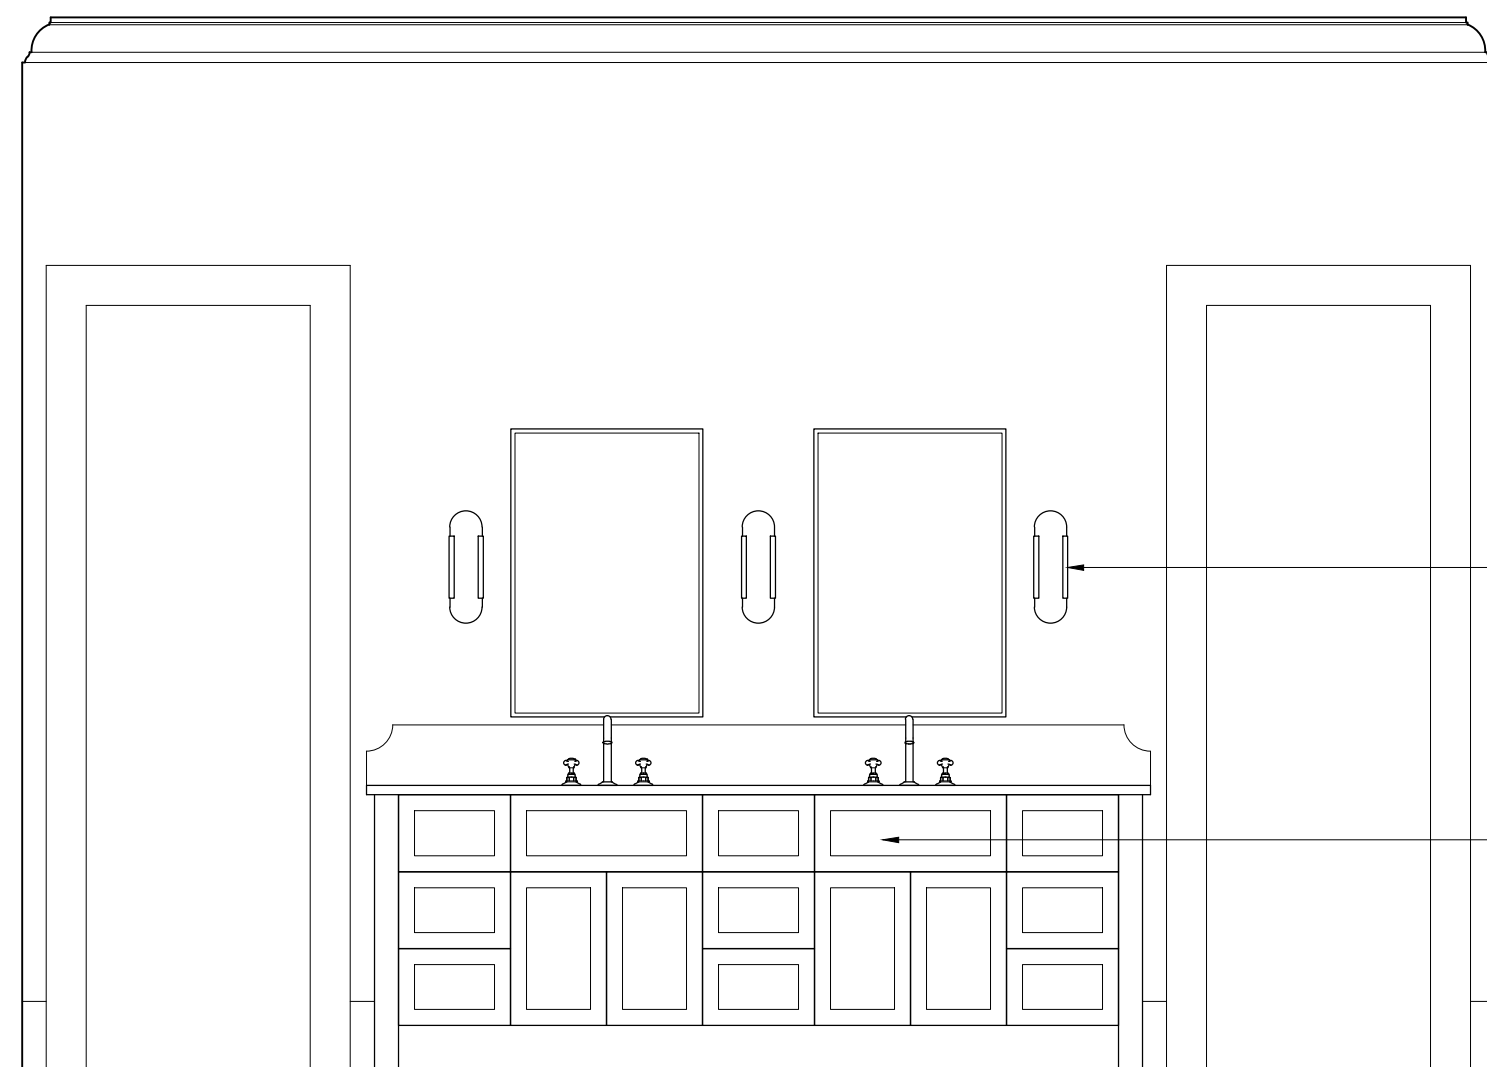

02 PRIMARY BATH  
SCALE: 1/2" = 1'-0"

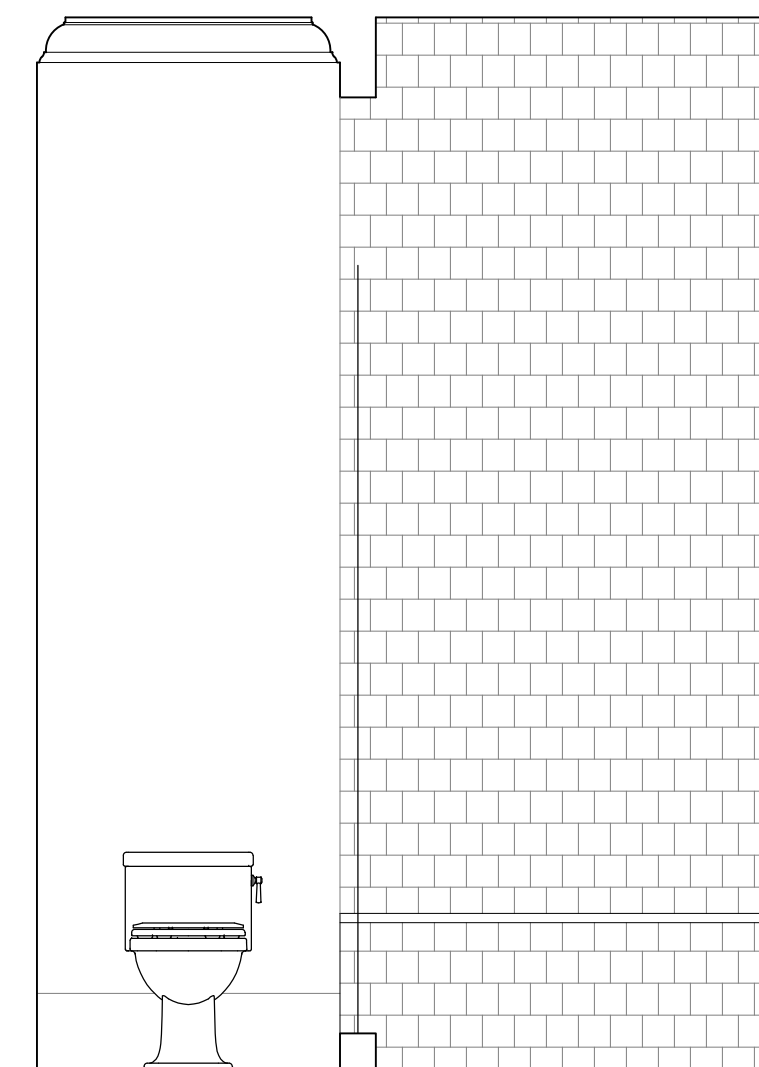

03 PRIMARY WATER CLOSET  
SCALE: 1/2" = 1'-0"

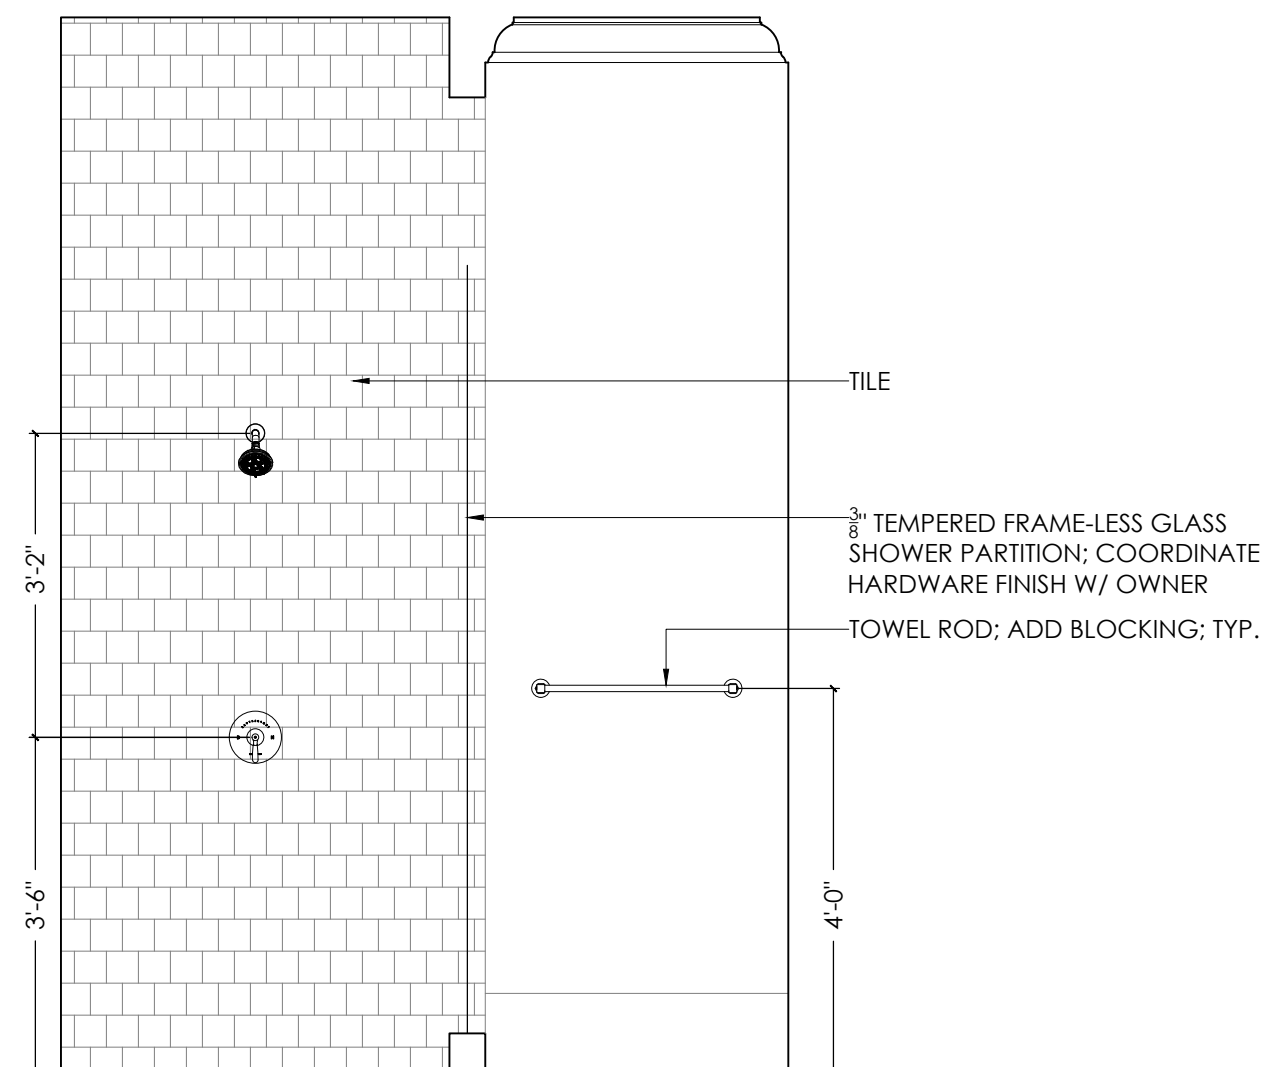

04 PRIMARY WATER CLOSET  
SCALE: 1/2" = 1'-0"

CRISCO RESIDENCE  
2827-2831 CHIPPEWA STREET  
NEW ORLEANS, LOUISIANA 70115

SEAL:



ISSUE DATE:  
OCTOBER 05, 2022

DRAWING TITLE:  
INTERIOR ELEVATIONS

DRAWING NUMBER:


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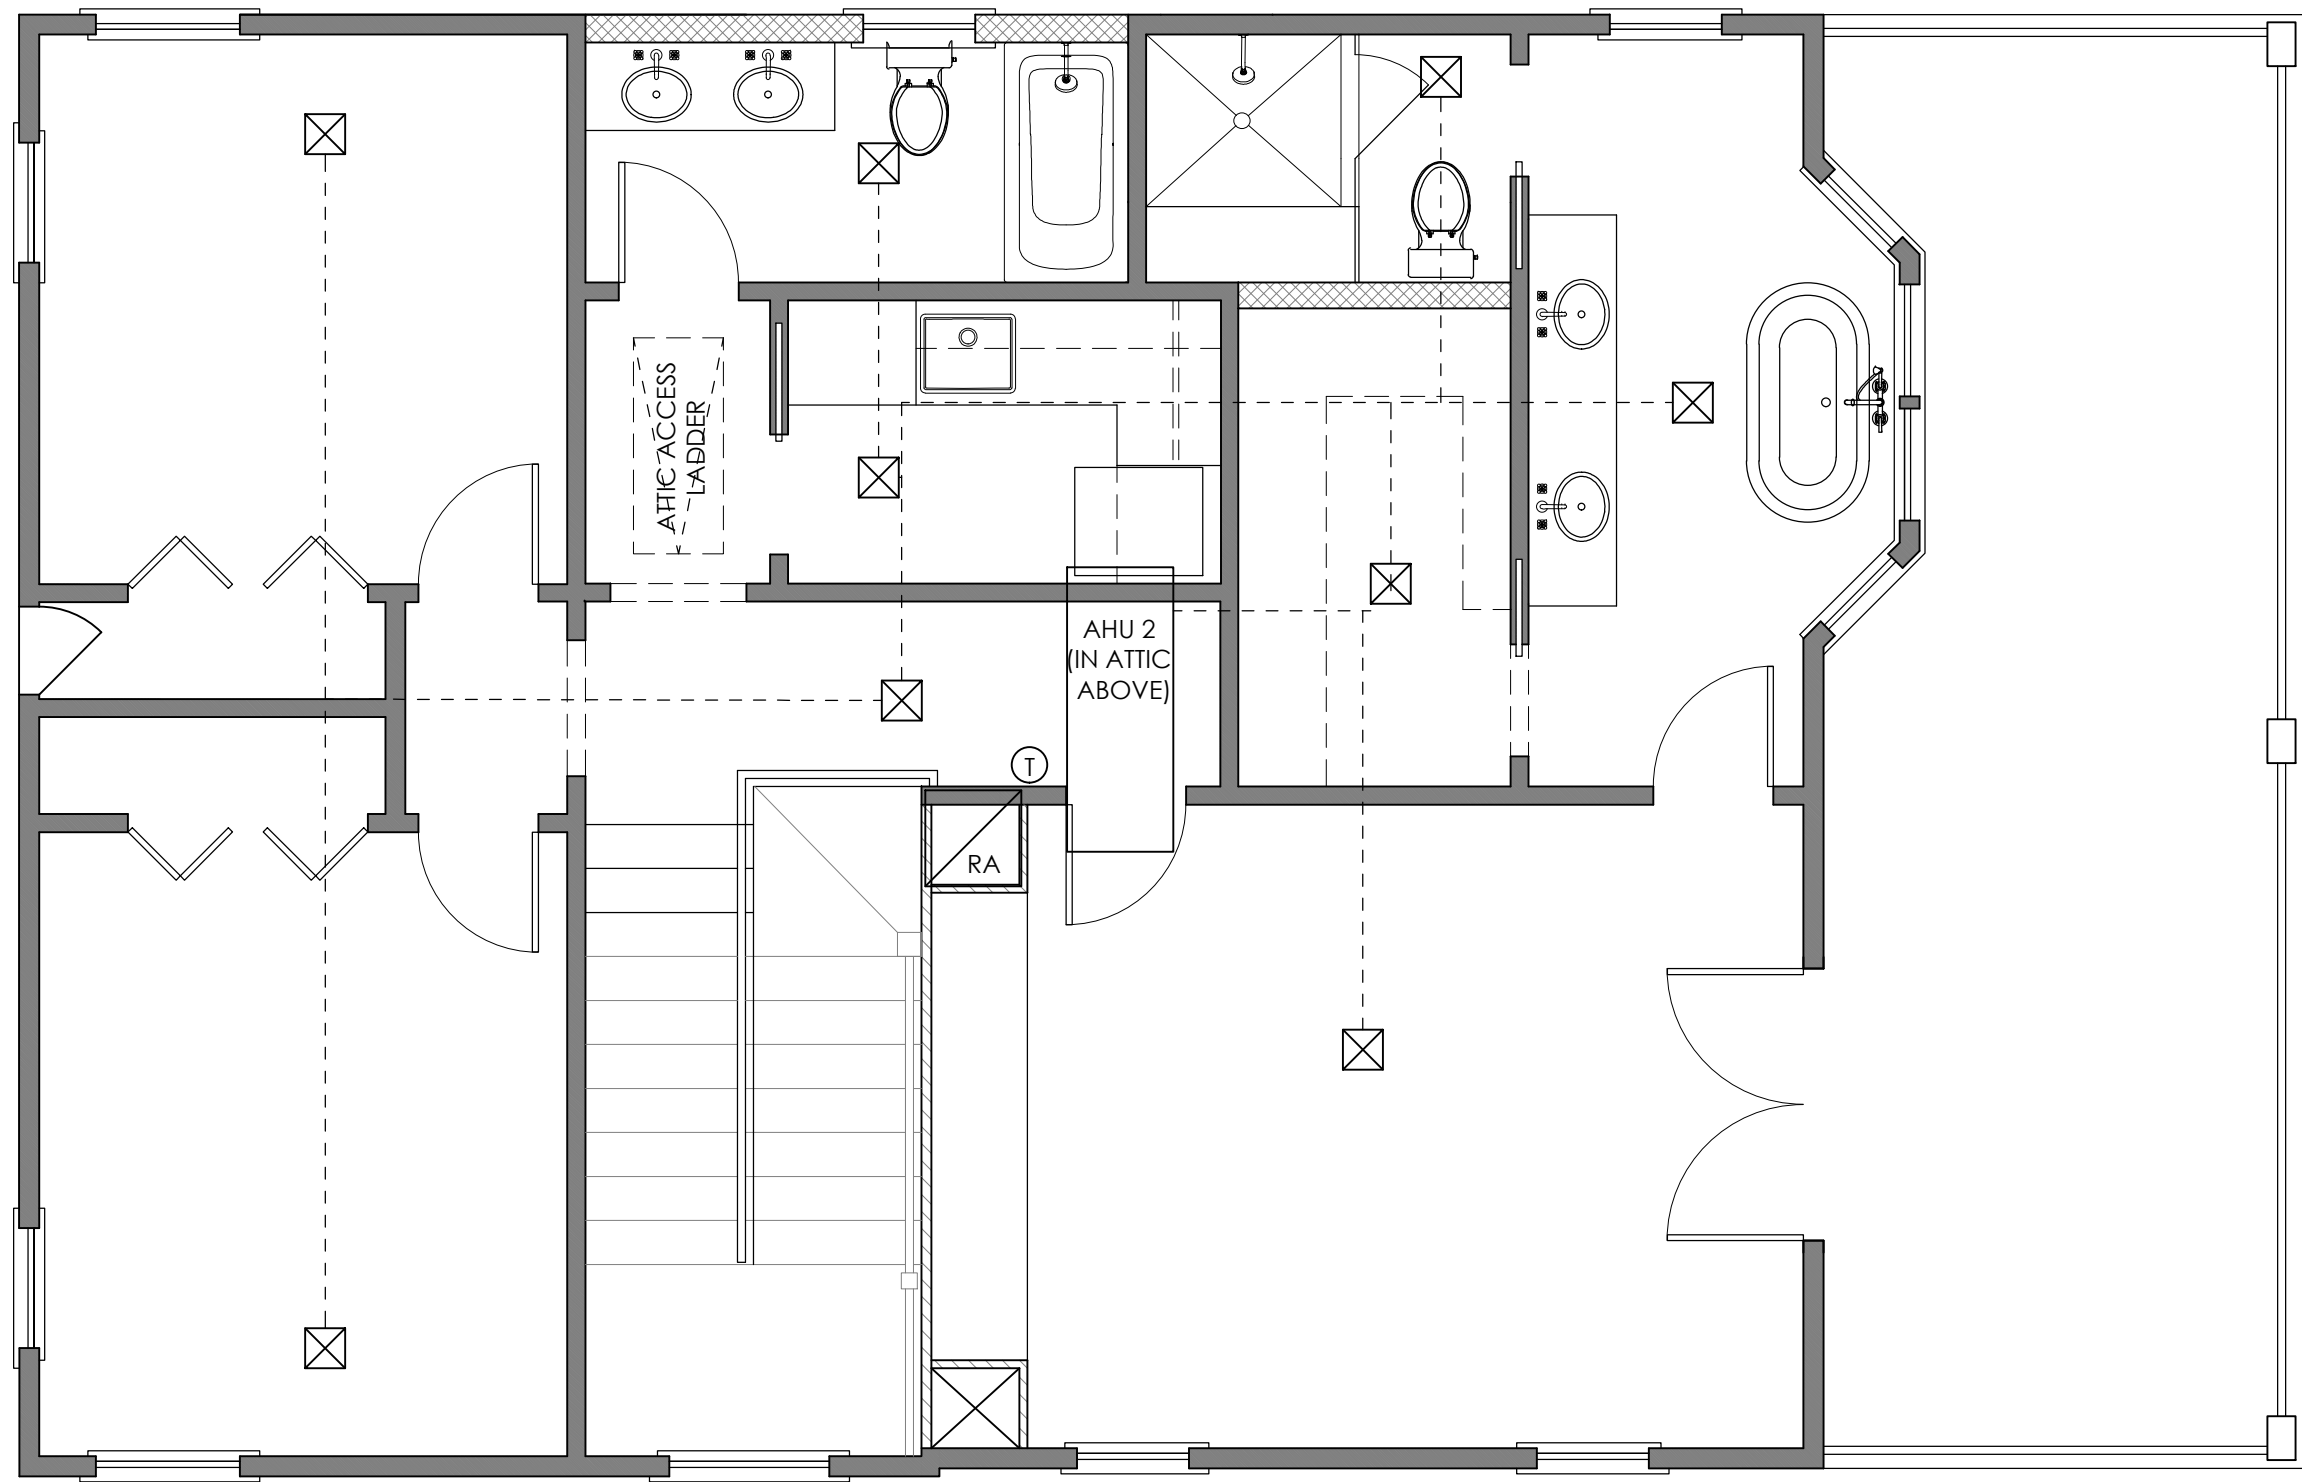
MECHANICAL NOTES:

1. ALL WORK TO BE DONE IN ACCORDANCE WITH THE STANDARD MECHANICAL CODE
2. NEW HVAC TO BE SIZED BY OTHERS
3. THERMOSTAT TO BE LOCATED IN NOTED LOCATION(S) RE: ELECTRICAL PLAN
4. AIR HANDLERS TO BE LOCATED IN ATTIC WITH RETURN AIR LOCATIONS AS NOTED
5. INSULATE DUCTS ON OUTSIDE AND SEAL/WRAP ALL JOINTS AND CONNECTIONS FOR AIR-TIGHT RESULTS
6. VENT ALL EXHAUST FANS TO EXTERIOR; FLASH AS REQUIRED
7. VERIFY ALL VENT LOCATIONS PRIOR TO INSTALLATION; DO NOT DISCHARGE FANS IN PROXIMITY OF ATTIC INTAKE AIR VENTS
8. CONDENSER TO BE PLACED ON MECH PLATFORM ABOVE BASE FLOOD ELEVATION
9. ZONE SYSTEM SO THAT EACH FLOOR MAINTAINS LEVEL OF THERMAL COMFORT

01 FIRST FLOOR MECHANICAL PLAN  
SCALE: 1/4" = 1'-0"



02 SECOND FLOOR MECHANICAL PLAN  
SCALE: 1/4" = 1'-0"

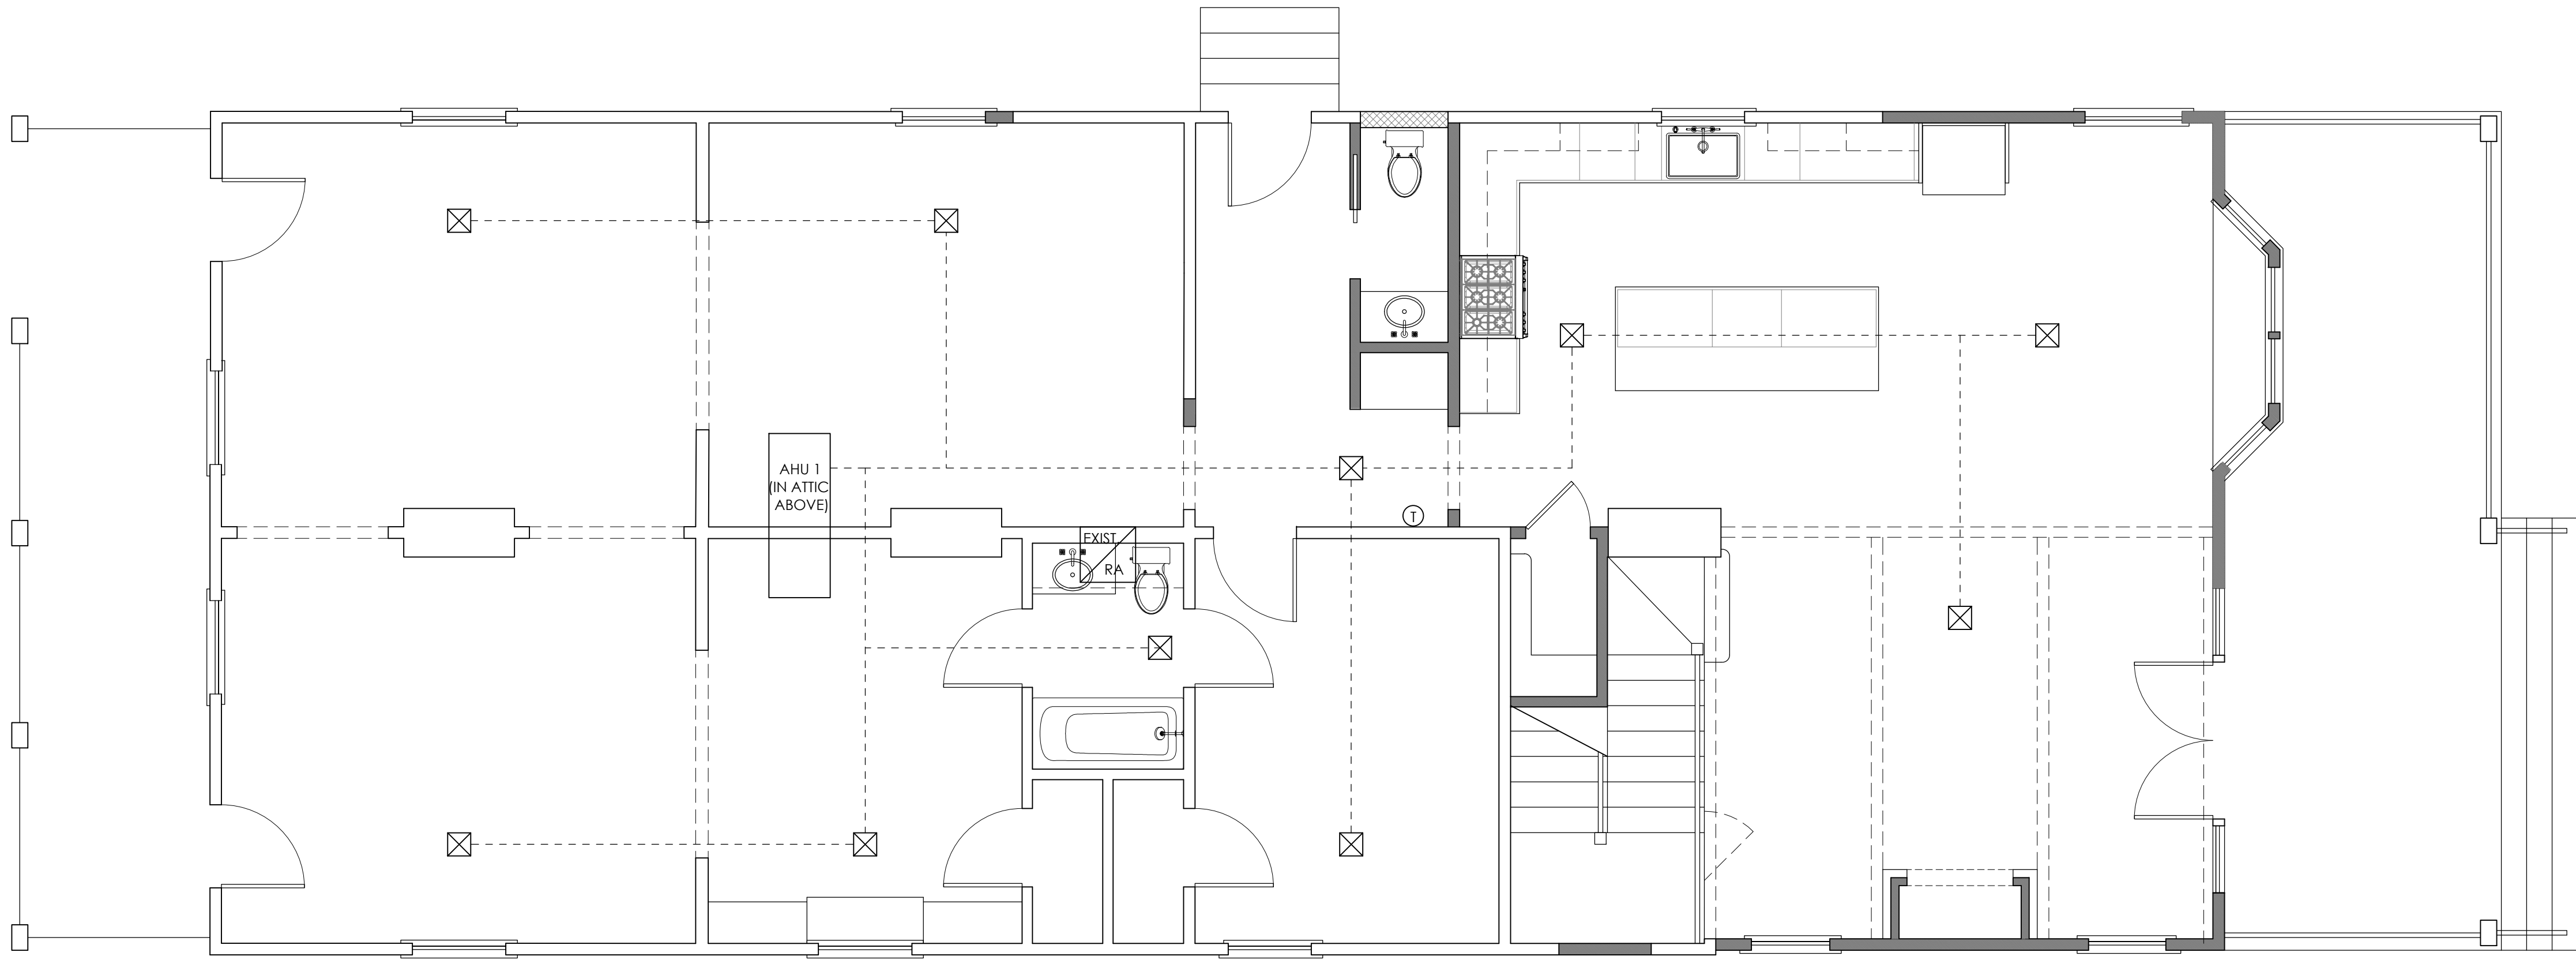

ARCHETYPE

CRISCO RESIDENCE  
2827-2831 CHIPPEWA STREET  
NEW ORLEANS, LOUISIANA 70115

SEAL:



ISSUE DATE:  
OCTOBER 05, 2022

DRAWING TITLE:  
MECHANICAL FLOOR  
PLANS

DRAWING NUMBER:

M1.1





ARCHETYPE

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SEAL:




ISSUE DATE:  
OCTOBER 05, 2022


DRAWING TITLE:  
ELECTRICAL FLOOR PLANS

DRAWING NUMBER:

E1.1

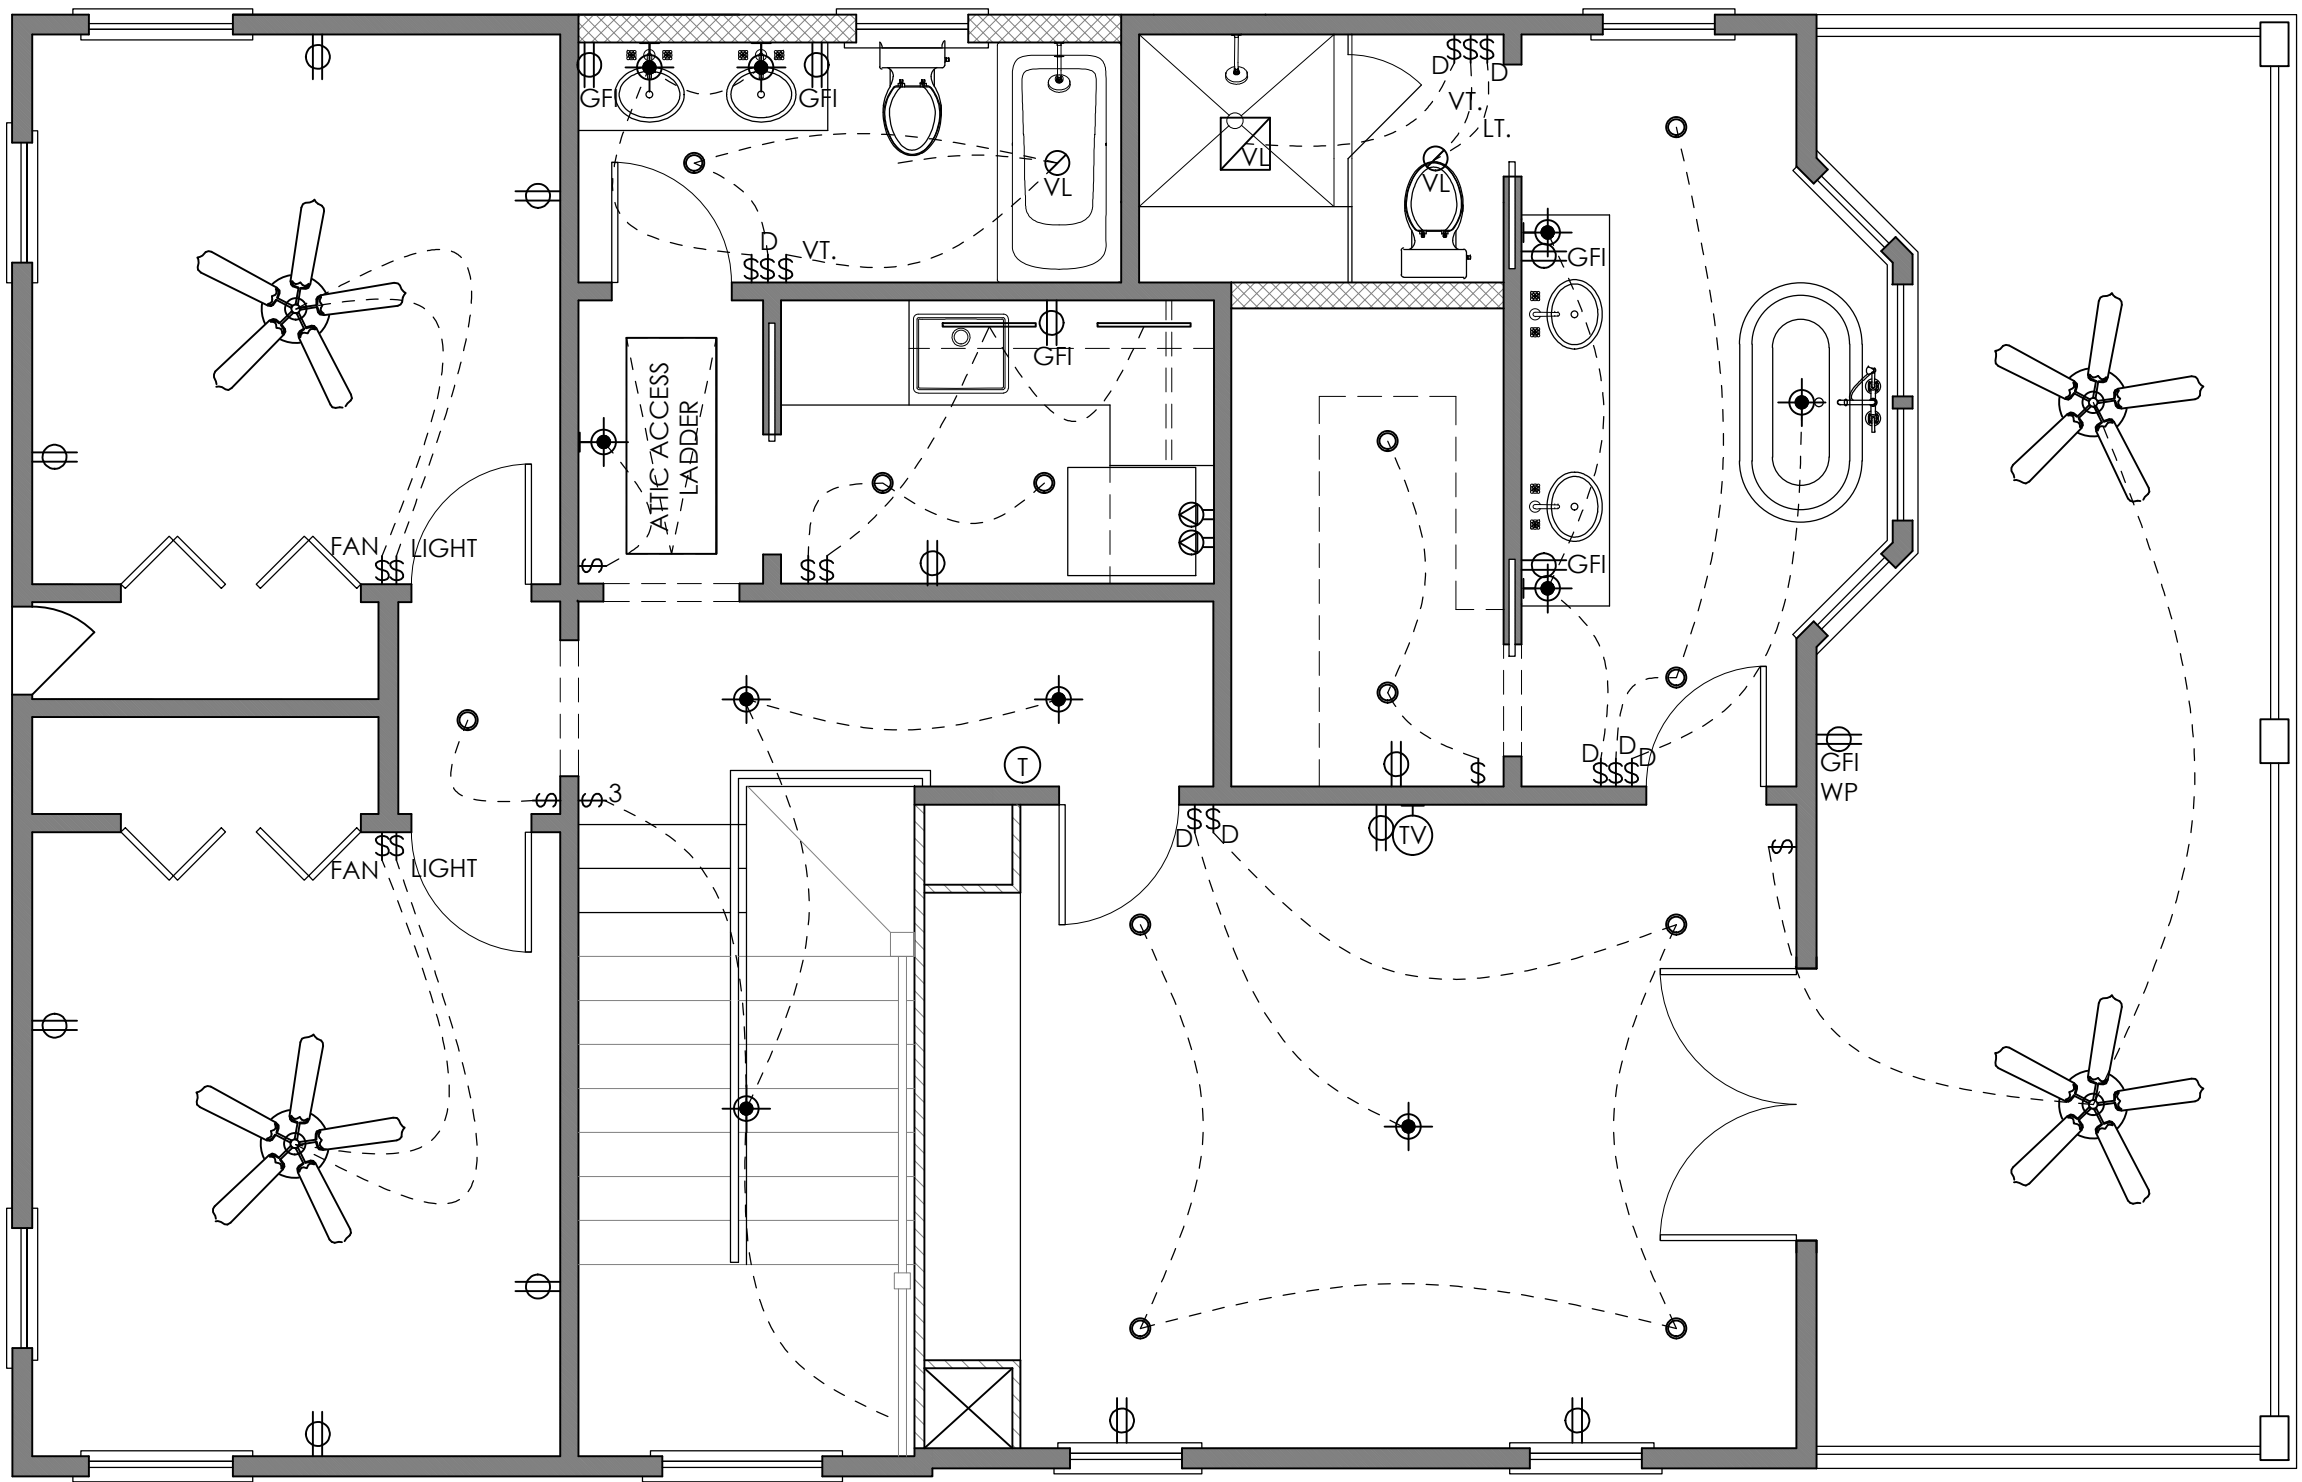

02 SECOND FLOOR ELECTRICAL PLAN  
SCALE: 1/4" = 1'-0"

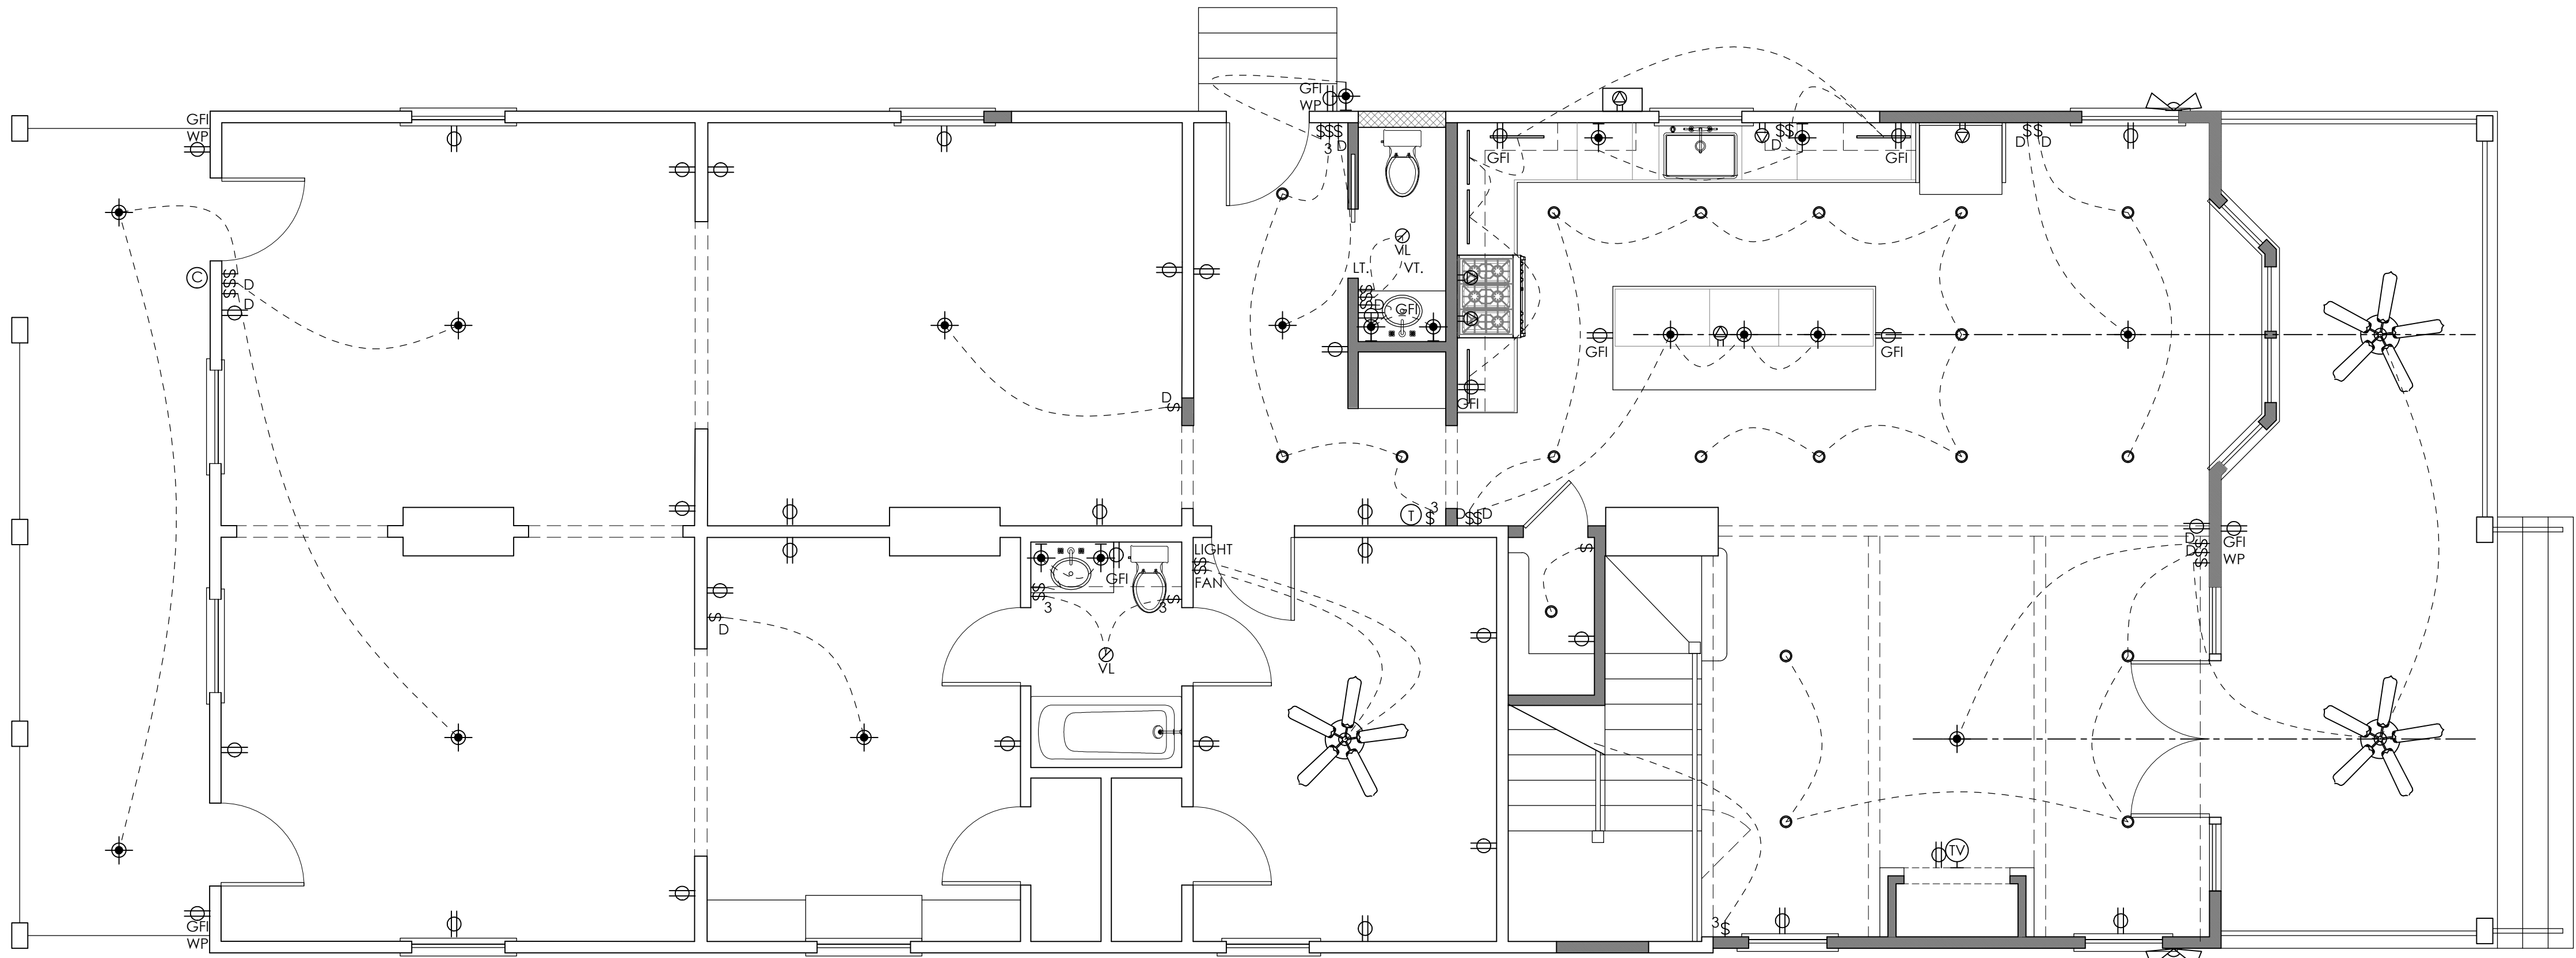

All exterior light fixtures to be submitted to HDLC prior to purchase and installation

ELECTRICAL NOTES:

1. ALL LIGHT FIXTURES TO BE DIRECTLY WIRED TO SWITCHES
2. ALL OUTLETS AND ELECTRICAL EQUIPMENT ARE SHOWN APPROXIMATELY LOCATED
3. EACH APPLIANCE TO HAVE DEDICATED CIRCUIT, AMPERAGE, VOLTAGE, AND GFI AS NOTED
4. FIXTURES ARE TO BE CENTERED IN ROOM UNLESS OTHERWISE NOTED
5. PROVIDE ARC FAULT PROTECTORS AT ALL BEDROOMS
3. APPROVED SMOKE ALARMS POWERED BY THE HOUSE ELECTRICAL SERVICE SHALL BE INSTALLED IN ACCORDANCE WITH NFPA 101-9.6.2.10 AND THE IBC IN EVERY SLEEPING AREA, OUTSIDE EVERY SLEEPING AREA IN THE IMMEDIATE VICINITY OF THE BEDROOMS. AT EVERY LIVING UNIT AND ON ALL LEVELS OF THE DWELLING UNIT, INCLUDING BASEMENTS. INSTALL ONE CARBON MONOXIDE DETECTOR ON EACH FLOOR
4. ELECTRICIAN TO COORDINATE WITH HVAC CONTRACTOR TO LOCATE AND PROVIDE APPROPRIATE POWER FOR HVAC EQUIPMENT AND ACCESSORIES
5. ELECTRICIAN TO COORDINATE ELEC. METER LOCATION
6. COORDINATE RECEPTACLE / SWITCH HEIGHTS WITH INTERIOR ELEVATIONS AND/OR OWNER
7. PROVIDE IN ATTIC, LIGHTING & SINGLE POLE LIGHT SWITCH NEAR ATTIC ACCESS LADDER

| LEGEND |   |
|--------|---|
| SYMBOL |   |
|        | DUPLEX RECEPTACLE - 15AMP, 2 POLE, 3W, 110V; MOUNT @ 12" A.F.F UNLESS OTHERWISE NOTED     |
|        | DUPLEX RECEPTACLE - 15AMP, 2 POLE, 3W, GFI TYPE; MOUNT @ 48" A.F.F UNLESS OTHERWISE NOTED |
|        | EXTERIOR GRADE DUPLEX RECEPTACLE - 15AMP, 2 POLE, 3W, GFI TYPE, WEATHERPROOF              |
|        | DUPLEX FLOOR RECEPTACLE - 15AMP, 2 POLE, 3W, 110V; COORD. LOCATION WITH OWNER             |
|        | DEDICATED CIRCUIT - 120V, 20AMP   |
|        | DEDICATED CIRCUIT - 120V, 20AMP; GROUND FAULT PROTECTED                                   |
|        | SINGLE POLE LIGHT SWITCH; MOUNT @ 48" A.F.F UNLESS OTHERWISE NOTED                        |
|        | THREE WAY LIGHT SWITCH; MOUNT @ 48" A.F.F UNLESS OTHERWISE NOTED                          |
|        | DIMMER LIGHT SWITCH; MOUNT 48" A.F.F UNLESS OTHERWISE NOTED                               |
|        | TELEVISION DATA & DUPLEX RECEPTACLE ; MOUNTING HT. TBD BY OWNER                           |
|        | CAMERA DOORBELL   |
|        | THERMOSTAT; MOUNT 60" A.F.F   |
|        | 4" LED RECESSED CAN LIGHT - IC RATED/DAMP RATED WET RATED AT ALL EXTERIOR                 |
|        | CEILING MOUNTED DECORATIVE FIXTURE  |
|        | WALL MOUNTED DECORATIVE FIXTURE   |
|        | VENT LIGHT W/ RECESSED CAN LIGHT  |
|        | VENT LIGHT W/ HUMIDITY SENSOR   |
|        | UNDER CABINET LED LIGHT FIXTURE   |
|        | DOUBLE FLOOD LIGHT ON MOTION SENSOR   |

01 FIRST FLOOR ELECTRICAL PLAN  
SCALE: 1/4" = 1'-0"





ARCHETYPE

CRISCO RESIDENCE  
2827-2831 CHIPPEWA STREET  
NEW ORLEANS, LOUISIANA 70115

SEAL:




ISSUE DATE:  
OCTOBER 05, 2022

DRAWING TITLE:  
PLUMBING FLOOR PLANS


DRAWING NUMBER:

P1.1

| REVISIONS |  | No. | Date | Scope |
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02 SECOND FLOOR PLUMBING PLAN  
SCALE: 1/4" = 1'-0"

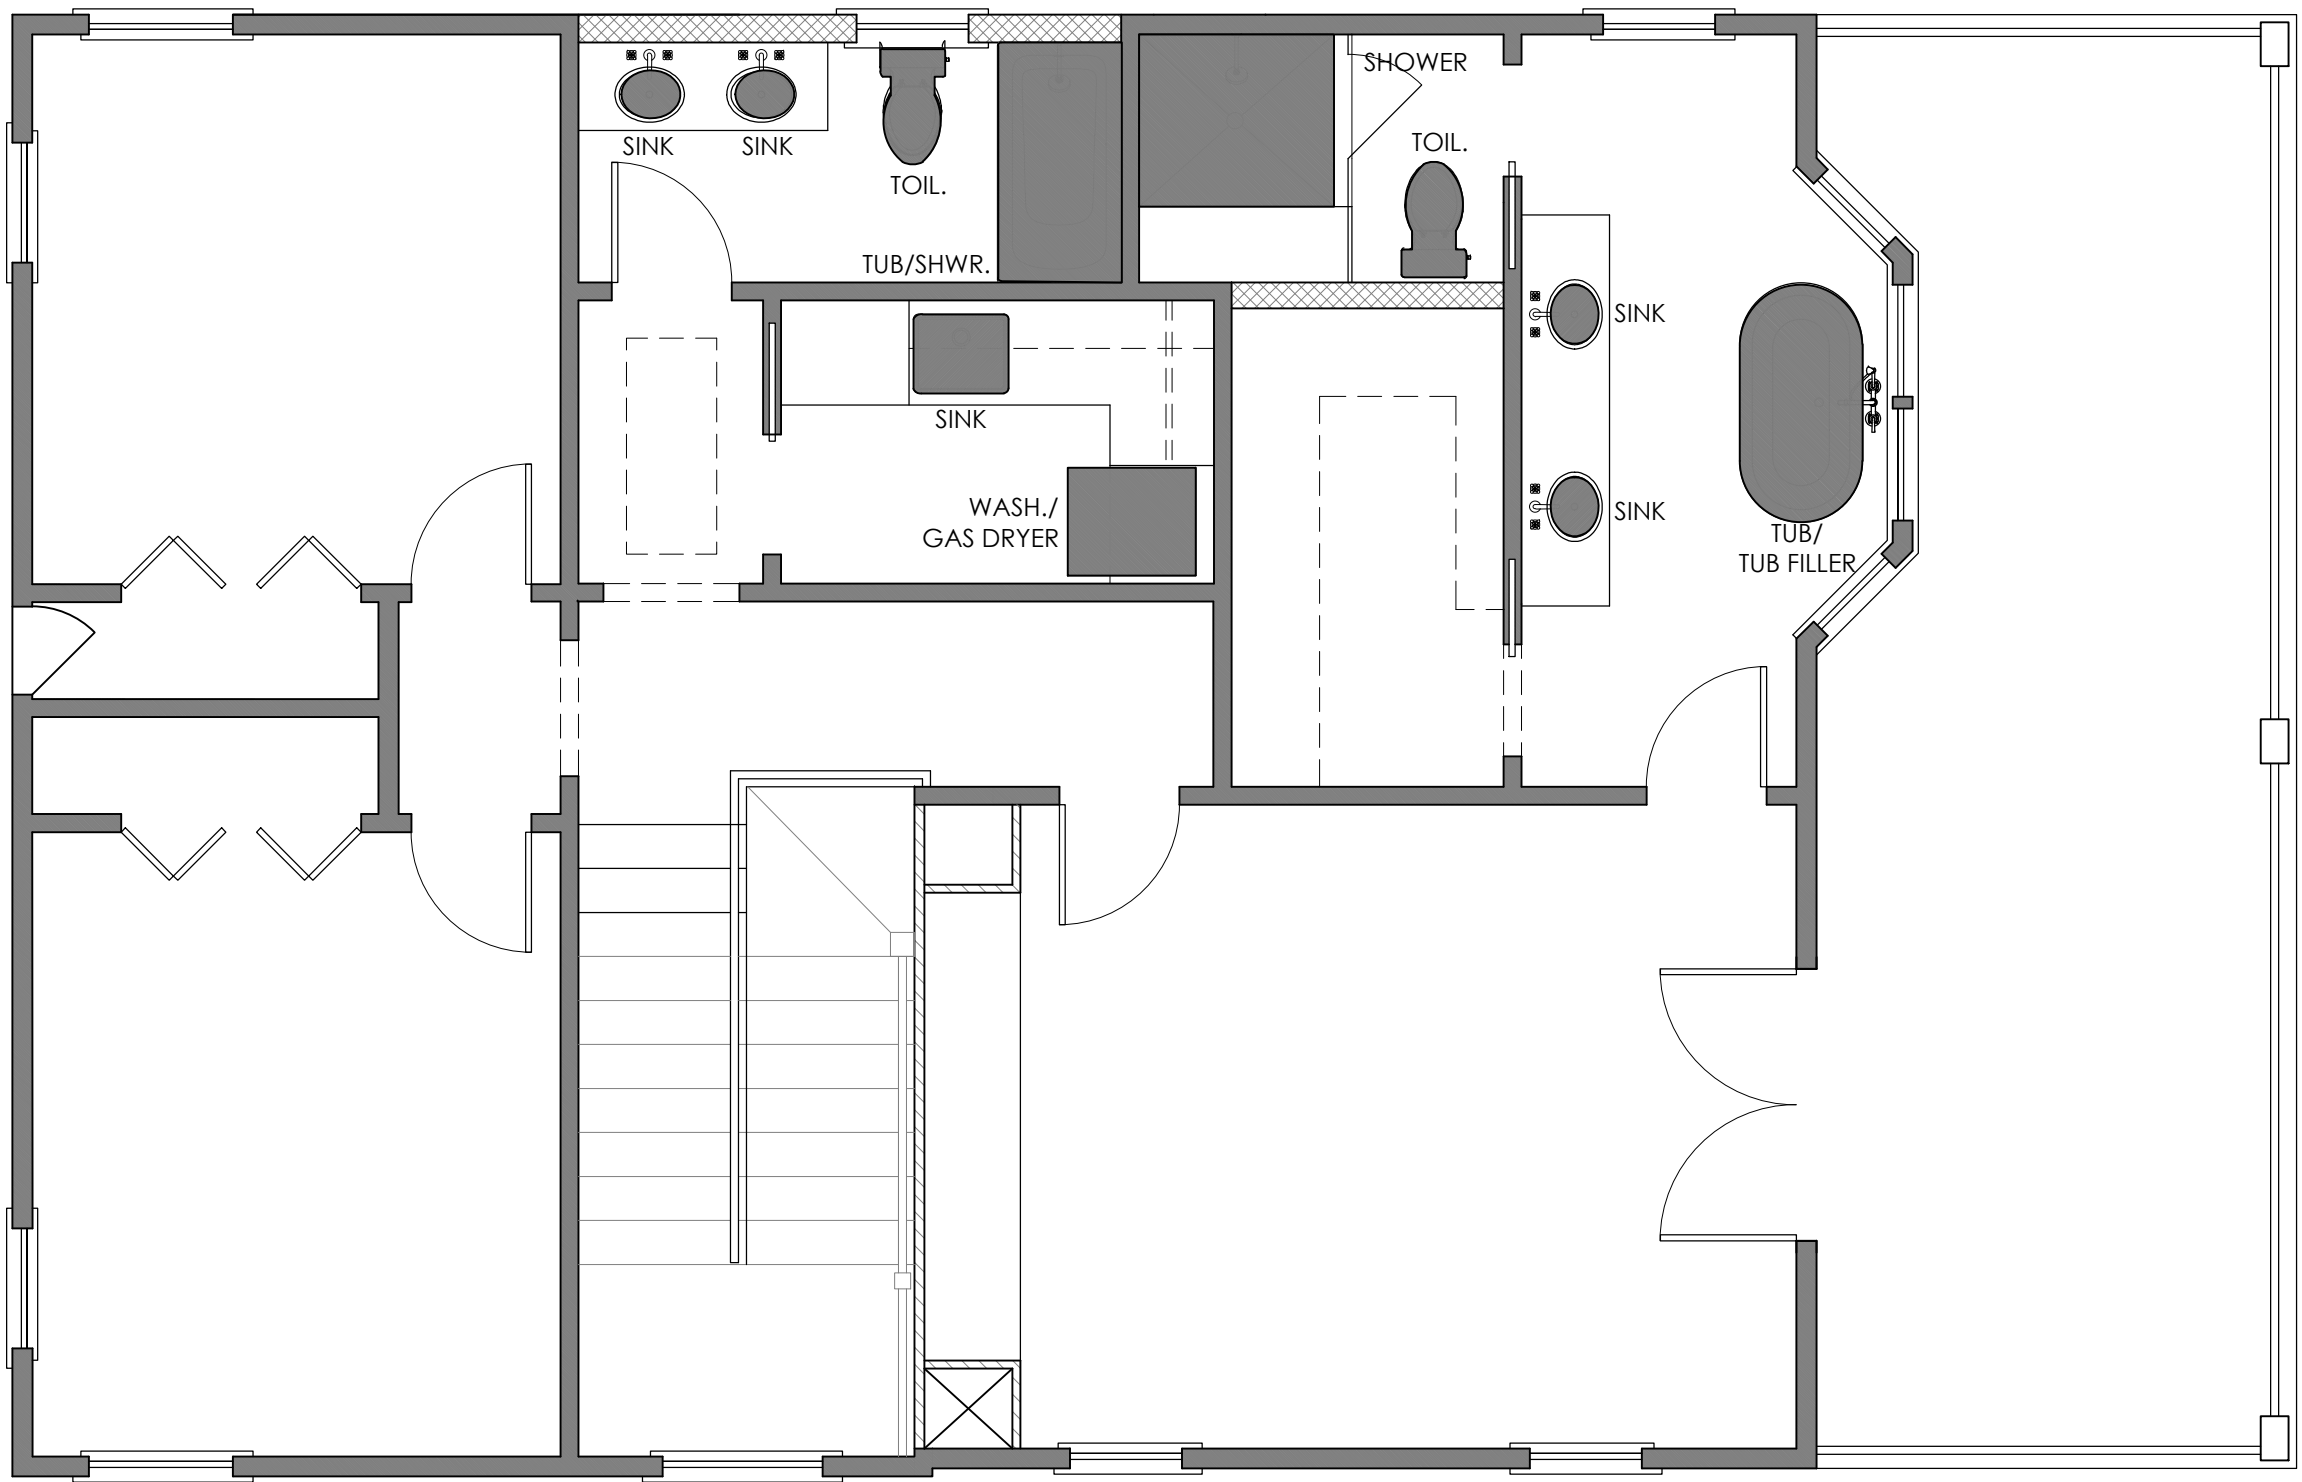


PLUMBING NOTES:

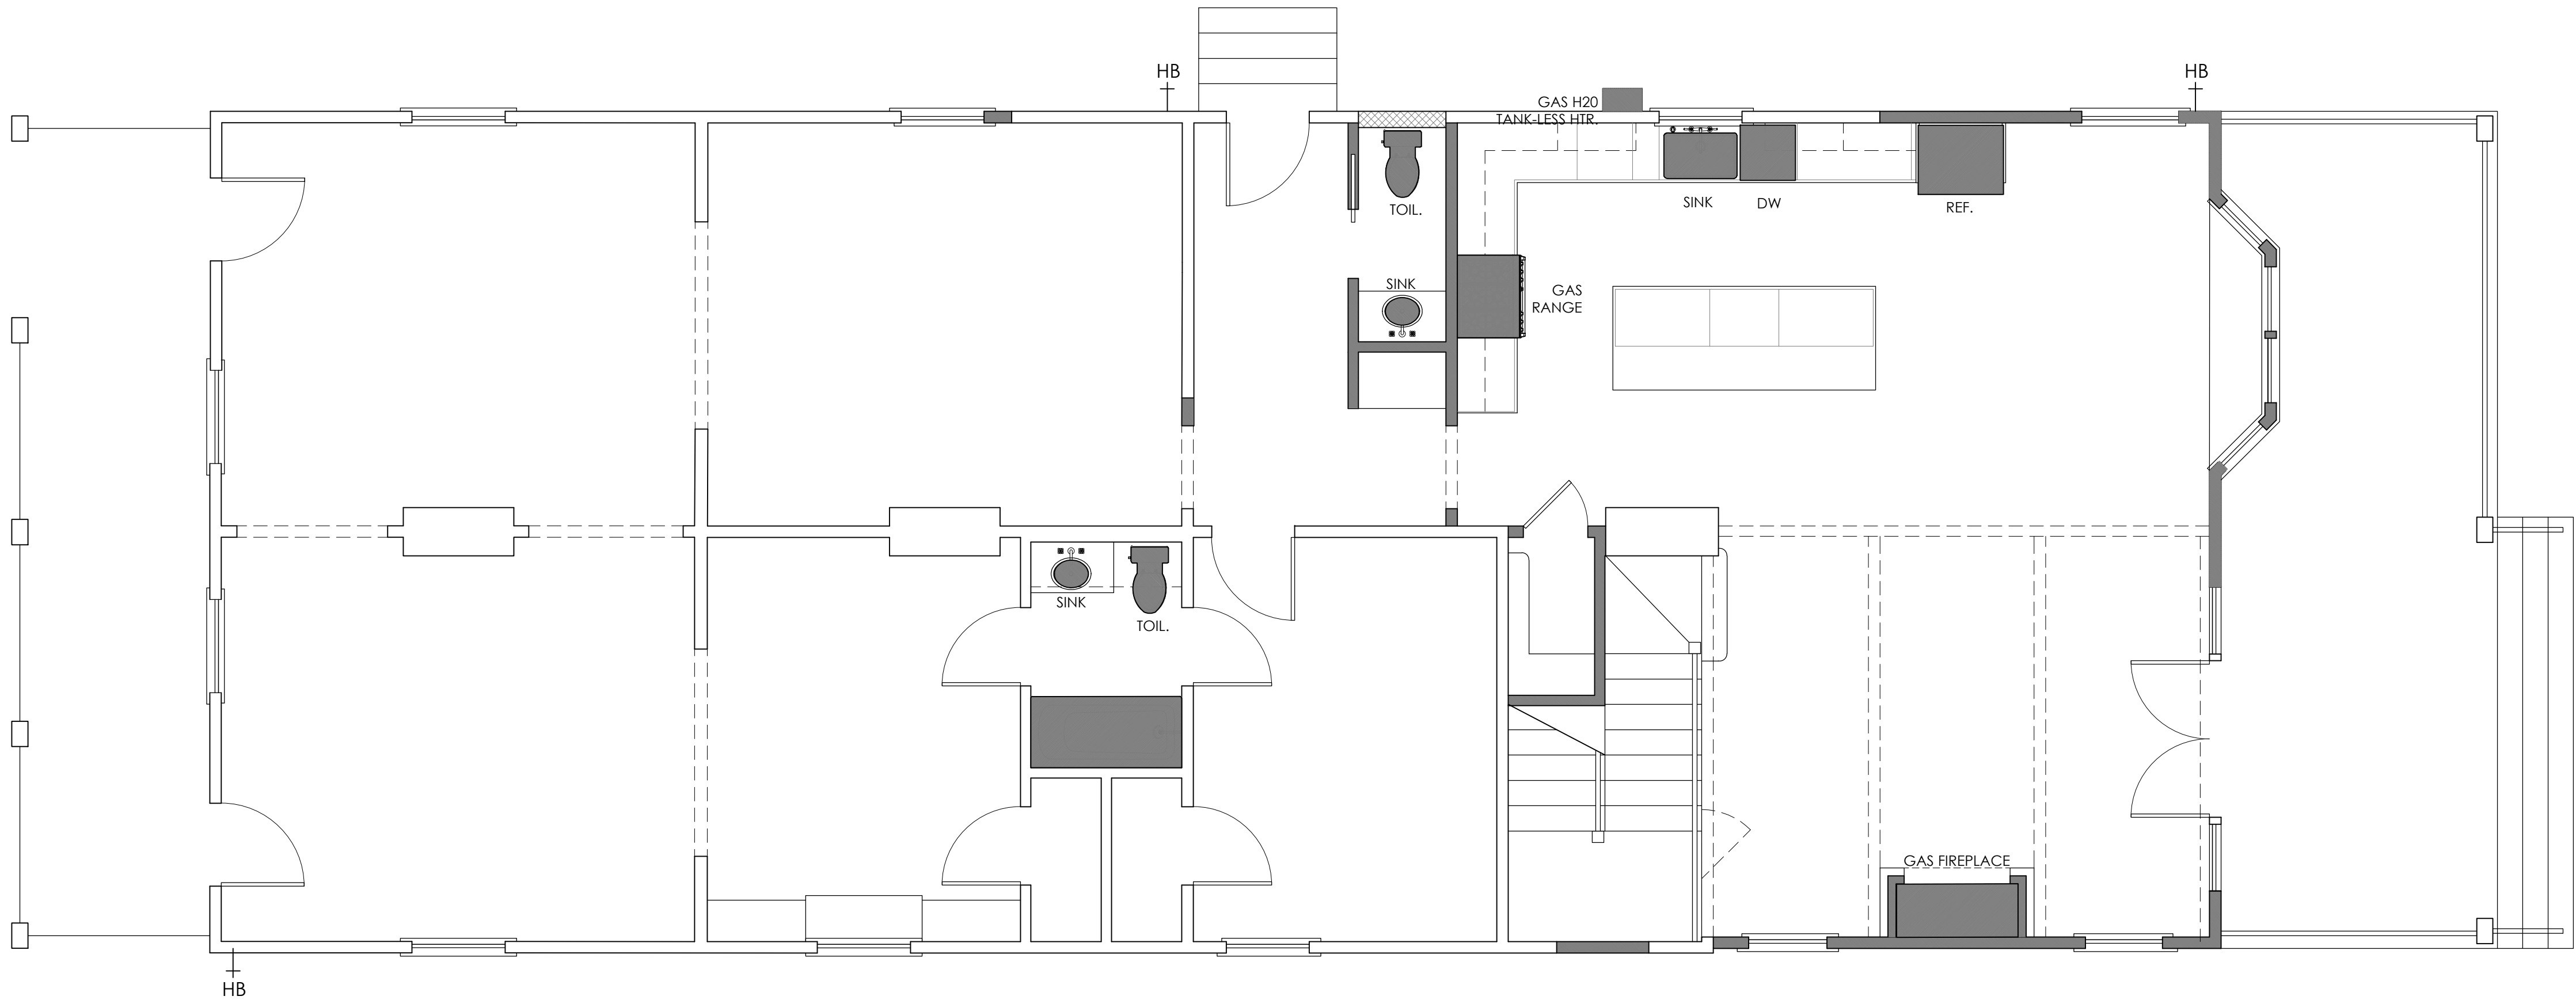1. ALL WORK TO BE DONE IN ACCORDANCE WITH THE STANDARD PLUMBING CODE
2. PLUMBER TO COORDINATE WITH HVAC CONTRACTOR TO LOCATE AND PROVIDE APPROPRIATE GAS LINE & DRAINAGE LINE FOR HVAC EQUIPMENT AND ACCESSORIES
3. PLUMBER TO SIZE ALL WATER SUPPLY, WATER DRAINAGE, SEWAGE, AND GAS LINES
4. PLUMBING STACK VENTS, EXHAUST FAN VENTS AND/OR OTHER ROOF PENETRATIONS SHALL NOT BE LOCATED ON THE FRONT ELEVATION. REDUCE THE NUMBER OF ROOF PENETRATIONS AS ALLOWED BY CODE

01 FIRST FLOOR PLUMBING PLAN  
SCALE: 1/4" = 1'-0"



## By the Way, Did You Know?

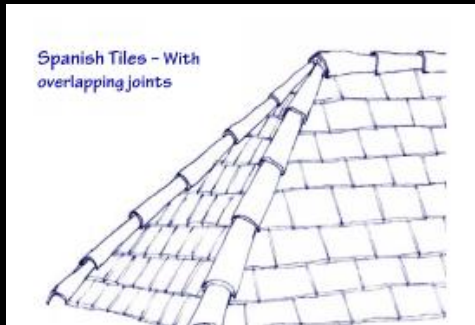

Existing ridge tiles should be salvaged and reinstalled!



The HDLC does NOT approve wind turbines. The HDLC does approve Chinese Cap and Low Profile Power Vents!

### Atlas

Atlas Stormmaster Shake

Black Shadow, Heathstone Grey, Pewter, Weathered Wood

Atlas Pinnacle Pristine

Pristine Black, Pristine Hearthstone, Pristine Pewter, Pristine Weathered wood

### Certainteed

Certainteed – Landmark

Colonial Slate, Georgetown Grey, Max Def Georgian Grey, Max Def Maine Black, Moire Block, Weathered Wood

Certainteed Landmark IR

Colonial Slate, Cumberland, Moire Black, Weathered Wood

Certainteed Landmark Premium

Max Def Moire Black

Certainteed Landmark Pro

Max Def Colonial Slate, Max Def Georgetown, Max Def Moire

Certainteed Landmark TL

Max Def Colonial Slate, Max Def Moire Black, Max Def Old Overton

Certainteed Grand Manor

Black Pearl, Colonial Slate, Gatehouse Slate, Stonegate Grey

Certainteed Climateflex

Colonial Slate, Weathered Wood, Moire Black

### BP

Everest 42

Silver Grey, Fossil Wood, Twilight Grey, Brownstone, Driftwood

Vanguard – Class IV

Twilight Grey, Shadow Black, Silver Grey



## **GAF**

GAF – Timberline UHD  
Slate, Pewter Gray, Charcoal, Weathered Wood  
GAF- Timberline HDZ  
Pewter Grey, Charcoal, Oyster Gray, Weathered wood  
GAF – Timberline – NS  
Charcoal, Weathered Wood, Slate, Pewter Grey  
GAF – Timberline – AS II  
Charcoal, Slate, Weathered Wood, Pewter Grey  
GAF – CS  
Antique Slate, Weathered Wood

## **IKO**

Cambridge Collection  
Dual Black, Dual Grey, Weathered Wood, Harvard Slate, Charcoal Grey  
Cambridge Natural Cool  
Dual Gray  
Cambridge Cool Plus  
Harvard Slate, Graphite Black  
Dynasty  
Castle Grey, Glacier, Granite Black



## **Malarkey**

Legacy/Legacy Scotchguard/Highlander NEX AR/Vista AR  
Midnight Black, Black Oak, Weathered Wood, Storm Grey

## **Owens Corning**

Owens Corning – Oakridge  
Driftwood, Estate Gray, Flagstone, Onyx Black, Peppermill, Twilight Black  
Owens Corning –Duration  
Driftwood, Estate Grey, Onyx Black, Quarry Grey  
Owens Corning – Duration Flex  
Estate Grey, Onyx Black, Driftwood,  
Owens Corning – Berkshire Collection  
Canterbury Black, Colonial, Concord, Manchester Grey

## **Tamko**

Tamko Heritage Woodgate  
Antique Wood, Weathered Wood, Black Sage  
Tamko Titan  
Rustic Black, Virginia Slate, Weathered Wood  
Tamko Stormfighter  
Weathered Wood, Rustic Black  
Tamko Heritage  
Antique Slate, Oxford Grey, Weathered Wood, Rustic Black, Shadow grey, Virginia Slate