

HURRICANE DAMAGE - ROOFING REPAIRS & REPLACEMENT

PROGRAM MANAGER

THE SULZER GROUP 4641 FAIRFIELD STREET, STE. D METAIRIE, LA 70006 (504) 299-3391


ARCHITECT

VERGES ROME ARCHITECTS 320 N. CARROLLTON AVENUE, STE. 100 NEW ORLEANS, LA 70119 504-488-7739

ST. THERESA OF AVILA CHURCH & RECTORY

1404 ERATO STREET NEW ORLEANS, LA

A0.00 SCALE: N.T.S.

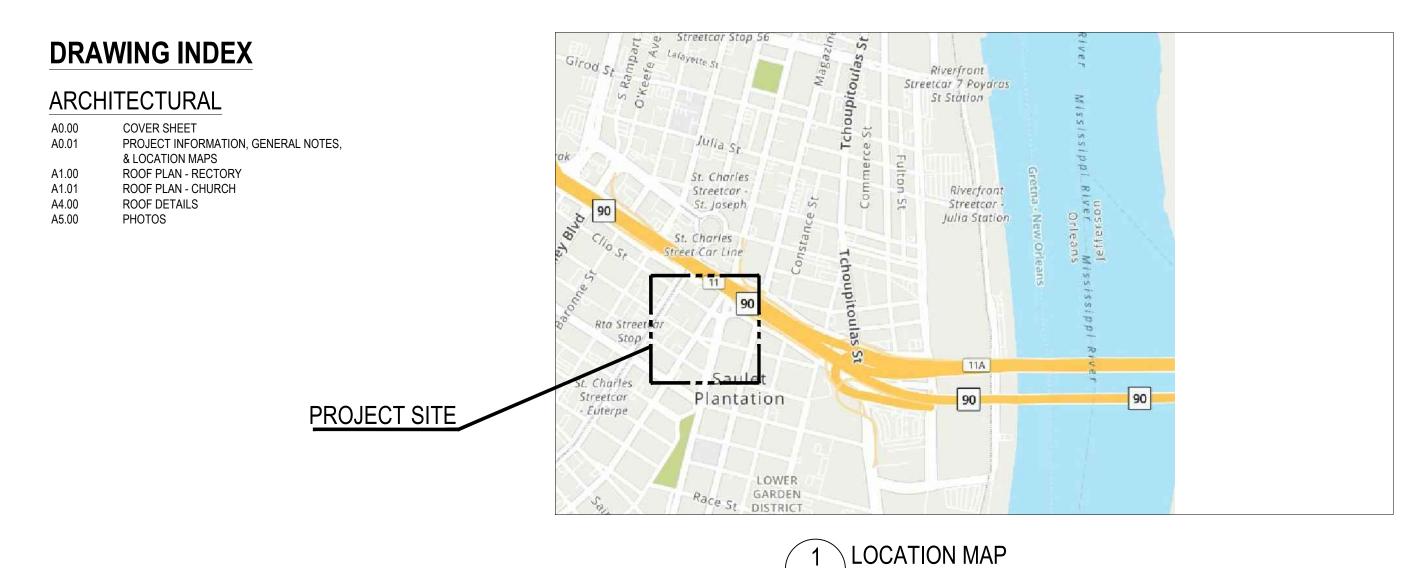



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RECTORY

THERESA HURRIC ARCHDI(

DATEISSUED: 5 OCT 2022 REVISED: REVISED: DRAWN BY: CHECKED BY: CV, AJT

CONSTRUCTION DOCUMENTS

22029

COVER SHEET

SHEET:

A0.00

PROJECT INFORMATION

NTERNATIONAL BUILDING CODE. 2015 EDITION

ZONING: ORLEANS PARISH ZONING ORDINANCE

OCCUPANCY CLASSIFICATION: EDUCATION (IBC)

CONSTRUCTION TYPE: (VARIES)

II (111) (NFPA) UNPROTECTED NON-COMBUSTIBLE - NON-BEARING WALLS. ROOF ASSEMBLY - CLASS A.

> DRINKING FOUNTAIN DRAIN INLET

DIAMETER

DIMENSION DOWN DOOR

DOWNSPOUT

EDGE BAND EXPANSION JOINT ELECTRIC(AL)

DETAIL

DRAWER

ELEVATOR

EXISTING FEET

FACE OF

FINISH(ED)

GAGE, GAUGE

GAI VANIZED

FACE OF EXISTING FINISH FACE OF FINISH

GENERAL CONTRACTOR

GYPSUM WALL BOARD

HOT-DIP GALVANIZED (STEEL)

HEATING, VENTILATION, AIR CONDITIONING WT

GENERAL GALVANIZED IRON

GYPSUM BOARD

HOLLOW METAL

HORIZONTAL HOUR

HANDICAP

EMERGENCY

DS DTL DWR EA

EA EB EJ ELEC EL, ELEV

ELEV

ELEV EMERG EQ EQUIP EXH EXIST ', FT

FL FLR FOEF FOF FR FRP GA

GALV G.C. GEN G.I.

GL GWB GYP GYP BD

HD HD GALV HDW HM HORIZ

HVAC ", IN. INCL INSUL

ABBREVIATIONS:

A/C ACOUS. AIR CONDITIONING ACOUSTICAL ACT
ADJ
AFF
AHU
AL, ALUM
ALT
ANN.
ARCH
ASPH
BD
BLDG
BLK
BLKG
BLW
BOT
BRK
CFCI ACOUSTIC CEILING TILE INT
JAN.
JT
JTS
LAM
LAV
LBL
MATL, MAT'L
MAX
MECH
MFR
MISC ALUMINUM ALTERNATE JOINTS ANNFALED I AMINATE(D) ARCHITECT LAVATORY LAVATORY
LABEL
MATERIAL
MAXIMUM
MECHANICAL
MANUFACTURE(R) BOARD BUILDING BLOCK BLOCKING BFI OW MISCELLANEOUS ROTTOM MINIMUM MIN MIRR MLD MO MR MTD MTL NA NIC #, NO. NOM NTS OC OFCI BRICK
CONTRACTOR FURNISHED
CONTRACTOR INSTALLED MIRROR(ED) MOLDING, MOULDING MASONRY OPENING MOISTURE RESISTAN CEILING HEIGHT CONTROL JOINT MOUNT(ED), (ING) NOT APPLICABLE NOT IN CONTRAC NUMBER(S), (ED) NOMINAL NOT TO SCALE CONCRETE MASONRY UNIT COMBINATION ON CENTER CONCRETE OWNER FURNISHED CONTRACTOR INSTALLED OFOI CONTINUOUS CONTRACTOR OPENING(S) CEMENTITIOUS SOFFIT BOARD PLUS OR MINUS CERAMIC TILE PARTITION(S) PEMB PF PLAS PLY. PNL PROP. PSF PRE-ENGINEERED METAL BUILDIN CL DBL DEMO DF DEMOLITION

PLYWOOD

PANEL(S)

QT R, RAD

REM RM RO SB

SQ SHT SIM SPEC

STL STOR

PROPERTY

QUARRY TILE

REFERENCE REFERENCE REQUIRED REFRIGERATOR REINFORCE(D), (ING)

REMOVE(D)

SOLID CORE SQUARE FOOT

SPECIFICATION(S)

STURUCTURE STRUCTURAL

UNDERWRITER'S LABORATORY
UNLESS NOTED OTHERWISE
VINYL COMPOSITION TILE

VERIFY ON JOB WITH ARCHITEC

ROOM ROUGH OPENING

SHEET

STORAGE

SURFACE(D)

TEMPORARY

THICKNESS

VERIFY ON JOB

VINYL WALL FABRIC

WATER CLOSET(S)

WATERPROOF

TOILFT(S)

TYPICAL

VERTICAL

WOOD

WAINSCOT

REINFORCING BAR

RADIUS

POLINDS PER SOLIARE FOOT

PRESSURE TREATED

WIND UPLIFT **CALCULATIONS** WIND LOAD (ASCE 7-16): BASIC WIND SPEED = 144 MPH RISK CATEGORY = II EXPOSURE CATEGORY = B


BEGINNING ON THE START DATE ESTABLISHED IN THE NOTICE-TO-PROCEED. THE CONTRACTOR RECOMES RESPONSIBLE FOR GETTING DEGINATING ON THE START DATE ESTABLISHED IN THE NOTICE-TO-PROCEED, THE CONTRACTOR BECOMES RESPONSIBLE FOR GETTING AND MAINTAINING ROOFS, IDENTIFIED AS REQUIRING REPAIRS OR REPLACEMENT, IN A WATERTIGHT CONDITION UNTIL COMPLETION OF PROJECT. MAINTENANCE INCLUDES MAINTAINING EXISTING TEMPORARY ROOF SYSTEMS. SOME ROOFS MAY NOT BE WATERTIGHT ON THIS START DATE.

GENERAL NOTES:

- 2. BEFORE SUBMITTING THE BID PROPOSAL. THE BIDDER SHALL PERSONALLY EXAMINE THE SITE AND ACQUAINT HIMSELF WITH ALL ATTENDING EXISTING CONDITIONS SO THAT NO MISUNDERSTANDING MAY AFTERWARDS ARISE AS TO THE CHARACTER OR EXTENT OF THE
- 3. TO ESTABLISH THE COMPLETE SCOPE OF ITS WORK AND TO AFFECT CLOSE COORDINATION WITH THE OTHER TRADES, EACH TRADE SHALL COMPLETELY REVIEW THE CONSTRUCTION DOCUMENTS, NOT ONLY FOR ITS RESPECTIVE TRADE BUT FOR THE WORK OF OTHER RELATED
- 4. THE CONTRACTOR SHALL FIELD VERIFY ALL DIMENSIONS AND CONDITIONS TO SUIT JOB REQUIREMENTS AND TO AVOID CONFLICT PRIOR TO
- 5. ALL DIMENSIONS AND TIE-INS GOVERNED BY EXISTING CONDITIONS ARE APPROXIMATE AND ARE NOT GUARANTEED TO BE CORRECT. ALL SUCH DIMENSIONS AND CONDITIONS SHALL BE FIELD VERIFIED BY THE CONTRACTOR PRIOR TO THE PREPARATION OF SHOP DRAWINGS AND BEFORE PROCEEDING WITH ANY WORK. THE FIRST SUBMITTAL OF SHOP DRAWINGS MUST CONTAIN CORRECT CONDITIONS AND DIMENSIONS OBTAINED FROM THE FIFLD. IF CONDITIONS AND DIMENSIONS VARY GREATLY FROM THOSE SHOWN. THE CONTRACTOR
- 6. CONTRACTOR SHALL COORDINATE AND OBTAIN ALL NECESSARY INSPECTIONS AND APPROVALS OR GUIDELINES FROM GOVERNING REGULATORY AGENCIES BEFORE PROCEEDING WITH ANY ITEMS OF WORK UNDER OR WITHIN SUCH JURISDICTION/S
- IT IS THE INTENT OF THE CONSTRUCTION DOCUMENTS TO PROVIDE FOR COMPLETE AND FINISHED WORK. ALL MISCELLANEOUS I COMPONENTS, PARTS, ANCHORS AND OTHER INCIDENTAL ITEMS REQUIRED FOR COMPLETE ASSEMBLY, FUNCTIONING AND OFERATION OF AN ITEM OR SYSTEM SHALL BE PROVIDED. THE CONTRACTOR SHALL INCLUDE ALL COMPONENTS WHICH ARE NOT SHOWN ON THE DRAWING, BUT WHICH ARE REQUIRED AS AN ESSENTIAL AESTHETIC OR FUNCTIONAL COMPONENT OF THE WORK.
- THE CONTRACTOR SHALL SUBCONTRACT WITH SUPPLIERS AND FABRICATORS AND INSTALLATION COMPANIES WHICH CAN DEMONSTRATE THAT THEY POSSESS THE KNOWLEDGE. EXPERIENCE AND PROVEN CAPABILITIES TO FULLY PERFORM ALL ASPECTS OF THE WORK
- UNLESS NOTED OTHERWISE ON THE DRAWINGS OR BY INDUSTRY STANDARDS, AN APPROVED MANUFACTURER'S PRODUCT IS TO BE FABRICATED AND INSTALLED IN ACCORDANCE WITH THAT MANUFACTURER'S LATEST PUBLISHED SPECIFICATIONS AND INSTALLATION
- 10. THE CONTRACTOR SHALL PROTECT EXISTING LITH ITIES & SERVICES AGAINST DISRUPTION DUE TO THEIR WORK. LITHLITY SERVICE IS TO BE THE CONTRACTOR SHALL PROTECT SEATING UTILITIES & SERVICES AGAINST DISCOVERION DUE TO THEIR WORK. STRITT SERVICES TO BY OPERATIONAL THROUGHOUT THE ENTIRE PROJECT. NECESSARY DISRUPTIONS MUST BE APPROVED BY THE OWNER, AND OWNERS REP. 72 HRS IN ADVANCE OF NEED, PER THE SPECIFICATIONS. ANY DAMAGE TO EXISTING UTILITIES AND SYSTEMS DURING CONSTRUCTION SHALL BE REPAIRED BY THE CONTRACTOR AT NO ADDITIONAL COST TO THE OWNER.
- 11. CONTRACTOR TO PERFORM ALL CUTTING AND PATCHING AS REQUIRED IN THE COURSE OF THIS WORK, USING CRAFTSMEN WITH EXPERTISE IN THE CONSTRUCTION TO BE PATCHED, INCLUDING WORK THAT IS REQUIRED BY MECHANICAL AND ELECTRICAL SUB-CONTRACTORS. ALL EXISTING CONSTRUCTION AND SITE TO BE PATCHED WITH MATCHING MATERIALS AND TO MEET ORIGINAL FIRE
- 12. ALL WORK AT THE BUILDING AND SITE SHALL BE IN COMPLIANCE WITH ALL CALCASIEU PARISH AND OTHER LOCAL CODES, STATE AND
- 13. ALL NEW EXTERIOR ELEMENTS OF THE BUILDING AND THE ASSOCIATED ADJACENT EXTERIOR PROJECT ELEMENTS. SHALL MEET THE
- 14. ANY CONFLICTS WITH THE DRAWINGS SHALL BE BROUGHT TO THE ATTENTION OF THE ARCHITECT IMMEDIATELY
- 15. CONTRACTOR SHALL PROTECT EXISTING CONSTRUCTION TO REMAIN. IT SHALL BE CONTRACTOR'S RESPONSIBILITY TO REPAIR OR REPLACE TO MATCH EXISTING, ANY EXISTING CONSTRUCTION DAMAGED DURING THE COURSE OF THIS WORK
- 16. ALL NOTES AND DETAILS LABELED "TYPICAL" OR "TYP." ON THESE DRAWINGS SHALL APPLY TO ALL SITUATIONS OR WORK ITEMS REQUIRED
- 17. DEVIATION FROM THE CONTRACT DOCUMENTS NOT APPROVED IN WRITING BY THE ARCHITECT SHALL BE THE RESPONSIBILITY OF THE
- 18. CONTRACTOR SHALL PROVIDE ALL TEMPORARY UTILITIES REQUIRED FOR CONSTRUCTION EITHER FROM EXISTING OWNER SOURCES OR FROM HIS OWN SOURCES. MODIFICATIONS OF EXISTING OWNER SOURCES SHALL BE RETURNED TO PRECONSTRUCTION CONDITIONS PRIOR TO COMPLETION OF PROJECT.
- 19. CONTRACTOR SHALL PROVIDE TEMPORARY TOILET FACILITIES FOR WORKERS; USE OF OWNER FACILITIES, OUTSIDE OF THE "DESIGNATED CONSTRUCTION AREAS", ARE PROHIBITED. CONTRACTOR SHALL NOT USE INTERIOR AREAS OF OTHER OWNER FACILITIES FOR ANY REASON OTHER THAN THOSE DIRECTLY RELATED TO PERFORMING THE SCHEDULED WORK INTERIOR AREAS OF THE OTHER OWNER FACILITIES. NOT BE USED FOR CONTRACTOR OR SUBCONTRACTOR BREAK OR MEETING AREAS OR FOR STORAGE OF MATERIALS OR DEBRIS.
- REPRESENT CONTRACTOR IN HIS ABSENCE AND ALL DIRECTIONS GIVEN TO HIM SHALL BE AS BINDING AS IF GIVEN DIRECTLY TO THE
- 21. CONTRACTOR SHALL MAINTAIN STRICT DUST AND TRASH CONTROL AT ALL TIMES. PROVIDE CLEANING AND REMOVAL OF ALL TRASH AND DEBRIS ON A DAILY BASIS. CONTRACTOR SHALL PROVIDE FOR HIS OWN TRASH STORAGE AND HAULING
- OWNER AS TO NOT DISRUPT THE DAILY WORK ACTIVITIES OF THE SCHOOL FACILITY
- 23. CONTRACTOR SHALL PROVIDE TEMPORARY CONSTRUCTION FENCING AROUND THE PROJECT SITE OR THE MATERIALS STORED THEREON URING THE ENTIRE CONSTRUCTION PERIOD. TEMPORARY FENCING (MINIMUM 6' HIGH CHAIN-LINKED FENCING) AS NOTED ON THE CONTROL OF THE CONTROL OF THE CONTROL OF THE CONTROL OF SHALL REQUIRE APPROVAL BY THE WHER'S REP., IN WRITING, WITH THEIR SIGNATURES. APPROVAL OF THE OWNER WILL BE OBTAINED BY THE ARCHITECT.
- 24. CONTRACTOR TO RETURN SITE TO EXISTING CONDITION AFTER WORK IS COMPLETE. INCLUDING ADDITIONAL FILL. COMPACTION, GRASS. FTC. RESTORE EXISTING GRASSY AREAS TO THEIR PRE-CONSTRUCTION CONDITION
- 25 CONTRACTOR SHALL PROTECT EXISTING ROADWAYS FENCING AND LITH LITES WITH SIGNAGE TEMPORARY FENCING AND TEMPORARY CONTRACTOR SHALL FOLICE LEAD IN THIS ROUGHT AT THE STATE OF THE STATE
- 26. CONTRACTOR TO KEEP EXISTING DRIVES, PARKING AREAS, SIDEWALKS, AND STREETS, FREE OF SILT, DIRT, SAND, ETC., AT ALL TIMES COORDINATE PLAN WITH THE SCHOOL FACILITY
- 27. UNLESS OTHERWISE LABELED AS "EXISTING", CONSIDER ALL ELEMENTS AS "NEW", WHETHER LABELED "NEW" OR NO
- 28. CONTRACTOR SHALL MAINTAIN A SECURE FACILITY AT ALL TIMES. AT NO TIME SHALL THE FACILITY BE UNSECURED WHILE THE SITE IS UNMANNED, DURING THE USE OF EXTERIOR DOORS UNDER ANY CIRCUMSTANCE. CONTRACTOR SHALL SEQUENCE REMOVAL AND REPLACEMENT WORK IN ORDER TO MAINTAIN A SECURE FACILITY.
- 29. CONTRACTOR SHALL COORDINATE WITH THE OWNER FOR OPERATION / SHUT DOWN OF THE EXISTING SITE UTILITIES, AS REQUIRED
- 30. CONTRACTOR SHALL MAINTAIN THE EXISTING LAWN / GRASSY AREAS, WITHIN THE "DESIGNATED CONSTRUCTION AREA", ON A WEEKLY BASIS. MOWING SHALL MAINTAIN GRASSY AREAS TO A MAXIMUM HEIGHT OF 6'


DESIGN UPLIFT-RESISTANCE CAPACITY: MINIMUM DESIGN UPLIFT-RESISTANCE CAPACITIES:

ST. THERESA OF AVILA CHURCH RECTORY - ROOF 2 - FLAT ROOF

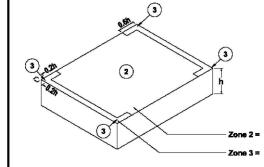



43.4 pounds per square foot Zone 1 75.5 pounds per square foot 99.6 pounds per square foot Zone 2 135.7 pounds per square foot


ST. THERESA OF AVILA CHURCH RECTORY - ROOF 2 - EDGE METAL

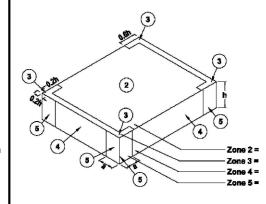

83.0 pounds per square foot Zone 3 113.1 pounds per square foot Zone 4 42.8 pounds per square foot 52.9 pounds per square foot

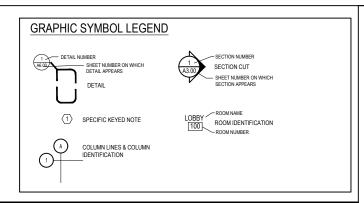

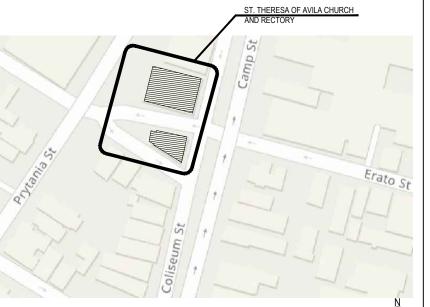

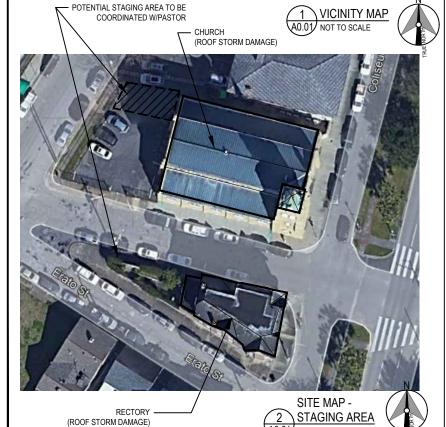

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VergesRome

PAIR? EAN ∞ಶ ORL CHURCH M OF NEW AVILA يبا 🗅 \overline{S} **RCHDIOCE** RICAN 9F **THERESA** HURF ST DATEISSUE REVISED: REVISED: REVISED: REVISED: DRAWN BY: CHECKED BY: CONSTRUCTION

DOCUMENTS

22029

PROJECT INFO., GENERAL

NOTES, & LOCATION MAPS

THESE PLANS AND SPECIFICATIONS HAVE BEEN PREPARED BY ME, OR UNDER MY CLOSE PERSONAL SUPERVISION AND TO THE BEST OF MY

Q:\CADD\2022\22029_ANO-StTheresaOfAvila\22029_A-001_INFO-NOTE-ROOF.dwg, 10/6/2022 11:5:3:46 AM, _DWGsen legs to presonal supervision and to the Best of MY (now Legs and Belliefs, comply with all state and local code requirements.

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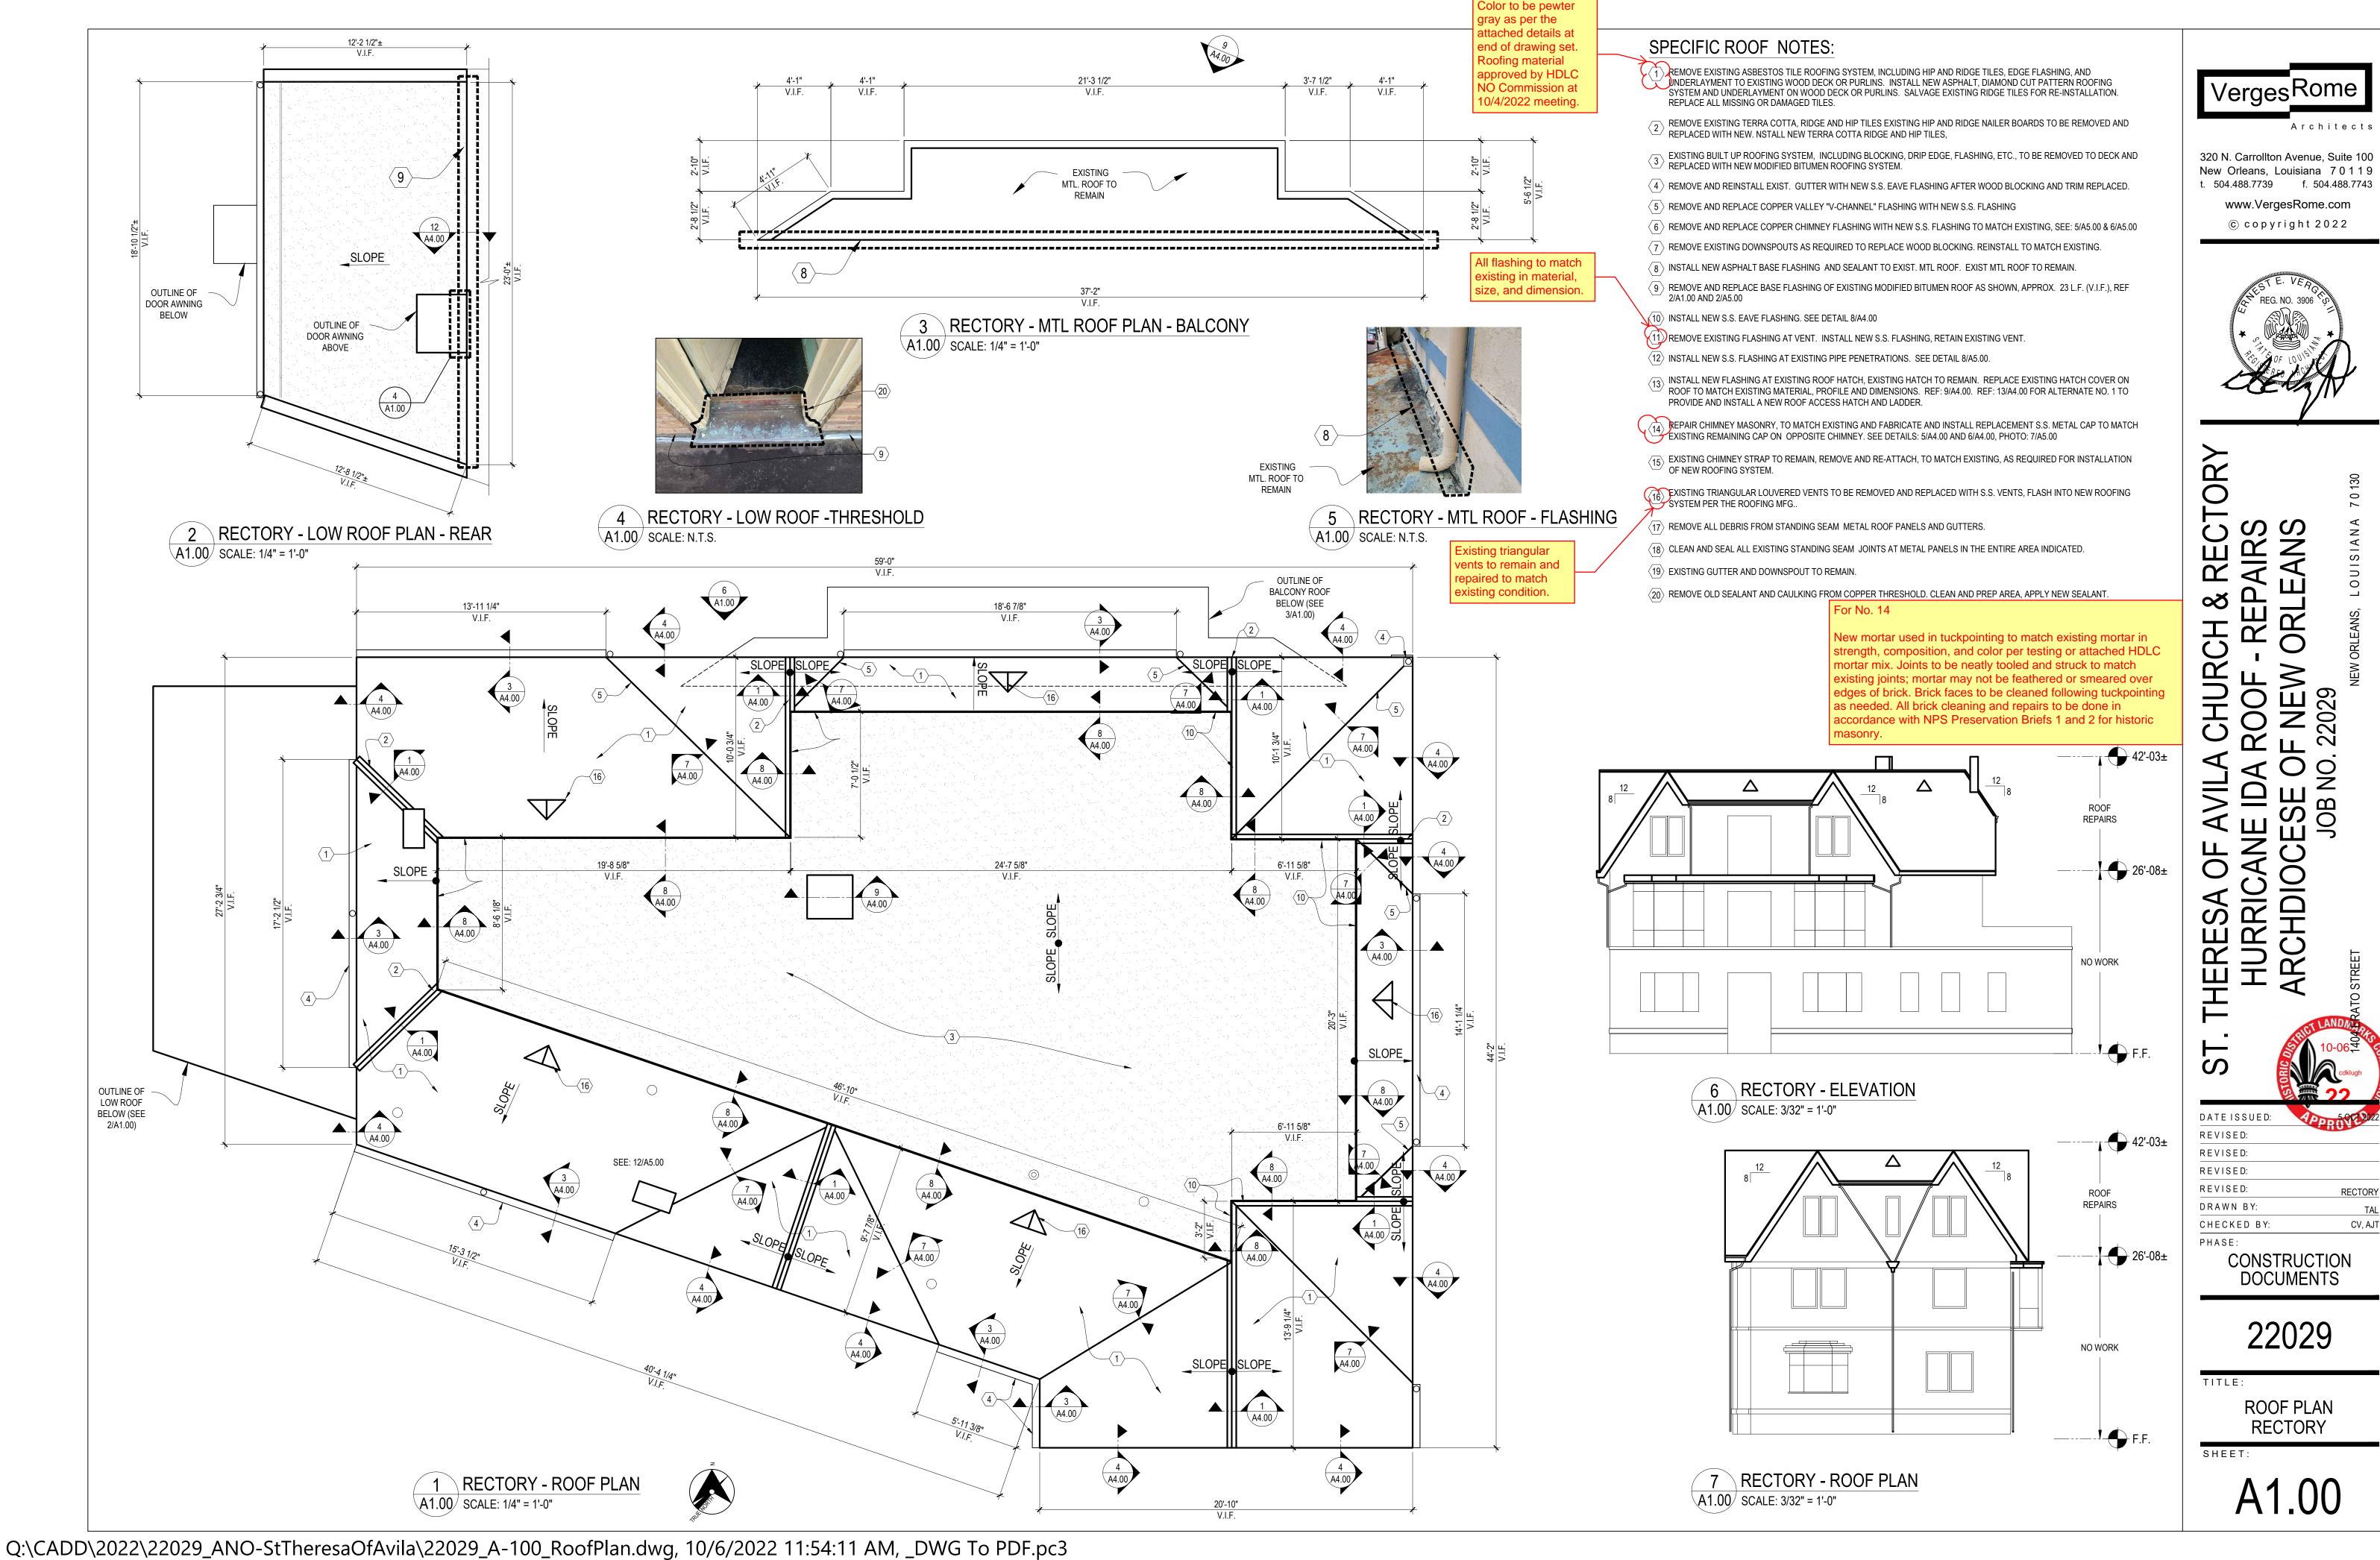
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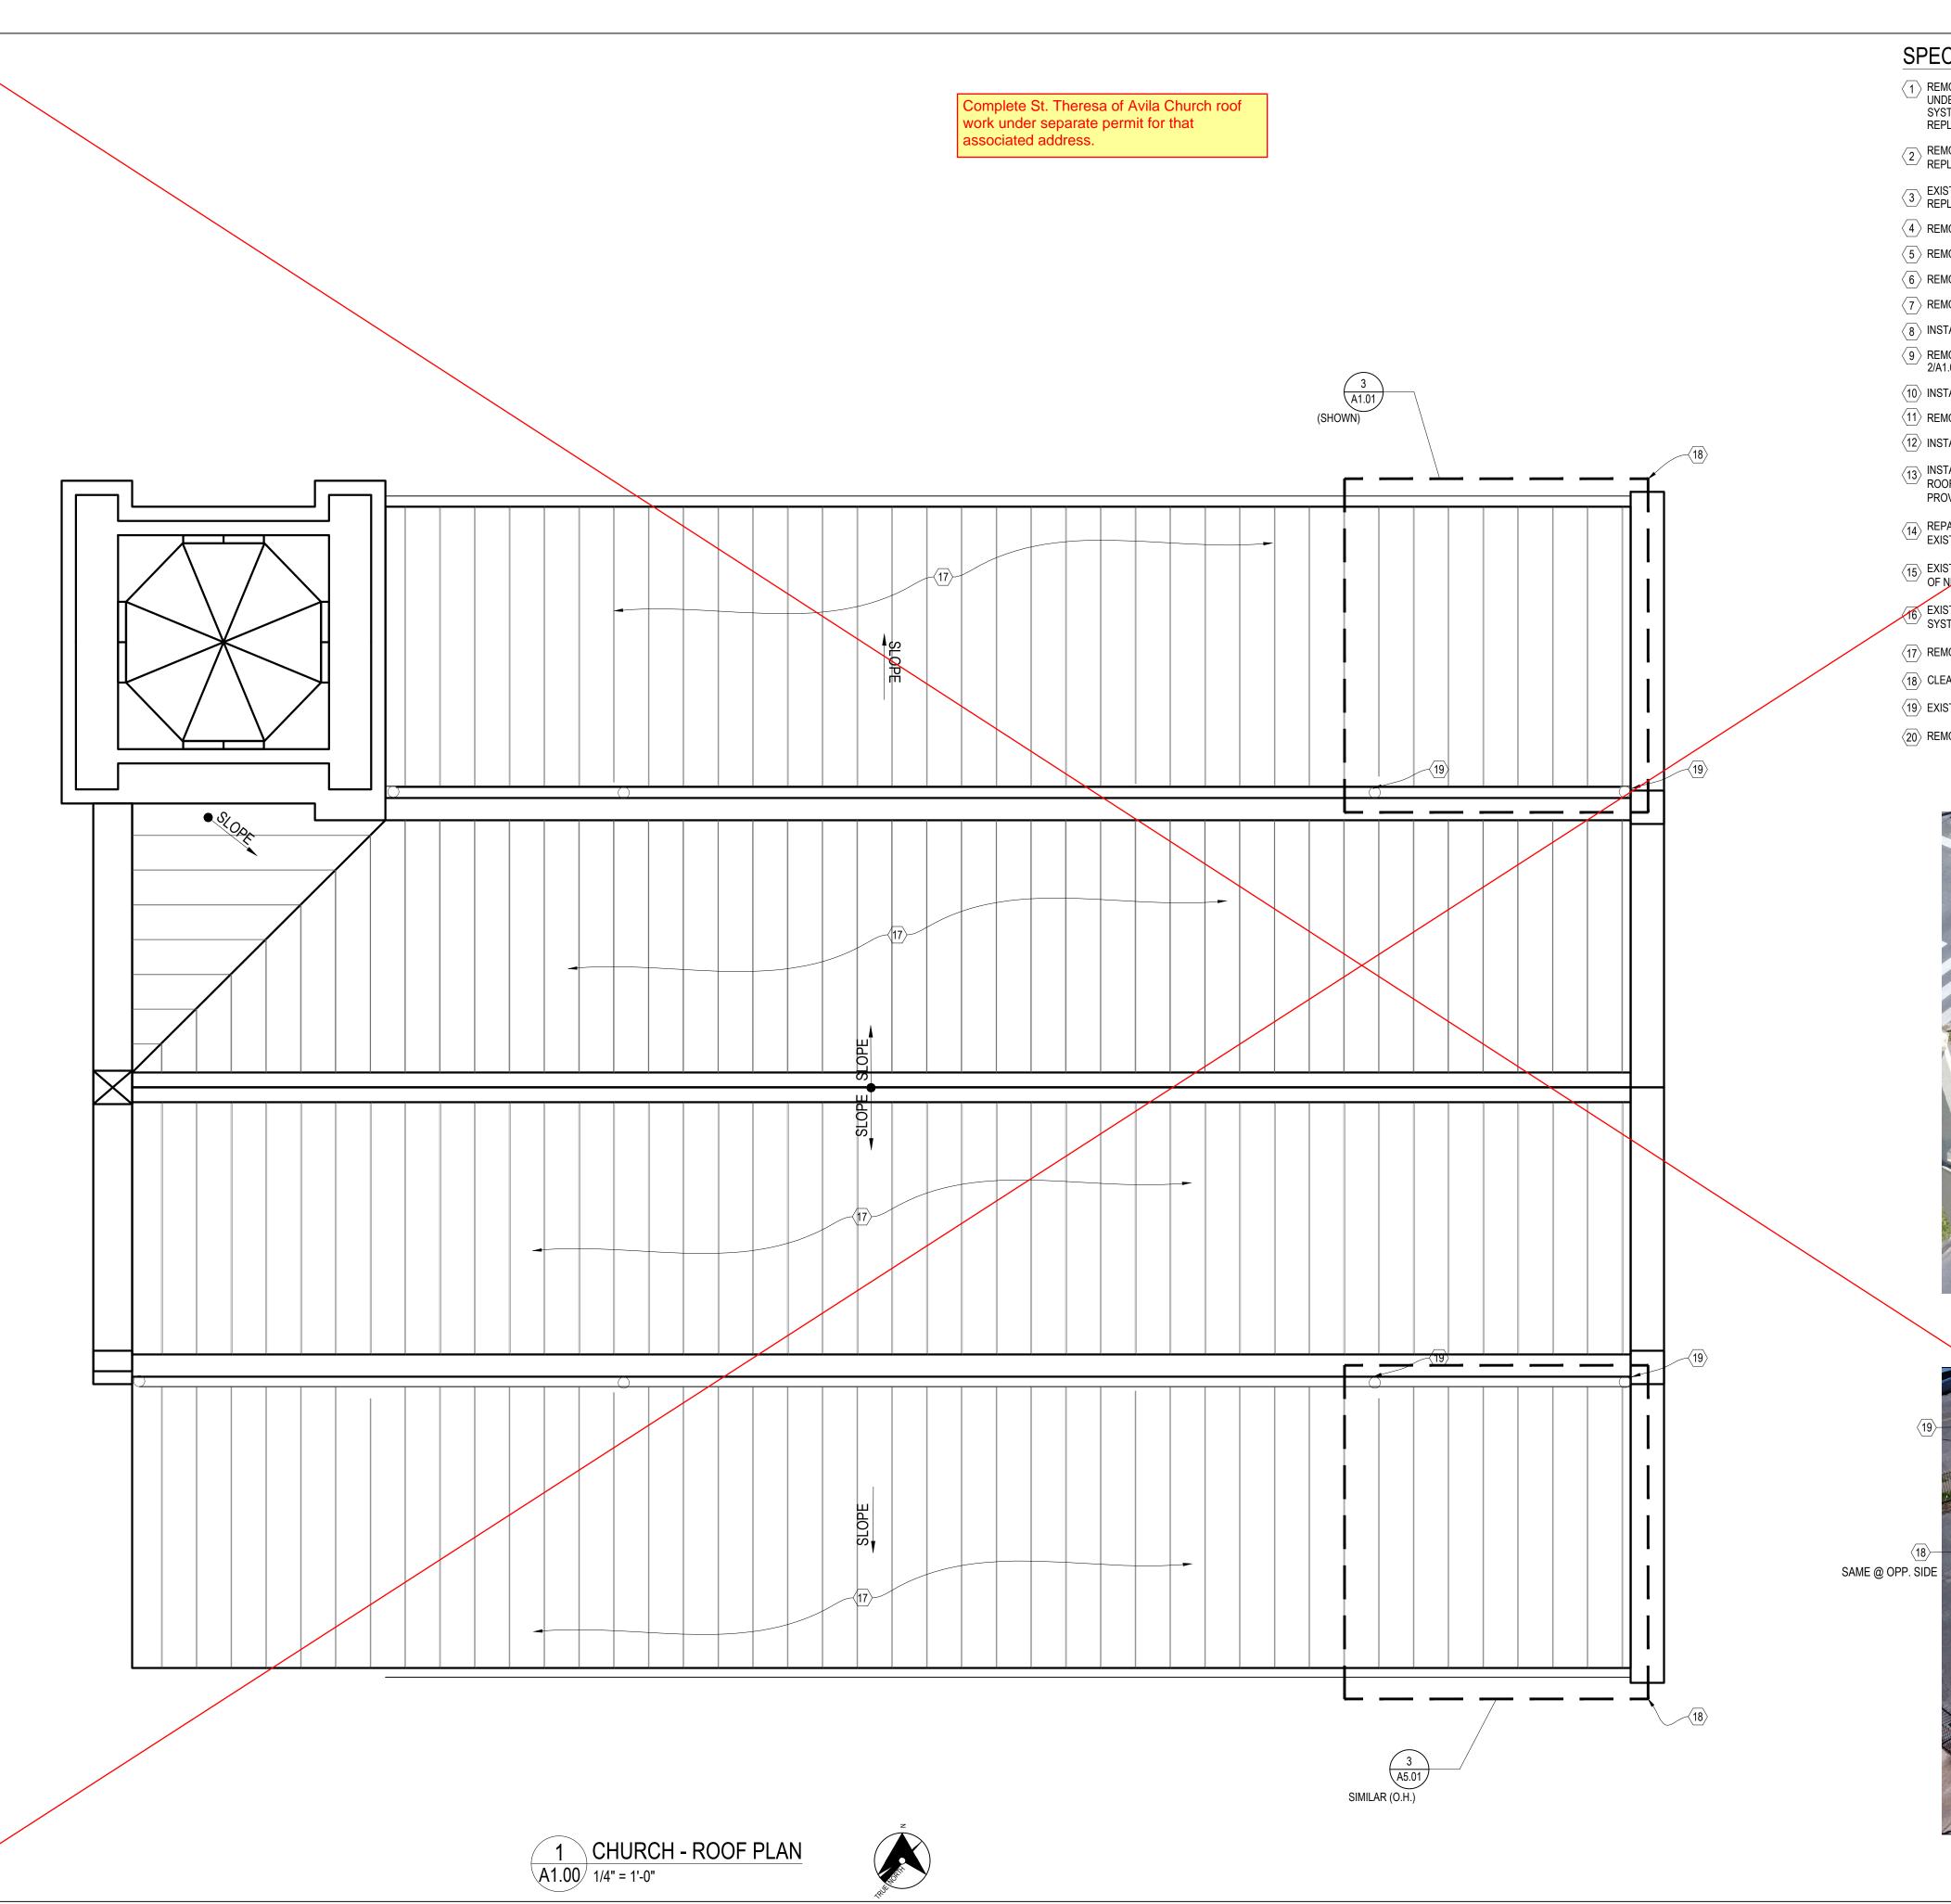
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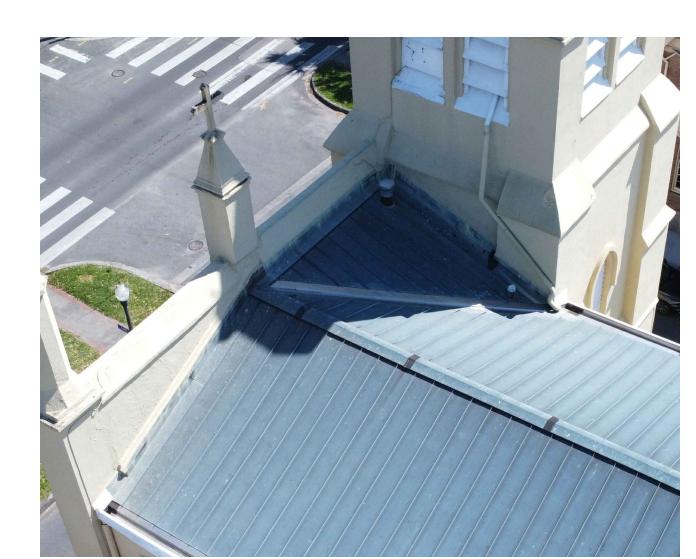
Q:\CADD\2022\22029_ANO-StTheresaOfAvila\22029_A-001_INFO-NOTE-ROOF.dwg, 10/6/2022 11:5:3:46 AM, _DWGsen legs to presonal supervision and to the Best of MY (now Legs and Belliefs, comply with all state and local code requirements.)






SPECIFIC ROOF NOTES:

- REMOVE EXISTING ASBESTOS TILE ROOFING SYSTEM, INCLUDING HIP AND RIDGE TILES, EDGE FLASHING, AND UNDERLAYMENT TO EXISTING WOOD DECK OR PURLINS. INSTALL NEW ASPHALT, DIAMOND CUT PATTERN ROOFING SYSTEM AND UNDERLAYMENT ON WOOD DECK OR PURLINS. SALVAGE EXISTING RIDGE TILES FOR RE-INSTALLATION. REPLACE ALL MISSING OR DAMAGED TILES.
- REMOVE EXISTING TERRA COTTA, RIDGE AND HIP TILES EXISTING HIP AND RIDGE NAILER BOARDS TO BE REMOVED AND REPLACED WITH NEW. NSTALL NEW TERRA COTTA RIDGE AND HIP TILES,
- EXISTING BUILT UP ROOFING SYSTEM, INCLUDING BLOCKING, DRIP EDGE, FLASHING, ETC., TO BE REMOVED TO DECK AND REPLACED WITH NEW MODIFIED BITUMEN ROOFING SYSTEM.
- 4 REMOVE AND REINSTALL EXIST. GUTTER WITH NEW S.S. EAVE FLASHING AFTER WOOD BLOCKING AND TRIM REPLACED
- (5) REMOVE AND REPLACE COPPER VALLEY "V-CHANNEL" FLASHING WITH NEW S.S. FLASHING
- 6 REMOVE AND REPLACE COPPER CHIMNEY FLASHING WITH NEW S.S. FLASHING TO MATCH EXISTING, SEE. 5/A5.00 & 6/A5.00
- $\langle 7
 angle$ REMOVE EXISTING DOWNSPOUTS AS REQUIRED TO REPLACE WOOD BLOCKING. REINSTALL TO MATCH EXISTING.
- 8 INSTALL NEW ASPHALT BASE FLASHING AND SEALANT TO EXIST. MTL ROOF. EXIST MTL ROOF TO REMAIN.
- PREMOVE AND REPLACE BASE FLASHING OF EXISTING MODIFIED BITUMEN ROOF AS SHOWN, APPROX. 23 L.F. (V.I.F.), REF 2/A1.00 AND 2/A5.00
- (10) INSTALL NEW S.S. EAVE FLASHING. SEE DETAIL 8/A4.00
- (11) REMOVE EXISTING FLASHING AT VENT. INSTALL NEW S.S. FLASHING, RETAIN EXISTING VENT.
- (12) INSTALL NEW S.S. FLASHING AT EXISTING PIPE PENETRATIONS. SEE DETAIL 8/A5.00.
- INSTALL NEW FLASHING AT EXISTING ROOF HATCH, EXISTING HATCH TO REMAIN. REPLACE EXISTING HATCH COVER ON ROOF TO MATCH EXISTING MATERIAL, PROFILE AND DIMENSIONS. REF: 9/A4.00. REF: 13/A4.00 FOR ALTERNATE NO. 1 TO PROVIDE AND INSTALL A NEW ROOF ACCESS HATCH AND LADDER.
- REPAIR CHIMNEY MASONRY, TO MATCH EXISTING AND FABRICATE AND INSTALL REPLACEMENT S.S. METAL CAP TO MATCH EXISTING REMAINING CAP ON OPPOSITE CHIMNEY. SEE DETAILS: 5/A4.00 AND 6/A4.00, PHOTO: 7/A5.00
- EXISTING CHIMNEY STRAP TO REMAIN, REMOVE AND RE-ATTACH, TO MATCH EXISTING, AS REQUIRED FOR INSTALLATION OF NEW ROOFING SYSTEM.
- EXISTING TRIANGULAR LOUVERED VENTS TO BE REMOVED AND REPLACED WITH S.S. VENTS, FLASH INTO NEW ROOFING SYSTEM PER THE ROOFING MFG..
- (17) REMOVE ALL DEBRIS FROM STANDING SEAM METAL ROOF PANELS AND GUTTERS.
- $\langle 18 \rangle$ CLEAN AND SEAL ALL EXISTING STANDING SEAM JOINTS AT METAL PANELS IN THE ENTIRE AREA INDICATED.
- (19) EXISTING GUTTER AND DOWNSPOUT TO REMAIN.
- $\langle 20
 angle$ REMOVE OLD SEALANT AND CAULKING FROM COPPER THRESHOLD. CLEAN AND PREP AREA, APPLY NEW SEALANT.



2 RIDGE & PARAPET - CHURCH ROOF A1.01 SCALE: N.T.S.

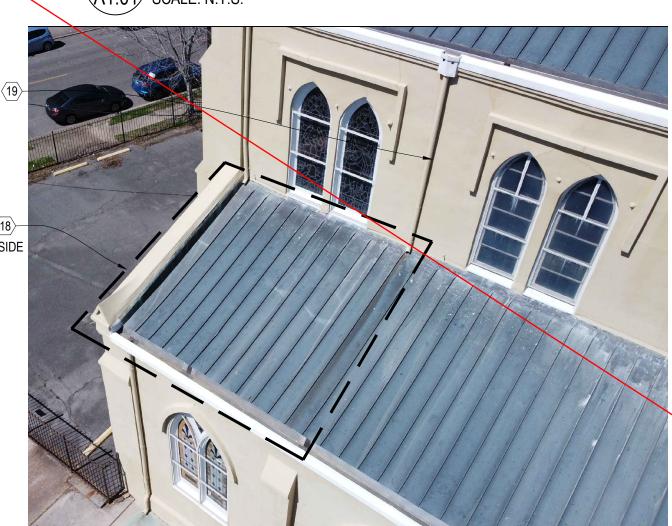

3 STANDING SEAM JOINTS AT REAR OF CHURCH A1.01 SCALE: N.T.S.

Verges Rome

Architects

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T. THERESA OF AVILA CHURCH & RECTORY HURRICANE IDA ROOF - REPAIRS ARCHDIOCESE OF NEW ORLEANS

DATEISSUED: 5 OCT 2022

REVISED:

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REVISED:

REVISED:

DRAWN BY:

CHECKED BY:

CV, AJT

PHASE:

CONSTRUCTION DOCUMENTS


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ROOF PLAN CHURCH

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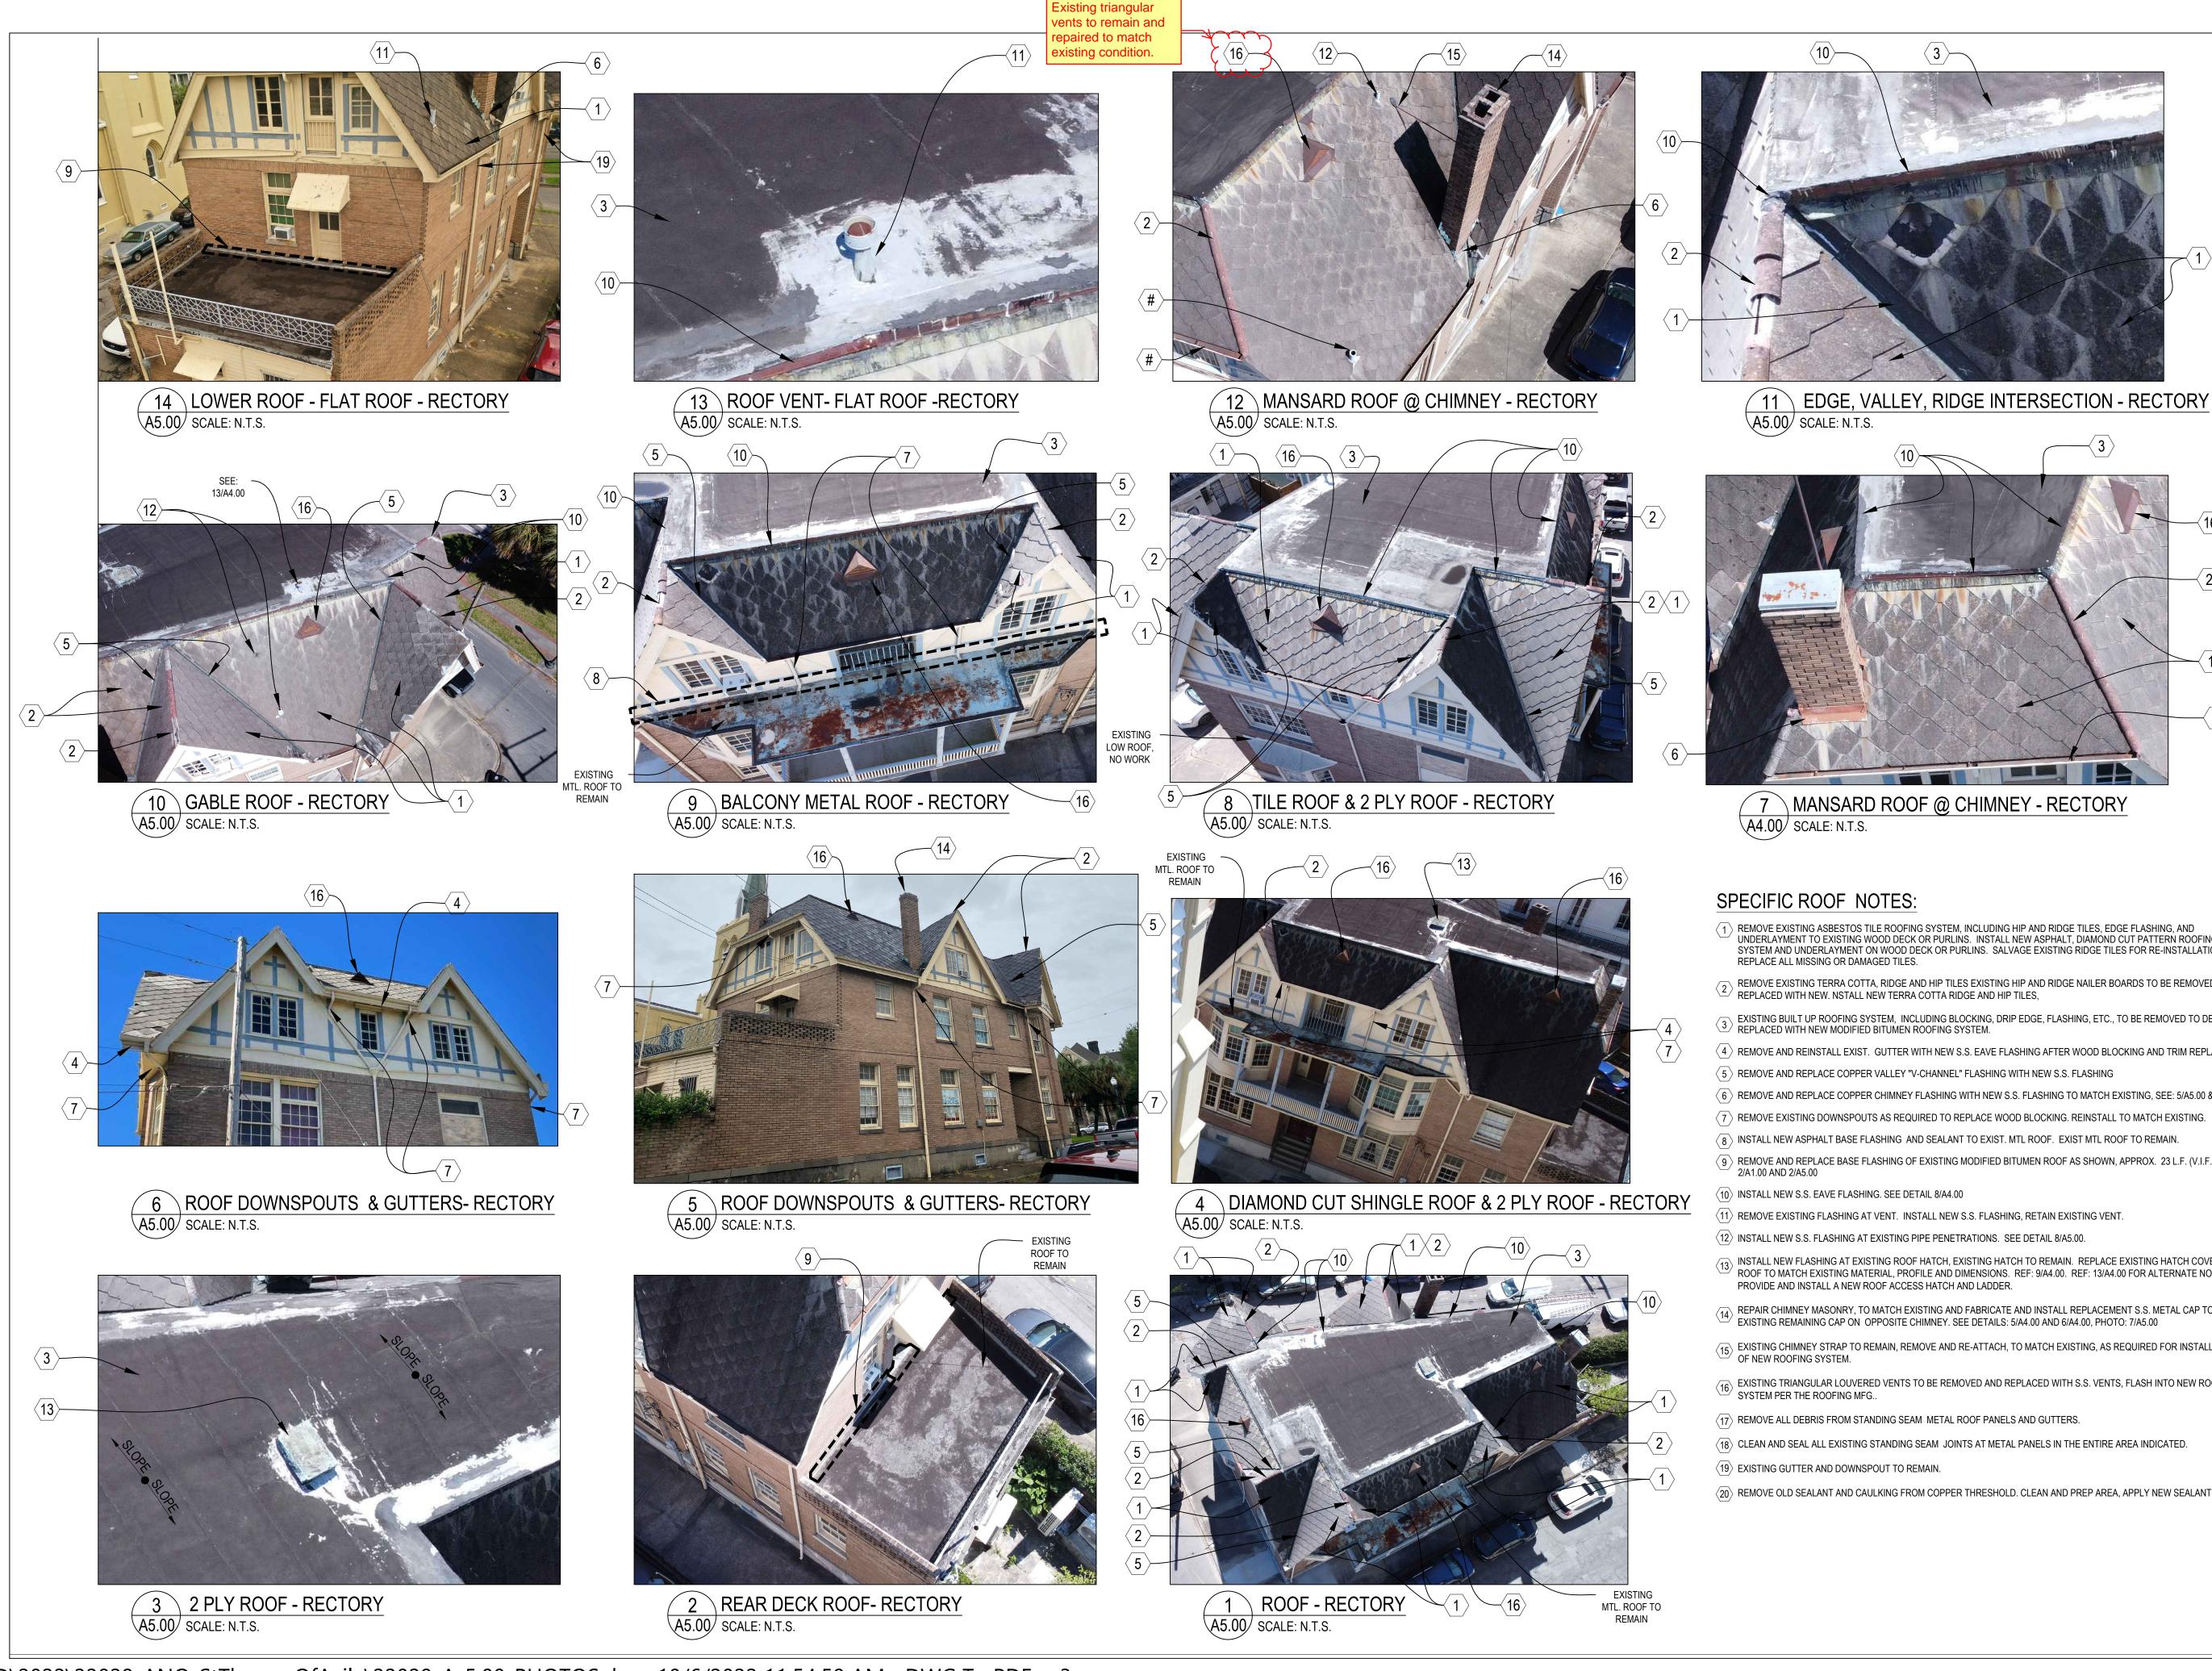


Architects

CV, AJT

ROOF
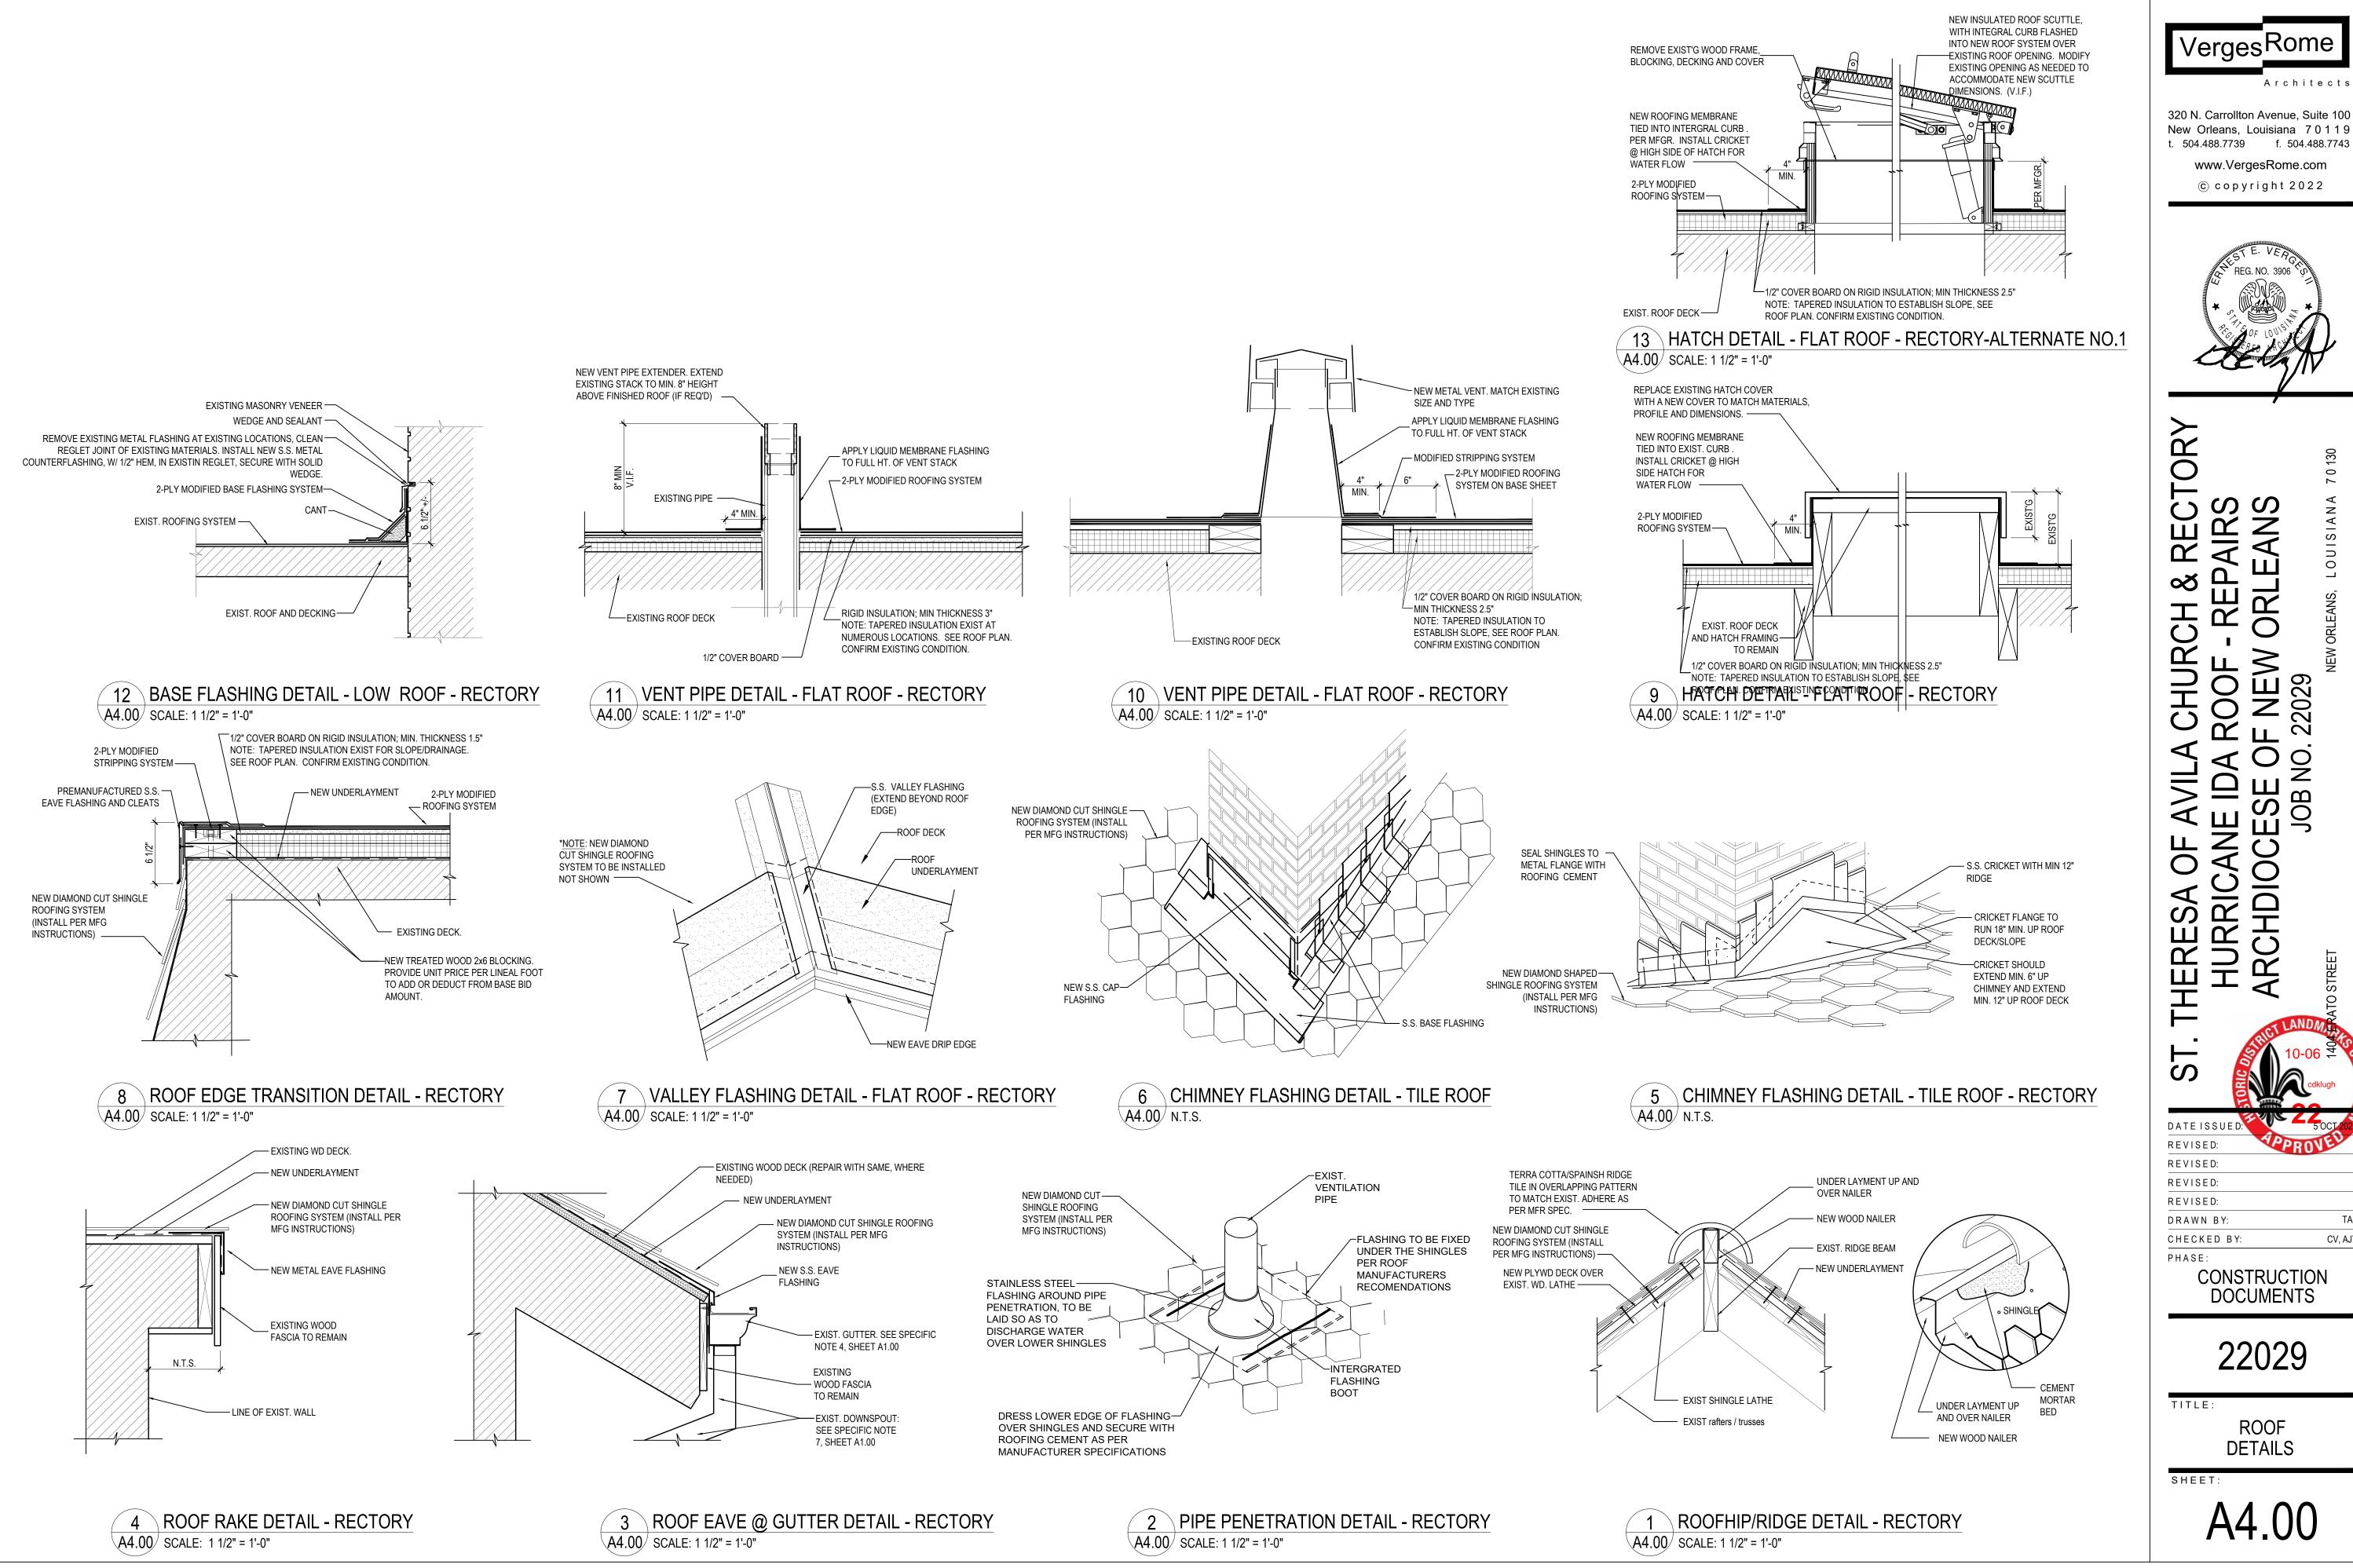
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