

3231 JACKSON AVENUE NEW ORLEANS, LA 70125

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JACKSON AVENUE RESIDENCE


3231 JACKSON AVENUE NEW ORLEANS, LA 70125

architect: **SARAH SATTERLEE** 9301 HOG EYE ROAD #536 AUSTIN, TX 76724



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AO.1
TITLE PAGE

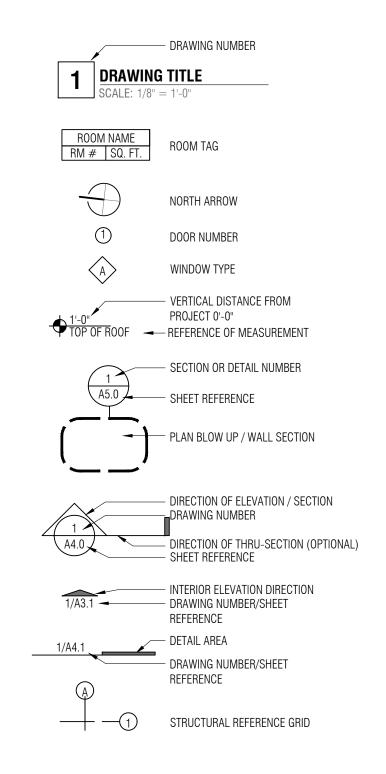

ADJ Adjacent ALT Alternate APPROX Approximate ARCH Architectural ASTM American Society for Testing & Materials BD Board BTWN Between BFF Below Finish Floor BLDG Building BLW Below BM Beam BO By Owner BOF By Owner in Future BOT Bottom BP Base Plate BS Both Sides CAB Cabinet CF Cubic Feet CIP Cast-in-Place CJT Construction Joint CJ Control Joint CL Centerline CLG Ceiling CLR Clear CM Construction Manager CMU Concrete Masonry Units CONC Concrete CONT Continuous COORD Coordinate CT Ceramic Tile CTR Center CY Cubic Yards DBL Double DEMO Demolition/Demolish DIA Diameter DIAG Diagonal DIM Dimension DWG Drawing EA Each EJ Expansion Joint ELEC Electrical EQ Equal EXT Exterior FDN Foundation

FFE Finish Floor Elevation GC General Contractor GYP Gypsum Wallboard HVAC Heating, Ventilating, Air Conditioning ID Inside Diameter IPS Iron Pin Set MECH Mechanical MFR Manufacturer MISC Miscellaneous NA Not Applicable NIC Not in Contract NTS Not to Scale OD Outside Diameter OTB Open to Below PSF Pounds per Square Foot PSI Pounds per Square Inch PT Pressure-Treated

FT Feet

FUT Future

GAL Gallon

HDWR Hardware

HW Hot Water

IN Inches

INT Interior

JST Joist

JT Joint

KO Knockout

L Angle

LAV Lavatory

LB Pound

LIN Linear

MAX Maximum

MIN Minimum

MTL Metal

NO Number

OC On Center

OPP Opposite

PLS Plaster

PR Pair

PLY Plywood

R Radius

RA Return Air REF Reference

NOM Nominal

GALV Galvanized

REF Reference REFR Refrigerator RM Room RO Rough Opening SECT Section SHT Sheet SIM Simiilar SPECS Specifications SQ Square SQ FT Square Foot SQ IN Square Inch STL Steel SUSP Suspended SYS System T/ Top T&B Top and Bottom T&G Tongue and Groove TOW Top of Wall TYP Typical UGND Underground UON Unless Otherwise Noted VERT Vertical VB Vapor Barrier VENT Ventilation VIF Verify in Field VTR Vent through Roof W Width / Wide W/ With W/O Without WC Water Closet WD Wood WT Weight WWF Welded Wire Fabric

2 SYMBOLS AND ABBREVIATIONS

CODE ANALYSIS

Applicable Codes

Building Code 2015 International Building Code 2015 NFPA 101 Life Safety Life Safety Code 2015 International Mechanical Code Mechanical Code

Plumbing Code SW&B Plumbing Code, 2000 Louisiana Plumbing Code

Electrical Code 2014 National Electric Code

AHRAE 90.1-2007 Energy Code

Occupancy Classification

Residential R-3 (IBC 310.5)

NFPA: Residential, One- and Two- Family Dwelling Unit (NFPA 6.1.8.1)

Building Information

Building Area

Conditioned main floor: 1315 sf Covered, unconditioned main floor: 129 sf Conditioned second floor: 1048 sf

Covered, unconditioned second floor: 0 sf

Total floor area: 2363 sf

Number of Stories:

Building Height: 30'-8" above adj grade, approx. Fire Protection: No sprinkler provided

PROJECT INFORMATION

New single-family residence. Description:

Building Address: 3231 Jackson Avenue New Orleans, LA 70125

Tax Bill/ Parcel Number 412402304

AE, -1.0 BFE. See Foundation Plan for FFE Flood Zone:

Zoning District: HU-RD2

3600 SF Lot Area Lot Width 60' 60' Lot Depth Permeable Open Space: 47% Yard Requirements: See Site Plan

Parking: None required

PROJECT DIRECTORY

Blake and Lena Satterlee 3822 Octavia

New Orleans, LA 70125

Sarah Satterlee Architect:

9301 Hog Eye Road #536 Austin, TX 78724

General Contractor: Charles Aponza

Brighter Horizons Construction







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SARAH SATTERLEE 9301 HOG EYE ROAD #536 AUSTIN, TX 76724



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A0.2 PROJECT INFORMATION

DEPARTMENT OF SAFETY & PERMITS CITY OF NEW ORLEANS

	1 JACKSON			SUBDIVISION:	N/A	
ISTRICT;	4TH	SQ	UARE:433	LO	TS: G & H	
COMMUNITY NUMBER	PANEL NUMBER	SUFFIX	DATE OF FIRM INDEX	FIRM ZONE	BASE FLOOD ELEVATION (BFE)	FREEBOARD (ADD 1FT FOR A AND V ZONES) OFFICE USE ONLY
225 203	0229	F	9/30/16	AE	-1.0 NA.V.D	+1ft =
MINIMUM FLO	OR ELEVATION	N:	IN ADDITION TO THE F		NS, THE FOLLOWING	<u> </u>
N.	A.V.D.	*****		GRADE OR FILL	MUST BE AT LEAST 36" ABO RONT OF THE LOT OR SITE.	OVE:
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PROVED FOR C	ITY BY:				ST BE SET AT REQUIRED MIN (ADD 1 FOOT FOR A & V-ZON	Charle Legisland.
		CERTIFICA	ATE OF CONSTRUCTION E	BENCHMARK	THE CONTROL OF THE CO	Walter Walter
EXISTING HIGHE	ST TOP OF CU	RB ELEVA	TION4.7'N.A.V.D.	ADD 3ft to	FOR PERMIT OFFICE USE ONLY curb, if no curb use the centerline of st	reet
XISTING HIGHE					9 3ft a	OF LOW
RONT (RIGHT) _ REAR (RIGHT) _ DTHER: DESCRIBE:	-4.0' N./ -3.9' N./ N.A.V.D.	A.V.D. FR A.V.D. RE		A.V.D. A.V.D. VER POLE IN FR	ONI OF LOI.	MOND W. KREBS 16. NO. 4836
NAIL SET ON	WEST SIDE O	F POWER P	OLE.			REGISTERED ROFESSIONAL
IGNATURE: A. REGISTEREI	PROFESSION CER	IAL LAND S	DATE URVEYOR OR CIVIL ENG OF TOP OF FORM OR TOP concrete for slab construc	INEER) OF PIER ELEVA	(SEA	SURVE
S BUILT ELEVA	TIONS: FORM_	S-80 - V-80	N.A.V.D. PIE	R.	_ N.A.V.D.	100
	TERIALS BELO				BE CONSTRUCTED WITH WA'M FLOOR ELEVATION (B.F.E.	
	d before framii	ng begins)	CTURAL MEMBER		K-AWAY WALLS CONSTRUCT	I FION.
V ZONES, ALL						
I V ZONES, ALL	PROFESSION	IAL LAND S	DATE	: IEER)	(SEA	L)
V ZONES, ALL IGNATURE : A. REGISTEREI	LING, GRADIN	G, DRAINA	DATE UVEYOR OR CIVIL ENGIN GE, SIDEWALK AND DRIV efore Use & Occupancy Co	EWAY CERTIFIC	ATION AND AFFIDAVIT	L)
V ZONES, ALL IGNATURE : A. REGISTEREI FIL HIS WILL CONF	LING, GRADIN (To be s	G, DRAINA ubmitted be	GE, SIDEWALK AND DRIV efore Use & Occupancy Co	EWAY CERTIFIC ertificate can be EWALKS AND DR	ATION AND AFFIDAVIT issued)	
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GIGNATURE: LA. REGISTEREI LA	LING, GRADIN (To be s IRM THAT ALL OF THE APPLI pe, rear to from PROPERLY IN PROPERLY IN PROPERLY IN WALLS REQUII Which side(s) SLABS, SUCH OR ELEVATION ARAGES IN A-2- W MINIMUM FL	G, DRAINA Lubmitted be FILLING, GI CABLE SECDATE	GE, SIDEWALK AND DRIV efore Use & Occupancy Co RADING, DRAINAGE, SIDE CTIONS OF THE CODE OF ::	EWAY CERTIFIC ertificate can be EWALKS AND DR THE CITY OF NE	ATION AND AFFIDAVIT issued) RIVEWAYS HAVE MET THE EW ORLEANS.	***
IV ZONES, ALL IGNATURE: LA. REGISTEREI LA. REGISTER	LING, GRADIN (To be s IRM THAT ALL OF THE APPLI Pe, rear to from the second se	IG, DRAINA Lubmitted be FILLING, GI CABLE SECDATEDATEDATEDATEDATEDATEDATEDATEDATEDATEDATEDATEDATEDATEDATEDATEDATEDATE	GE, SIDEWALK AND DRIV efore Use & Occupancy Co RADING, DRAINAGE, SIDE CTIONS OF THE CODE OF OR RLY FILLED TO GRADE? every 20 feet)	EWAY CERTIFIC ertificate can be EWALKS AND DR THE CITY OF NE (NOT YES	ATION AND AFFIDAVIT issued) RIVEWAYS HAVE MET THE EW ORLEANS.	***


2 ELEVATION CERTIFICATE

page size: 18" x 24". do not scale drawings.

BOUNDARY SURVEY OF PORTION OF LOTS G & H **SQUARE 433** FOURTH DISTRICT ORLEANS PARISH, LA



MARTIN LUTHER KING JR. BOULEVARD (SIDE) (LATE MELPOMENE STREET)

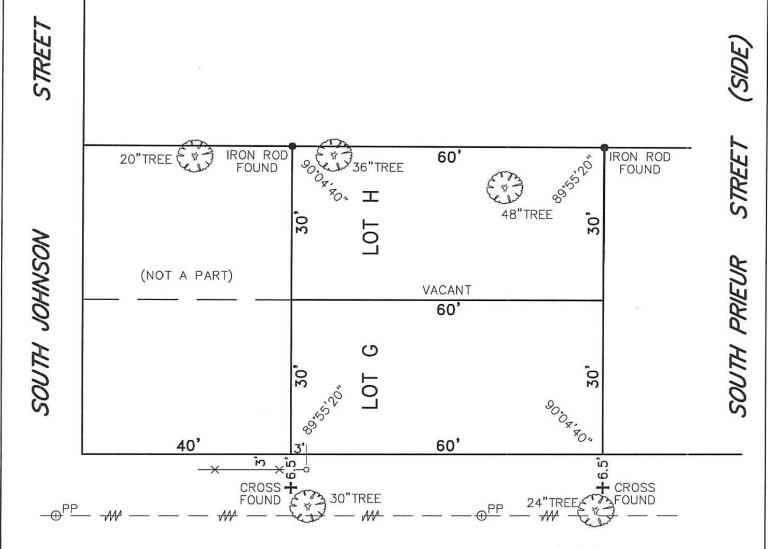

JACKSON

AVENUE

NOTE:
ALL ANGLES ARE 90° UNLESS OTHERWISE NOTED. SOME ITEMS MAY NOT BE TO SCALE FOR CLARITY. DIMENSIONS ON SURVEY PREVAIL OVER THE SCALE. FENCES ARE SHOWN FOR GENERAL INFORMATION PURPOSES ONLY AND DO NOT REFLECT EXACT LOCATION OR CONDITION.

RICHMOND W. KREBS REG. NO 4836 REGISTERED PROFESSIONAL

MADE AT THE REQUEST OF BLAKE SATTERLEE

GENERAL NOTES

ANGLES AND/OR BEARINGS ARE BASED ON REFERENCE PLAN #1
REFERENCE PLAN #1: A PLAN OF SURVEY BY GILBERT, KELLY & COUTURIE, INC., SURVEYING & ENGINEERING DATED APRIL 16, 1981

THE SERVITUDES SHOWN ON THIS SURVEY ARE LIMITED TO THOSE FURNISHED US AND THERE IS NO REPRESENTATION THAT ALL APPLICABLE SERVITUDES ARE REFLECTED OR SHOWN HEREON. THE SURVEYOR HAS MADE NO TITLE SEARCH OR PUBLIC RECORD SEARCH IN COMPILING THE DATA FOR THIS SURVEY. THIS PERIMETER SURVEY SHALL NOT CONSTITUTE A LEGAL OPINION OF TITLE, AND SHALL NOT BE RELIED UPON FOR THAT PURPOSE. THERE IS NO WARRANTY THAT IT CONFORMS TO THE LEGAL TITLE, AND WAS MADE SOLELY ACCORDING TO THE INFORMATION PROVIDED THE SURVEYOR.

ELEVATION NOTES

INSURANCE RATE MAP (FIRM) DATED: SEPTEMBER 30, 2016 BASE FLOOD ELEVATION: -1.0'

THIS IS CERTIFY THAT SUBJECT PROPERTY IS LOCATED IN THE FOLLOWING FLOOD ZONE, PER FLOOD FLOOD ZONE: AE COMMUNITY PANEL: 225203 0229 F

THIS IS TO CERTIFY THAT THE PROPERTY BOUNDARY SURVEY RECORDED HEREON WAS MADE ON THE GROUND UNDER MY DIRECT SUPERVISION, AND IS IN ACCORDANCE WITH APPLICABLE STANDARDS OF PRACTICE FOR PROFESSIONAL LAND SURVEYORS AS STIPULATED IN LOUISIANA ADMINISTRATIVE CODE TITLE: 46:LXI, CHAPTER 29 FOR A CLASS "C" (SUBURBAN) SURVEY

RICHMOND W. KREBS, PLS, LIC. #4836

R.W. KREBS PROFESSIONAL LAND SURVEYING, LLC RICHMOND W. KREBS, SR., PLS 3445 N. CAUSEWAY BLVD, SUITE 201

METAIRIE, LA. 70002 PHONE: (504) 889-9616 FAX: (504) 889-0916 E-MAIL: infonola@rwkrebs.com WEB: www.rwkrebs.com

DATE: NOVEMBER 22, 2021 DRAWN BY: WRB SCALE: 1" = 20'CHECKED BY: NDK JOB #: 212546

1 SURVEY

JACKSON AVENUE RESIDENCE

> 3231 JACKSON AVENUE NEW ORLEANS, LA 70125

SARAH SATTERLEE 9301 HOG EYE ROAD #536 AUSTIN, TX 76724



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A0.3 SURVEY

GENERAL NOTES

- 1. ALL WORK TO BE CARRIED OUT IN ACCORDANCE WITH THESE SPECIFICATIONS.
- ALL WORK SHALL BE IN ACCORDANCE WITH DESIGN AND DESCRIBED UNDER CODE REVIEW BELOW.
- 3. CONTRACTOR TO NOTIFY ARCHITECT FOR CLARIFICATION OF ANY DISCREPANCIES IN THE DRAWINGS.
- 4. SLOPE ALL EXTERIOR SLABS FOR POSITIVE DRAINAGE. STANDING WATER CAUSE FOR REJECTION NO EXCEPTIONS.
- GENERAL CONTRACTOR IS RESPONSIBLE FOR PROVIDING ALL NECESSARY BLOCKING, GYPBD AND/OR FIRE CAULKING AS NEEDED TO PROVIDE REQD FIRE RESISTANCE RATING AT ALL FLOOR, WALL, AND ROOF ASSEMBLIES AND SEPARATIONS PER CODE REQUIREMENTS.
- ARCHITECT HAS MADE EFFORT TO DOCUMENT ALL EXISTING CONDITIONS AT SITE. HOWEVER, VARIATIONS IN INFORMATION CALLED OUT HEREIN MAY EXIST. CONTRACTOR TO CONFIRM ANY VARIATIONS OR DISCREPANCIES PRIOR TO BEGINNING WORK.
- 7. FOR MINOR UNDOCUMENTED EXISTING CONDITIONS, GENERAL CONTRACTOR TO MAKE MODIFICATIONS AS REQUIRED TO FULFILL DESIGN INDICATED ON CONTRACT DOCUMENTS.

GENERAL STRUCTURAL NOTES

- 1. CONTRACTOR RESPONSIBILITY CONSTRUCTION DOCUMENTS REPRESENT THE FINISHED STRUCTURE. CONTRACTOR IS RESPONSIBLE FOR CONSTRUCTION MEANS, METHODS, SEQUENCES AND SAFETY PRECAUTIONS, INCLUDING BUT NOT LIMITED TO SHORING AND TEMPORARY BRACING.
- 2. DIMENSIONS USE WRITTEN DIMENSIONS ONLY. VERIFY ALL DIMENSIONS AT JOB SITE BEFORE COMMENCING WORK AND REPORT ANY DISCREPANCIES. WHERE NO DIMENSIONS ARE PROVIDED OBTAIN CLARIFICATION PRIOR TO PROCEEDING WITH WORK.
- OMISSIONS & CONFLICTS OMISSIONS OR CONFLICTS BETWEEN VARIOUS ELEMENTS OF THE CONSTRUCTION DOCUMENTS SHOULD BE BROUGHT TO THE ATTENTION OF THE DESIGN TEAM. IF CERTAIN FEATURES ARE NOT FULLY DELINEATED IN THE CONSTRUCTION DOCUMENTS, THEIR CONSTRUCTION SHALL BE OF THE SAME CHARACTER AS FOR SIMILAR CONDITIONS THAT ARE DELINEATED.

II. DESIGN BASIS

APPLICABLE BUILDING CODES AND STANDARDS:

1. 2015 INTERNATIONAL BUILDING CODE (IBC), NEW ORLEANS AMENDMENTS

MECHANICAL NOTES

- GENERAL CONTRACTOR RESPONSIBLE FOR PROVIDING DESIGN/BUILD MECHANICAL SERVICES FOR PROJECT. WORK TO COMPLY WITH ALL APPLICABLE CODES. WORK TO BE COORDINATED AND REVIEWED BY ARCHITECT FOR COMPLIANCE WITH DESIGN REQUIREMENTS PRIOR TO INSTALL. STANDARD SUBMITTAL PROCEDURE TO BE FOLLOWED.
- 2. ALL WORK SHALL BE PERFORMED BY LICENSED INDIVIDUALS TO PERFORM THEIR SAID WORK, AS OUTLINED BY LAW.
- 3. IT IS INTENDED THAT ALL OCCUPIED SPACES ARE TO BE CONDITIONED.
- 4. ALL HVAC DUCT WORK TO BE ROUTED ABOVE CEILING IN CONCEALED SPACE.

ELECTRICAL NOTES

- 1. GENERAL CONTRACTOR RESPONSIBLE FOR PROVIDING DESIGN/BUILD ELECTRICAL SERVICES FOR PROJECT. WORK TO COMPLY WITH ALL APPLICABLE CODES. WORK TO BE COORDINATED AND REVIEWED BY ARCHITECT FOR CODE COMPLIANCE WITH DESIGN REQUIREMENTS PRIOR TO INSTALL. STANDARD SUBMITTAL PROCEDURE TO BE FOLLOWED.
- 2. ALL WORK SHALL BE PERFORMED BY LICENSED INDIVIDUALS TO PERFORM THEIR SAID WORK, AS OUTLINED BY LAW.
- 3. LIGHTING LAYOUT SHOWN ON PLANS IS TO DESCRIBE DESIGN INTENT ONLY. ELECTRICAL CONTRACTOR TO PROVIDE ALL CODE-REQUIRED LIGHTING, EXIT SIGNAGE, ETC. FINAL LIGHTING LAYOUT TO BE COORDINATED WITH ARCHITECT.
- 4. RECEPTACLES, SWITCHES, AND ALL OUTLET BOX COVERS TO BE WHITE U.O.N.
- SMOKE AND CARBON MONOXIDE DETECTORS TO BE PROVIDED AS REQUIRED BY CONTRACTOR

PLUMBING NOTES

- 1. GENERAL CONTRACTOR RESPONSIBLE FOR PROVIDING DESIGN/BUILD PLUMBING SERVICES FOR PROJECT. WORK TO COMPLY WITH ALL APPLICABLE CODES. WORK TO BE COORDINATED AND REVIEWED BY ARCHITECT FOR CODE COMPLIANCE WITH DESIGN REQUIREMENTS PRIOR TO INSTALL. STANDARD SUBMITTAL PROCEDURE TO BE FOLLOWED.
- 2. ALL WORK SHALL BE PERFORMED BY LICENSED INDIVIDUALS TO PERFORM THEIR SAID WORK, AS OUTLINED BY LAW.
- 3. SEE PLUMBING FIXTURE SCHEDULE FOR BASIC PLUMBING FIXTURES. NOT ALL EQUIPMENT AND FIXTURES ARE SHOWN OR NOTED. PLUMBING CONTRACTOR TO PROVIDE ALL NECESSARY PARTS AND EQUIPMENT FOR COMPLETE INSTALLATION.
- 4. HOT WATER AND DRAIN PIPES SHALL BE INSULATED OR OTHERWISE CONFIGURED TO PROTECT AGAINST CONTACT. THERE SHALL BE NO SHARP OR ABRASIVE SURFACES UNDER LAVATORIES.

MATERIALS

- 1. EARTHWORK PLACE FOOTINGS ON UNDISTURBED SOIL. NOTIFY THE ARCHITECT IF 'SOFT SPOTS', UNDERGROUND OBSTRUCTIONS OR ANY UNUSUAL CONDITION IS ENCOUNTERED DURING STRIPPING, EXCAVATION OR FILLING.
- CONCRETE ALL CONCRETE WORK SHALL CONFORM TO ACI 301 SPECIFICATION FOR STRUCTURAL CONCRETE FOR BUILDINGS AND MEET THE FOLLOWING REQUIREMENTS: CONCRETE - TYPE 1 CEMENT ASTM C 150, NORMAL WEIGHT AGGREGATES ASTM C 33, 3000 PSI AT

28 DAYS, 5" SLUMP REINFORCING STEEL - ASTM A615 GRADE 60, WELDED WIRE FABRIC ASTM A185 REINFORCING STEEL DETAILS - EXCEPT AS NOTED OTHERWISE, WHERE CONTINUOUS REINFORCING IS

LAP BAR SPLICES AS INDICATED:

#3 1'-3" #4 1'-8"

#6 2'-2"

WELDED WIRE FABRIC - ONE SPACING PLUS 6"

SPECIFIED, HOOK BARS AT NON-CONTINUOUS ENDS.

PROVIDE 1 ½" TOP COVER, 3" BOTTOM COVER FOR GRADE BEAM REINFORCING.

CONCRETE MASONRY UNITS- ALL CONCRETE MASONRY WORK SHALL CONFORM TO ACI 530/530.1-05: BUILDING CODE REQUIREMENTS AND SPECIFICATIONS FOR MASONRY STRUCTURES CONCRETE MASONRY UNITS - ASTM C90, GRADE N, TYPE 1, LIGHTWEIGHT UNITS. MORTAR - ASTM C270, TYPE S. GROUT - ASTM C476.

REINFORCING STEEL - ASTM 615 GRADE 60, WIRE STEEL SHALL BE ASTM A82. HOOK HORIZONTAL BARS AT NON-CONTINUOUS ENDS OF BOND BEAMS. EXTEND VERTICAL BARS INTO HORIZONTAL BOND BEAMS. SECURE VERTICAL REINFORCING AT INTERVALS NOT TO EXCEED 192 BAR DIAMETER OR 10 FEET WITH REINFORCING WIRE BAR POSITIONERS AS DETAILED ON PLANS. LAP SPLICE REINFORCING AS INDICATED BELOW:

#4 2'0"

#6 2'6"

WIRE JOINT REINFORCING - 1'0"

THE MASONRY ASSEMBLY SHALL ACHIEVE A UNIT STRENGTH (FM') = 1500 PSI.

4. WOOD FRAMING- ALL WOOD FRAMING FABRICATION AND ERECTION SHALL CONFORM TO THE NATIONAL DESIGN SPECIFICATION FOR WOOD CONSTRUCTION BY THE NFPA. THE PLYWOOD DESIGN SPECIFICATION BY THE APA AND MEET THE REQUIREMENTS BELOW. UNLESS NOTED OTHERWISE ALL WOOD CONNECTIONS SHALL BE IN ACCORDANCE WITH THE FASTENING SCHEDULE OF THE STANDARD BUILDING CODE. ALL LUMBER IN CONTACT WITH CONCRETE OR MASONRY SHALL BE

FRAMING LUMBER - SOUTHERN YELLOW PINE, S4S, NO. 2, MAXIMUM MOISTURE CONTENT 19%. FLOOR FRAMING - PROVIDE BRIDGING FOR ALL FLOOR JOISTS AT 8'-0" O.C. MAX. PROVIDE SOLID BLOCKING AT ALL PANEL EDGES.

WALL FRAMING - THE SIZE AND SPACING OF WOOD STUDS ARE NOTED ON THE DRAWINGS. RAMSET BOTTOM PLATE OF STUD WALLS TO CONCRETE WITH 1/4" RAMSETS @ 16" O.C. PLYWOOD FLOORING - APA RATED 48/24, 3/4" THICK. NAIL WITH 8D NAILS SPACED AT 6" O.C. AT PANEL ENDS AND 12" O.C. AT INTERMEDIATE SUPPORTS.

PLYWOOD ROOFING - APA RATED 32/16, 5/8" THICK. NAIL WITH 10D NAILS SPACED AT 6" O.C. AT PANEL EDGES AND 12" O.C. AT INTERMEDIATE SUPPORTS.

WALL SHEATHING - PROVIDE 1/2" PLYWOOD ON ALL EXTERIOR WALLS. NAIL PLYWOOD EDGES WITH 10D NAILS AT 6" O.C. AT PANEL EDGES AND 12" O.C. AT INTERMEDIATE SUPPORTS. PROVIDE SOLID BLOCKING AT ALL PANEL EDGES EXCEPT SHEAR WALLS.

MISCELLANEOUS

- 1. STRUCTURAL DRAWINGS, IF ANY, ARE INTENDED TO BE USED WITH ARCHITECTURAL AND MECHANICAL DRAWINGS. CONTRACTOR IS RESPONSIBLE FOR COORDINATING SUCH REQUIREMENTS INTO THEIR SHOP DRAWINGS AND WORK.
- 1. NO CHANGE IN SIZE OR DIMENSIONS OF STRUCTURAL MEMBERS SHALL BE MADE WITHOUT THE WRITTEN APPROVAL OF THE PROFESSIONAL OF RECORD.
- 2. THE CONTRACTOR IS RESPONSIBLE FOR LIMITING THE AMOUNT OF CONSTRUCTION LOAD IMPOSED UPON THE STRUCTURAL FRAMING. CONSTRUCTION LOADS SHALL NOT EXCEED THE DESIGN CAPACITY OF THE FRAMING AT THE TIME THE LOADS ARE IMPOSED.
- 3. THE STRUCTURE IS DESIGNED TO FUNCTION AS A UNIT UPON COMPLETION. THE CONTRACTOR IS RESPONSIBLE FOR FURNISHING ALL TEMPORARY BRACING AND/OR SUPPORT THAT MAY BE REQUIRED AS THE RESULT OF THE CONTRACTOR'S CONSTRUCTION METHODS AND/OR SEQUENCES.
- 4. DO NOT SCALE THESE DRAWINGS, USE DIMENSIONS.
- 5. THE CONTRACTOR SHALL INFORM THE PROFESSIONAL OF RECORD IN WRITING OF ANY DEVIATION FROM THE CONTRACT DOCUMENTS. THE CONTRACTOR SHALL NOT BE RELIEVED OF THE RESPONSIBILITY OF SUCH DEVIATION BY THE PROFESSIONAL OF RECORD'S REVIEW OF SHOP DRAWINGS, PRODUCT DATA, ETC. UNLESS THE CONTRACTOR HAS SPECIFICALLY INFORMED THE PROFESSIONAL OF RECORD OF SUCH DEVIATION AT THE TIME OF SUBMISSION AND THE PROFESSIONAL OF RECORD HAS GIVEN WRITTEN APPROVAL TO THE SPECIFIC DEVIATION.

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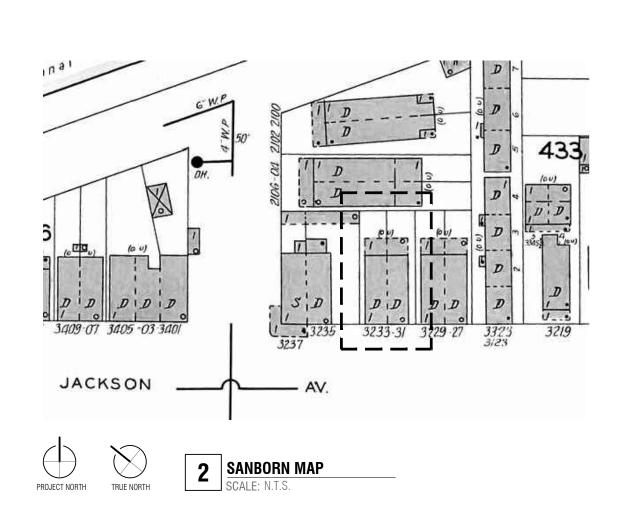


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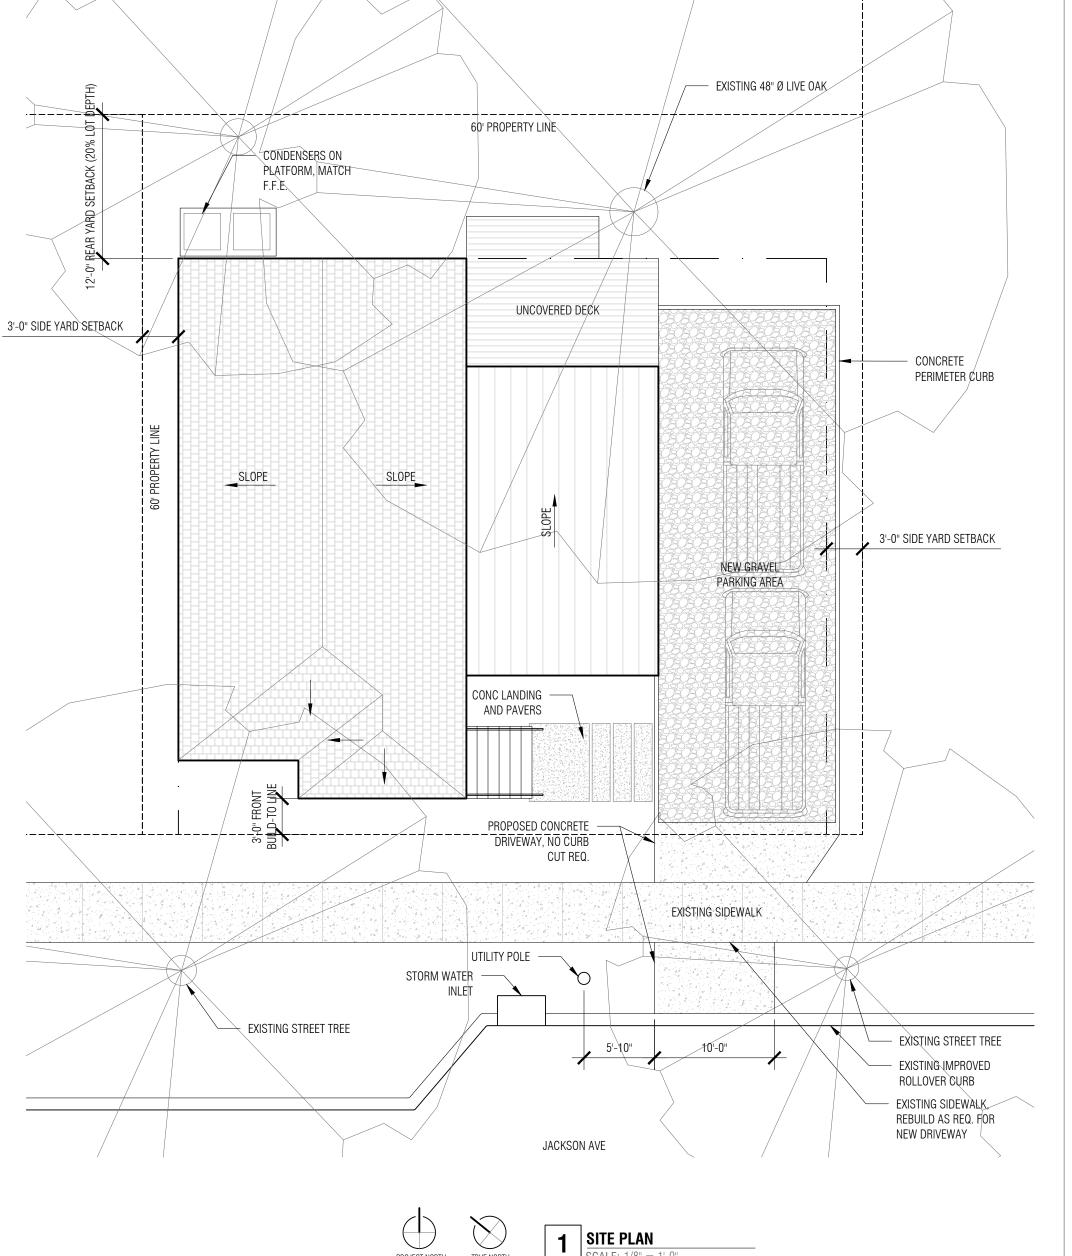
GENERAL NOTES:

-FRONT BUILD-TO LINE BASED ON 1940 SANBORN MAP, VOL. 6A. WHERE BUILD-TO LINE IS SHOWN AT 0'-0" FROM P.L.

-PROPOSED BUILD-TO LINE IS 3'-0"

-PROPOSED REAR YARD SETBACK TO BE 20% OF LOT DEPTH: 12'-0".

-IF REQ'D, ANY SIDEWALK REPAIRS TO BE DONE IN ACCORDANCE WITH PARKS AND PARKWAYS APPROVED SIDEWALK BRIDGING



PROJECT NORTH

TRUE NORTH

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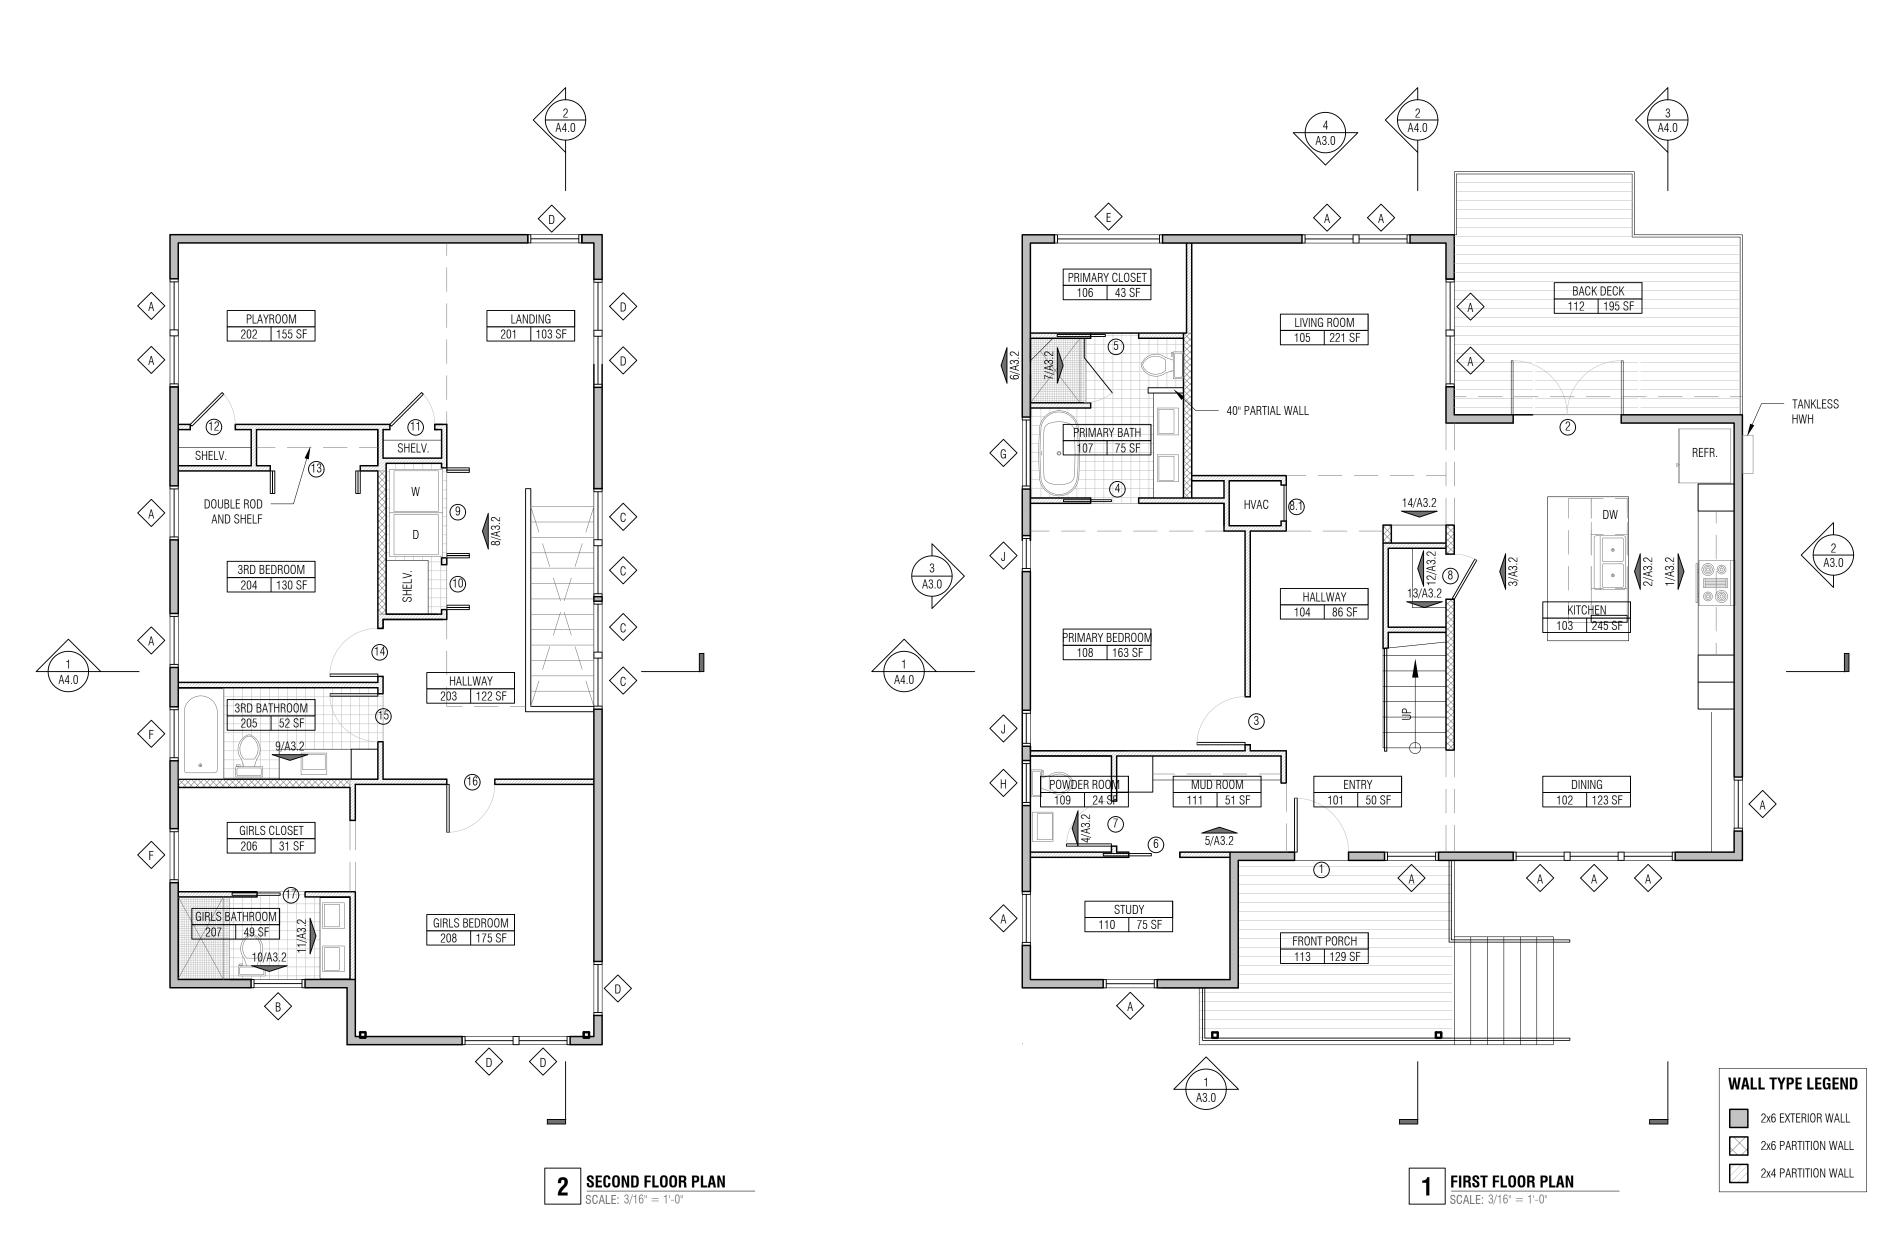


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revisions:

A1.0 SITE PLAN



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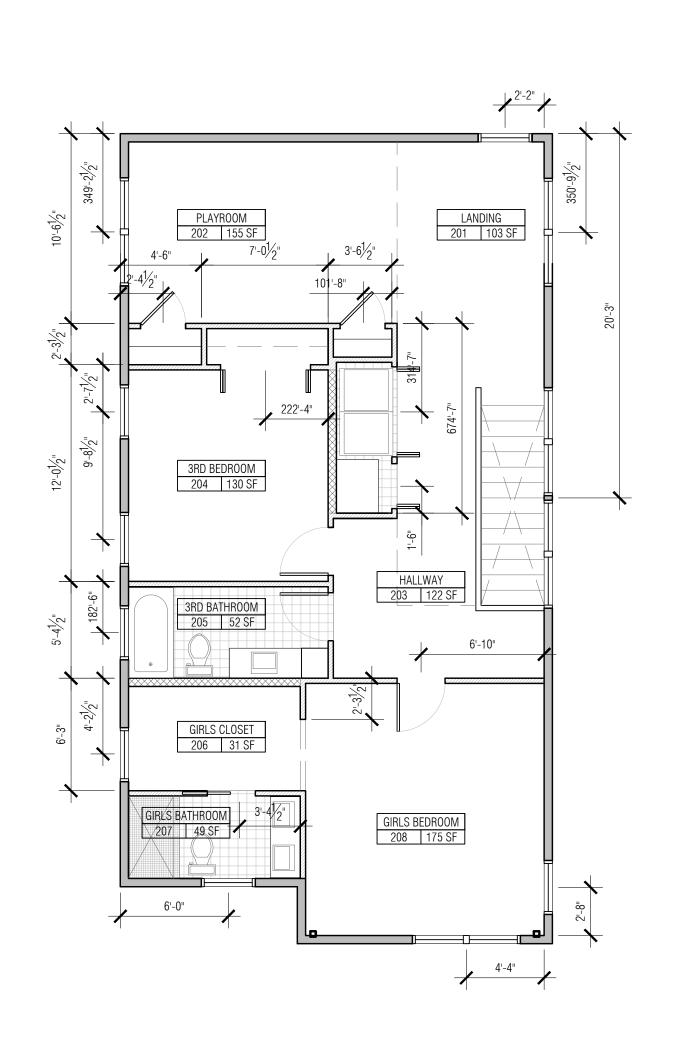
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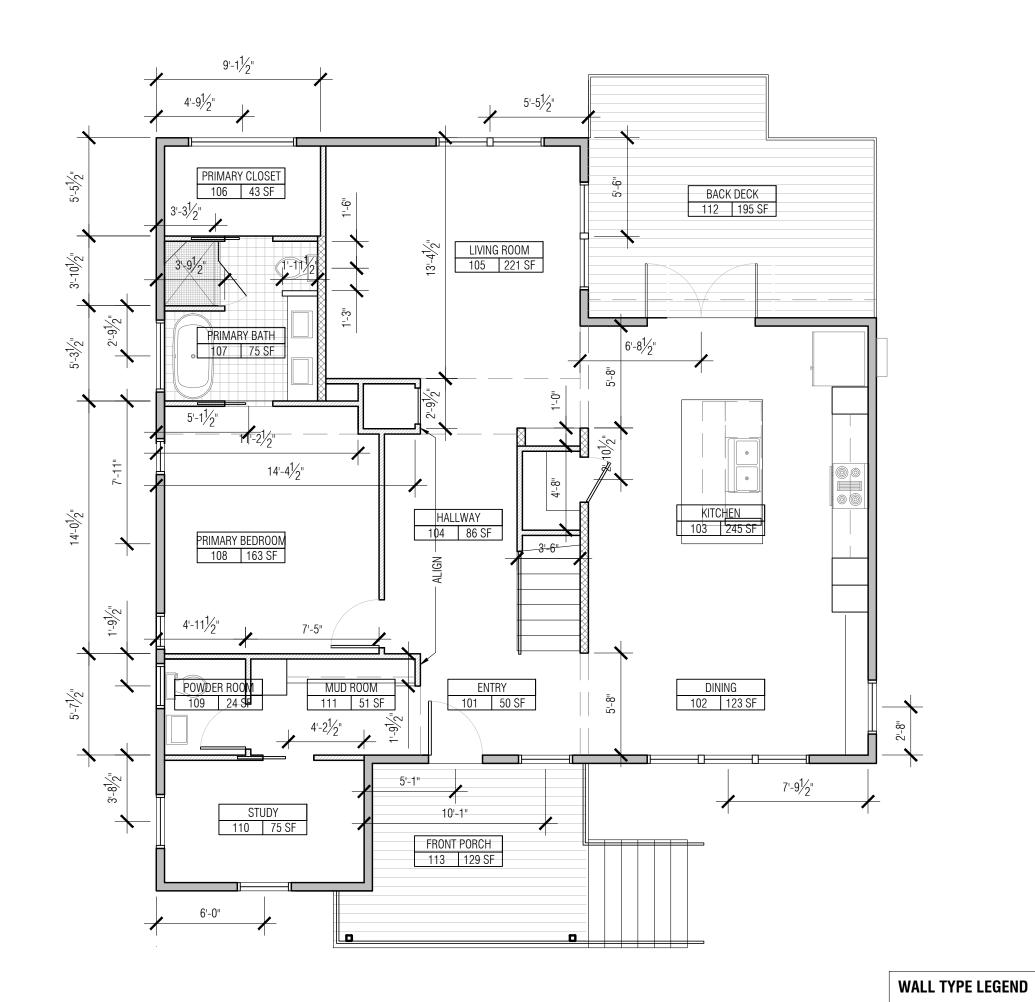
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rovisions

A2.0
BUILDING PLANS

page size: 18" x 24". do not scale drawings.





SECOND FLOOR PLAN
SCALE: 3/16" = 1'-0"

first floor plan

Scale: 3/16" = 1'-0"

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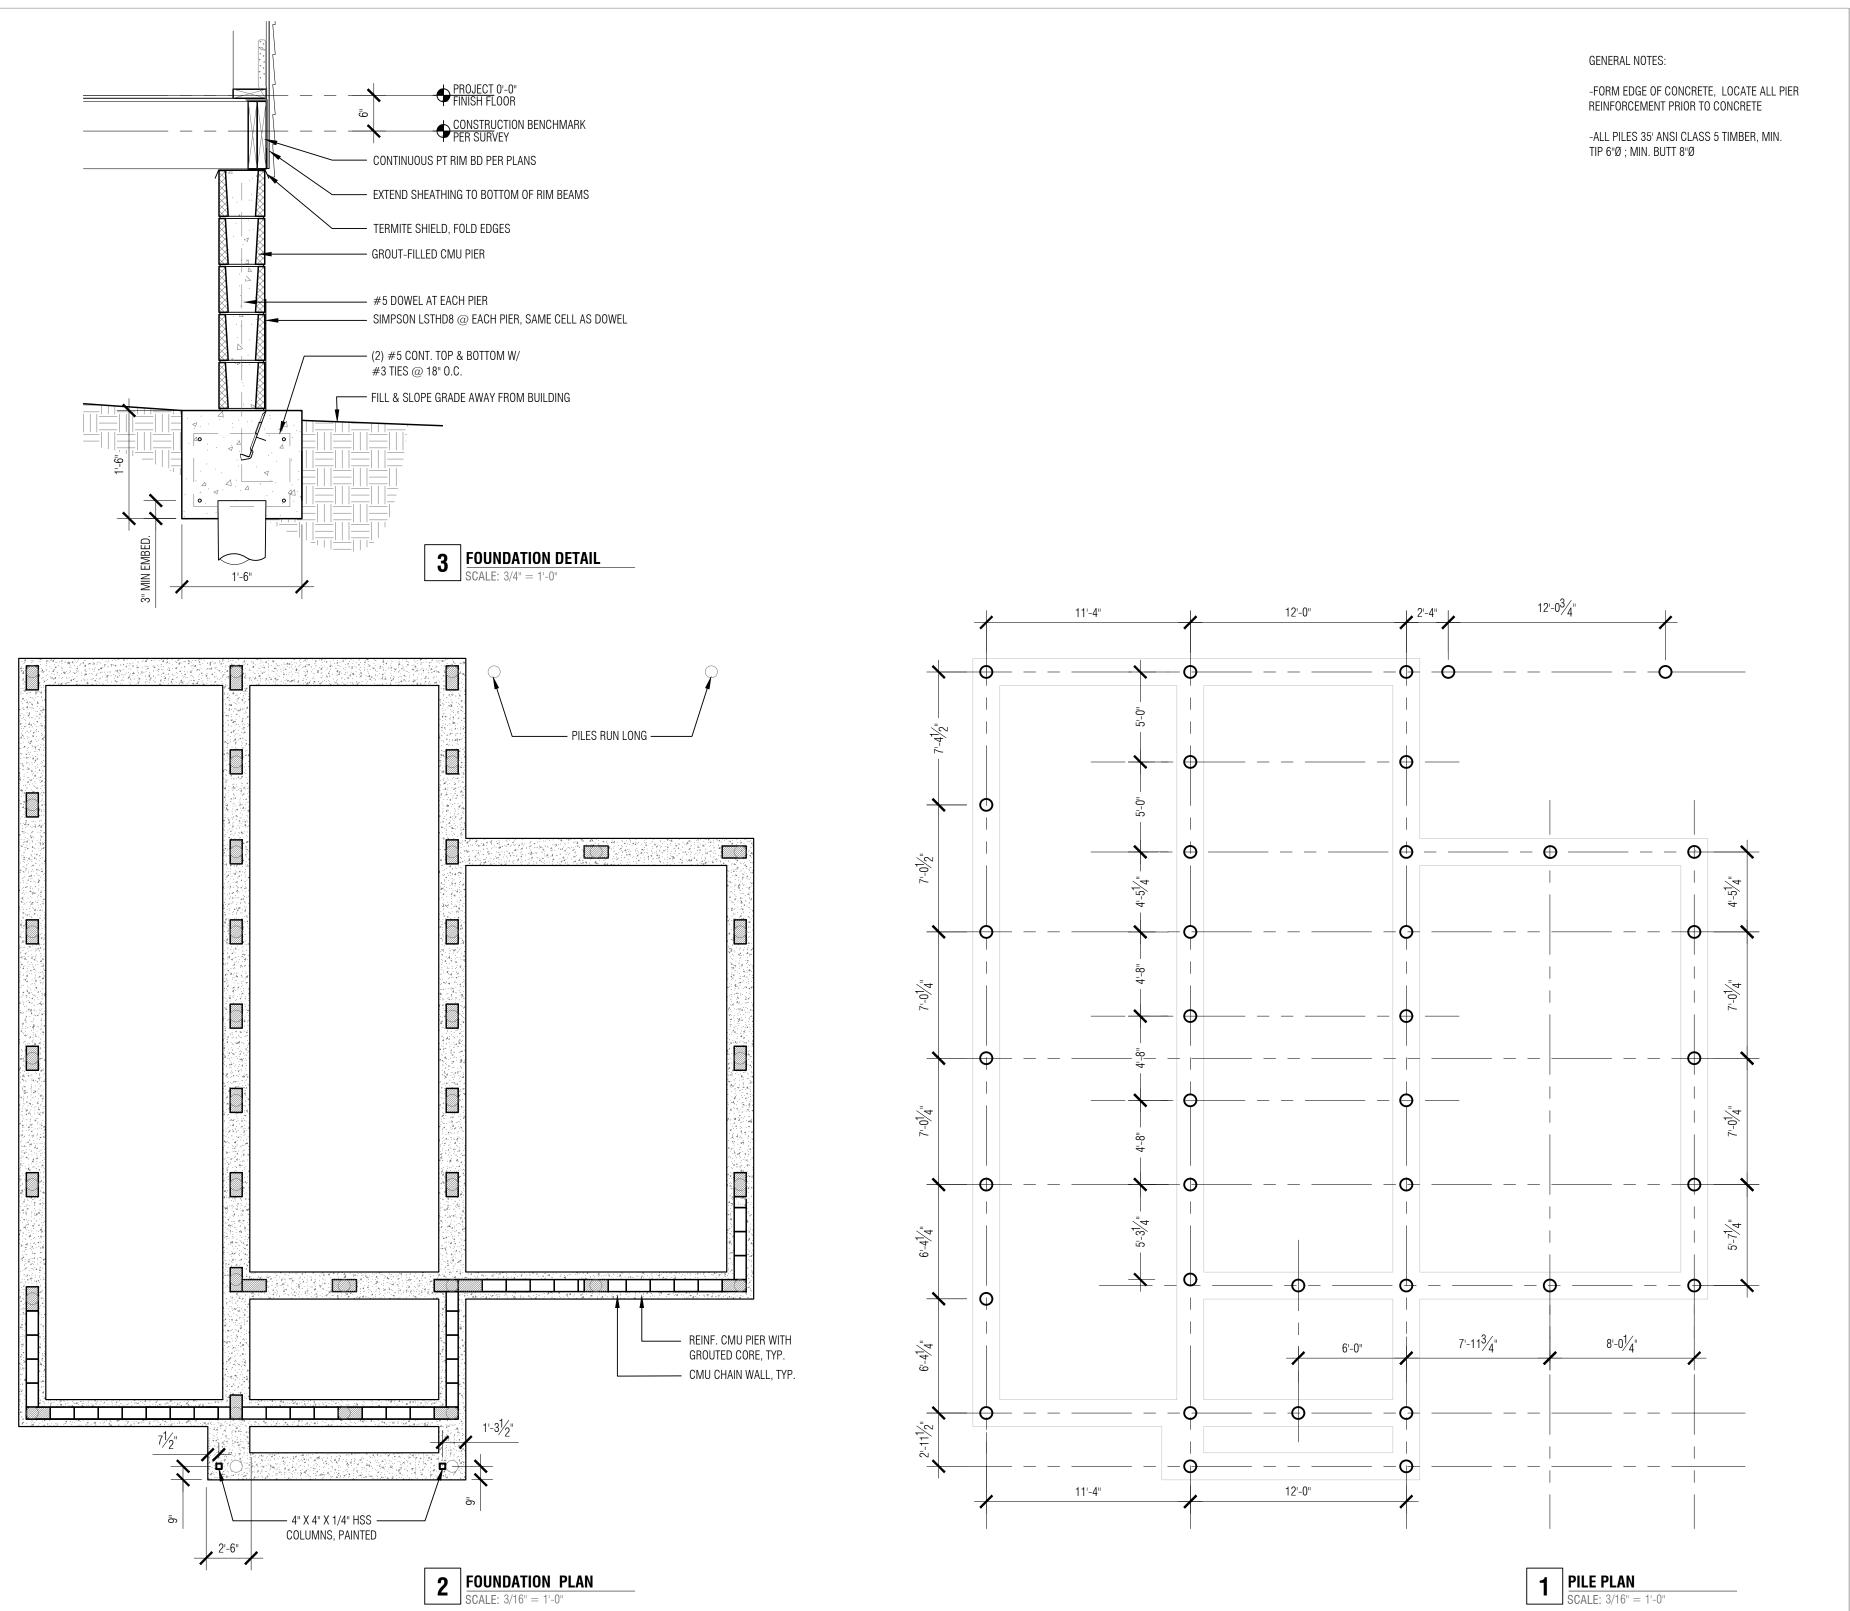
revisions:

2x6 EXTERIOR WALL

2x6 PARTITION WALL

2x4 PARTITION WALL

A2.1
BUILDING PLANS



3231 JACKSON AVENUE NEW ORLEANS, LA 70125

architect: **SARAH SATTERLEE** 9301 HOG EYE ROAD #536 AUSTIN, TX 76724




12 AUGUST 2022 PERMIT SET


drawn by: ae, ss checked by: ss sheet format: 18" x 24"

revisions:

A2.2
FOUNDATION PLAN

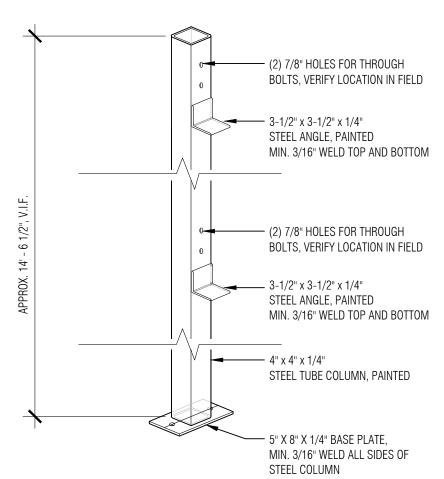


3 COLUMN DETAIL SCALE: 3/4" = 1'-0"

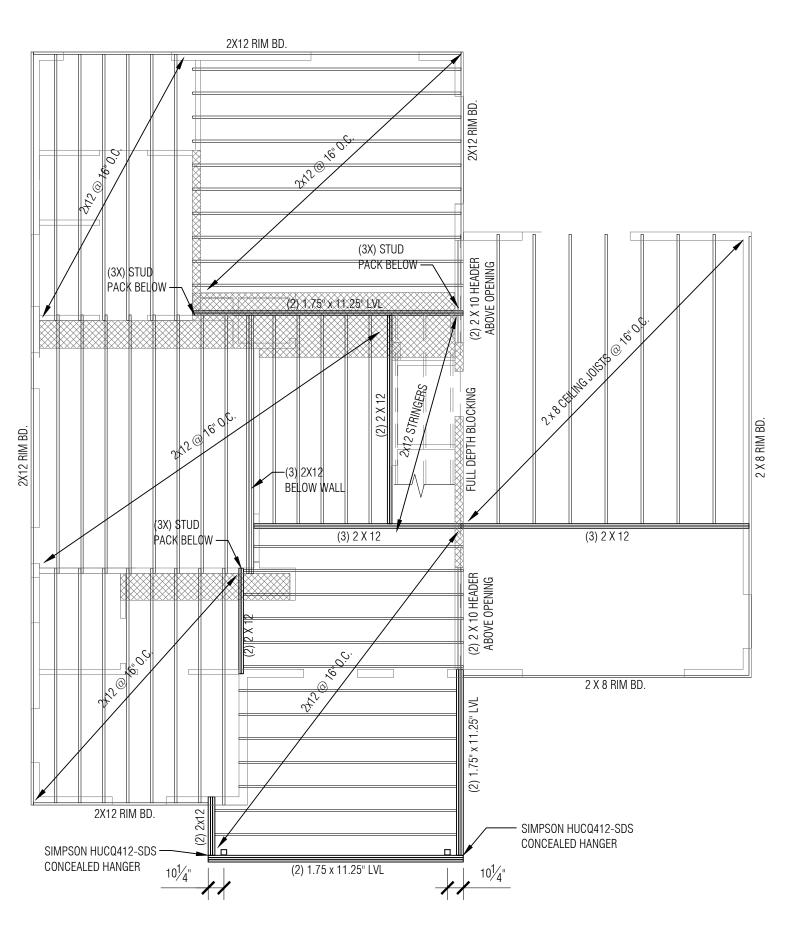



2 SECOND FLOOR FRAMING
SCALE: 3/16" = 1'-0"

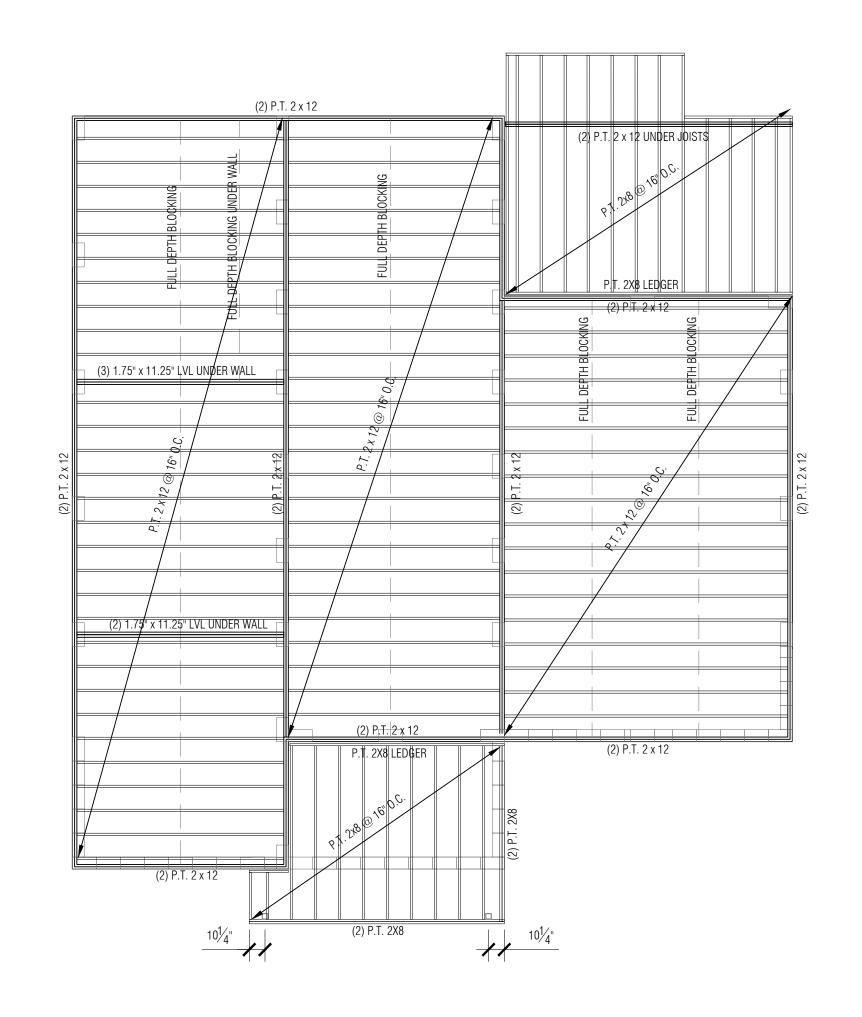

1 FLOOR FRAMING

GENERAL NOTES:

MAX

0.19" Ø)

-ALL FLOOR JOISTS TO BE BLOCKED AT 8'-0"

- ALL FASTENERS TO BE 8D (MIN. 0.131" Ø)

RING SHANK NAILS OR #10 SCREWS (MIN.

JACKSON AVENUE RESIDENCE

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SARAH SATTERLEE 9301 HOG EYE ROAD #536 AUSTIN, TX 76724



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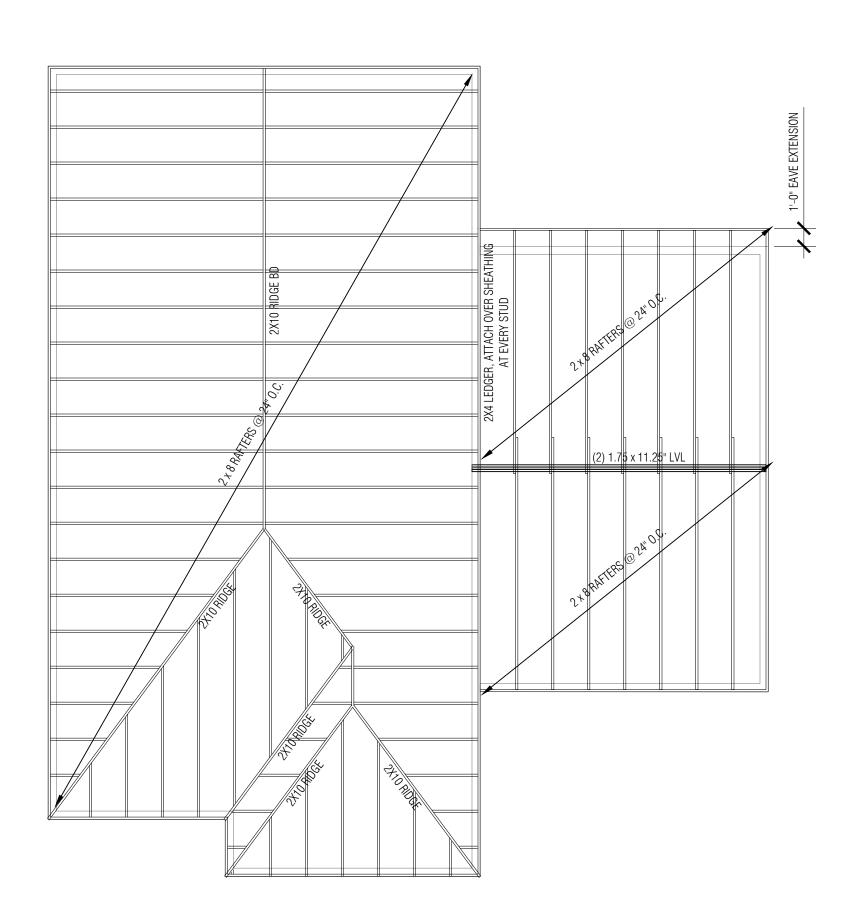
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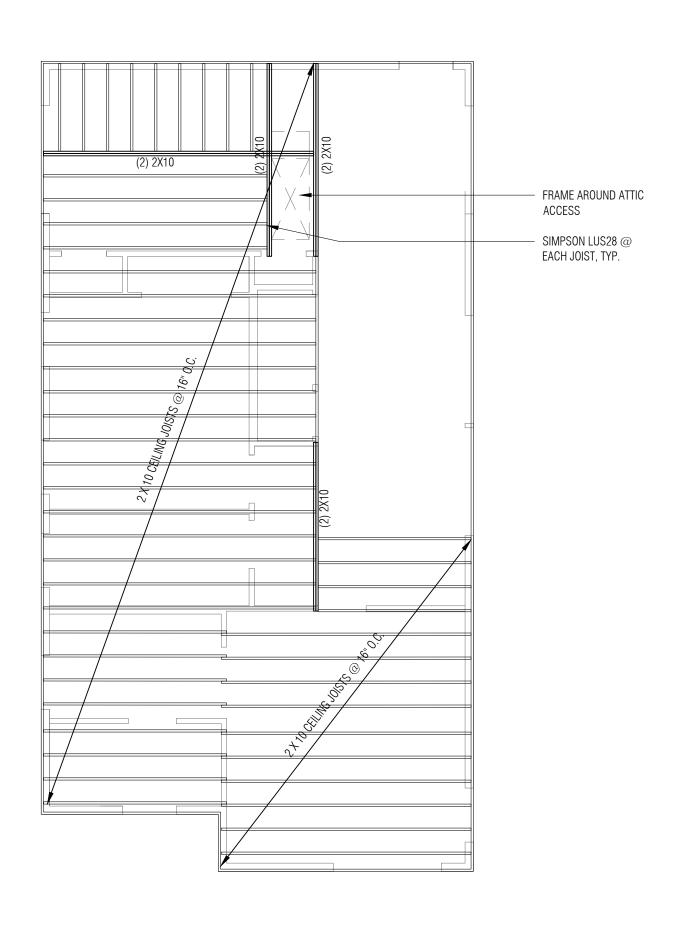
revisions:

A2.3
FRAMING PLANS

NOTES:

2X6 COLLAR TIE EACH RAFTER, (6) 16D NAILS EACH END





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RESIDENCE

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architect: **SARAH SATTERLEE** 9301 HOG EYE ROAD #536 AUSTIN, TX 76724



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revisions:

2 ROOF FRAMING
SCALE: 3/16" = 1'-0"

1 SECOND FLOOR CEILING FRAMING SCALE: 3/16" = 1'-0"

A2.4FRAMING PLANS



page size: 18" x 24". do not scale drawings.

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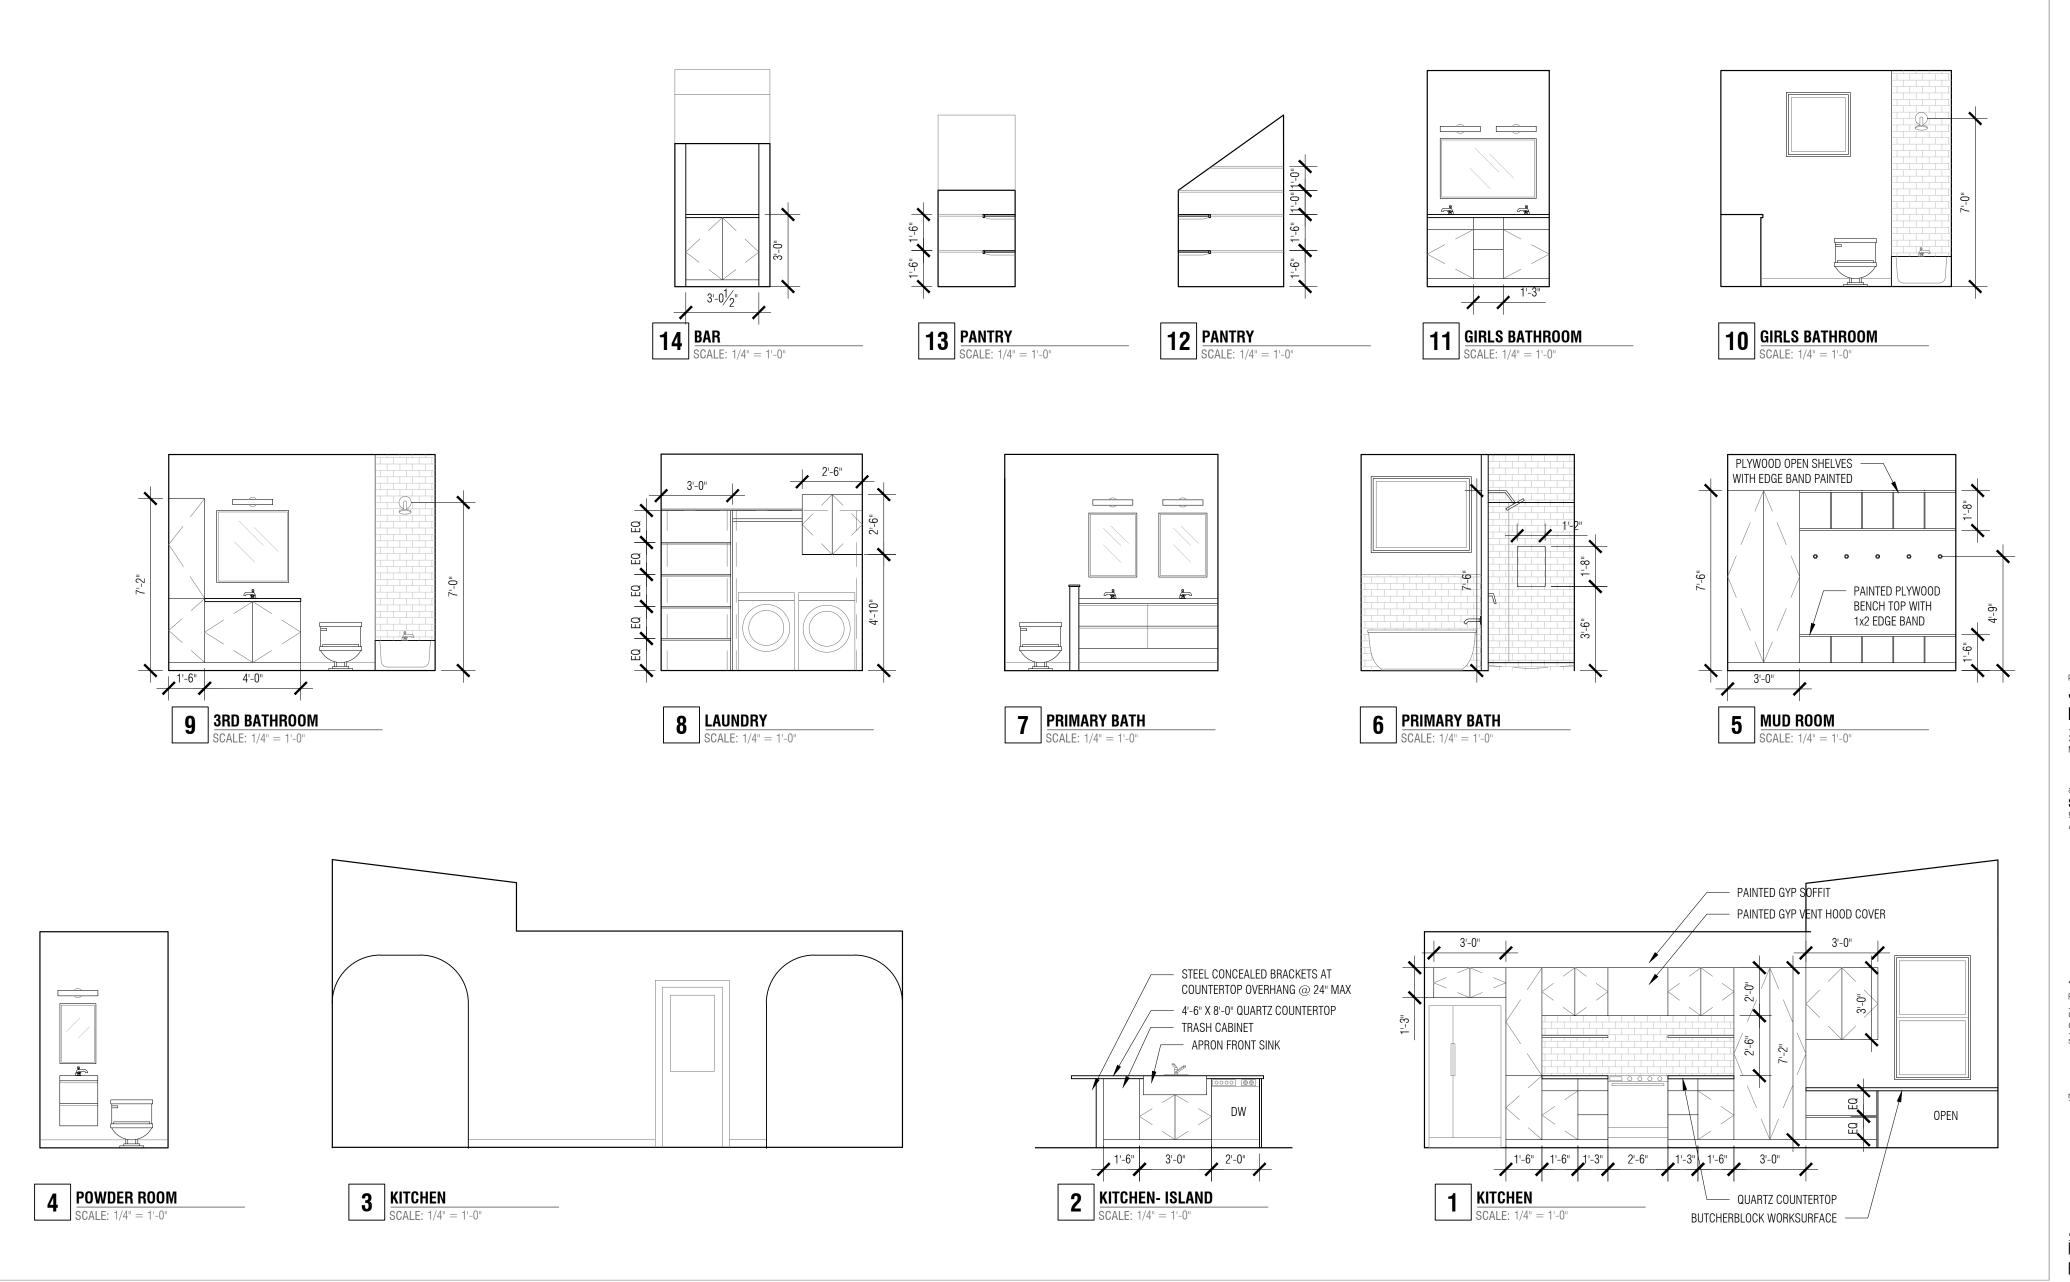
SARAH SATTERLEE 9301 HOG EYE ROAD #536 AUSTIN, TX 76724



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A3.0 ELEVATIONS



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architect: **SARAH SATTERLEE** 9301 HOG EYE ROAD #536 AUSTIN, TX 76724




12 AUGUST 2022 PERMIT SET


drawn by: ae, ss checked by: ss sheet format: 18" x 24"

revisions:


A3.2
INTERIOR
ELEVATIONS

page size: 18" x 24". do not scale drawings.

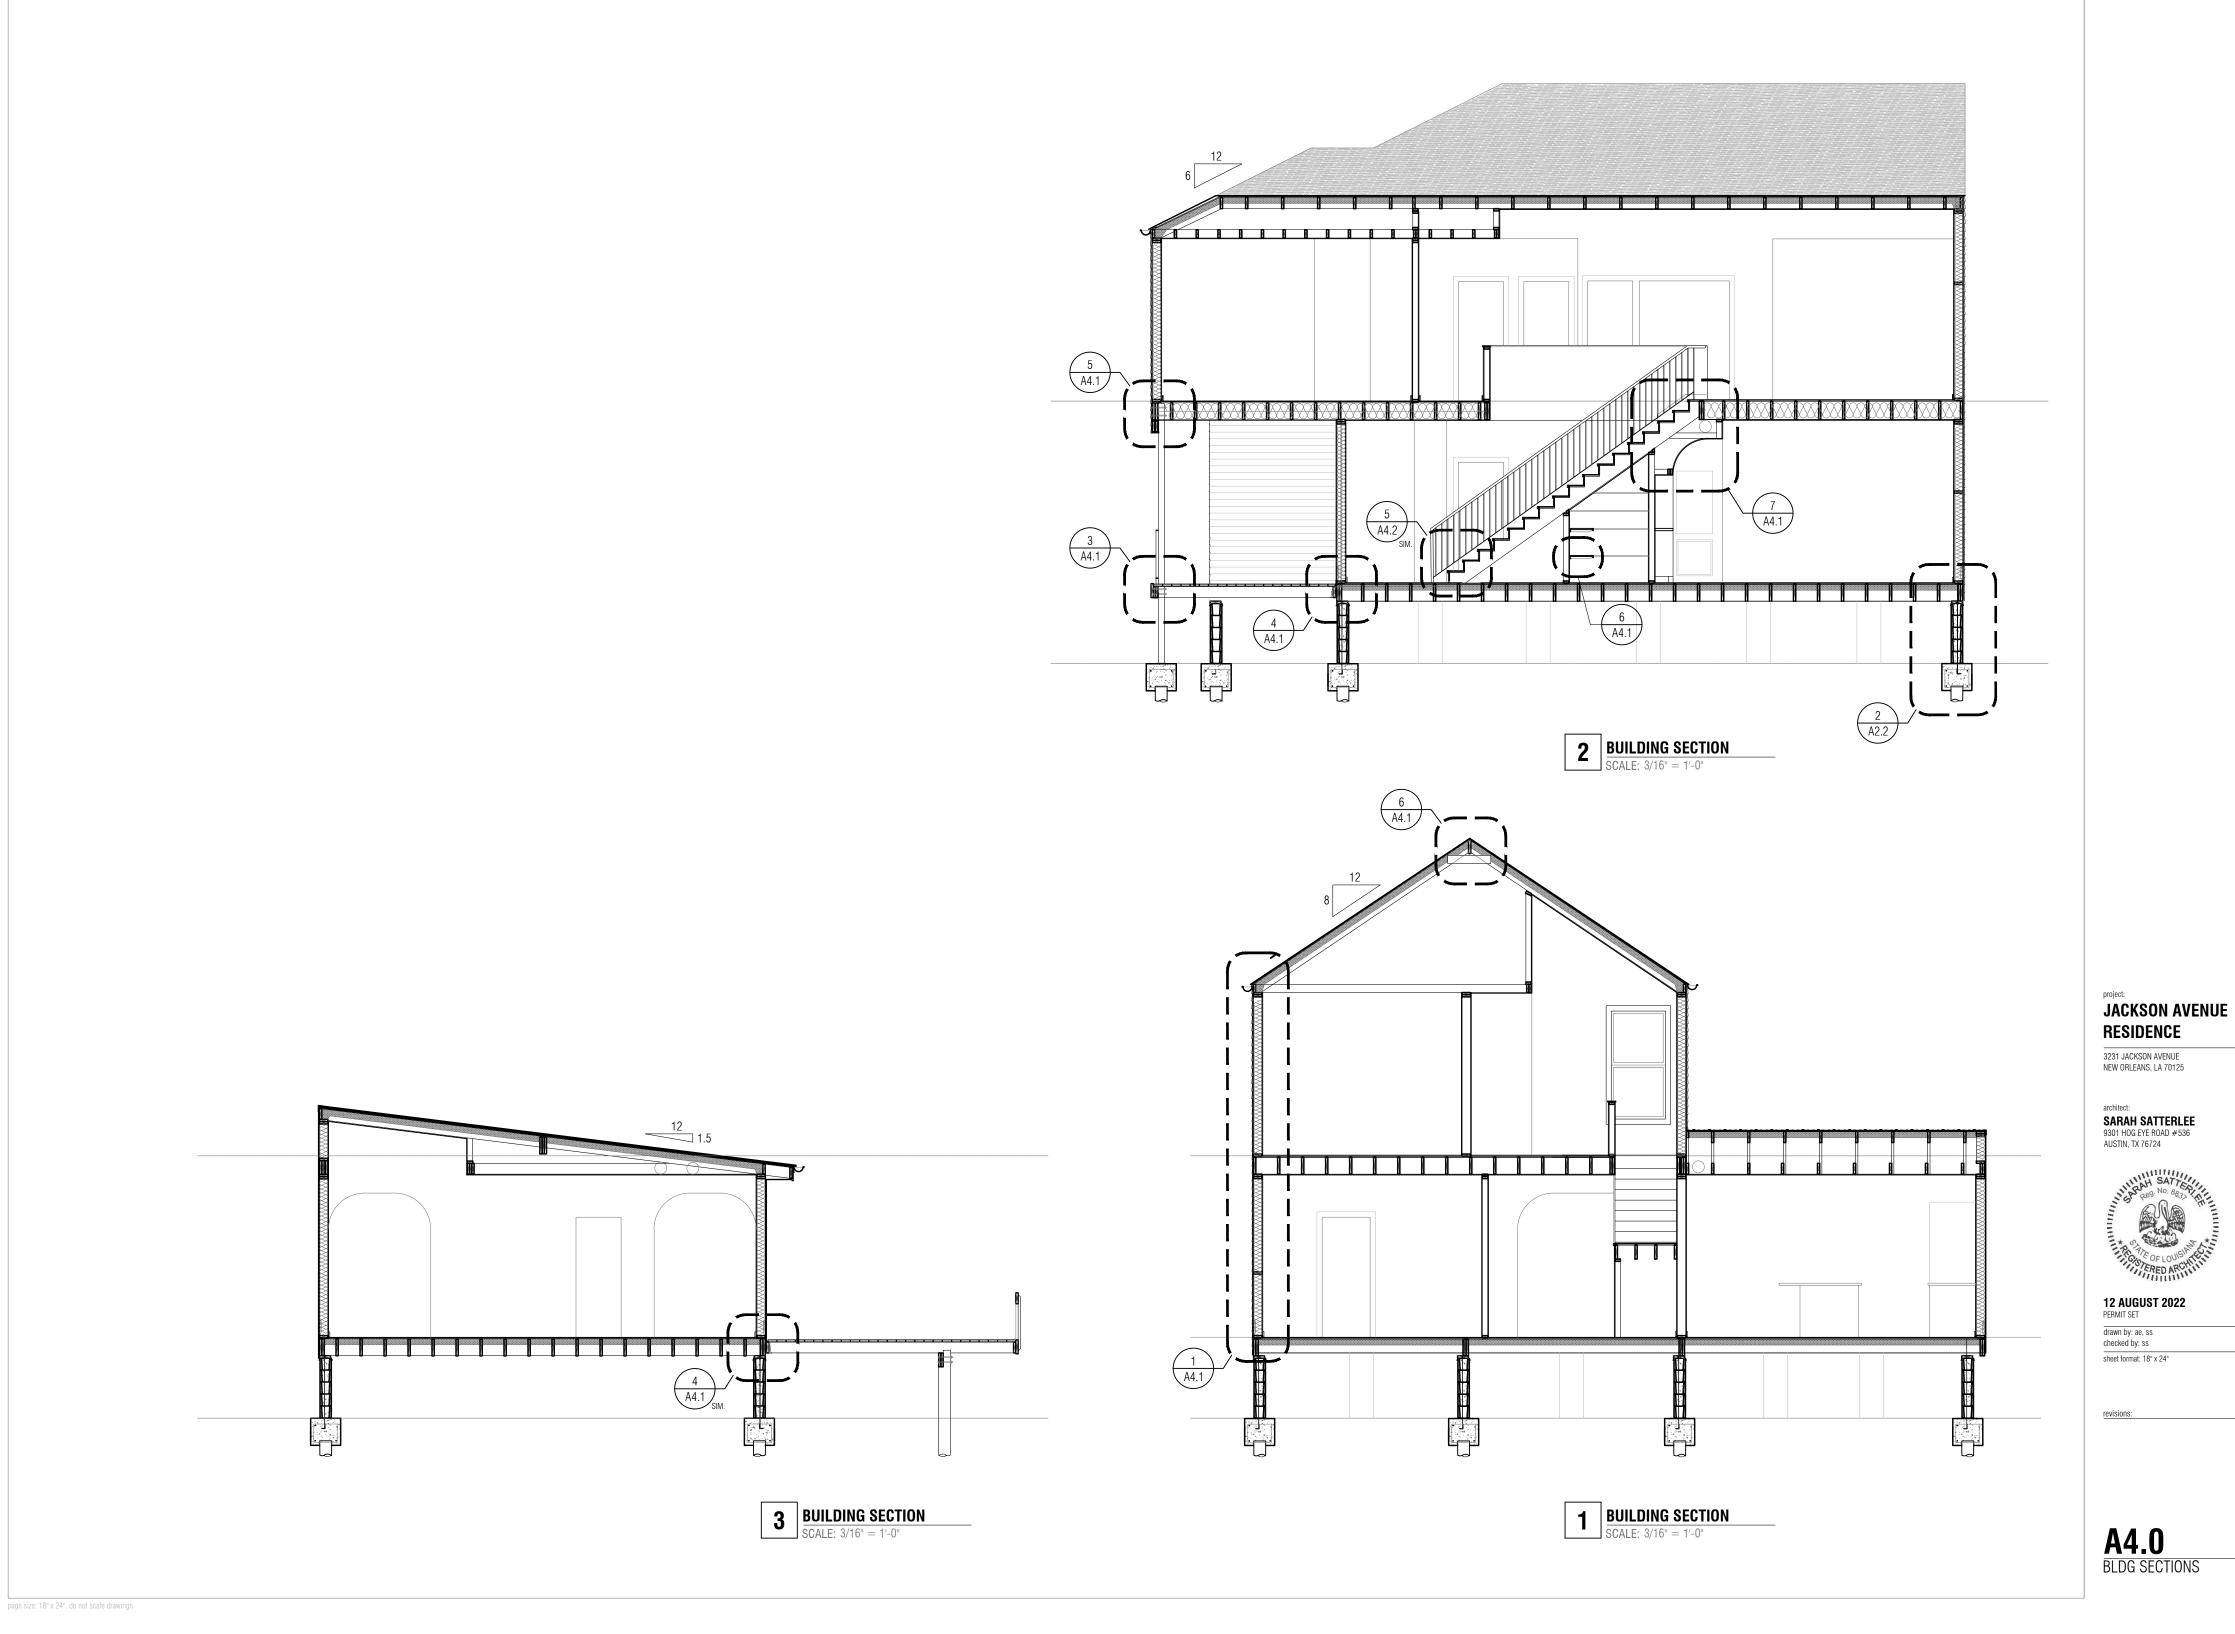

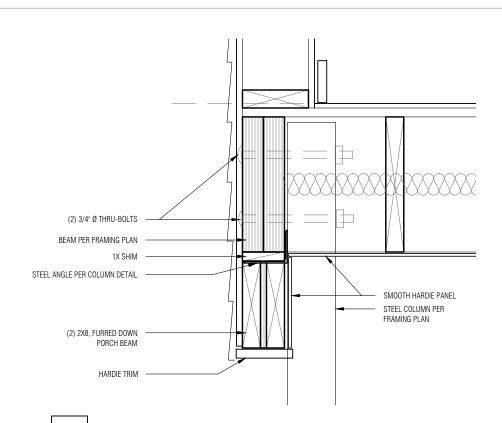


5 BEAM CONNECTION DETAIL SCALE: 1-1/2" = 1'-0"

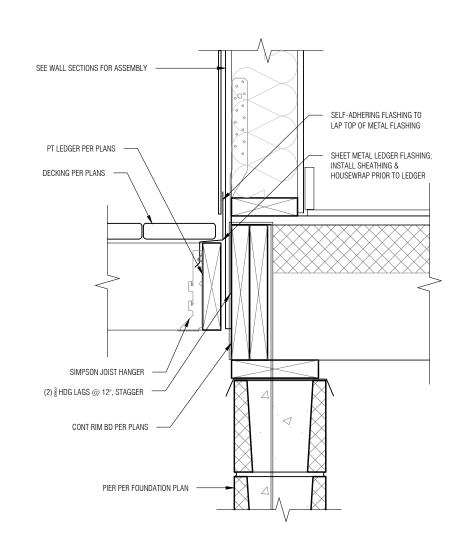

PORCH LEDGER DETAIL


SCALE: 1-1/2" = 1'-0"

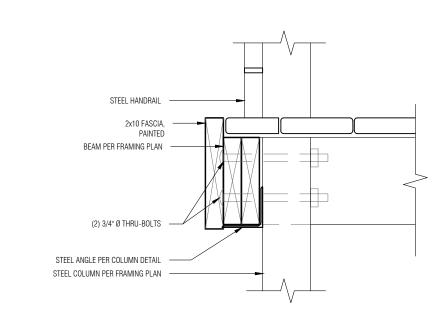

6 COLLAR TIE DETAIL
SCALE: 1-1/2" = 1'-0"

BEAM CONNECTION DETAIL
SCALE: 1-1/2" = 1'-0"

TYPICAL WALL SECTION
SCALE: 1" = 1'-0"

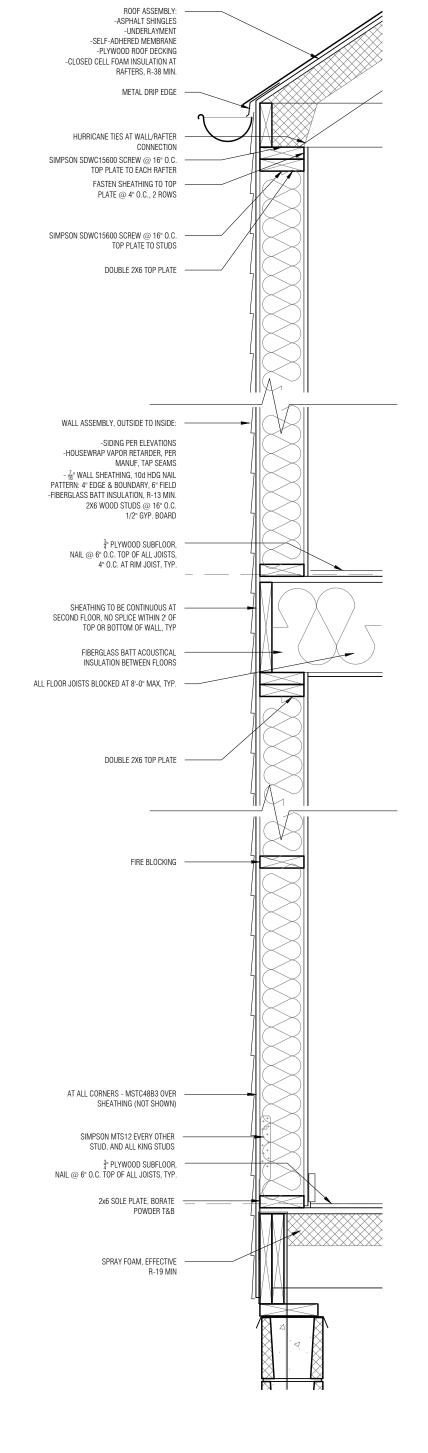

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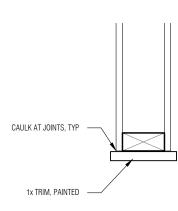
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revisions:


A4.1
WALL SECTIONS +
DETAILS


RIDGE BOARD RE: PLAN

2 X 6 COLLAR TIE EACH RAFTER PAIR W/ (6) 16 D NAILS EACH END




PLAN DETAIL: INTERIOR OPENING SCALE: 1 -1/2" = 1'-0"

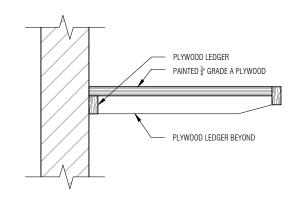

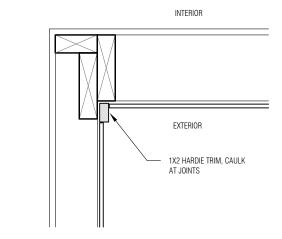


6 TYPICAL SHELF DETAIL
SCALE: 1-1/2" = 1'-0"



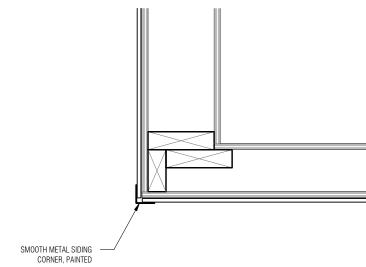


PLAN DETAIL: CORNER @ LAP SIDING

SCALE: 1 -1/2" = 1'-0"

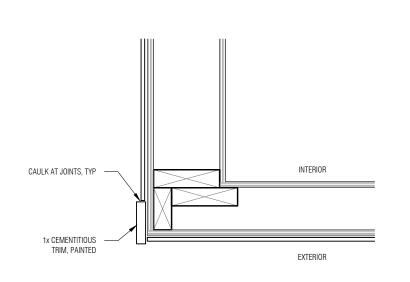


PLAN DETAIL: CORNER @ PANEL SIDING
SCALE: 1 -1/2" = 1'-0"

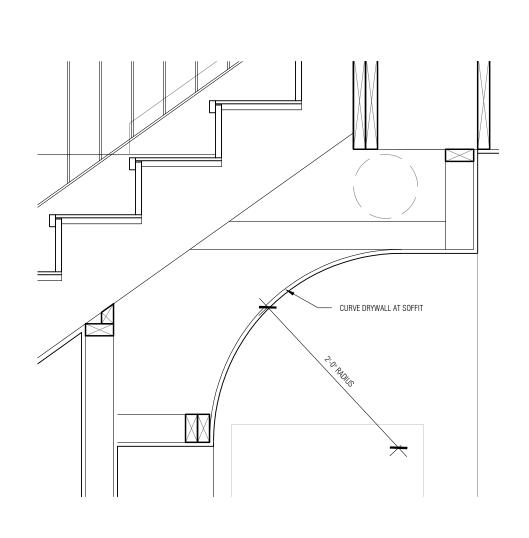

SOFFIT DETAIL
SCALE: 1" = 1'-0"

page size: 18" x 24". do not scale drawings.

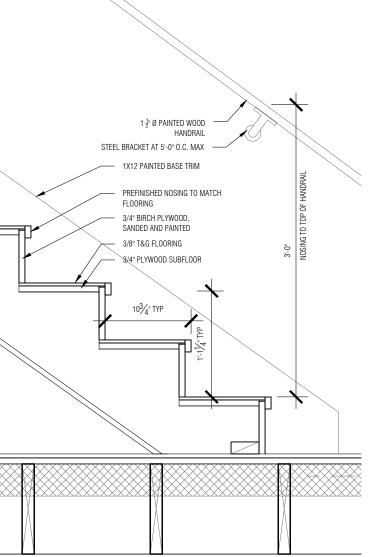

5 STAIR DETAIL
SCALE: 1" = 1'-0"

A4.2 DETAILS

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RESIDENCE

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revisions:


DOOR SCHEDULE

ALL HARDWARE TO BE BRUSHED NICKEL, LEVER TYPE

ALL DOORS TO HAVE PAINTED FINISH U.N.O.

NUMBER	SIZE		HADDWADE	ТҮРЕ	GLAZING	NOTES
NUMBEN	W	W H HARDWARE TYPE		GLAZING	NUIES	
1	3'-0"	8'-0"	ENTRY	SMOOTH FIBERGLASS	HALF LITE, FROSTED	-
2	6'-0"	8'-0"	ENTRY, PROVIDE 180° HINGES AND WALL STOPS	SMOOTH FIBERGLASS	FULL LITE	-
3	2'-8"	6'-8"	PRIVACY	SOLID FLUSH	-	-
4	2'-8"	6'-8"	PRIVACY	POCKET, SOLID FLUSH	-	ı
5	2'-8"	6'-8"	PASSAGE	POCKET, SOLID FLUSH	-	-
6	2'-8"	6'-8"	PRIVACY	SOLID FLUSH	-	-
7	2'-6"	6'-8"	PRIVACY	SOLID FLUSH	-	-
8	2'-6"	6'-8"	PASSAGE	SALVAGE WOOD	HALF LITE	-
9	5'-0"	6'-8"	PASSAGE	BIFOLD LOUVERED		
10	2'-6"	6'-8"	PASSAGE	BIFOLD LOUVERED		
11	2'-6"	6'-8"	PASSAGE	SOLID FLUSH -		-
12	2'-6"	6'-8"	PASSAGE	SOLID FLUSH	-	
13	5'-0"	6'-8"	PASSAGE	SOLID FLUSH		
14	2'-8"	6'-8"	PRIVACY	SOLID FLUSH	-	-
15	2'-8"	6'-8"	PRIVACY	SOLID FLUSH		
16	2'-8"	6'-8"	PRIVACY	SOLID FLUSH		
17	2'-8"	6'-8"	PRIVACY	POCKET, SOLID FLUSH -		-

WINDOW SCHEDULE							
ALL WINDOW HEAD HEAD HEIGHTS TO BE 8'-0" AFF, U.N.O.							
LETTED	SI	ZE	ТҮРЕ	HEIGHT		NOTES	
LETTER	W	Н		Н	J	NUTES	
А	3'-0"	5'-0"	SINGLE HUNG	_	-		
В	3'-0"	3'-0"	FIXED	_	-		
С	3'-0"	4'-0"	FIXED	-	-		
D	3'-0"	6'-0"	SINGLE HUNG	ı	-		
Е	6'-0"	2'-0"	FIXED	I	-		
F	3'-0"	2'-0"	FIXED	1	-		
G	4'-0"	2'-0"	FIXED	-	-		
Н	2'-0"	3'-0"	FIXED	-	-		
J	2'-0"	6'-0"	CASEMENT	-	-		

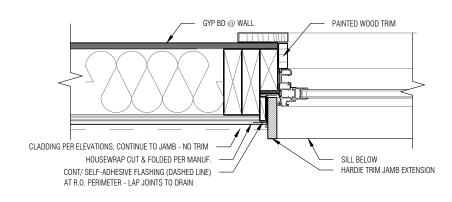



2 PLAN DETAIL - WINDOW JAMB
SCALE: 1-1/2" = 1'-0"

CLADDING PER ELEVATIONS; CONTINUE TO JAMB, NO TRIM

CAULKING AT JOINTS, TYP, UNO

SELF-ADHESIVE FLASHING TAPE @ FLASHING -

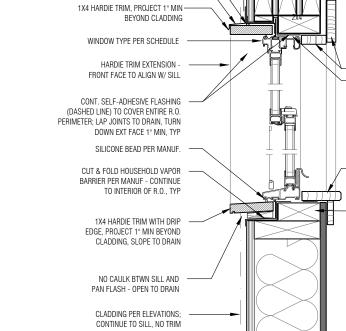

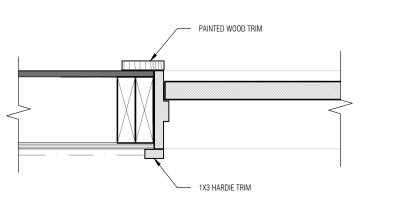

3 PLAN DETAIL - DOOR JAMB

SCALE: 1-1/2" = 1'-0"





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PAINTED WOOD TRIM

PAINTED WOOD SILL AND APRON

2X4 WINDOW LINER


LOW-EXPANSION SPRAY FOAM
 AT GAPS




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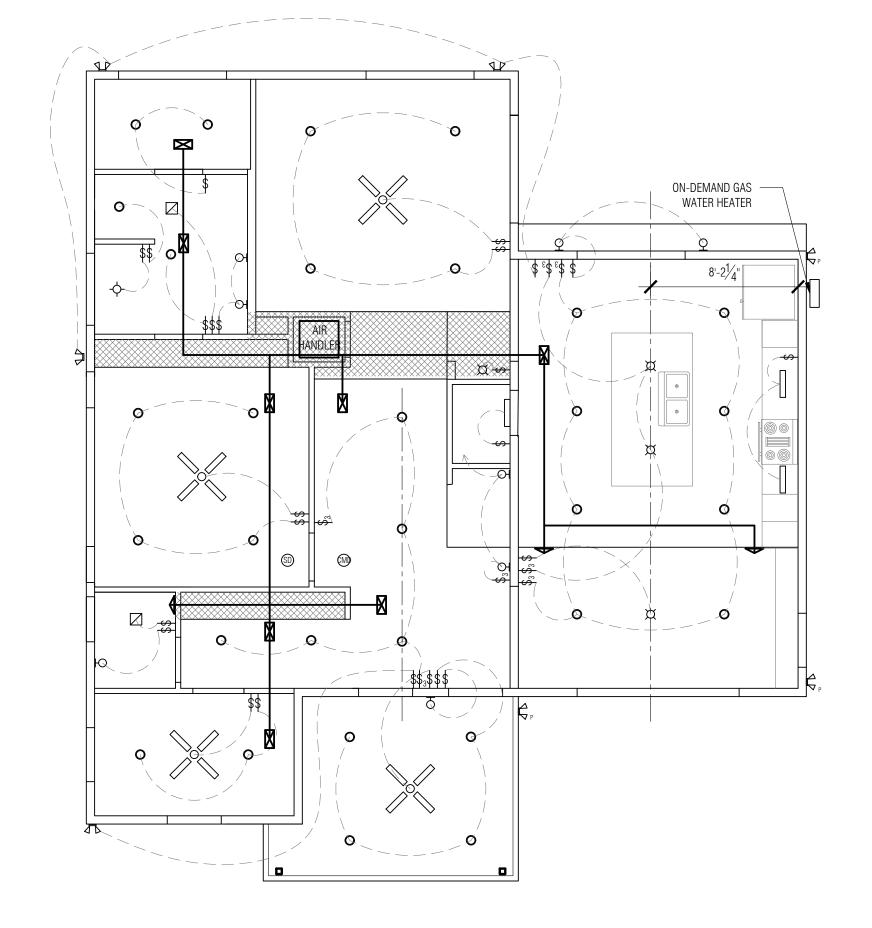
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A5.0 SCHEDULES



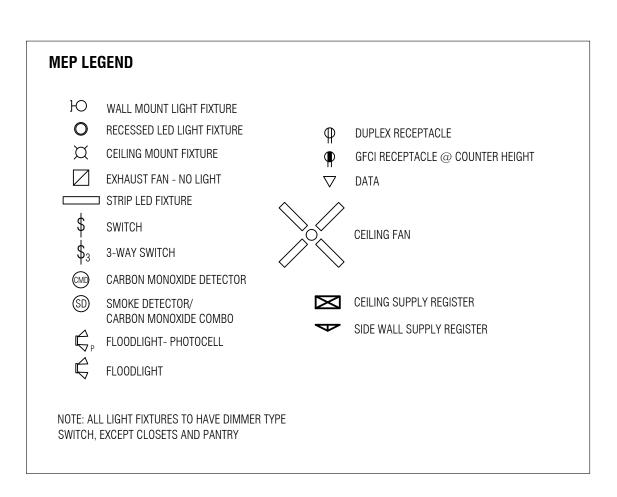

2 SECOND FLOOR REFLECTED CEILING PLAN

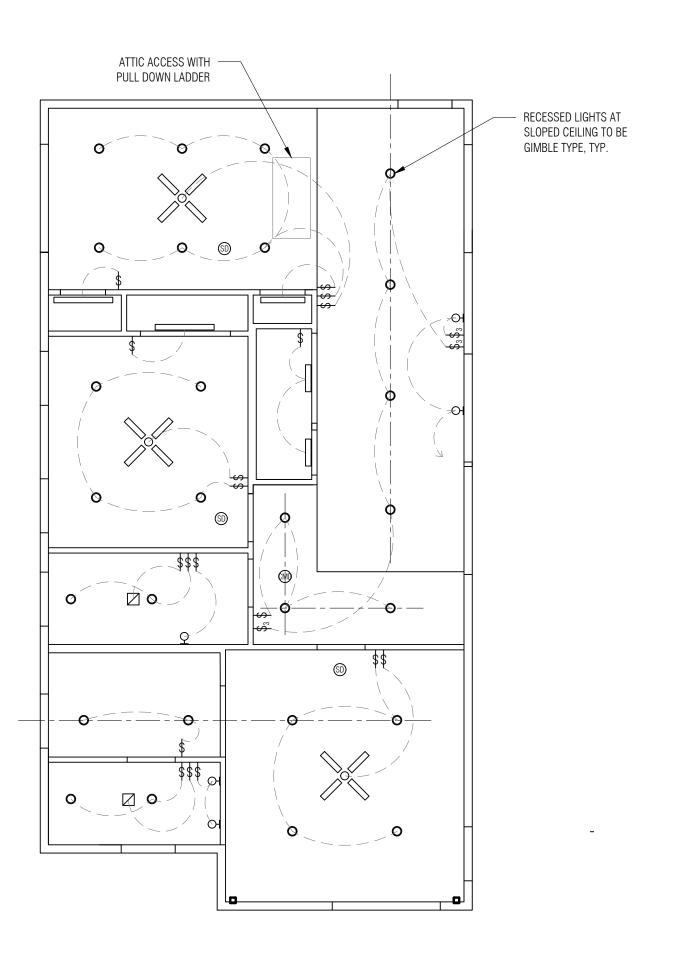

NOTES:

AT FURR DOWNS

-HVAC DUCT RUNS SHOWN FOR INFORMATION ONLY. FINAL HVAC TO BE

IN WALL BELOW AIR HANDLER

TO BE LOCATED IN ATTIC SPACE

DESIGN-BUILD BY HVAC SUPPLIER

-DUCT RUN ASSUMED TO RUN THROUGH

FLOOR FRAMING AND CHANGE DIRECTIONS

-FIRST FLOOR HVAC RETURN TO BE LOCATED

-SECOND FLOOR AIR HANDLER AND DUCTS

1 FIRST FLOOR REFLECTED CEILING PLAN

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RESIDENCE

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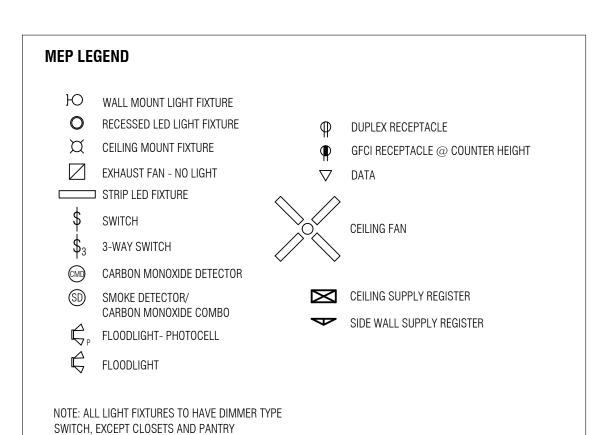



12 AUGUST 2022 PERMIT SET

drawn by: ae, ss checked by: ss sheet format: 18" x 24"


revisions:

A6.0 MEP PLANS



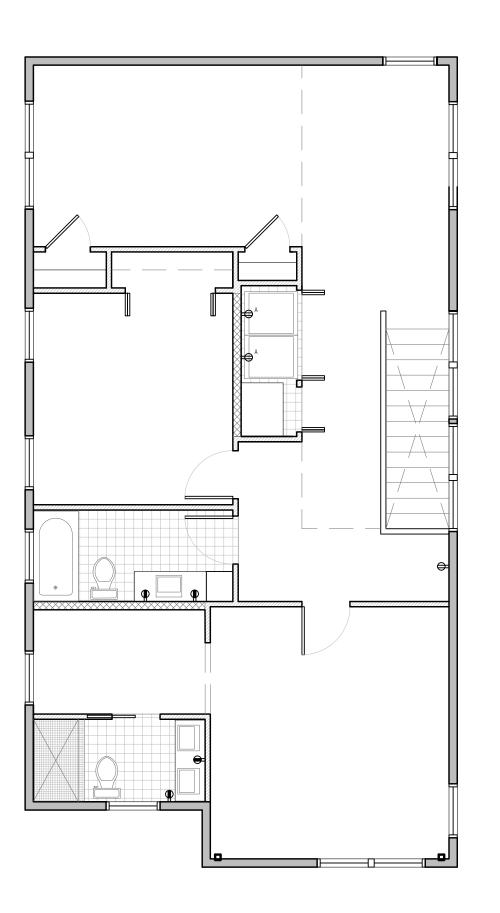

2 SECOND FLOOR POWER PLAN
SCALE: 3/16" = 1'-0"

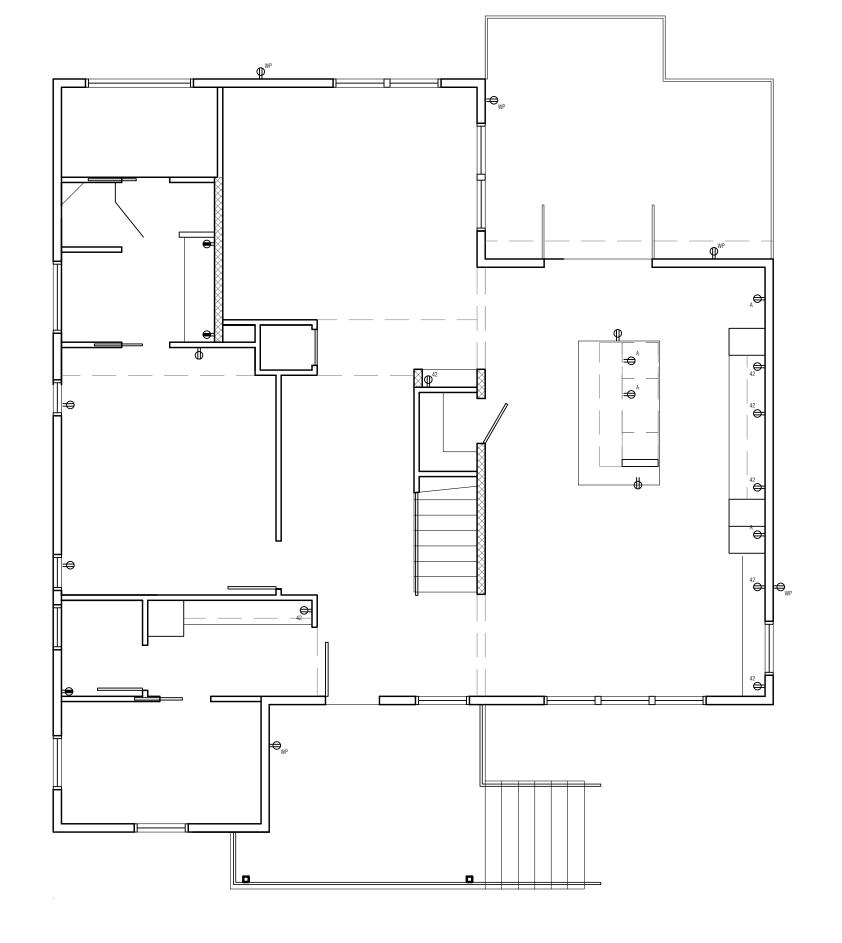

FIRST FLOOR POWER PLAN
SCALE: 3/16" = 1'-0"

-RECEPTACLES SHOWN ARE MINIMUM REQUIRED. G.C. TO PROVIDE ADDITIONAL RECEPTACLES PER CODE

NOTES:

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revisions:

A6.1
POWER PLANS