

### CONTRACTOR AND MAJOR SUBCONTRACTORS ARE TO FAMILIARIZE THEMSELVES WITH THE CONSTRUCTION SITE AND VERIFY LOCATIONS OF ALL UTILITIES PRIOR TO

CONTRACTOR SHALL VERIFY ALL CONDITIONS AND DIMENSIONS AT JOB SITE PRIOR TO COMMENCING WORK AND REPORT ANY DISCREPANCIES TO THE ARCHITECT AND THE OWNER. IN ADDITION REVIEW CAREFULLY ALL CONDITIONS AND SYSTEMS AND FAMILIARIZE HIMSELF WITH ALL ASPECTS OF THE REQUIRED WORK FOR A COMPLETE INSTALLATION. ALL DEVIATION OR CHANGES NECESSARY TO ACHIEVE THE INSTALLATIONS SHOWN SHALL BE CALLED TO THE ATTENTION OF THE ARCHITECT OR OWNER PRIOR TO SUBMITTING FINAL PRICE TO MAKE NECESSARY ADJUSTMENTS SO AS TO AVOID ANY EXTRA COSTS DURING CONSTRUCTION.

ACCUMULATION OF DEMOLITION DEBRIS, WASTE MATERIALS OR RUBBISH CAUSED BY HIS OPERATION AND SHALL REMOVE NO LESS THAN WEEKLY ALL DEBRIS FROM AND ABOUT THE PROJECT. ALL WASTE SHALL BE SEPARATED BY TYPE OF MATERIAL FOR RECYCLING. CONTRACTOR SHALL COORDINATE CONSTRUCTION LIMITS,

REGULATIONS AND AGENCIES. NO WORK SHALL BE CONCEALED UNTIL APPROVED BY LOCAL INSPECTORS. CONTRACTOR SHALL ENSURE ALL MATERIALS AND WORK

CONSTRUCTION AS NECESSARY TO PROTECT THE PUBLIC FROM INJURY AND

DO NOT SCALE DRAWINGS. IF DIMENSIONS ARE IN QUESTION THE CONTRACTOR SHALL BE RESPONSIBLE FOR OBTAINING CLARIFICATION FROM THE ARCHITECT

PERIMETER DIMENSIONS ARE TO BE FROM FINISH FACE TO FINISH FACE UNLESS

ALL RATED PARTITIONS SHALL BE TIGHTLY SEALED TO THE UNDERSIDE OF STRUCTURE. INTEGRITY OF ONE-HOUR RATED PARTITIONS AND SMOKE PARTITIONS SHALL BE MAINTAINED AT CORNERS AND AT INTERSECTIONS OF OTHER PARTITION

THICKNESS GREATER THAN 4 INCHES ARE TO BE CONSTRUCTED OF 6" STUDS WITH ONE LAYER OF 5/8" TYPE X DRYWALL ON BOTH SIDES. PROVIDE METAL OR DRYWALL CROSS BRACES AS REQUIRED TO MAINTAIN THE REQUIRED FIRE RATING OF THE CONSTRUCTION. HOLD CHASE WALLS TO MINIMUM DIMENSIONS. VERTICAL PIPING LOCATED WITHIN THE STUD SPACE OF PARTITIONS SHALL BE COMPLETELY ENCLOSED WITH FULL THICKNESS OF DRYWALL ON EACH SIDE OF STUD.

RECESSES FOR ELECTRICAL PANELS, FIRE EXTINGUISHER CABNETS, ANNUNCIATOR BOXES, ETC., LOCATED IN RATED PARTITIONS SHALL BE FACED WITH DRYWALL TO CREATE A FIVE SIDED ENCLOSURE AS REQUIRED TO RETAIN RATING OF WALL.

ALL WALLS AND FLOOR OPENINGS SHALL BE FIRESTOPPED WITH AN APPROVED NON-COMBUSTIBLE MATERIAL MECHANICALLY FASTENED INPLACE TO PROVIDE AN EFFECTIVE AND APPROVED FIRE STOP. OPENING IN SLABS AND PARTITIONS FOR CONDUIT, PIPING AND OTHER ITEMS SHALL BE FILLED WITH N APPROVED NON-COMBUSTIBLE MATERIAL TO PROVIDE AN APPROVED SEAL TO PROHIBIT THE

PROVIDE 6 INCH STUDS BEHIND SINKS, AND WHERE NOTED OR OTHERWISE REQUIRED TO CONCEAL PIPING AND OTHER ITEMS OCCURING WITHIN PARTITIONS. NAILERS, BLOCKING AND OTHER ROUGH CARPENTRY ITEMS INDICARED AS "WOOD", "P.T. WOOD", OR "TREATED WOOD" SHALL BE TREATED FOR WATER RESISTANCE. THE CONTRACTOR AND SUBCONTRACTORS ARE TO FAMILIARIZE THEMSELVES WITH THE FOLLOWING ABBREVIATIONS AND THE STANDARD ABBREVIATIONS WHICH MAY

- FACE OF SHEATHING

- FACE OF CONCRETE (MASONRY)

- UNLESS NOTED OTHERWISE - TOP OF FINISH FLOOR

SPECIFIED MATERIALS OR PRODUCTS CALLED FOR OR SHOWN ON THE DRAWINGS OR IN THE SPECIFICATIONS, SHALL BE SUBMITTED TO THE OWNER IN WRITING FOR A WRITTEN APPROVAL BY THE OWNER, SHALL BE RECIEVED AT THE OWNER'S OFFICE TEN (10) BUSINESS DAYS PRIOR TO THE SPECIFIED BID DATE. ANY BID BASED UPON OR CONTAINING AN UNAPPROVED PRODUCT OR MATERIAL SUBSTITUTION MAY BE

DO NOT SUBSTITUTE MATERIALS, PRODUCTS OR EQUIPMENT UNLESS SUCH SUBSTITUTION HAVE BEEN "SPECIFICALLY APPROVED IN WRITING" FOR THIS WORK

WHERE THE PHRASE "OR EQUAL" OR "AS APPROVED BY THE ARCHITECT" OCCURS IN THE CONTRACT DOCUMENTS, DO NOT ASSUME THAT MATERIALS, PRODUCTS OR SPECIFICALLY APPROVED IN WRITING FOR THIS WORK BY THE ARCHITECT. THE DECISION OF THE OWNER SHALL BE FINAL IN RELATION TO SUBSTITUTIONS.

ANY SUBSTITUTIONS FOR SPECIFIED MATERIALS CALLED FOR ON THE DRAWINGS OR SPECIFICATIONS, SHALL BE SUBMITTED TO THE OWNER IN WRITING FOR A WRITTEN


DIMENSIONS, ALIGNMENTS, DETAILS AND FLOOR PLAN DIMENSIONS SHOWN ON THESE DOCUMENTS ARE BASED UPON AN ASSUMED MANUFACTURER'S STANDARD DETAILS. IF A MANUFACTURER IS SUBSTITUTED AND/OR "APPROVED AS EQUAL" BY THE ARCHITECT AS SPECIFIED IN THE "BIDDING REQUIREMENTS": THEN IT WILL BE THE RESPONSIBILITY OF THE GENERAL CONTRACTOR TO RECOORDINATE THE DIMENSIONAL AND DETAIL REQUIREMENTS OF THE SUBSTITUTED MANUFACTUER TO THE REQUIRMENTS OF THIS PROJECT AND/OR TO ENGAGE THE ARCHITECT TO REVISE AND RECOORDINATE THE CONTRACT DOCUMENTS AS MAY BE REQUIRED.

CONTRACTOR TO COORDINATE ALL FINISHES WITH OWNER AND ARCHITECT OF CONTRACTOR TO PROVIDE BLOCKING FOR ALL CABINETS AND CASEWORK. PROVIDE BLOCKING FOR ALL SURFACE MOUNTED, SEMI-RECESSED OR RECESSED ITEMS SUCH AS ACCESSORIES, GRAB-BARS, CLOSET RODS AND SHELVES, DRAPERY

CONTRACTOR SHALL BE RESPONSIBLE FOR THE COORDINATION OF MECHANICAL ELECTRICAL, PLUMBING, ETC WORK SO THAT THE WORK IN THE FIELD WILL ACHIEVE

RATED WALLS AND/OR FLOOR-CEILING ASSEMBLIES WITH FIRE SEALANT AND/OR INTUMECENT PIPE WRAPS. INTUMESCENT PIPE WRAPS TO BE USED AT ALL

ALL WALL AND FLOOR ASSEMBLIES MUST MEET THE REQUIREMENTS OF THE U.L.

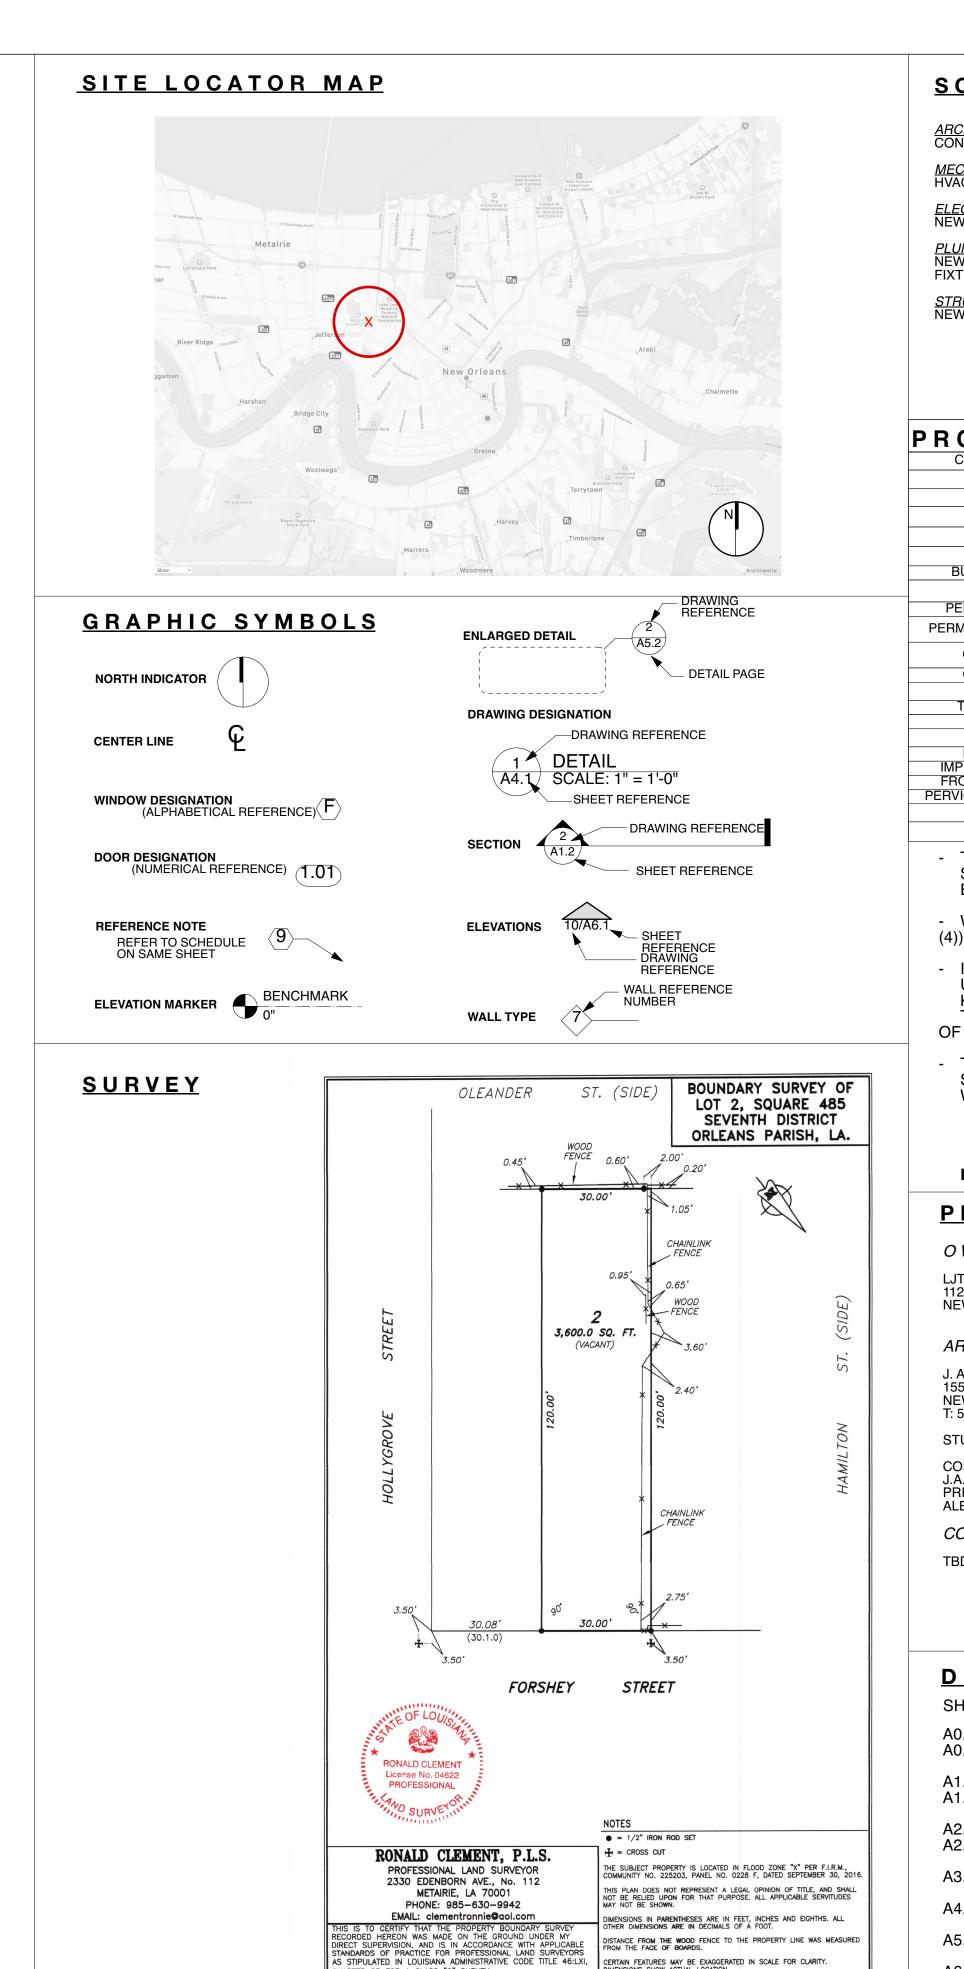

HAPTER 25 FOR A CLASS "C" SURVEY.

DRAWN BY: RGC

SCALE: 1'' = 20'

REPARED AT THE REQUEST OF

REGISTRATION No. 4622

HAIS SANTOS

### SCOPE OF WORK

<u>ARCHITECTURAL</u> CONSTRUCTION OF A NEW TWO STORY DUPLEX RESIDENCE.

<u>MECHANICAL</u> HVAC SYSTEM TO BE INSTALLED PER PER APPLICABLE CODES.

NEW ELECTRICAL SYSTEM TO BE INSTALLED PER PLANS PER APPLICABLE CODES.

NEW PLUMBING SUPPLY AND DRAIN LINES TO BE INSTALLED PER APPLICABLE CODES. FIXTURES TO BE INSTALLED PER PLANS.

STRUCTURAL NEW FRAMING AND FOUNDAITON PER PLANS

### PROJECTINFORMATION CONSTRUCTION OF A TWO FAMILY RESIDENCE CLASSIFICATION OF WORK

| CLASSIFICATION OF WORK    |     | CONSTRUCT  |    | A TWO FAIVILT RESIDENCE      |
|---------------------------|-----|------------|----|------------------------------|
|                           |     |            |    |                              |
| ZONING:                   |     | HU-RD2     |    | PER http://property.nola.gov |
|                           |     |            |    |                              |
| LOT AREA                  |     | 3600       | SF |                              |
|                           |     |            |    |                              |
| BUILDING FOOTPRINT AREA   |     | 2237       | SF |                              |
| PAVED AREA                |     | 96         | SF |                              |
| 'ERMEABLE LOT AREA REQ'D  | 30% | 1080       | SF |                              |
| RMEABLE LOT AREA PROPOSED |     | 1267       | SF |                              |
| OPEN SPACE REQUIRED       | 30% | 1080       | SF |                              |
| OPEN SPACE PROVIDED       |     | 1363       | SF |                              |
| TOTAL OCCUPANCY AREA      |     | 00000      | SF |                              |
|                           |     | 2066       | SF |                              |
| AREA UNDER BEAM           |     | 2237       | ЪГ |                              |
| FRONT YARD PROVIDED       |     | 258        | SF | BLOCK AVG. = 7'              |
| IPERVIOUS FRONT YARD MAX  | 40% | 103        | SF |                              |
| RONT /CORNER YARD PAVING  |     | 48         | SF |                              |
| VIOUS FRONT YARD PROPOSED |     | 210        | SF |                              |
|                           |     |            |    |                              |
| BUILDING HEIGHT           |     | 18'-7 3/4" |    | SEE A4.1                     |

THESE DRAWINGS HAVE BEEN PREPARED TO MEET THE DESIGN SPECIFICATIONS OF THE INTERNATIONAL RESIDENTIAL CODE 2015 EDITION.

- WIND LOADS = 130 MPH. BASIC WIND SPEED EXPOSURE "B" (R301.2 (4))

- I HAVE RESEARCHED THIS CHAPTER AND THE LOUISIANA STATE UNIFORM CONSTRUCTION CODE AND TO THE BEST OF MY KNOWLEDGE AND BELIEF THESE DRAWINGS ARE IN COMPLIANCE THEREWITH. I TAKE FULL RESPONSIBILITY FOR THE CONTENTS OF THESE PLANS.

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CERTAIN FEATURES MAY BE EXAGGERATED IN SCALE FOR CLARITY. DIMENSIONS SHOW ACTUAL LOCATION.

SURVEYED IN ACCORDANCE WITH THE STANDARDS OF PRACTICE FOR PROPERTY BOUNDARY SURVEYS FOR A CLASS "C" SURVEY.

 SCALE: 1" = 20'
 ANGLES ARE BASED UPON A PLAN OF SURVEY OF LOT 10. SQUARE 485.

 DATE: FEBRUARY 22, 2022
 SEVENTH DISTRICT, ORLEANS PARISH, LA BY GILBERT, KELLY & COUTURE',

 PROJECT No. 22-011
 INC. DATED OCTOBER 10, 2006.

| THESE PLANS HAVE BEEN PREPARED UNDER MY DIRECT<br>SUPERVISION AND TO THE BEST OF MY KNOWLEDGE CON<br>WITH THE INTERNATIONAL BUILDING CODE.  | APLY BOOS  |
|---|--|
| I WILL <del>/ WILL NO</del> T OBSERVE THE WORK.   |  |
| DUNNER<br>JT INVESTMENTS LLC<br>1227 MIDPOINT DRIVE<br>NEW ORLEANS, LA 70128<br>ARCHITECT OF RECORD<br>A. MODINGER ARCHITECT, LLC<br>558 ANNUNCIATION ST.<br>NEW ORLEANS, LA 70130<br>T 512.535.2085<br>STUDIO@JAMODINGER.COM<br>CONTACT:<br>IA. MODINGER, ARCHITECT<br>PRINCIPAL<br>ALEX@JAMODINGER.COM<br>CONTRACTOR<br>TBD | ISSUED DATE: REVISION: REVISION DATE:<br>3 AUG 22<br>3 AUG 22<br>3 AUG 22<br>9 AUG 22<br>1 |
| DRAWING INDEXSHEETDESCRIPTIONA0.0GENERAL INFORMATION<br>SITE PLAN AND SITE DETAILSA1.1INTERIOR DETAILS<br>EXTERIOR DETAILSA1.2EXTERIOR DETAILSA2.0FOUNDATION PLAN<br>FLOOR PLANSA3.1REFLECTED CEILING PLANSA3.1REFLECTED CEILING PLANSA5.1BUILDING SECTIONSA6.1INTERIOR ELEVATIONS AND SCHEDULES                              | INFORMATION<br>3 AUGUST 2022   |






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# HOLLYGROVE STREET (SIDE) 120.0'

9000-02 FORSHEY STREET VACANT


| — 6'-0" TREATED<br>WOOD FENCE   | DOORBELL, MAILBOX AND ORNAMENTE<br>AND PAVE | ED/PTD. GATE TO MARK ENTRY | NEW PRESSURE<br>TREATED DECK<br>WITH GUARD<br>RAIL, PAINTED   |
|---|---|----------------------------|---|
| A A A A A A A A A     A | (B)   |                            | GATE  |
| UPLEX RESIDEN<br>NE STORY<br>066 S.F.   |   |                            |   |
| <u>93'-10"</u>  |   | GRAVEL                     | B<br>B<br>B<br>B<br>C<br>GATE<br>B<br>C<br>GATE<br>B<br>C<br>GATE<br>C<br>SERVICE<br>SERVICE<br>C<br>SERVICE<br>SERVICE<br>11'-5" 9'-<br>11'-2": SI<br>NON<br>LISTON<br>LISTON<br>LISTON<br>LISTON<br>LISTON<br>LISTON<br>LISTON<br>LISTON<br>LISTON<br>LISTON<br>LISTON<br>LISTON<br>LISTON<br>LISTON<br>LISTON<br>LISTON<br>LISTON<br>LISTON<br>LISTON<br>LISTON<br>LISTON<br>LISTON<br>LISTON<br>LISTON<br>LISTON<br>LISTON<br>LISTON<br>LISTON<br>LISTON<br>LISTON<br>LISTON<br>LISTON<br>LISTON<br>LISTON<br>LISTON<br>LISTON<br>LISTON<br>LISTON<br>LISTON<br>LISTON<br>LISTON<br>LISTON<br>LISTON<br>LISTON<br>LISTON<br>LISTON<br>LISTON<br>LISTON<br>LISTON<br>LISTON<br>LISTON<br>LISTON<br>LISTON<br>LISTON<br>LISTON<br>LISTON<br>LISTON<br>LISTON<br>LISTON<br>LISTON<br>LISTON<br>LISTON<br>LISTON<br>LISTON<br>LISTON<br>LISTON<br>LISTON<br>LISTON<br>LISTON<br>LISTON<br>LISTON<br>LISTON<br>LISTON<br>LISTON<br>LISTON<br>LISTON<br>LISTON<br>LISTON<br>LISTON<br>LISTON<br>LISTON<br>LISTON<br>LISTON<br>LISTON<br>LISTON<br>LISTON<br>LISTON<br>LISTON<br>LISTON<br>LISTON<br>LISTON<br>LISTON<br>LISTON<br>LISTON<br>LISTON<br>LISTON<br>LISTON<br>LISTON<br>LISTON<br>LISTON<br>LISTON<br>LISTON<br>LISTON<br>LISTON<br>LISTON<br>LISTON<br>LISTON<br>LISTON<br>LISTON<br>LISTON<br>LISTON<br>LISTON<br>LISTON<br>LISTON<br>LISTON<br>LISTON<br>LISTON<br>LISTON<br>LISTON<br>LISTON<br>LISTON<br>LISTON<br>LISTON<br>LISTON<br>LISTON<br>LISTON<br>LISTON<br>LISTON<br>LISTON<br>LISTON<br>LISTON<br>LISTON<br>LISTON<br>LISTON<br>LISTON<br>LISTON<br>LISTON<br>LISTON<br>LISTON<br>LISTON<br>LISTON<br>LISTON<br>LISTON<br>LISTON<br>LISTON<br>LISTON<br>LISTON<br>LISTON<br>LISTON<br>LISTON<br>LISTON<br>LISTON<br>LISTON<br>LISTON<br>LISTON<br>LISTON<br>LISTON<br>LISTON<br>LISTON<br>LISTON<br>LISTON<br>LISTON<br>LISTON<br>LISTON<br>LISTON<br>LISTON<br>LISTON<br>LISTON<br>LISTON<br>LISTON<br>LISTON<br>LISTON<br>LISTON<br>LISTON<br>LISTON<br>LISTON<br>LISTON<br>LISTON<br>LISTON<br>LISTON<br>LISTON<br>LISTON<br>LISTON<br>LISTON<br>LISTON<br>LISTON<br>LISTON<br>LISTON<br>LISTON<br>LISTON<br>LISTON<br>LISTON<br>LISTON<br>LISTON<br>LISTON<br>LISTON<br>LISTON<br>LISTON<br>LISTON<br>LISTON<br>LISTON<br>LISTON<br>LISTON<br>LISTON<br>LISTON<br>LISTON<br>LISTON<br>LISTON<br>LISTON<br>LISTON<br>LISTON<br>LISTON<br>LISTON<br>LISTON<br>LISTON<br>LISTON<br>LISTON<br>LISTON<br>LISTON<br>LISTON<br>LISTON<br>LISTON<br>LISTON<br>LISTON<br>LISTON<br>LISTON<br>LISTON<br>LISTON<br>LISTON<br>LISTON<br>LISTON<br>LISTON<br>LISTON<br>LISTON<br>LISTON<br>LISTON<br>LISTON<br>LISTON<br>LISTON<br>LISTON<br>LISTON<br>LISTON<br>LISTON<br>LISTON<br>LISTON<br>LISTON<br>LISTON<br>LISTON<br>LISTON<br>LISTON<br>LISTON<br>LISTON<br>LISTON<br>LISTON<br>LISTON<br>LISTON<br>LISTON<br>LISTON<br>LISTON<br>LISTON<br>LISTON<br>LISTON<br>LISTON<br>LISTON<br>LISTON<br>LISTON<br>LISTON<br>LISTON<br>LISTON<br>LISTON<br>LISTON<br>LISTON<br>LISTON<br>LISTON<br>LISTON<br>LISTON<br>LISTON<br>LISTON<br>LISTO |


HAMILTON STREET (SIDE) 120.0'

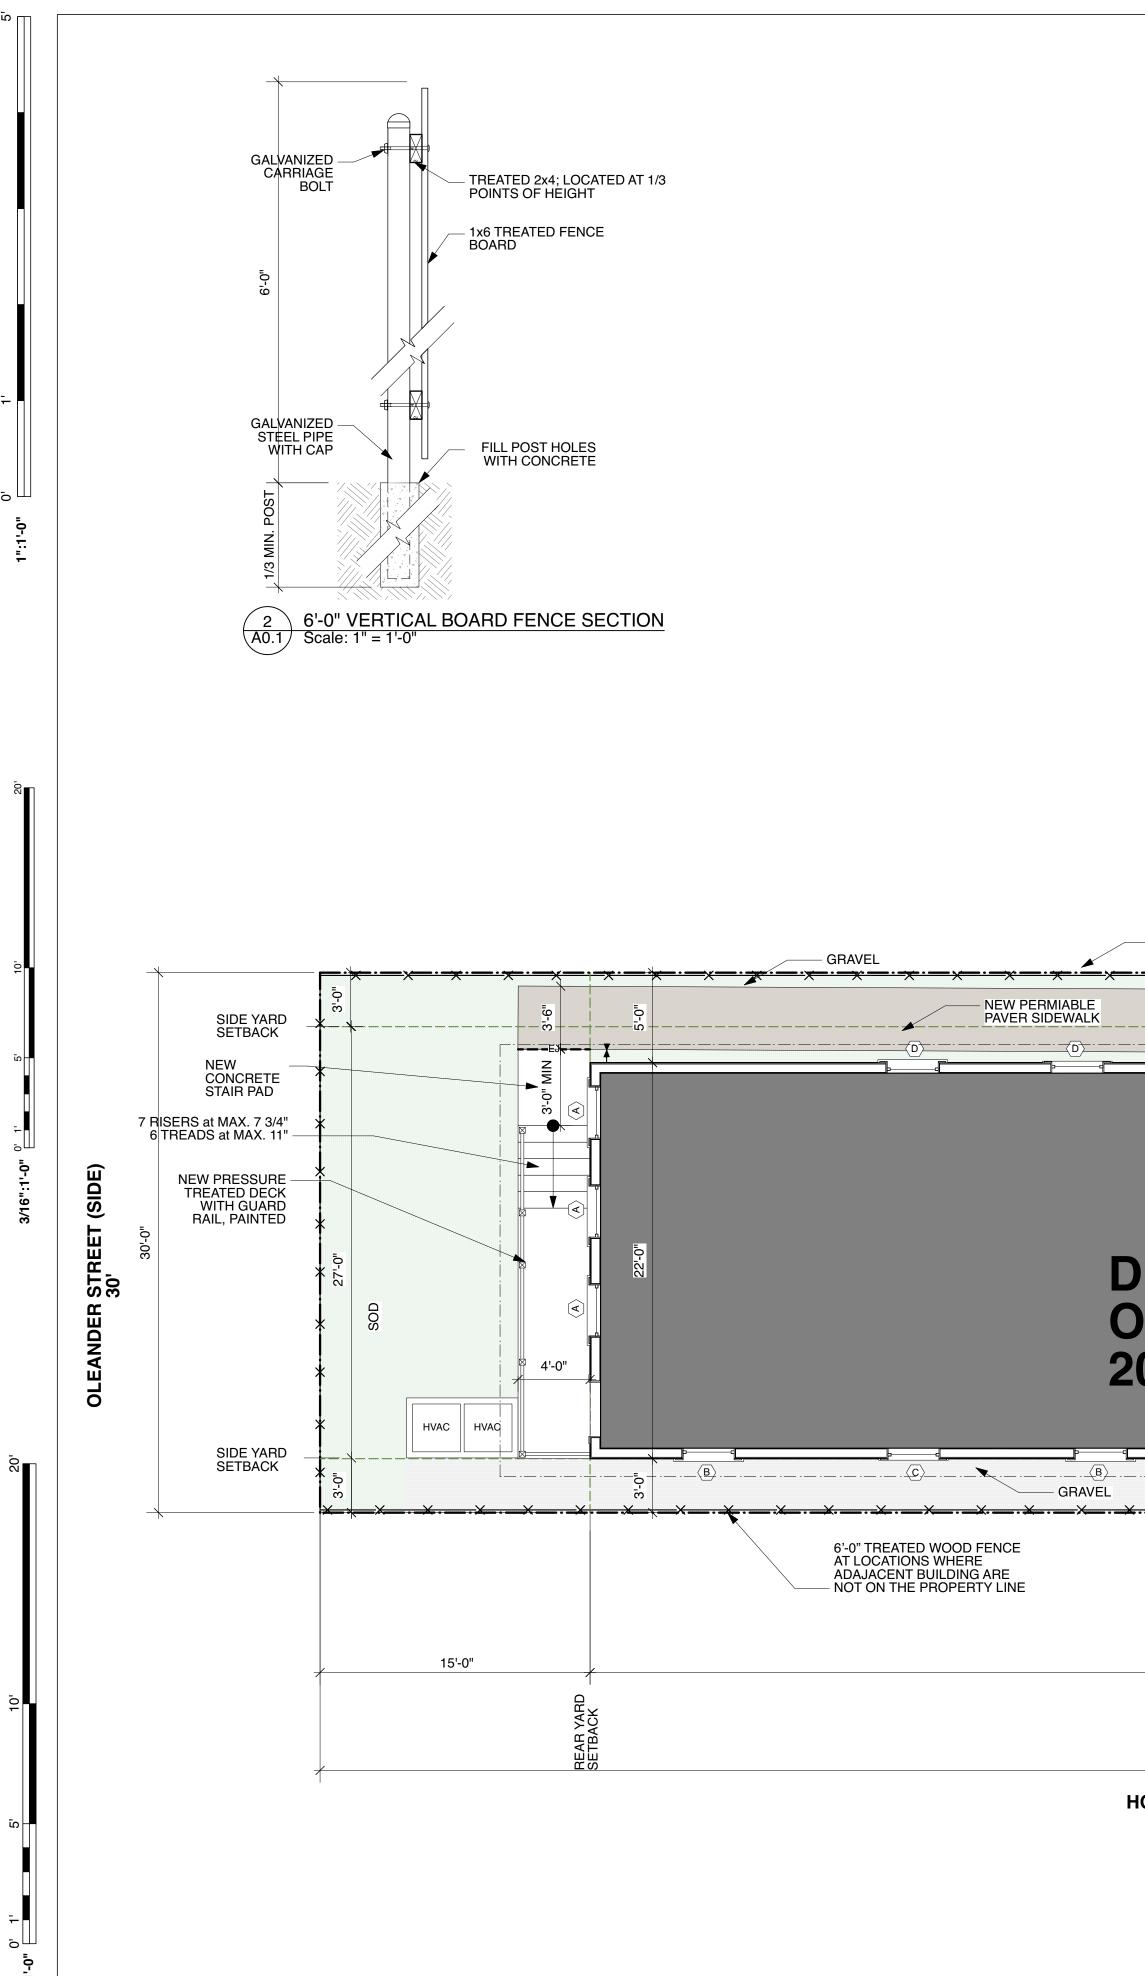
9010 FORSHEY STREET

SITE NOTES: 1. NO PARKING PROVIDED PER CZO 22.5.A.2, DWELLING ON LOTS OF 30'-0" OR LESS. 2. FRONT YARD SETBACK DETERMINED BY FIELD VERIFICATION OF EXISITNG NEIGHBOR SETBACK

9'-8"

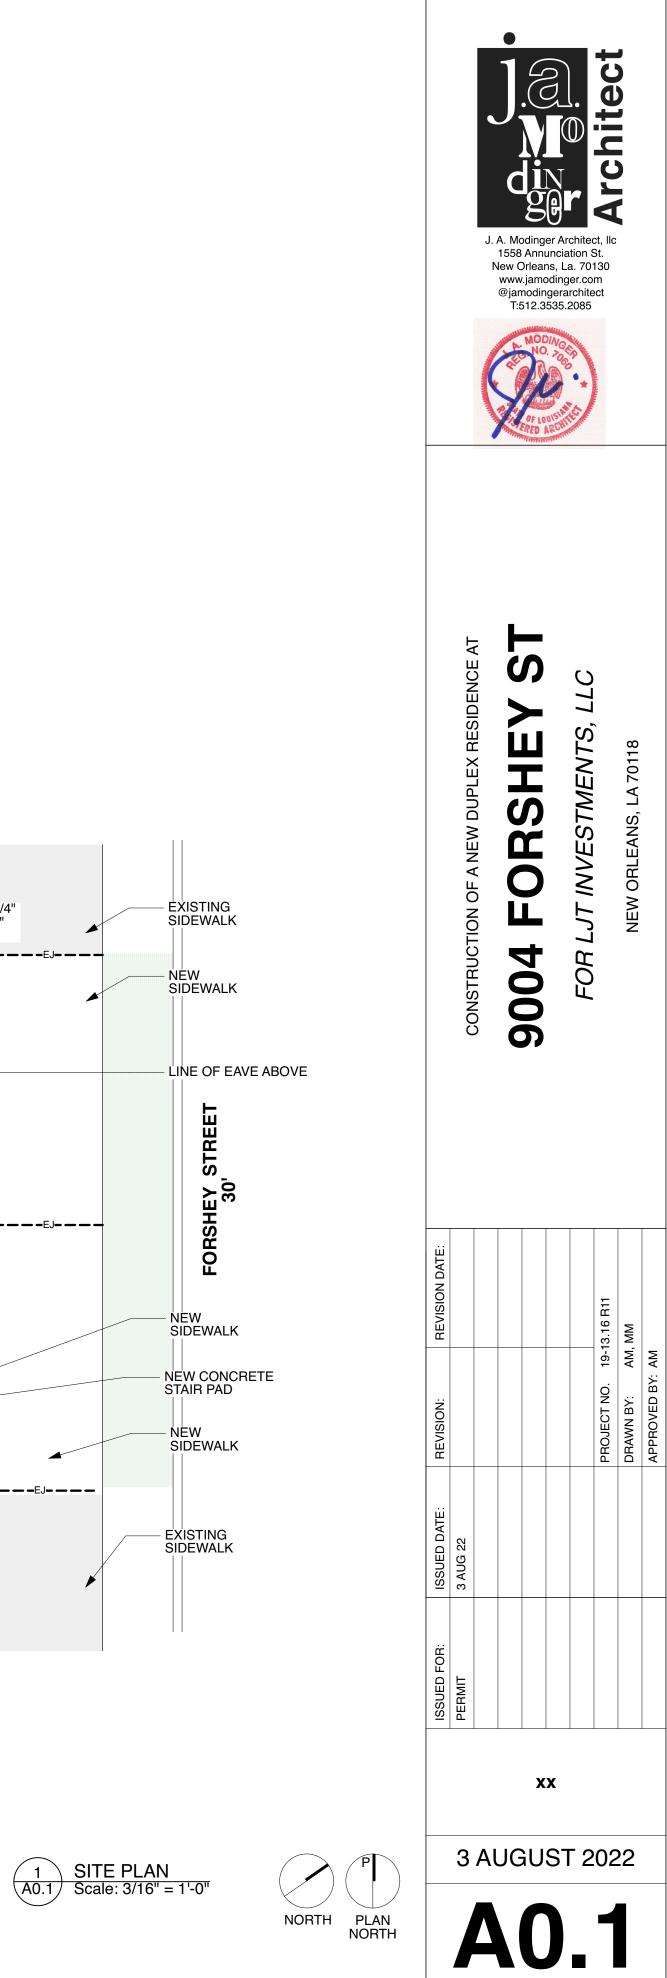

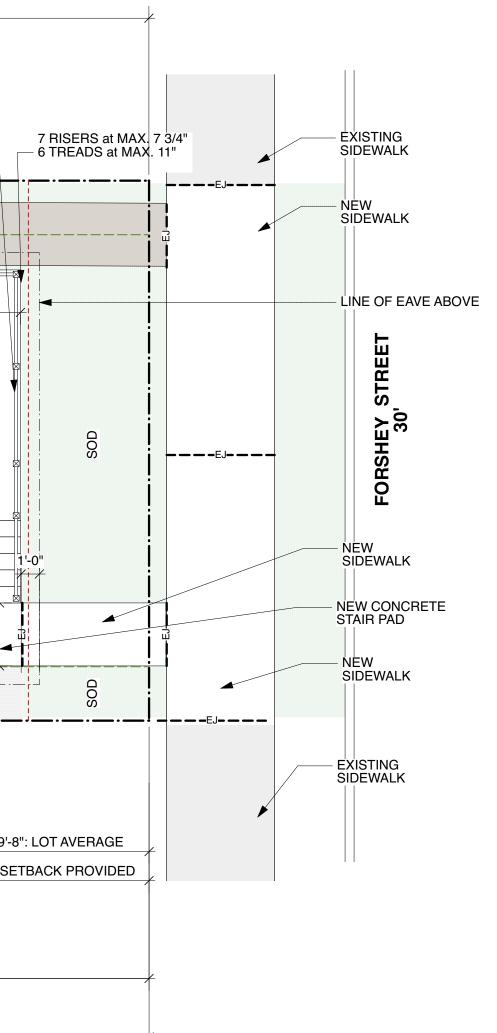

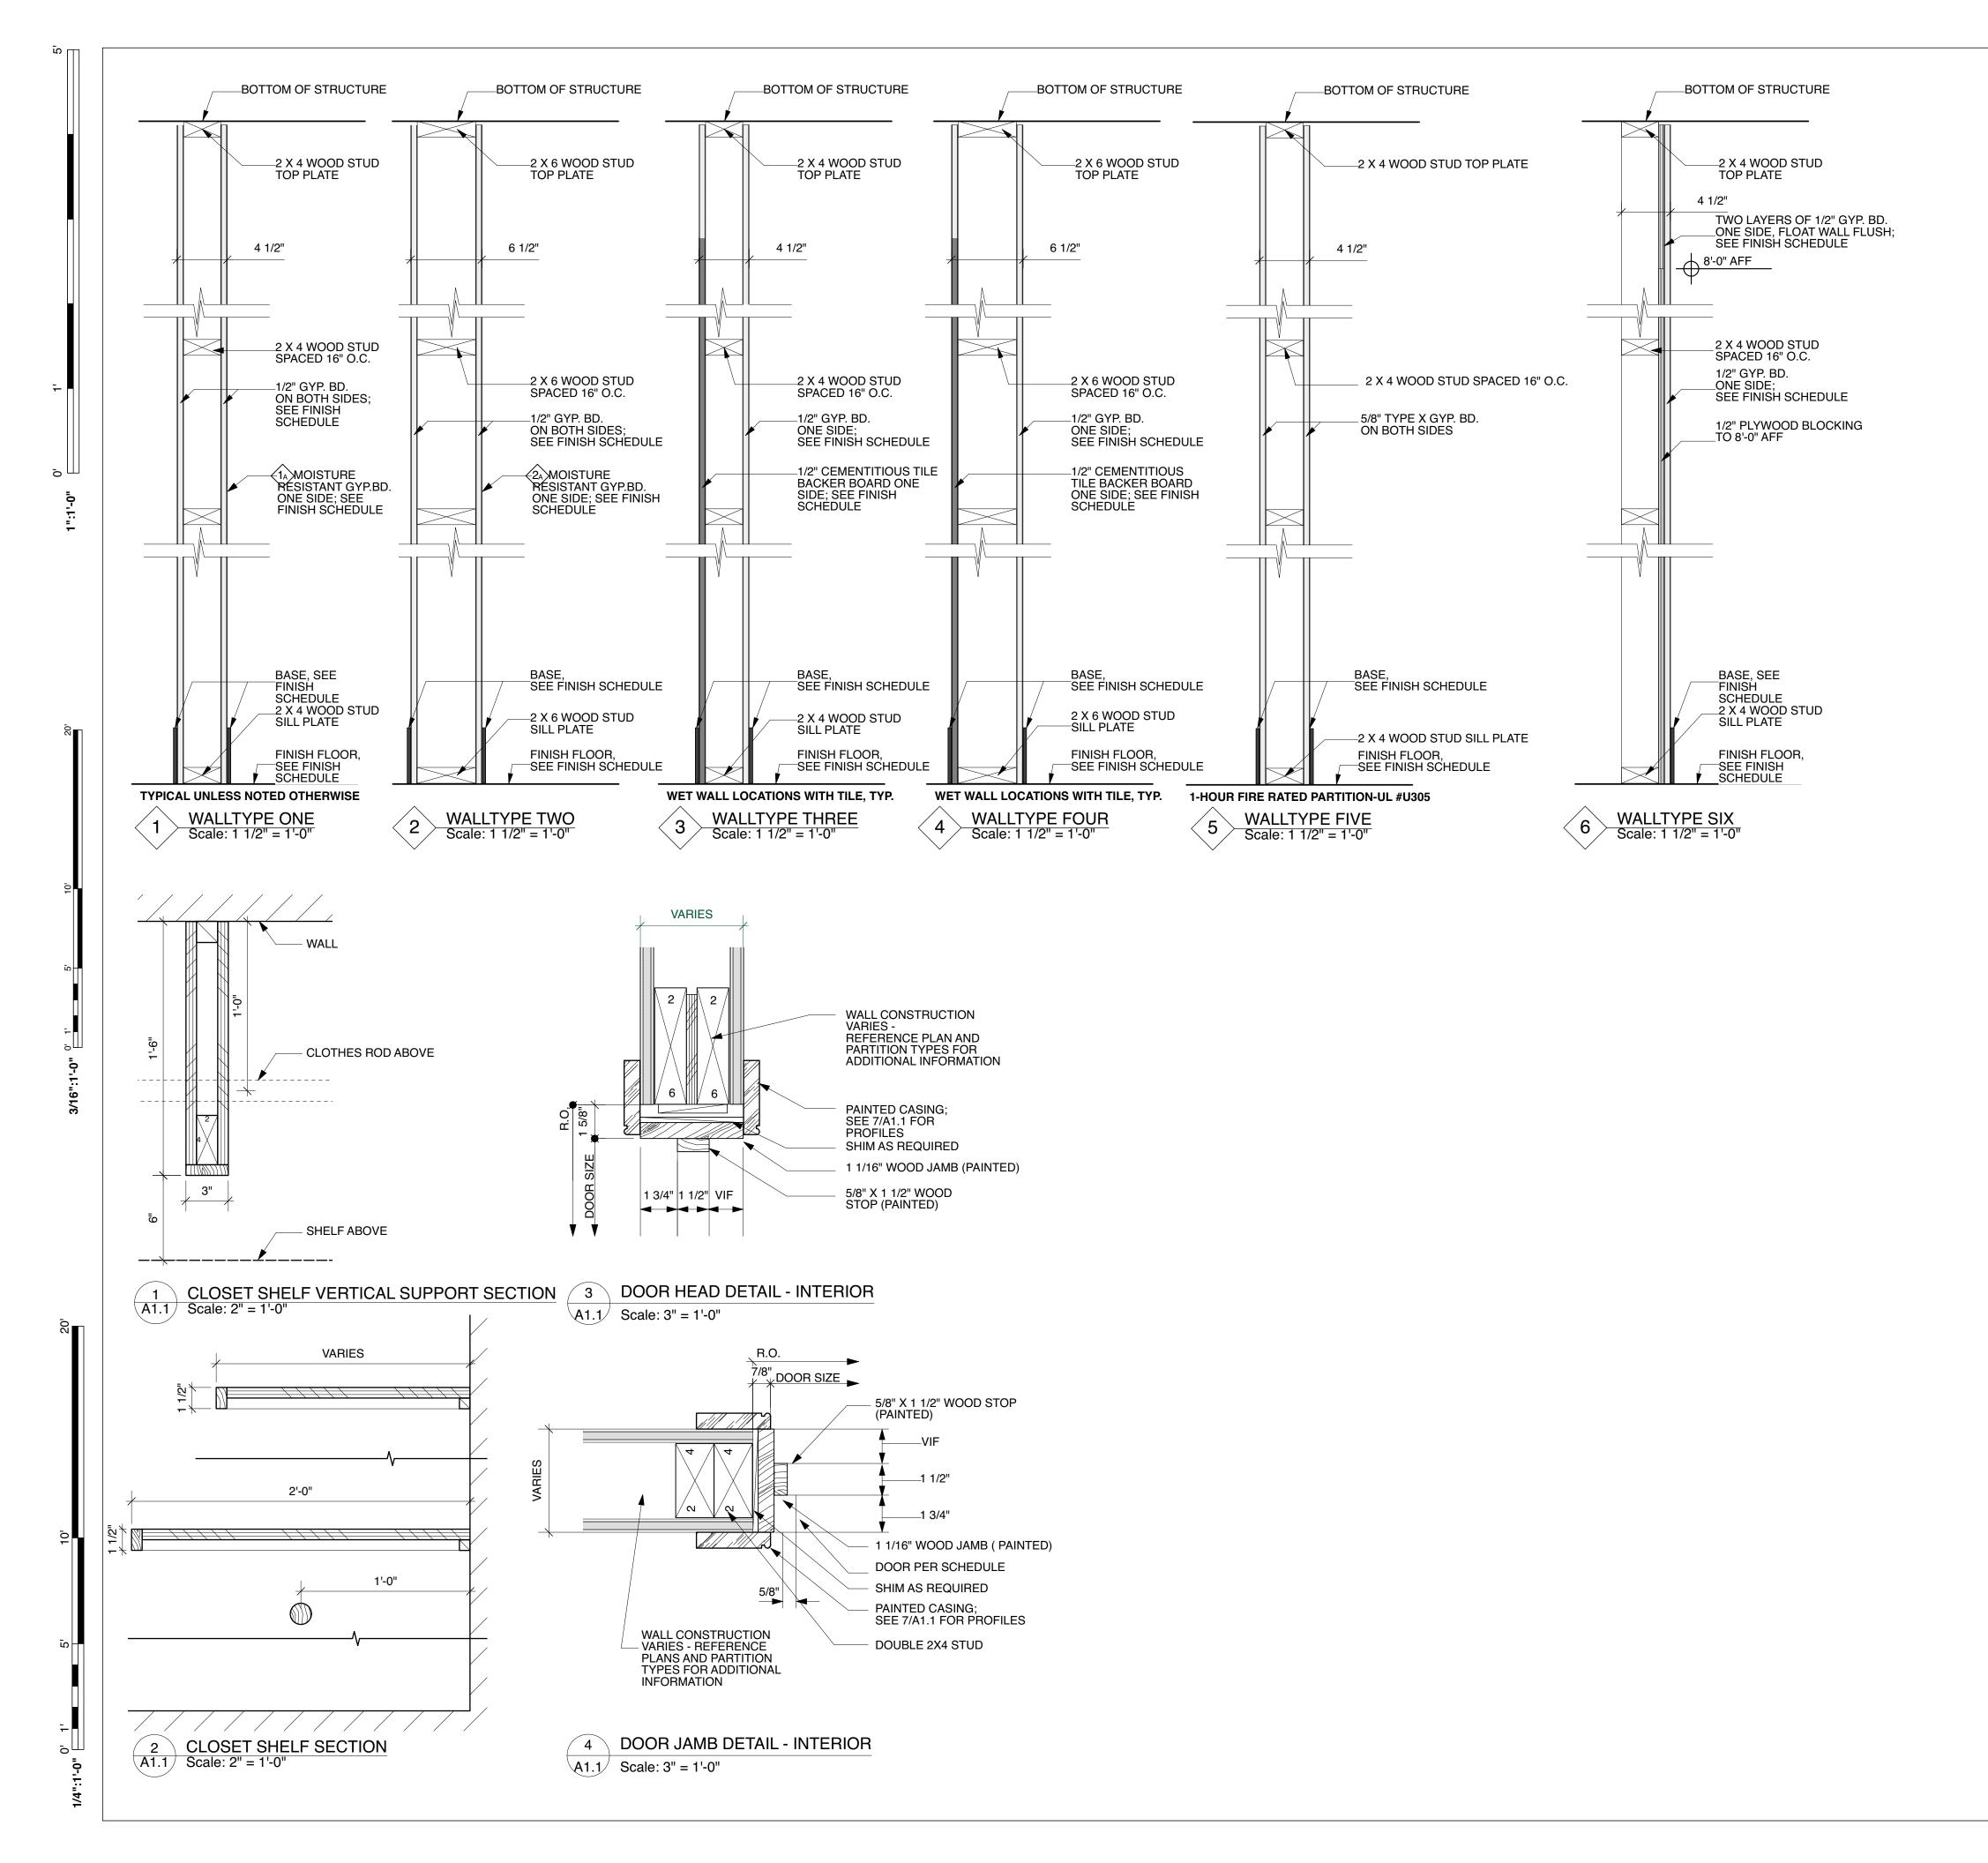



ORLEANS, LA 70118


NEW

FOR LJT INVESTMENTS, LLC


# 9004 FORSHEY S

CONSTRUCTION OF A NEW DUPLEX RESIDENCE AT

| <b>REVISION DATE:</b>               |               |  |  |  |  |  | 13.16 R11                | AM, AG       |                 |  |
|-------------------------------------|---------------|--|--|--|--|--|--------------------------|--------------|-----------------|--|
| REVISION:                           |               |  |  |  |  |  | PROJECT NO. 19-13.16 R11 | DRAWN BY: AM | APPROVED BY: AM |  |
| ISSUED DATE:                        | 3 AUG 22      |  |  |  |  |  |                          |              |                 |  |
| ISSUED FOR:                         | PERMIT        |  |  |  |  |  |                          |              |                 |  |
| INTERIOR AND<br>EXTERIOR<br>DETAILS |               |  |  |  |  |  |                          |              |                 |  |
|                                     | 3 AUGUST 2022 |  |  |  |  |  |                          |              |                 |  |
|                                     |               |  |  |  |  |  |                          |              |                 |  |

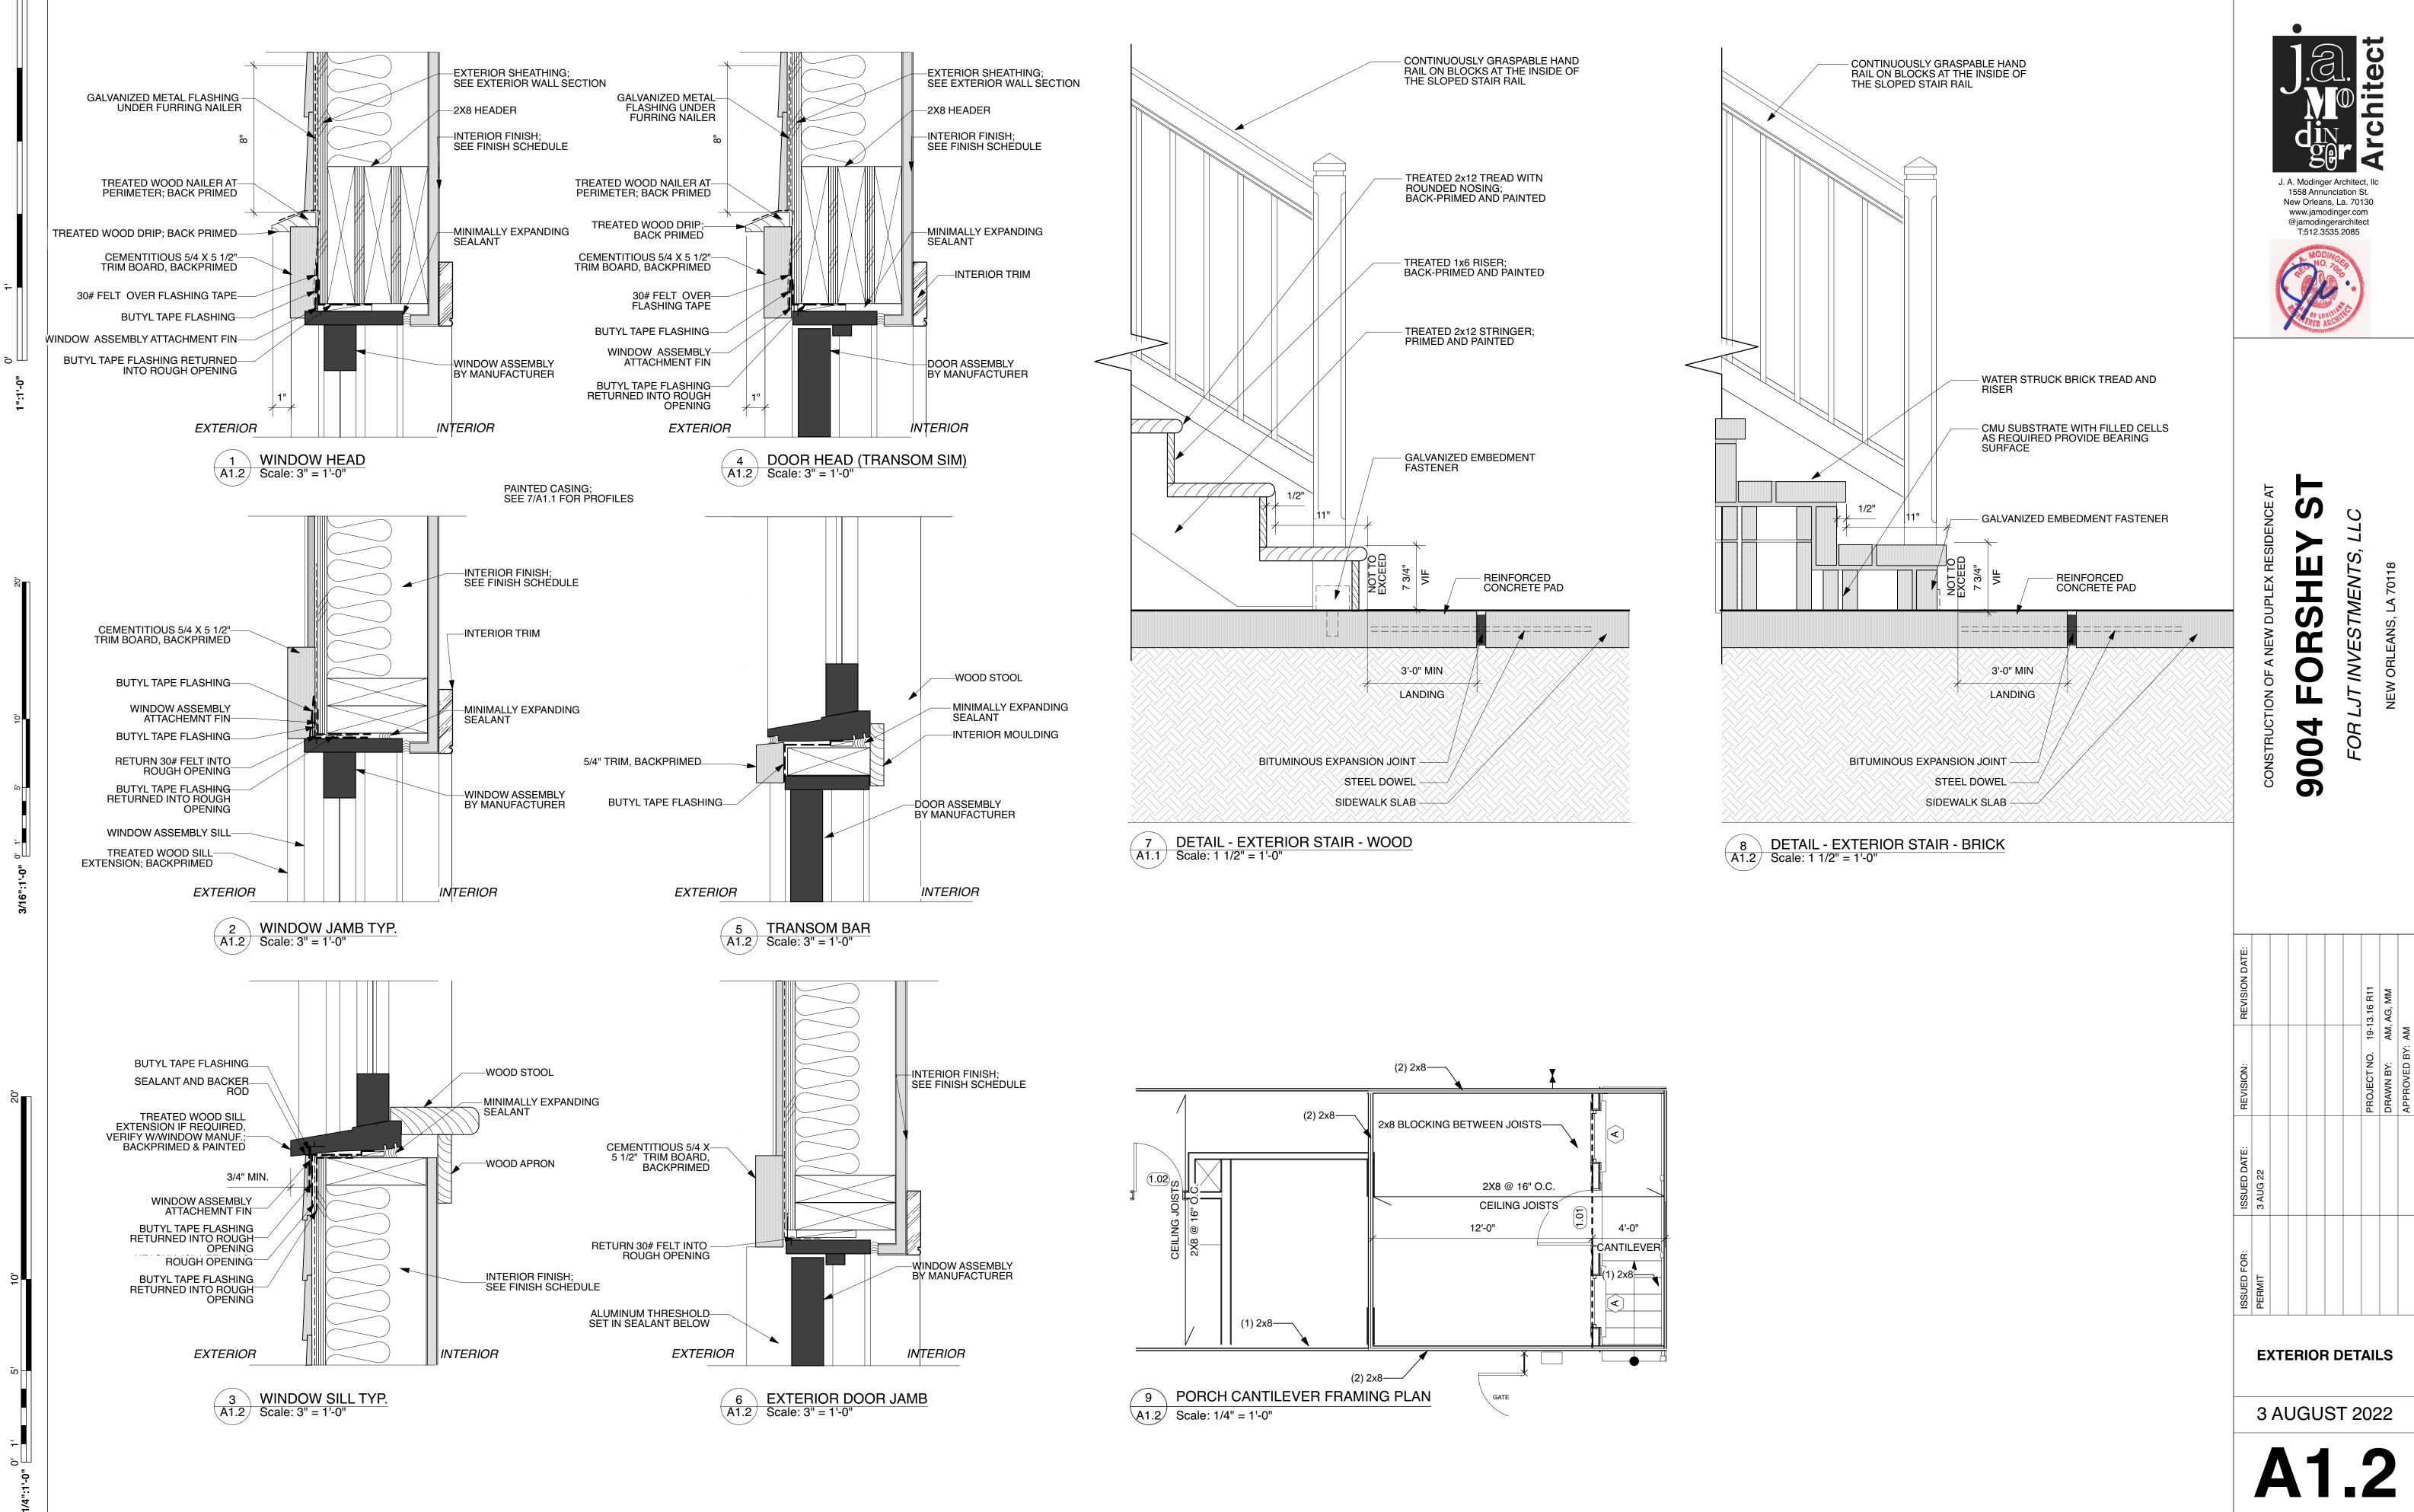

| <b>REVISION DATE:</b> |          |     |     |     |     |    | ·13.16 R11               | AM, AG, MM   | _               |
|-----------------------|----------|-----|-----|-----|-----|----|--------------------------|--------------|-----------------|
| REVISION:             |          |     |     |     |     |    | PROJECT NO. 19-13.16 R11 | DRAWN BY: AM | APPROVED BY: AM |
| ISSUED DATE:          | 3 AUG 22 |     |     |     |     |    |                          |              |                 |
| ISSUED FOR:           | PERMIT   |     |     |     |     |    |                          |              |                 |
|                       | E)       | KTI | ERI | IOF | R D | ET | AIL                      | _S           |                 |
|                       | 3        | Al  | JG  | ίU  | S1  | 2  | 02                       | 22           |                 |
|                       |          |     |     |     |     |    |                          |              |                 |

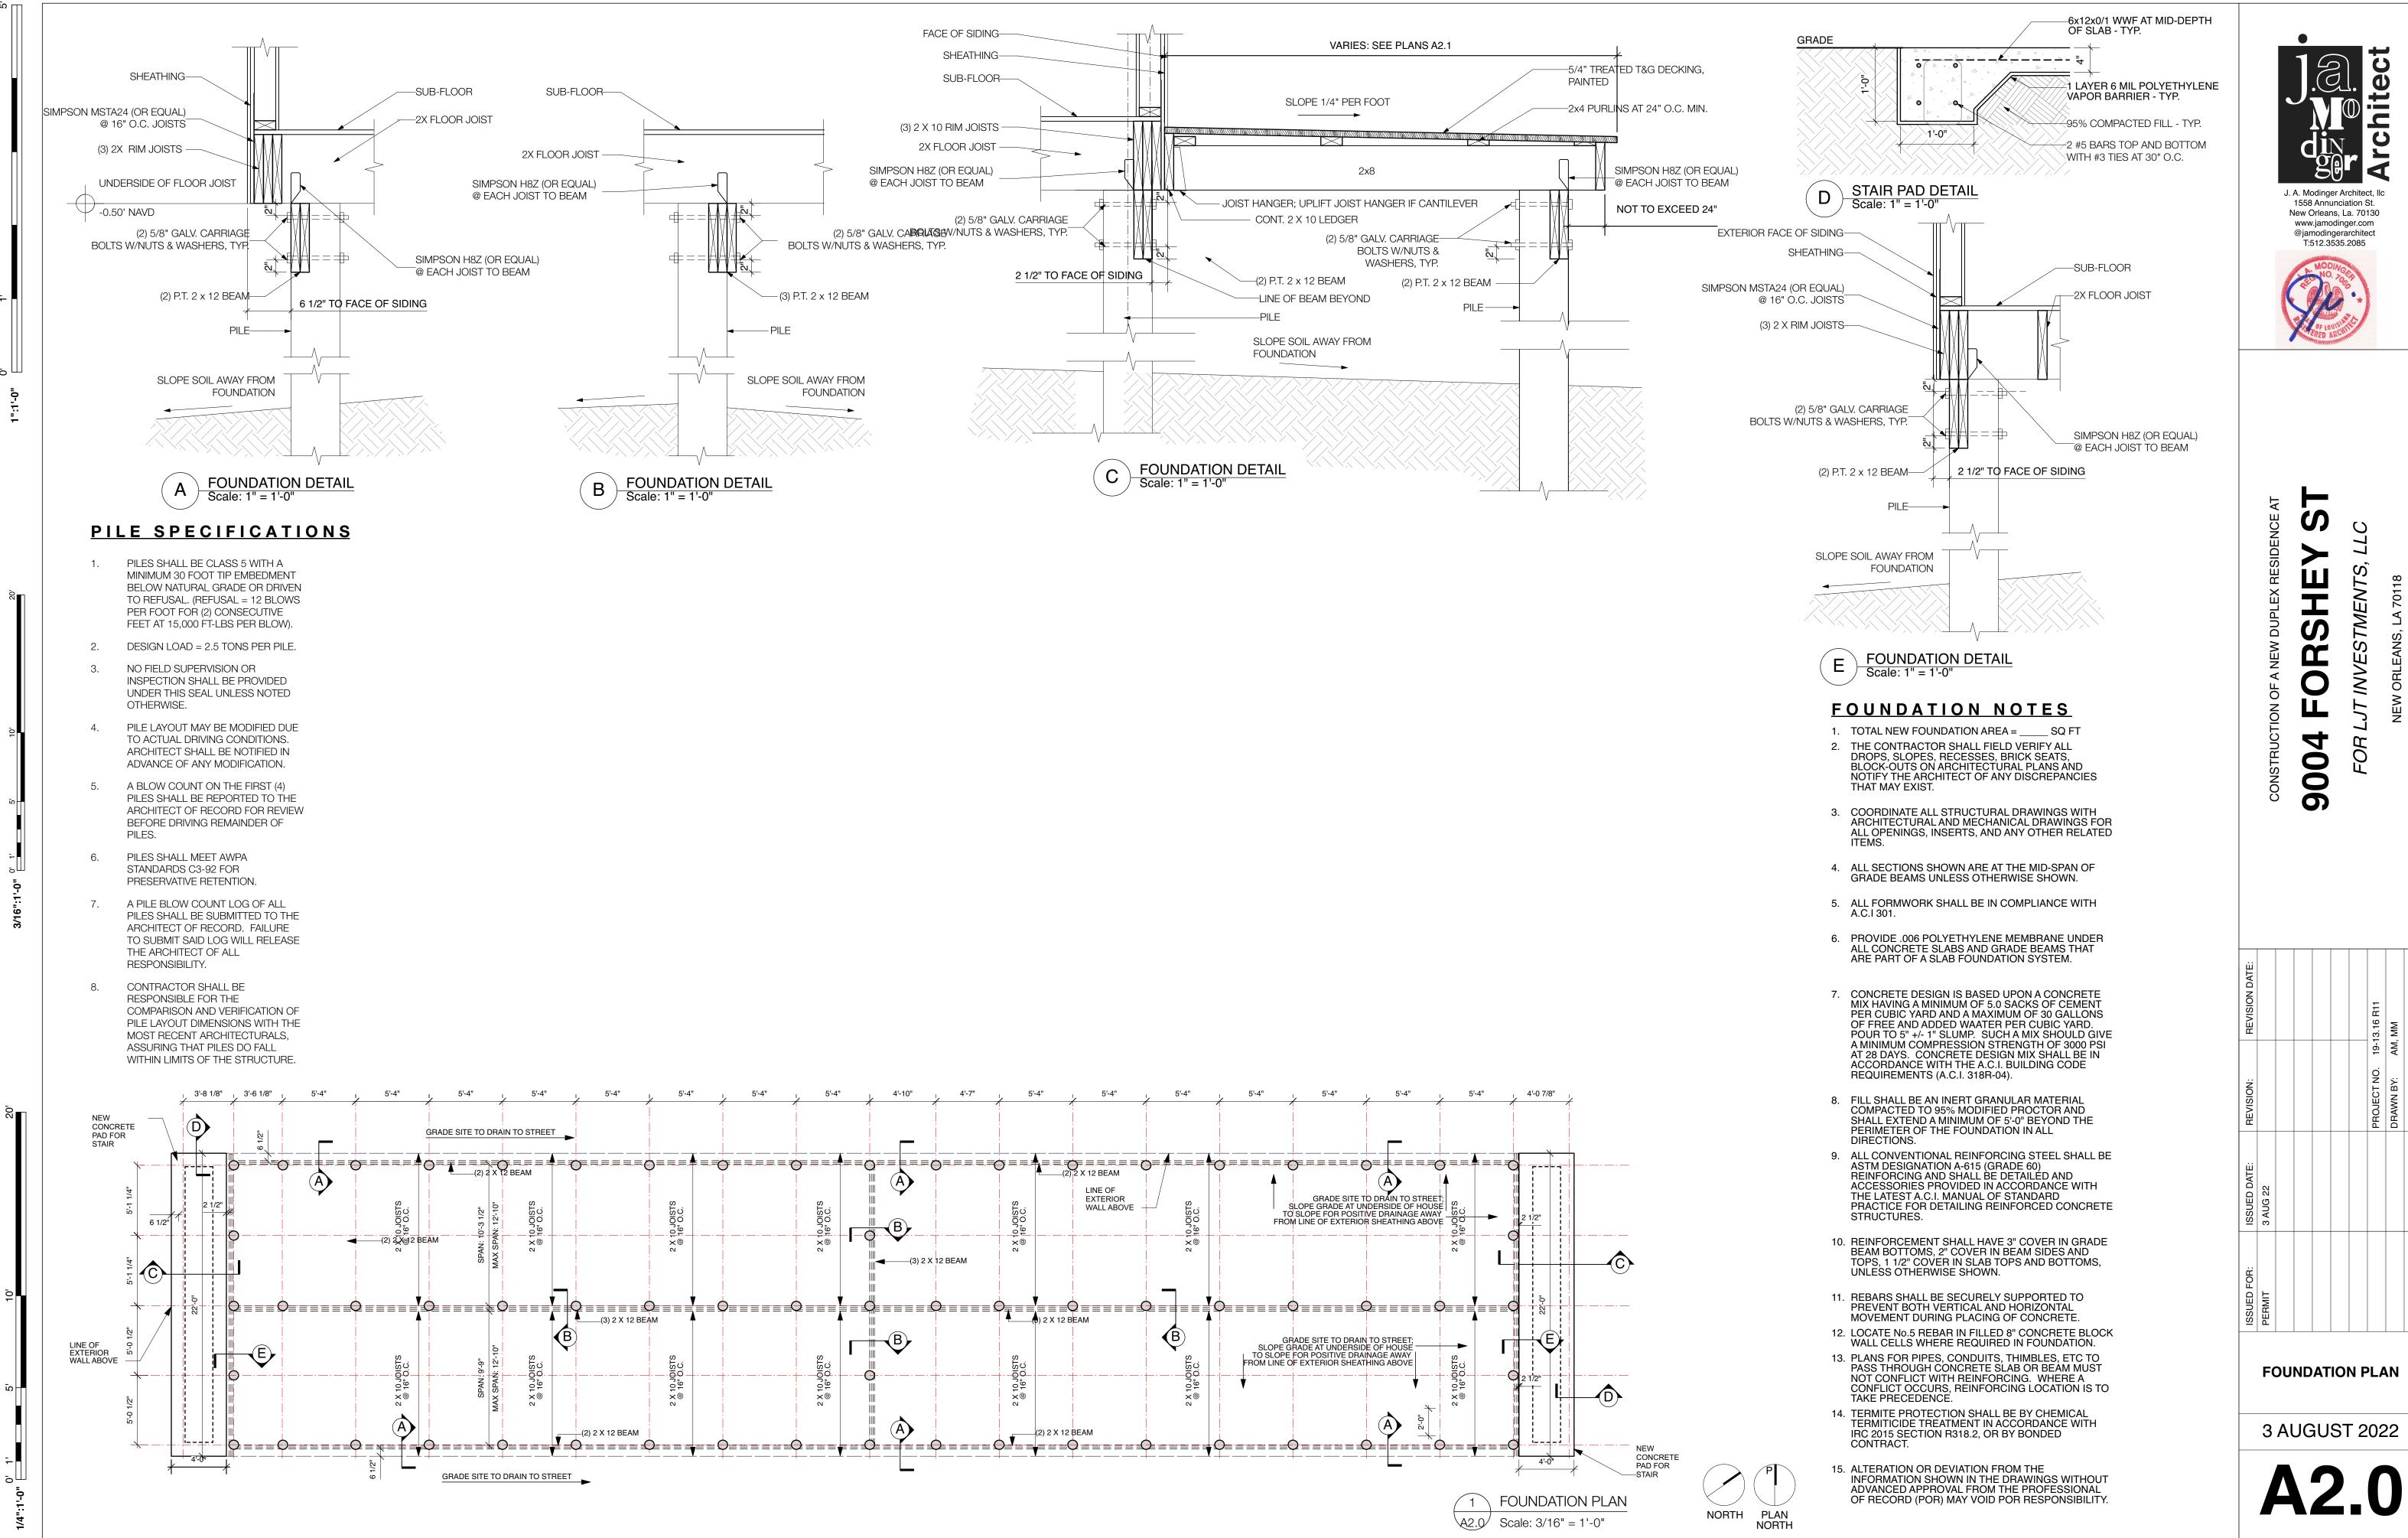

| <b>REVISION DATE:</b> |                 |    |    |    |    |   | 13.16 R11                | AM, MM       |                 |  |  |
|-----------------------|-----------------|----|----|----|----|---|--------------------------|--------------|-----------------|--|--|
| REVISION:             |                 |    |    |    |    |   | PROJECT NO. 19-13.16 R11 | DRAWN BY: AM | APPROVED BY: AM |  |  |
| ISSUED DATE:          | 3 AUG 22        |    |    |    |    |   |                          |              |                 |  |  |
| ISSUED FOR:           | PERMIT          |    |    |    |    |   |                          |              |                 |  |  |
|                       | FOUNDATION PLAN |    |    |    |    |   |                          |              |                 |  |  |
|                       | 3               | Al | JG | ίU | S1 | 2 | 02                       | 22           |                 |  |  |
|                       |                 |    |    |    |    |   | ſ                        |              |                 |  |  |

| DOWS        |           |        |  |                |  | MADK    | DOOM           |              |          |         | WALL C                               |                                      | CEILING |        |
|-------------|-----------|--------|--|----------------|--|---------|----------------|--------------|----------|---------|--------------------------------------|--------------------------------------|---------|--------|
| MARK        | UNIT SIZE |        | DESCRIPTION  | SILL<br>HEIGHT | REMARKS  | MARK    | ROOM           | FLOOR        | CROWN    | BASE    | WALLS                                | CEILING                              | HEIGHT  |        |
|             | WIDTH     | HEIGHT |  |                |  | 101/201 | LIVING ROOM    | VINYL PLANK  | -        | 8" WOOD | PAINTED GYPSUM BOARD                 | PAINTED GYPSUM BOARD                 | 10'-0"  |        |
| Α           | 2'-10"    | 5'-10" | DOUBLE HUNG WOOD WINDOW WITH SCREEN  | 32"            | EGRESS COMPLIANT PER IRC 2015;<br>JELD-WEN W-2500 WOOD | 102/202 | DINING ROOM    | VINYL PLANK  | -        | 8" WOOD | PAINTED GYPSUM BOARD                 | PAINTED GYPSUM BOARD                 | 10'-0"  | WALL I |
| В           | 2'-10"    | 5'-10" | SINGLE HUNG VINYL WINDOW WITH SCREEN   | 32"            | EGRESS COMPLIANT PER IRC 2015                          | 103/203 | KITCHEN        | CERAMIC TILE | -        | 6" WOOD | PAINTED MOISTURE<br>RESISTANT GYP BD | PAINTED MOISTURE<br>RESISTANT GYP BD | 10'-0"  |        |
| С           | 2'-10"    | 4'-10" | SINGLE HUNG VINYL WINDOW WITH SCREEN   | 44"            |  | 104/204 | BATH 02        | CERAMIC TILE | -        | 6" WOOD | PAINTED MOISTURE<br>RESISTANT GYP BD | PAINTED MOISTURE<br>RESISTANT GYP BD | 10'-0"  | ••••   |
| D           | 2'-10"    | 2'-0"  | FIXED VINYL WINDOW   | 6'-6"          |  | 105/205 | LAUNDRY        | CERAMIC TILE | -        | 4" WOOD | PAINTED MOISTURE<br>RESISTANT GYP BD | PAINTED MOISTURE<br>RESISTANT GYP BD | 10'-0"  |        |
| DRS<br>MARK | UNIT SIZE |        | DESCRIPTION  | ТҮРЕ           | REMARKS  | 106/206 | HALL           | VINYL PLANK  | -        | 6" WOOD | PAINTED GYPSUM BOARD                 | PAINTED GYPSUM BOARD                 | 10'-0"  |        |
|             | WIDTH     | HEIGHT |  |                |  |         |                |              |          |         | PAINTED MOISTURE                     | PAINTED MOISTURE                     |         |        |
| 1.01/2.01   | 3'-0"     | 6'-8"  | SOLID WOOD HISTORIC NEW HALF-GLASS LEAF + 20" TRANSOM OVER 2" BAR<br>(RICCA'S) |                | MATCH HEAD HEIGHT AT WINDOWS                           | 107/207 | MASTER BATH    | CERAMIC TILE | -        | 6" WOOD | PAINTED MOISTURE<br>RESISTANT GYP BD | PAINTED MOISTURE<br>RESISTANT GYP BD | 10'-0"  |        |
| 1.02/2.02   | 5'-0"     | 8'-0"  | CASED OPENING  |                | MATCH HEAD HEIGHT AT WINDOWS                           | 108/208 | CLOSET         | VINYL PLANK  | -        | 4" WOOD | PAINTED GYPSUM BOARD                 | PAINTED GYPSUM BOARD                 | 10'-0"  |        |
| 1.03/2.03   | 3'-0"     | 6'-8"  | SINGLE LEAF RIVERSIDE SMOOTH 5-PANEL EQUAL HOLLOW CORE INTERIOR DOOR           |                |  | 109/209 | MASTER BEDROOM | VINYL PLANK  | <u> </u> | 6" WOOD | PAINTED GYPSUM BOARD                 | PAINTED GYPSUM BOARD                 | 10'-0"  |        |
| 1.04/2.04   | 2'-6"     | 6'-8"  | SINGLE LEAF RIVERSIDE SMOOTH 5-PANEL EQUAL HOLLOW CORE INTERIOR DOOR           |                |  | 103/203 |                |              |          | 0 11000 |                                      |                                      | 10-0    |        |
| 1.05/2.05   | 2'-6"     | 6'-8"  | SINGLE LEAF RIVERSIDE SMOOTH 5-PANEL EQUAL HOLLOW CORE INTERIOR DOOR           |                |  | 110/210 | BEDROOM 02     | VINYL PLANK  | -        | 6" WOOD | PAINTED GYPSUM BOARD                 | PAINTED GYPSUM BOARD                 | 10'-0"  |        |
| 1.06/2.06   | 2'-6"     | 6'-8"  | SINGLE LEAF RIVERSIDE SMOOTH 5-PANEL EQUAL HOLLOW CORE INTERIOR DOOR           |                |  | 111/211 | CLOSET         | VINYL PLANK  | -        | 4" WOOD | PAINTED GYPSUM BOARD                 | PAINTED GYPSUM BOARD                 | 10'-0"  |        |
| 1.07/2.07   | 2'-6"     | 6'-8"  | SINGLE LEAF RIVERSIDE SMOOTH 5-PANEL EQUAL HOLLOW CORE INTERIOR DOOR           |                |  |         |                |              |          |         |                                      |                                      |         |        |
| 1.08/2.08   | 3'-0"     | 6'-8"  | SINGLE LEAF RIVERSIDE SMOOTH 5-PANEL EQUAL HOLLOW CORE INTERIOR DOOR           |                |  | 112/212 | CLOSET         | VINYL PLANK  | -        | 4" WOOD | PAINTED GYPSUM BOARD                 | PAINTED GYPSUM BOARD                 | 10'-0"  |        |
| 1.09/2.09   | 3'-0"     | 6'-8"  | SINGLE LEAF RIVERSIDE SMOOTH 5-PANEL EQUAL HOLLOW CORE INTERIOR DOOR           |                |  | 113/213 | BEDROOM 03     | VINYL PLANK  | -        | 6" WOOD | PAINTED GYPSUM BOARD                 | PAINTED GYPSUM BOARD                 | 10'-0"  |        |
| 1.10/2.10   | 2'-6"     | 6'-8"  | SINGLE LEAF RIVERSIDE SMOOTH 5-PANEL EQUAL HOLLOW CORE INTERIOR DOOR           |                |  |         |                |              |          |         |                                      |                                      |         |        |
| 1.11/2.11   | 2'-6"     | 6'-8"  | SINGLE LEAF RIVERSIDE SMOOTH 5-PANEL EQUAL HOLLOW CORE INTERIOR DOOR           |                |  |         |                |              |          |         |                                      |                                      |         |        |
| 1.12/2.12   | 3'-0"     | 6'-8"  | SINGLE LEAF RIVERSIDE SMOOTH 5-PANEL EQUAL HOLLOW CORE INTERIOR DOOR           |                |  |         |                |              |          |         |                                      |                                      |         |        |

### <u>OPENING SCHEDULE NOTES</u>

1. PROVIDE WIND-BORNE DEBRIS PROTECTION FOR WINDOWS IN ACCORDANCE WITH R301.2.1.2 IRC 2015 2. MAINTAIN 1/2" DIFFERENTIAL BETWEEN INTERIOR AND

EXTERIOR FINISH FLOOR ELEVATIONS AT EXTERIOR DOORS. SLPE PORCH SURFACES AWAY FROM EXTERIOR WALLS.

3. ALL DOORS SHAL RECEIVE A PAINT FINISH 4. INSTALL WEATHER STRIPPING AT ALL EXTERIOR DOORS


5. ALL WOOD SHALL BE KILN DRIED, MOISTURE CONTENT 6-12%


6. ALL DOOR GLASS SHALL BE TEMPERED

7. ALL HARDWARE SHALL BE BRUSHED NICKEL

8. PROVIDE DOOR STOPS OR BUMPERS AT ALL DOORS

9. PROVIDE GASKETED ALUMINUM THRESHOLD SET IN SEALANT

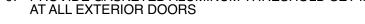

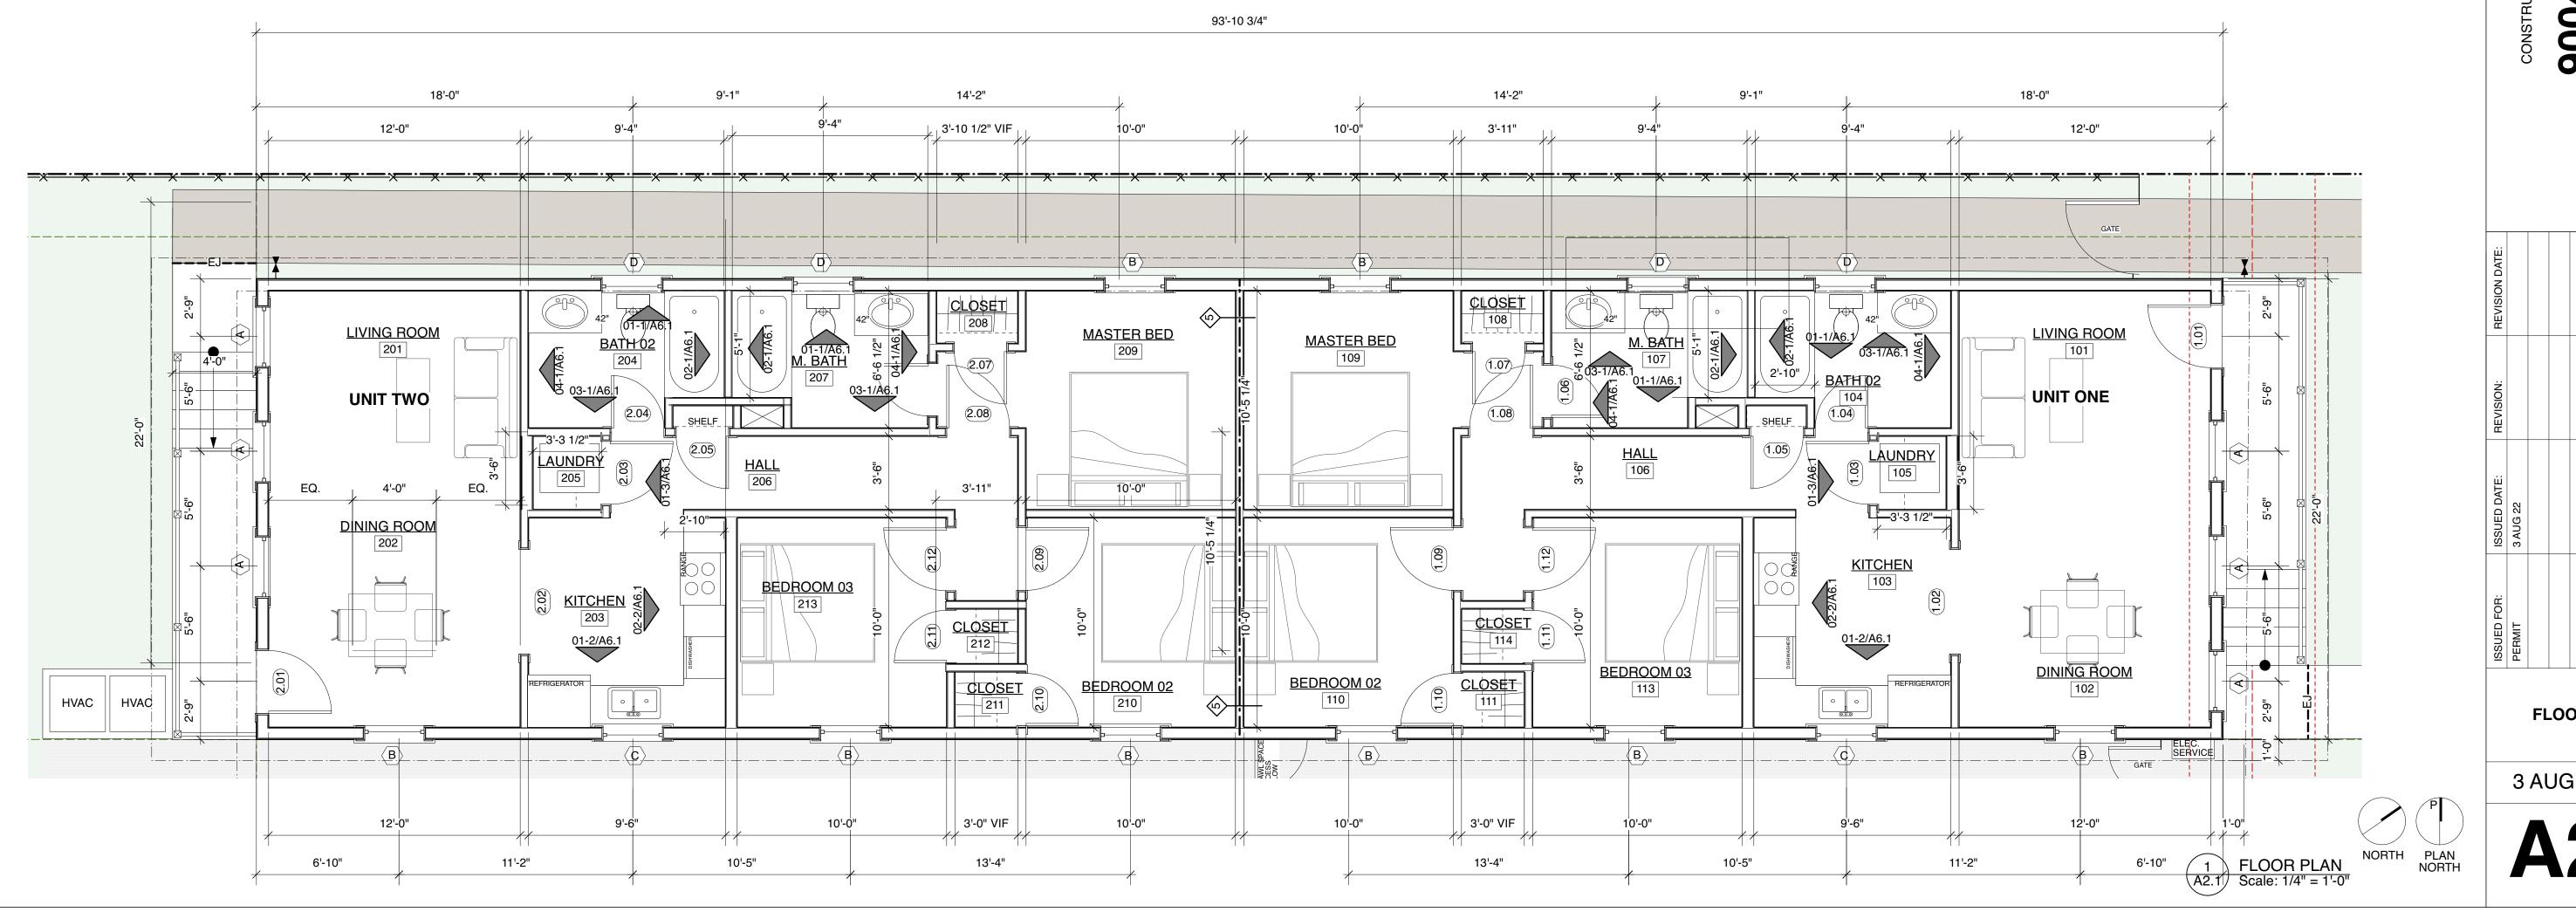

- FINISHES

### FINISH SCHEDULE NOTES

1. MAINTAIN 1/2" DIFFERENTIAL BETWEEN TILE AND WOOD

2. ALL CERAMIC TILE SHALL BE SEALED 3. FLOORING SHALL BE LEFT IN HOUSE TO ACCLIMATE PRIOR TO INSTALLATION - SEE PROJECT NOTES 4. 4. ALL FLOOR LEVEL TRANSITIONS NOT TO EXCEED 1/2"

NEW INTERIOR WALL EXISTING WALL EXISTING MASONRY WALL NEW EXTERIOR WALL RATED WALL TO CONT. TO UNDERSIDE OF ROOF DECKING NEW INTERIOR SHEAR WALL; PROVID CONTINUOUS SHEATHING PER CODE AT THIS LOACATION

1-HR RATED WALL- SEE WALLTYPES\* 2-HR RATED WALL- SEE WALLTYPES\* 3-HR RATED WALL- SEE WALLTYPES\* \*NOT ALL RATINGS ARE USED IN THIS PROJECT. SEE SHEET A1.1 FOR WALLTYPE ASSEMBLIES



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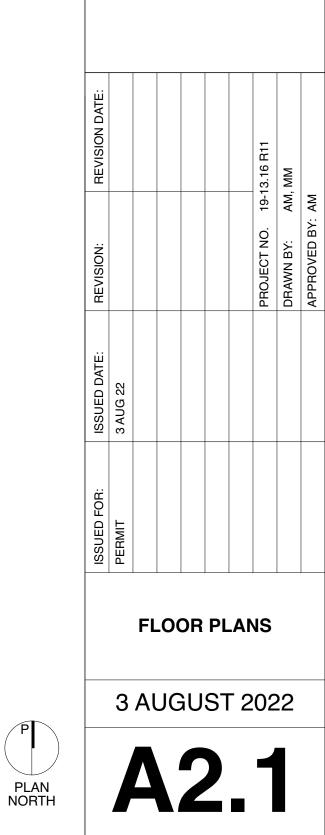
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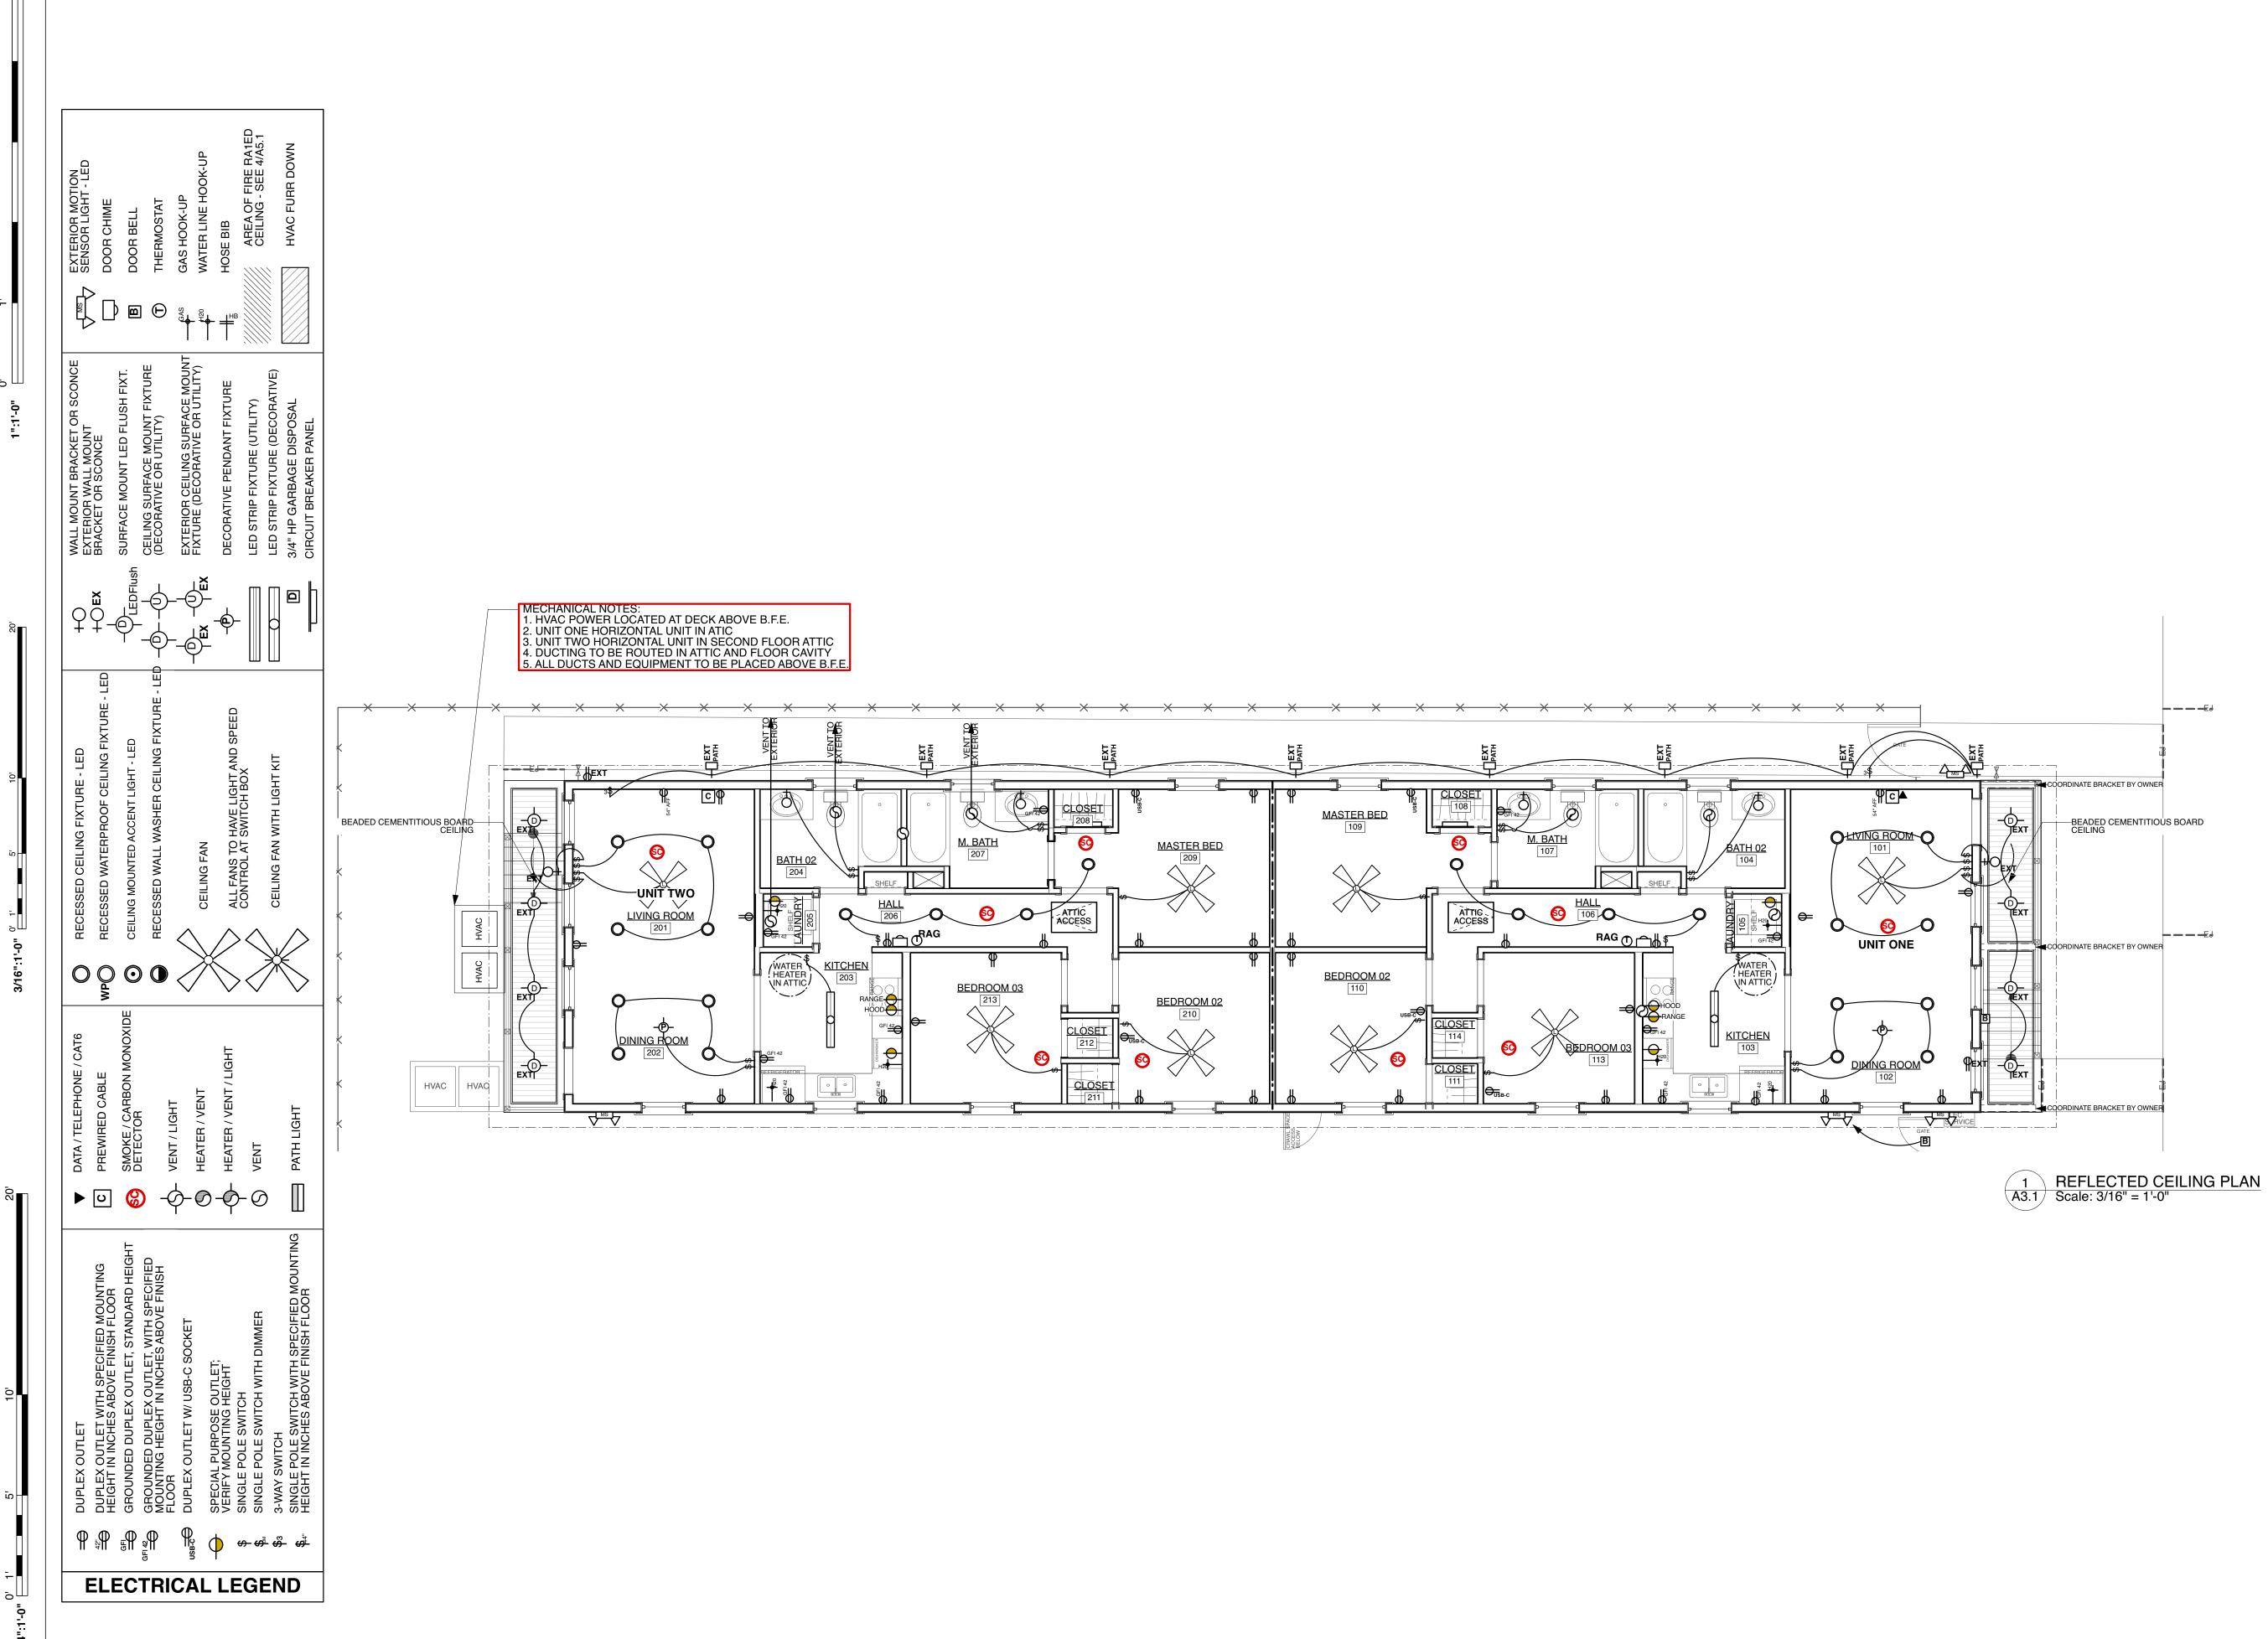
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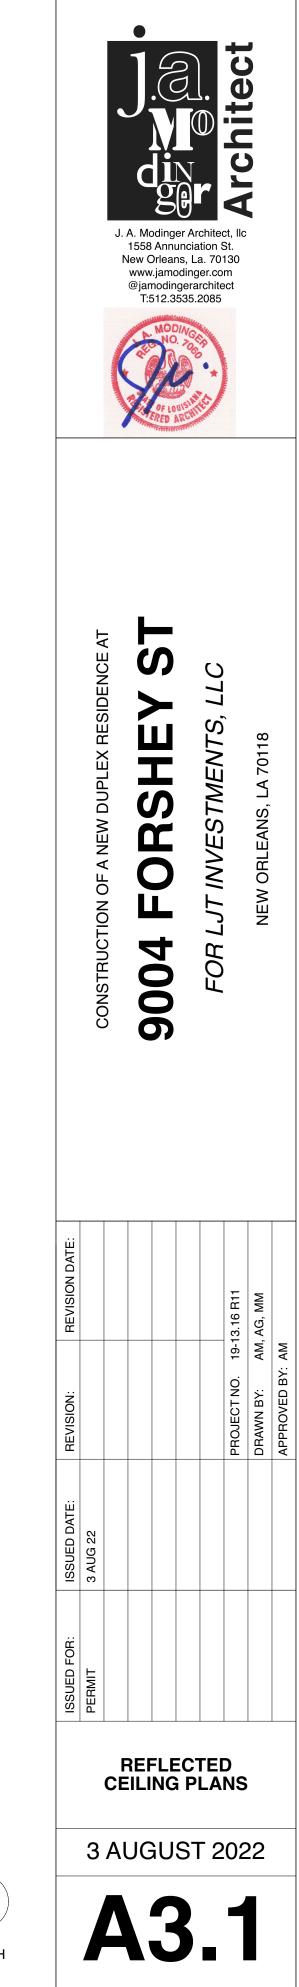
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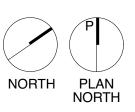
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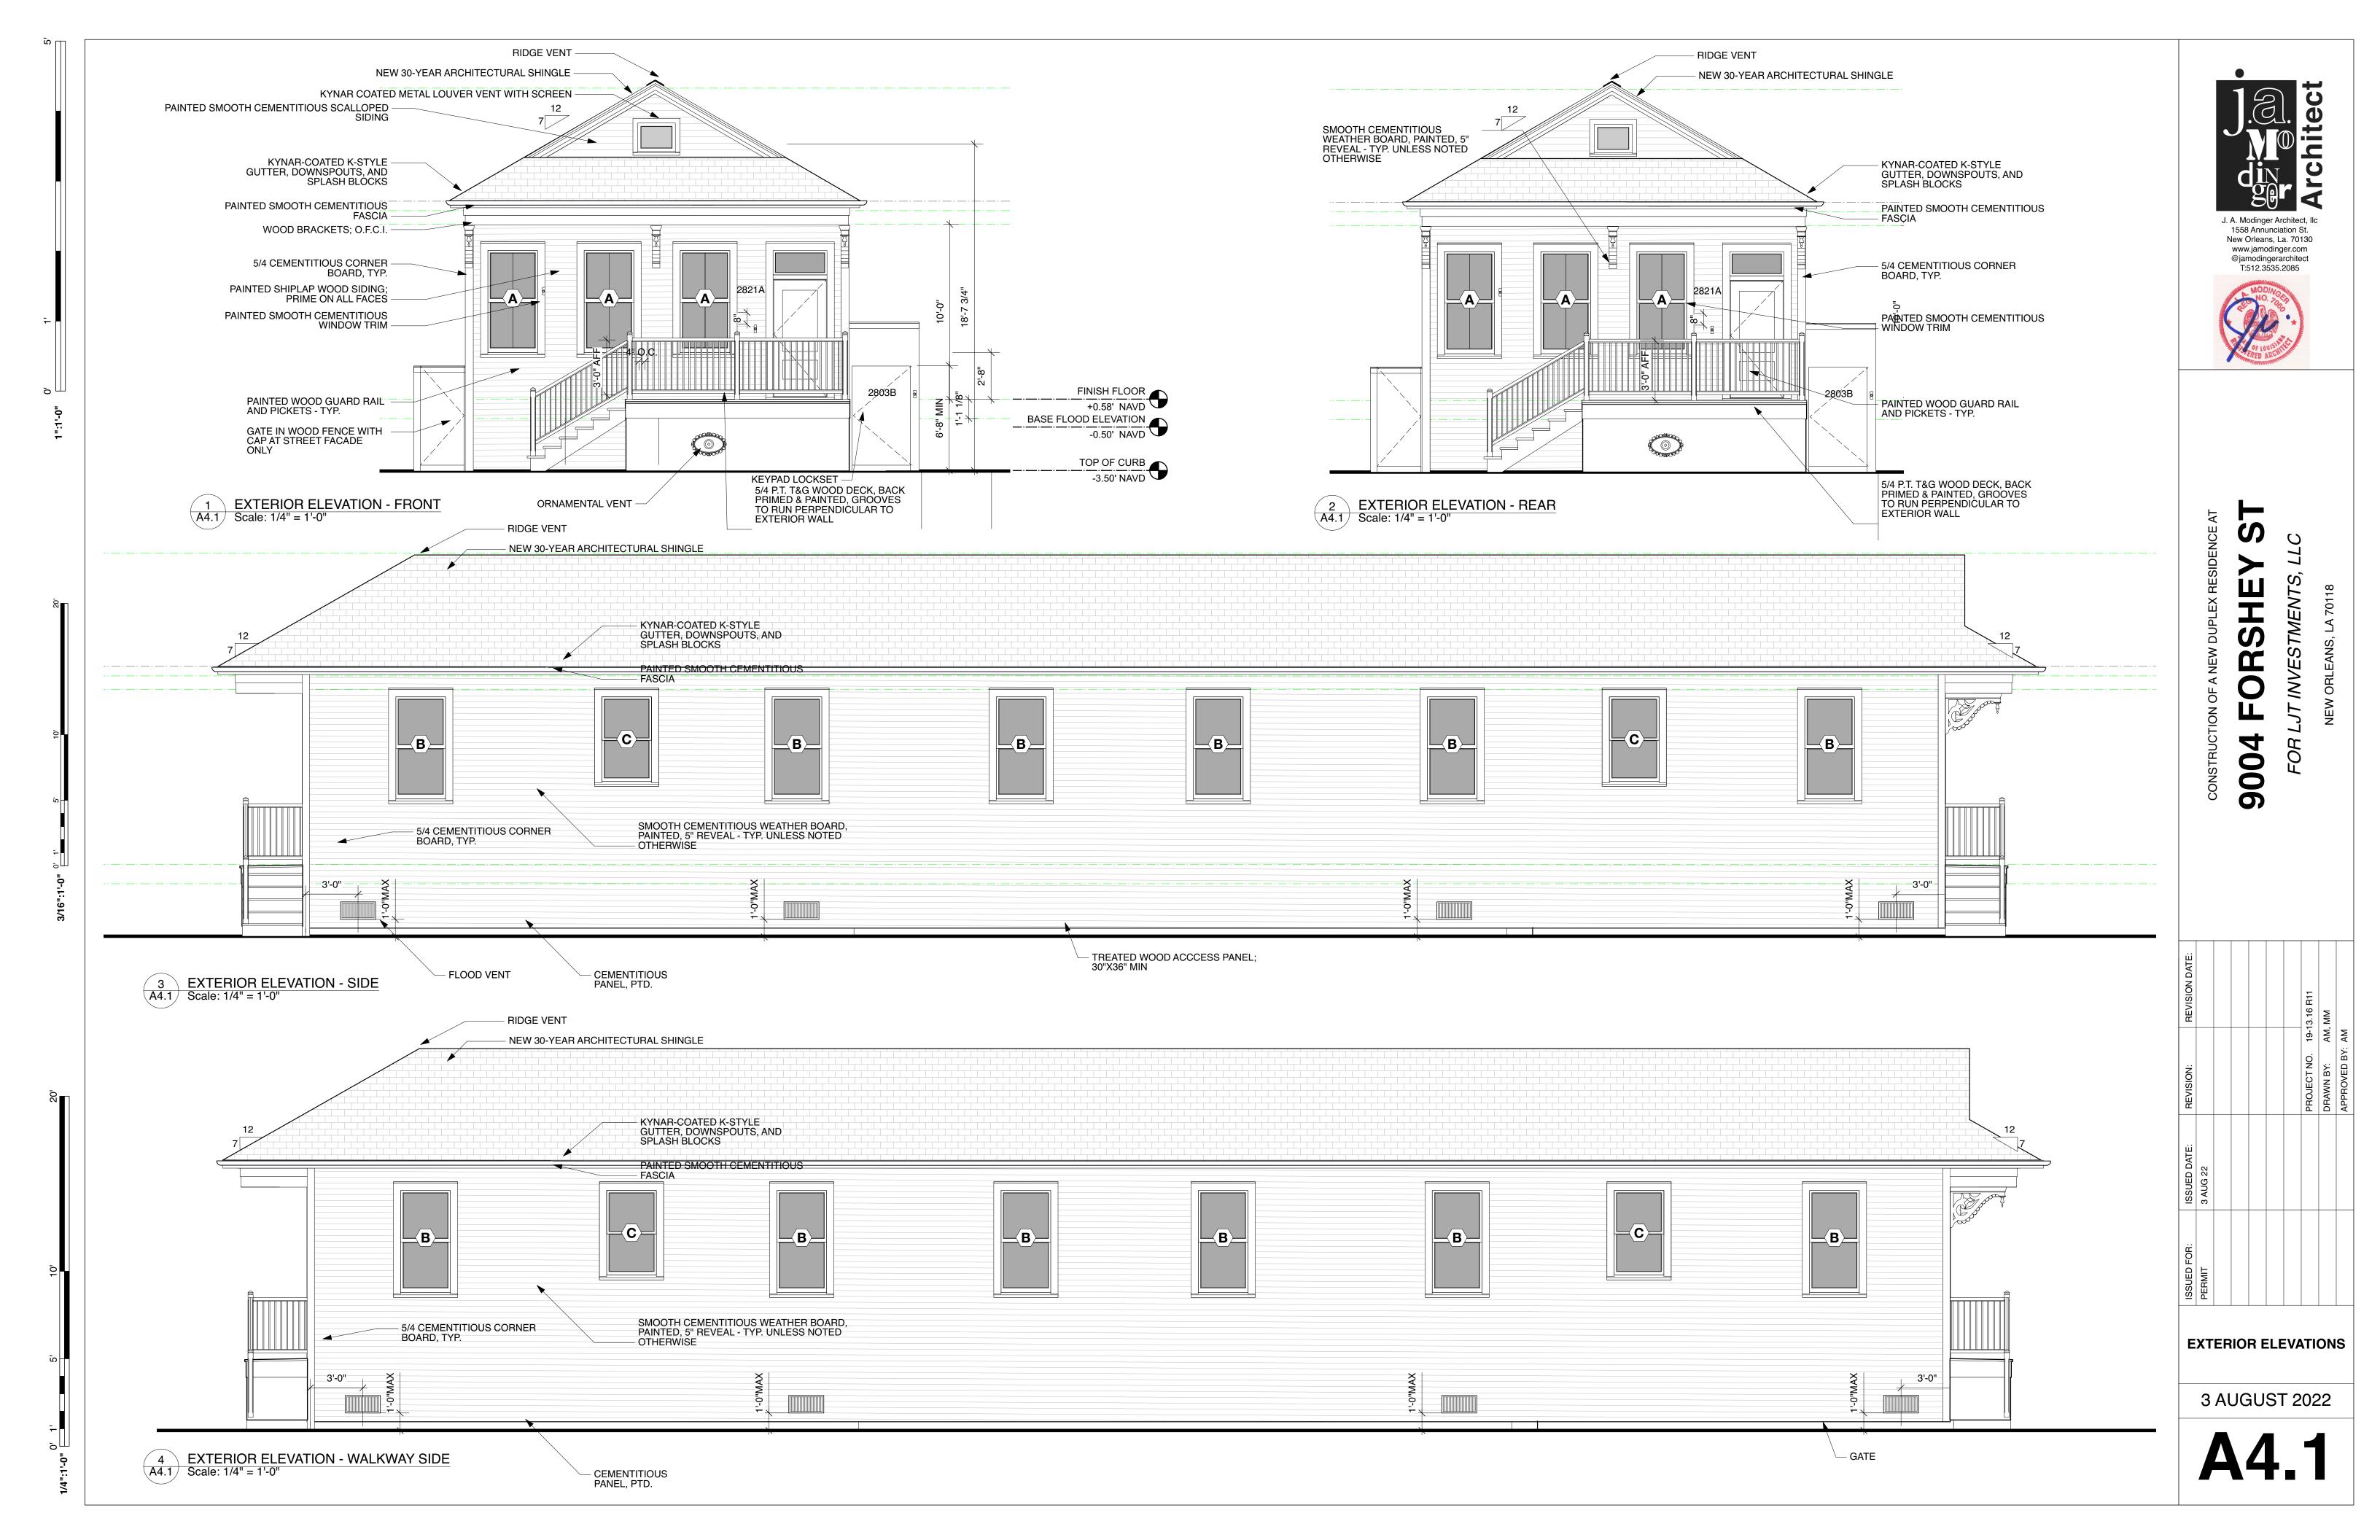
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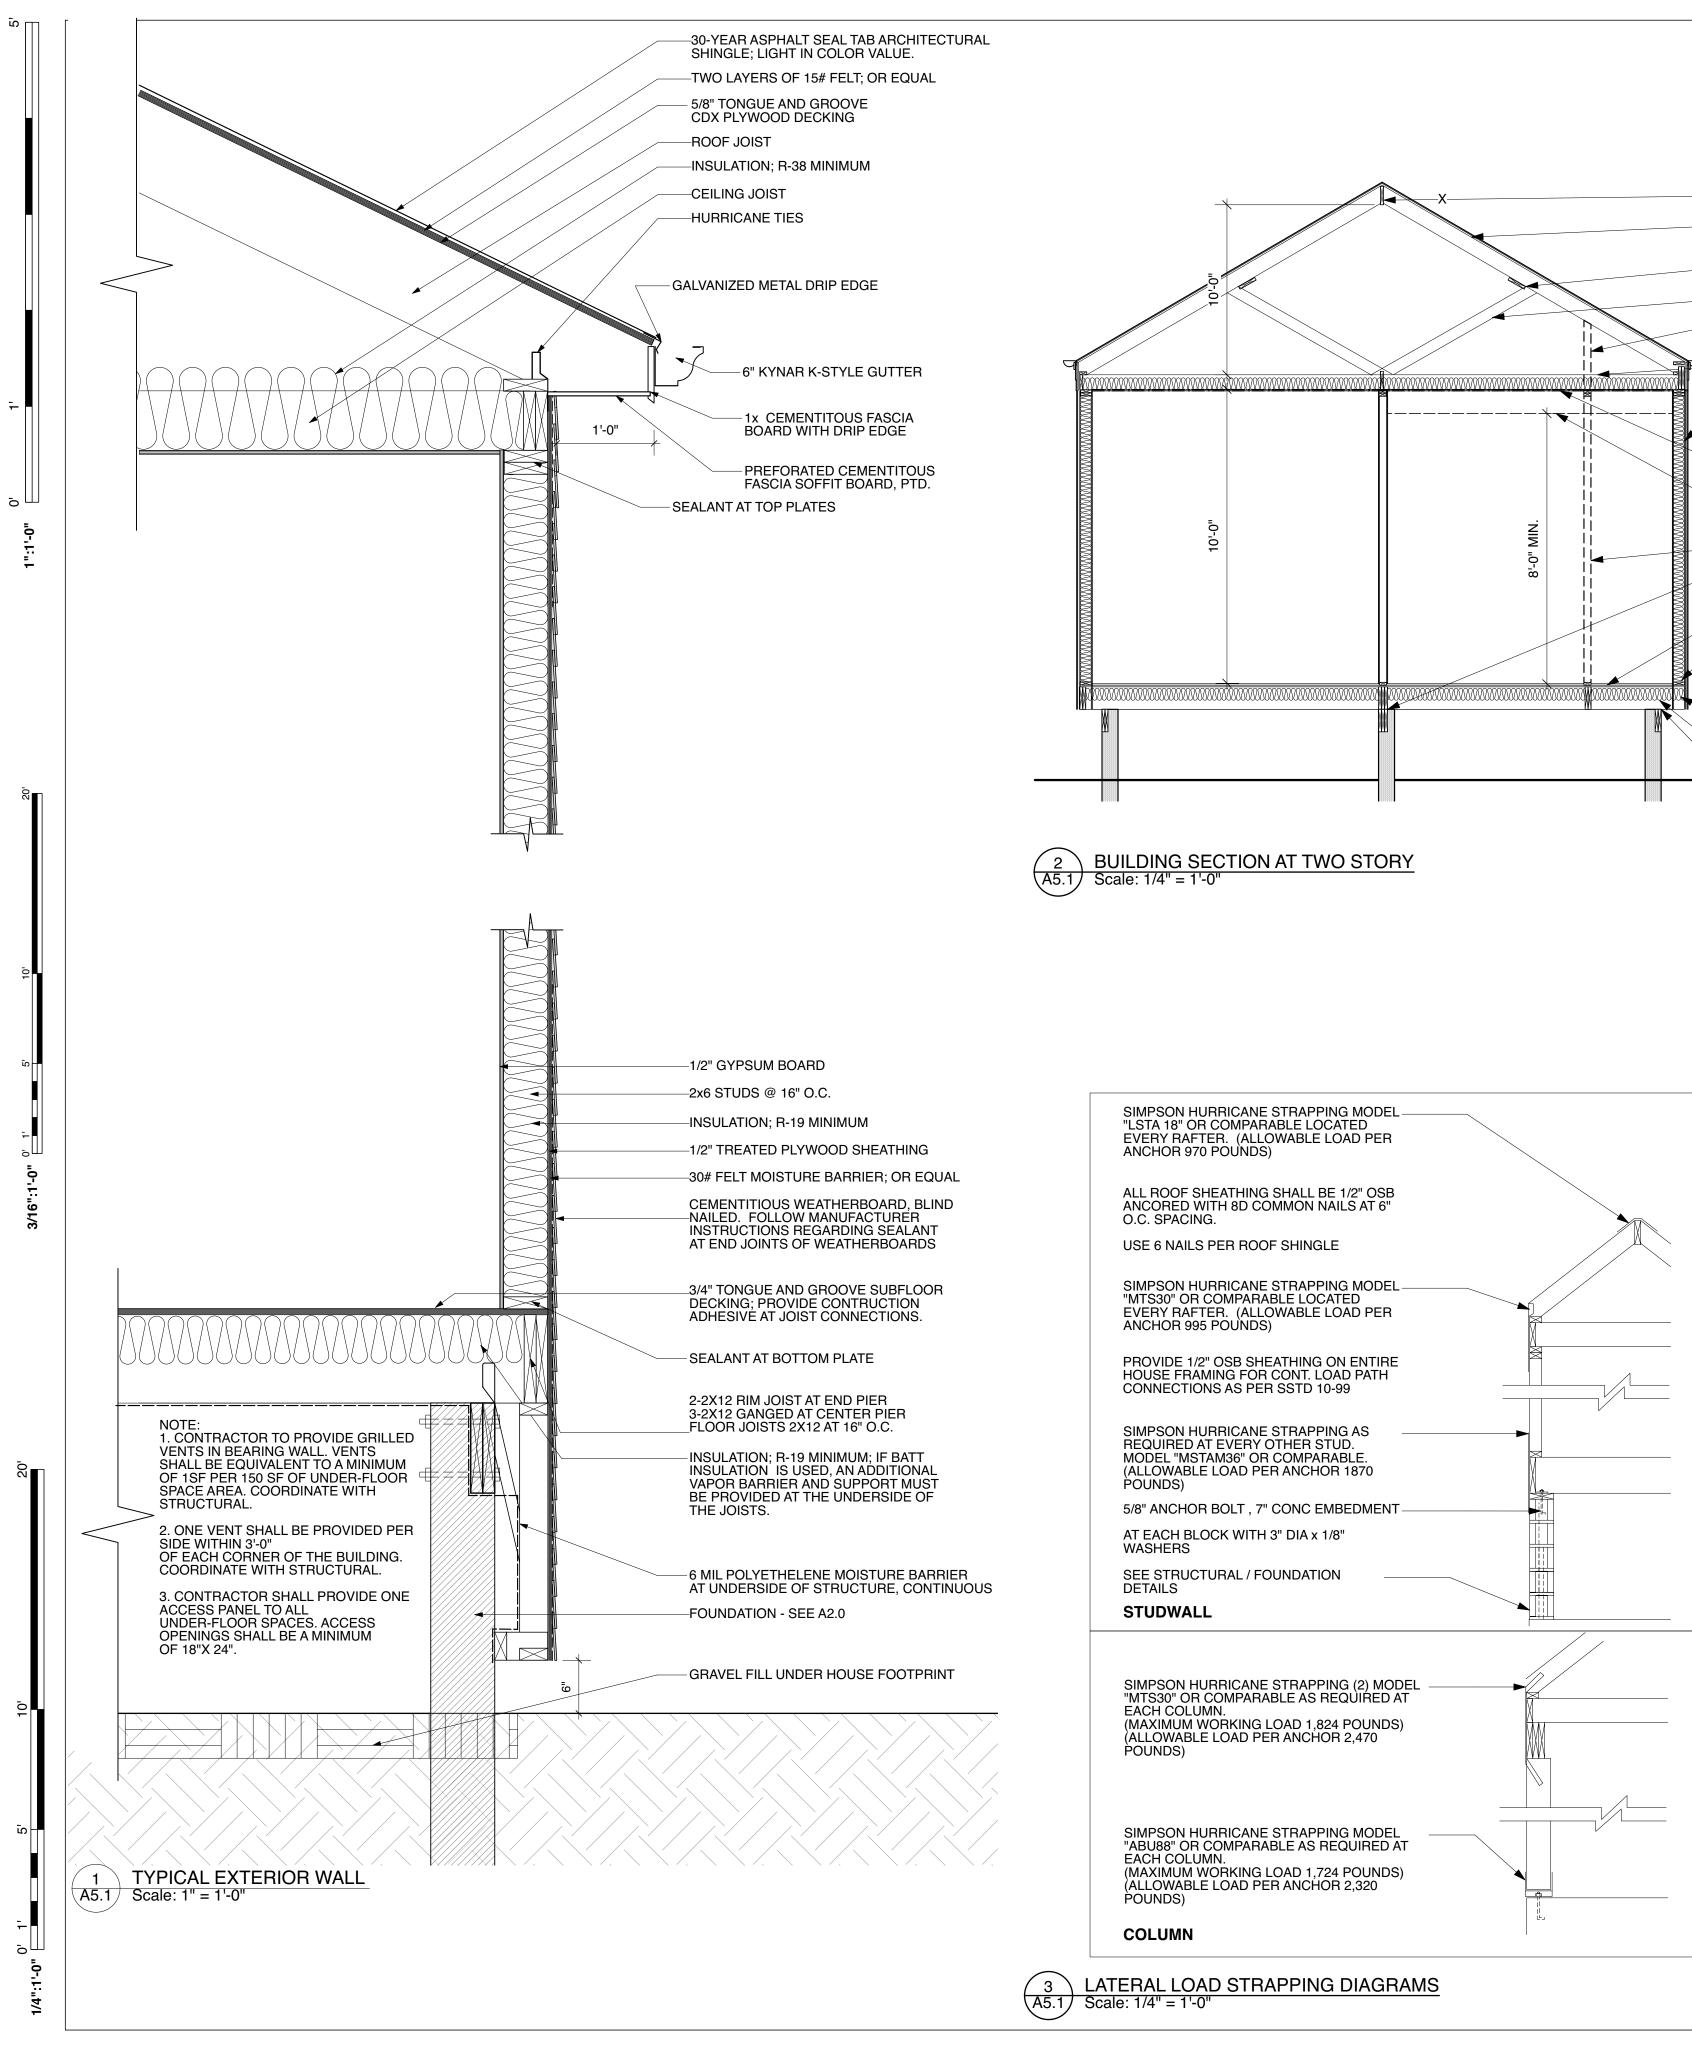












|        | xX | -2x8 RIDGE BEAM   |     |
|--------|----|---|-----|
|        |    | -2x6 ROOF JOIST @ 16" O.C.  | 2.  |
|        |    | 2x6¦CONTINUOUS PURLIN AT<br>SPANS EXCEEDING 13'-0"  | 3.  |
| 10,1   |    | -2x4 STRUT BRACING AT 48" O.C.  |     |
|        |    | -PROVIDE LOAD BEARING KNEE WALL IN ATTIC AT PORCH EXTERIOR WALL<br>WITH CONTINIOUS BOTTOM PLATE AND CONTINIOUS DOUBLE TOP PLATE.                | 4.  |
|        |    | -2x6 CEILING JOISTS @ 16" O.C.  |     |
|        |    | -2X4 WOOD STUDS AT 16" O.C.   | 5.  |
|        |    | -MAINTAIN CONTINUOUS ONE HOUR FIRE<br>SEPARATION AT FLOOR PER UL#L501<br>-UNRATED FURR DOWN FOR HVAC  | 6.  |
| 10'-0" |    | AND VENT LINES; SEAL ALL<br>PENETRATIONS OF RATED BARRIER ABOVE<br>-STUD WALL AT PORCH<br>3-2x10 FLOOR JOISTS @ INTERIOR<br>BEARING WALLS, TYP. | 7.  |
| ,      |    | 3/4" TNG PLYWOD SUB FLOOR; GLUED<br>AND MECHANICALLY FASTENED<br>-2x4 BOTTOM PLATE  | 8.  |
|        |    |   | 9.  |
|        |    | -2-2x10 RIM JOIST<br>-2x10 FLOOR JOISTS @ 16" O.C.  | 10. |
|        |    | -2XTO FLOOR JOISTS @ TO O.C.<br>-PROVIDE UPLIFT TIE AT BAND BEAM IF NOTED IN FRAMING PLAN A2.0<br>GRADE   | 11. |

### FRAMING NOTES

1. ALL FRAMING TO COMPLY WITH THE WOOD FRAME CONSTRUCTION MANUAL FOR ONE AND TWO FAMILY DWELLINGS, 2015 ED. AND INTERNATIONAL RESIDENTIAL CODE 2015 ED. UNLESS NOTED OTHERWISE, ALL WOOD CONNECTIONS SHALL BE IN ACCORDANCE WITH THE FASTENING SCHEDULE FO THE INTERNATIONAL BUILDING CODE AND/OR THE CODES REFERENCED THEREIN. ALL LUMBER IN CONTACT WITH CONCRETE OR MASONRY SHALL BE PRESSURE TREATED.

FRAMING LUMBER: SOUTHERN YELLOW PINE NO. 2 DENSE K.D. (15%) OR BETTER, U.N.O

FLOOR FRAMING SHALL BE SIZED AS INDICATED ON FRAMING PLANS. PROVIDE WOOD CROSS BRIDGING WHERE INDICATED ON DRAWINGS OR WHEN JOIST SPAN EXCEEDS EIGHT (8) FEET.

COORDINATE FRAMING LAYOUT WITH HVAC, ELECTRICAL, AND PLUMBING REQUIREMENTS.

5. SUBSTITUTIONS FOR FRAMING SIZE, SPACING GRADE AND SPECIED WITH PERMISSION FROM THE ARCHITECT ONLY.

BORED HOLES SHALL BE 2" CLEAR FROM TOP OR BOTTOM EDGE OF JOIST AND SHALL NOT BE LARGER THAN 1 1/4" IN DIAMETER AND SHALL NOT BE LOCATED IN THE MIDDLE OF A SPAN.

ALL WALL SHEATHING SHALL BE APA STRUCTURALLY RATED SHEATHING. FLOOR AND ROOF SHEATHING SHALL BE APA RATED SHEATHING. SHEATHING SHALL BE NAILED AT 4" O.C. ALONG SUPPORTED PANEL EDGES AND 12" O.C. AT INTERMEDIATE SUPPORTS, WITH 8D COMMON NAIL.

PLYWOOD SUB FLOORING SHALL BE APA RATED 48/24, 3/4" THICK TONGUE AND GROOVE, GLUED AND FASTENED TO FLOOR JOISTS AS INDICATED IN THE BUILDING SECTION, OR EQUAL.

9. PARALLAM JOISTS SHALL HAVE A MIN. E=2,000,000 PSI AND FB OF 2900 PSI.

- 10. THE NUMBER AND SIZE OF NAILS AT ALL WOOD CONNECTIONS SHALL BE PER THE INTERNATIONA RESIDENTIAL CODE 2015 ED. TABLE R602.3(1).
- 11. CONNECTORS SPECIFIED AS "SIMPSON" TYPE ARE TO BE MFR'D BY SIMPSON TIE CO. OR APPROVED EQUAL. COMPLY WITH MFR'S FASTENING PROCEDURES. ALL CONNECTIONS SHALL BE GALVANIZED.
- 12. JOIST HANGERS SHALL BE 16 GAUGE TYPE "U" AS MANUFACTURED BY SIMPSON STRONG TIE, OR EQUAL. INSTALL JOIST HANGERS IN STRICT ACCORDANCE WITH THE MANUFACTURER'S SPECIFICATIONS. USE JOIST HANGERS FOR BEAMS AND JOISTS WHICH FRAME TO BEAMS AT SAME ELEVATION. JOINST HANGERS SHALL BE OF A SIZE APPROPRIATE FOR THE MEMBER SUPPORTED.
- 13. STRAP ALL PLATES CUT AWAY FOR PLUMBING WITH 1 1/2" WIDE, 24 GAUGE GALVANIZED STRAPS 18" LONG, BOTH SIDES OF WALL, SPIKED TO PLATES.
- 14. ALL LUMBER BELOW BASE FLOOD ELEVATION SHALL BE PRESSURE TREATED (P.T.)
- 15. TOP OF FINISH FLOOR SHALL BE AT OR ABOVE BASE FLOOD ELEVATION, TYP (SEE EXTERIOR ELEVATIONS).



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| <b>REVISION DATE:</b> |          |    |    |    |                |   | 9-13.16 R11              | AM          | Z               |
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| REVISION:             |          |    |    |    |                |   | PROJECT NO. 19-13.16 R11 | DRAWN BY: A | APPROVED BY: AM |
| ISSUED DATE:          | 3 AUG 22 |    |    |    |                |   |                          |             |                 |
| ISSUED FOR:           | PERMIT   |    |    |    |                |   |                          |             |                 |
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NEW ORLEANS, LA 70118

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| <b>REVISION DATE:</b> |               |  |  |   |  |  | 13.16 R11                | AM, AG       |                 |  |
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| REVISION:             |               |  |  |   |  |  | PROJECT NO. 19-13.16 R11 | DRAWN BY: AM | APPROVED BY: AM |  |
| ISSUED DATE:          | 3 AUG 22      |  |  |   |  |  |                          |              |                 |  |
| ISSUED FOR:           | PERMIT        |  |  |   |  |  |                          |              |                 |  |
| INTERIOR ELEVATIONS   |               |  |  |   |  |  |                          |              |                 |  |
|                       | 3 AUGUST 2022 |  |  |   |  |  |                          |              |                 |  |
|                       |               |  |  | 6 |  |  |                          |              |                 |  |