DIVISION OF SPECIFICATIONS:

THIS DIVISION OF THE SPECIFICATIONS IS DIVIDED INTO THE FOLLOWING SECTIONS WHICH, WITH THEIR RESPECTIVE SUBSECTIONS, IS FOR CONVENIENCE ONLY AND NOT INTENDED TO ESTABLISH LIMITS OF WORK:

SECTION 26 0500 - COMMON WORK FOR ELECTRICAL

SECTION 26 0501 - ELECTRICAL RELATED WORK SECTION 26 0533 - RACEWAYS AND BOXES FOR ELECTRICAL SYSTEMS

SECTION 26 0519 - LOW VOLTAGE ELECTRICAL POWER CONDUCTORS AND CABLES

SECTION 26 0553 - IDENTIFICATION FOR ELECTRICAL SYSTEMS

SECTION 26 2726 - WIRING DEVICES

SECTION 26 0526 - GROUNDING AND BONDING SECTION 26 2416 - PANELBOARDS

SECTION 26 2816 - ENCLOSED SWITCHES AND CIRCUIT BREAKERS SECTION 28 3111 - FIRE ALARM SYSTEMS SECTION 27 0000 - TELEPHONE/DATA SYSTEM

COMPLY WITH LOCAL AND STATE CODES, OSHA, NEC, TIA, NFPA, IBC REQUIREMENTS, AND NATIONAL CODES.

2. COMPLETELY GROUND ENTIRE ELECTRICAL SYSTEM AS PER NATIONAL ELECTRICAL CODE.

3. APPLY FOR PERMIT AND PAY ALL FEES. PROVIDE FINAL INSPECTION CERTIFICATE.

4. WORKMANSHIP TO MEET NECA. GUIDELINES.

5. PUT INTO OPERATION AND TEST ALL ELECTRICAL EQUIPMENT.

6. PROVIDE COMPLETE INSTALLATION, INCLUDING ALL MINOR ITEMS.

7. ALL ELECTRICAL EQUIPMENT LOCATIONS ARE APPROXIMATE ONLY. FOR ALL MEASUREMENTS, USE ARCHITECTURAL PLANS AND FIELD SURVEYS. COORDINATE WITH AIR CONDITIONING WORK, CABINET WORK, PARTITION WORK, ETC., WHEN REQUIRED.

8. SUBMIT ONE SET OF CLEARLY MARKED REPRODUCIBLE "RECORD" AS-BUILT DRAWINGS FOR ALL WORK, INDICATING CHANGES MADE DURING CONSTRUCTION. SUBMIT TO ARCHITECT FOR OWNER'S RECORD FILE. INSURE THAT ALL CIRCUITRY IS SHOWN AS WIRED IN THE FIELD, TO INCLUDE ACCURATE HOMERUN DESIGNATIONS.

9. UNLESS OTHERWISE NOTED ON THE DRAWINGS OR REQUIRED BY THE ARCHITECT. THE FOLLOWING MOUNTING HEIGHTS (CENTERLINE ABOVE FINISHED FLOOR) SHALL APPLY:

> TOGGLE SWITCHES 4'-0" RECEPTACLES TELEPHONE/DATA/FIBER OPTIC OUTLETS

UPON APPROVAL OF THE ARCHITECT, MOUNTING HEIGHTS MAY BE ADJUSTED. LENGTH OF RECEPTACLES SHALL RUN VERTICALLY. DO NOT MOUNT OUTLETS BACK TO BACK ON OPPOSITE SIDES OF WALLS.

10. BIDDER'S SHALL VISIT THE SITE OF THE PROPOSED WORK TO UNDERSTAND THE COMPLEXITY, RESTRICTIONS, AND ALL THE REQUIREMENTS TO PERFORM WORK OF THESE DOCUMENTS IN SAID FACILITY. NO ADDITIONAL COMPENSATION SHALL BE ALLOWED TO THE SUCCESSFUL BIDDER FOR FAILURE TO BE SO INFORMED.

11. SEAL ALL FLOOR, DEMISING WALL, AND FIRE WALLS WITH 3M FIRE PROOF PUTTY OR OWNER APPROVED EQUAL. ALL FIRE PROOFING SHALL BE CERTIFIED.

12. ALL WORK IN FLOOR SLABS INCLUDING CORING, CHOPPING OR CHASING SHALL BE PROPOSED TO THE OWNER AND WRITTEN PERMISSION GRANTED BEFORE ACTUAL PERFORMANCE. X-RAY ALL PENETRATIONS. AFTER HOURS WITH A BUILDING ENGINEER PRESENT. CONTRACTOR SHALL HIRE MORPHY MAKOFSKY (JON SOFRANKO 504-488-1317) TO APPROVE X-RAYS AND INCLUDE PRICE IN THIS CONTRACT. NO CHASING OF SHAFT WALLS SHALL BE PERMITTED.

SECTION 26 0501 - ELECTRICAL RELATED WORK

1. ALL DRILLING OF FLOORS SHALL BE PERFORMED AFTER NORMAL WORKING HOURS BETWEEN 5:00 P.M. AND 6:00 A.M.).

2. WIRING FOR HVAC: BRING POWER TO HVAC EQUIPMENT AND DUCT HEATERS. INSTALL STARTERS WHERE REQUIRED. STARTERS, FIRESTATS AND CONTROL WIRING FURNISHED UNDER MECHANICAL SECTION. FRACTIONAL STARTERS TO BE SUPPLIED UNDER THIS SECTION.

SECTION 26 0533 - RACEWAYS AND BOXES FOR ELECTRICAL SYSTEMS

1. ALL CONDUITS FROM MECHANICAL AND ELECTRICAL ROOMS INTO TENANT SPACE SHALL BE EMT.

2. ALL CIRCUIT HOMERUNS SHALL BE EMT. EMT SHALL BE USED, AT A MINIMUM, UP TO THE FIRST DEVICE (WITHIN 15') THE CIRCUIT SERVES.

3. MC CABLE SHALL BE USED IN TENANT SPACE EXISTING WALLS. MC CABLE WHIPS SHALL BE USED FOR CONNECTIONS TO LIGHT FIXTURES AND TO ALL VIBRATING EQUIPMENT. MC CABLE MAY BE USED BETWEEN DEVICES ON THE SAME CIRCUIT WITH A MAXIMUM LENGTH OF 40'.

4. MC CABLE SHALL NOT BE USED ABOVE HARD AND/OR INACCESSIBLE CEILINGS.

5. WHIPS TO LIGHT FIXTURES SHALL BE GIVEN ENOUGH SLACK SUCH THAT THE FIXTURE MAY MOVE 1 CEILING TILE IN ANY DIRECTION.

6. ALL CONDUITS MOUNTED IN CEILING SPACE SHALL BE AS CLOSE AS POSSIBLE TO BEAMS AND/OR SLAB ABOVE. ALL JUNCTION BOXES IN CEILING CAVITY TO BE MOUNTED TO STRUCTURE.

7. ALL DEVICE JUNCTION BOXES TO BE METAL MIN. 4" X 4" WITH PLASTER

8. MOUNT ALL BOXES USING UTILITY BRACKETS. IN EXISTING WALLS, USE "REWORK" BOXES. "F" CLIPS ARE NOT ALLOWED.

9. SUPPORT ALL CONDUIT AND PLENUM RATED WIRING FROM BEAMS USING BEAM CLAMPS. CONDUIT OR WIRE SUPPORTED FROM CEILING GRID SUPPORTS IS NOT

10. LABEL CONDUITS FOR POWER, LIGHTING, FIRE ALARM AND TELEPHONE/DATA. LABEL ALL JUNCTION BOXES WITH CIRCUIT DESIGNATIONS.

11. USE ANTI-SHORTING BUSHINGS WITH MC CABLE.

12. USE SET SCREW FITTINGS WITH EMT.

SECTION 26 0519 - LOW VOLTAGE ELECTRICAL POWER CONDUCTORS AND CABLES

1. ALL WIRING SHALL BE #12 UNLESS OTHERWISE NOTED. ALL CONDUCTORS SHALL BE COPPER. SIZES #10 AND SMALLER TO BE THWN/THHN, LARGER SIZES THW, THWN/THHN. ALL FINAL CONNECTIONS TO WIRING DEVICES WITH SCREW TERMINALS (SWITCHES, RECEPTACLE, ETC.) SHALL BE MADE WITH SOLID

SECTION 26 2726 - WIRING DEVICES

1. WIRING DEVICES ARE TO BE LEVITON OR APPROVED EQUAL SPEC GRADE WIRING DEVICES AS FOLLOWS:

A. WALL SWITCHES TO BE QUIET TYPE, BACK-AND-SIDE WIRED, 120-277 VOLTS A.C., 20-AMPERES. SINGLE-POLE: NO. 1221. THREE-POLE: NO. 1223. SWITCHES, WHEN MOUNTED ADJACENT TO ONE ANOTHER, SHALL BE GANGED TOGETHER WITH SINGLE MONOLITHIC COVER PLATE. CONVENIENCE OUTLET RECEPTACLES TO BE BACK-AND-SIDE WIRED,

20-AMPERES, 125 VOLTS, 2-POLE, 2-WIRE, GROUNDING TYPE. DUPLEX: NO. 5362. GROUND FAULT INTERRUPTER DUPLEX: NO. 6598.

CONTRACTOR SHALL SUBMIT COLOR SAMPLES FOR APPROVAL BY ARCHICTECT FOR ALL DEVICES AND DEVICE COVER PLATES PRIOR TO ORDERING. COVER PLATES TO MATCH EXISTING.

2. DIMMERS SHALL BE AS FOLLOWS:

DIMMERS SHALL BE LUTRON DIMMERS OR EQUAL, COLOR PER ARCHITECT WITH MATCHING COVER PLATE. WHEN DIMMERS ARE MOUNTED ADJACENT TO SWITCHES THEY SHALL BE GANGED TOGETHER WITH SINGLE MONOLITHIC COVER PLATE. DIMMERS SHALL BE AS FOLLOWS:

WHEN DIMMING AN INCANDESCENT 120V FIXTURE: NT-SERIES DIMMER. WHEN DIMMING A 0-10V FIXTURE: DVSTY SERIES DIMMER WHEN DIMMING AN ELECTRONIC LOW VOLTAGE FIXTURE: DVELY SERIES

WHEN DIMMING WITH ROOM CONTROLLER: WATTSTOPPER LMDM-101

3. OCCUPANCY SENSORS SHALL BE AS FOLLOWS:

WALL MOUNTED: DUAL TECHNOLOGY, ULTRASONIC/INFARED.

CEILING MOUNTED: DUAL TECHNOLOGY, ULTRASONIC/INFARED. PROVIDE POWER PACKS AS NECESSARY FOR DEVICE.

CONTRACTOR SHALL SUBMIT COLOR SAMPLES FOR APPROVAL BY ARCHITECT FOR DEVICE AND DEVICE COVER PLATES PRIOR TO ORDERING.

SECTION 26 0553 - IDENTIFICATION FOR ELECTRICAL SYSTEMS

1. IDENTIFY ALL ELECTRICAL EQUIPMENT AND CONTROLS, NEW AND EXISTING, WITH LAMINATE TAG WITH DOUBLE STICK TAPE.

2. PROVIDE TYPEWRITTEN PANEL BOARD DIRECTORY IN BOTH NEW AND EXISTING PANELBOARDS. TYPE THE REVISION DATE ON THE DIRECTORY CARD. INFORMATION SHALL CONSIST OF TENANT NAME/ROOM NUMBER/TYPE OF CIRCUIT, IE. OUTLETS, COPIER, ETC.

SECTION 26 0526 - GROUNDING AND BONDING

RUN SEPARATE GROUND WIRE IN ALL BRANCH CIRCUITS AND FEEDER CIRCUITS. SIZE GROUND WIRE PER NEC TABLE 250-95. INCREASE CONDUIT SIZE ACCORDINGLY.

SECTION 26 2416 - PANELBOARDS

BRANCH CIRCUITS ABANDONED DURING DEMOLITION SHALL BE REMOVED FROM THE SPACE TO THE PANELBOARD. PLUG HOLES IN PANEL WITH PLATED STEEL SNAP-IN BLANKS.

SECTION 26 2816 - ENCLOSED SWITCHES AND CIRCUIT BREAKERS

1. FUSES:

FUSES 600 AMPERES AND BELOW TO BE BUSS, U.L. CLASS RK1, TYPE FRS-R FOR 208-VOLT CIRCUITS. EQUAL BY LITTELFUSE.

2. CIRCUIT BREAKER REQUIREMENTS:

OPERATING MECHANISM TO BE TRIP FREE OPERATION ON ABNORMAL OVERLOADS OR SHORT CIRCUITS, QUICK-BREAK CONTACT MOVEMENT UNDER MANUAL AND AUTOMATIC OPERATION. TRIPPING ELEMENTS THAT WILL NOT TRIP BREAKER ON HARMLESS MOMENTARY OVERLOADS BUT ENSURE ADEQUATE CIRCUIT PROTECTION. INSTANTANEOUS MAGNETIC TRIP ELEMENTS FOR RAPID INTERRUPTION OF SHORT-CIRCUIT CURRENTS. STATIONARY AND MOVING CONTACTS TO BE NON-WELDING SILVER ALLOY, ADEQUATELY PROTECTED FOR USE OF "DE-ION" ARCH QUENCHER. AUTOMATIC TRIPPING TO BE INDICATED BY HANDLE ASSUMING MIDPOINT POSITION BETWEEN MANUAL. ON AND OFF POSITIONS. TRIP SETTING TO BE INDICATED ON BREAKER HANDLE OR BREAKER CASE. ON MULTI-POLE BREAKERS, THE OVERLOAD ON ANY ONE POLE SHALL OPEN ALL POLES SIMULTANEOUSLY. HANDLE TIES ARE NOT ACCEPTABLE. BREAKER CONNECTIONS TO PANELBOARDS SHALL BE OF THE SAME MANUFACTURER AND SAME VOLTAGE, AIC, RATINGS AND SERIES.

SECTION 28 3111 - FIRE ALARM SYSTEMS

1. PROVIDE ALL NEW COMPONENTS AS SPECIFIED HEREIN. COORDINATE FIRE ALARM INSTALLATION WITH ITS FIRE ALARM. FINAL CONNECTIONS, TESTING AND UPDATING OF BUILDING SYSTEM WIRING DIAGRAM TO BE PERFORMED BY ITS FIRE ALARM AND ALL ASSOCIATED COST FOR THIS WORK SHALL BE INCLUDED IN THIS CONTRACT.

CABLE SHALL BE PLENUM RATED WITH FIREMAN'S RED INSULATION. PROVIDE NEW PLENUM RATED CABLE FOR EXISTING/RELOCATED DEVICES THAT HAVE NON-PLENUM RATED CABLE.

3. PROVIDE CONDUIT FOR ALL CABLING SERVING DEVICES IN GYPSUM CEILINGS AND HARD CEILINGS. CABLE IN ACCESSIBLE CEILING MAY BE RUN DIRECTLY IN PLENUM AND SHALL BE SUPPORTED INDEPENDENTLY FROM CEILING SYSTEM SUPPORTS, OR HVAC EQUIPMENT/SUPPORTS.

4. STROBE DEVICES SHALL BE MOUNTED TO LOW VOLTAGE MOUNTING BRACKET.

COMPONENTS INCLUDE THE FOLLOWING: SPEAKER - WHEELOCK E60 SERIES (CEILING MOUNTED)

STROBE - WHEELOCK STWC SERIES SPEAKER/STROBE - WHEELOCK E60 SERIES

AREA SMOKE DETECTOR - SYSTEM SENSOR 2151 SERIES

E. STROBE SYNCH MODULE - WHEELOCK DSM SERIES

5. ANY EXISTING DEVICE THAT IS RELOCATED, OR TEMPORARILY MOVED SHALL BE TESTED BY ITS FIRE ALARM. ASSOCIATED COST INCLUDED IN THIS CONTRACT.

6. FIELD VERIFY THE EXISTING FIRE ALARM STROBE AND SPEAKER WIRING IS OF SUFFICIENT SIZE TO HANDLE THE NEW STROBES AND SPEAKERS TO BE INSTALLED.

7. PROVIDE AS-BUILT DRAWINGS.

8. ALL SHOP DRAWINGS WITH CALCULATIONS SHALL BE SUBMITTED TO THE STATE FIRE MARSHALL OFFICE AND PAID FOR UNDER THIS CONTRACT. PROVIDE "CERTIFICATE OF COMPLETION" TO BUILDING MANAGEMENT. AFTER THE INSTALLATION HAS BEEN COMPLETED AND TESTED. FIRE ALARM SYSTEM SHALL BE COMPLETED AND TESTED BY THE FINAL PROJECT OBSERVATION.

SECTION 27 0000 - TELEPHONE/DATA SYSTEM

1. TELEPHONE/DATA SWITCHING EQUIPMENT SHALL BE LOCATED IN THE TENANT SPACE ONLY. UNLESS NOTED OTHERWISE ON THE PLANS THE TELEPHONE SWITCHING EQUIPMENT IS NOT A PART OF THIS CONTRACT.

TELEPHONE/DATA OUTLETS INDICATED ARE TO BE FLUSH MOUNTED 4"X4" OUTLET BOXES WITH 1-GANG P.R. FURNISH 3/4 IN. CONDUIT AND PULL STRING FROM OUTLET BOX TO ABOVE CEILING FOR WIRE INSTALLATION BY

3. TELEPHONE/DATA WIRE SHALL BE PLENUM RATED. TENANT TO SUBMIT CERTIFICATION OF PLENUM RATING OF CABLE USED. UNLESS NOTED OTHERWISE TELEPHONE WIRING IS NOT A PART OF THIS CONTRACT.

END OF SPECIFICATIONS

ABOVE COUNTER

ABBREVIATIONS

48. FACP FIRE ALARM CONTROL PANEL

	ACCU	AIR COOLED CHILLER UNIT	49. FARA	FIRE ALARM REMOTE ANNUCL
	ACR	ACRYLIC	50. FIN	FINISH
	AFF	ABOVE FINISHED FLOOR	51. FL	FLUORESCENT
	AHU	AIR HANDLING UNIT	52. FLR	FLOOR
	AL	ALUMINUM	53. FS	FUSIBLE SWITCH
	ASYMM	ASYMMETRICAL	54. GA	GAUGE
	AV	ALIDIO AVISLIAI	55. GSKT	GASKET OR GASKETED
	BCI I	BLOWER COIL LINIT	56. GFI	GROUND FAULT INTERRUPTER
١	BIK	BLACK COIL OWN	57 GND G	GROUND
٠.	BAS	BUILDING AUTOMATION SYSTEM	58 GUH	GAS UNIT HEATER
·	C	CONDUIT	59. HWP	HEATING HOT WATER PUMP
	CFI	COMPACT FLOURESCENT	60. HID	HIGH INTENSITY DISCHARGE
L	CHMD	CHILLED WATER DIMP	61 HOUSE	HOUSING
	CI	CENTEDI INF	62 IWRP	ICE WATER BUILDER PUMP
,. :	CLC	CELLING	63 LCP	LIGHTING CONTROL PANEL
,. ,	CLG	CI EAD	64 I IN	LINFAR
	CMI	CEDANIC METAL HALIDE	65 MAII	MAKE-LIP AIR LINIT
'. `	COMM	COMMUNICATIONS	66 MH	METAL HALIDE
٠.	COMM	CONTINUOUS	67 MNT	MOUNT
). I	CONT	CIRCUI ATION DUMP	68 MSB	MAIN SWITCHROARD
۱. ک	CP	CONTROL DANEL	60 MTI	METAL
Ĺ.	CPI	COLOR DEVIDEDING INDEX	70 NI	NIGHT LIGHT
). I	CRI	COLD BOLLED STEEL	70. NE 71 PENINT	DENIDANT
t.	CKS	CDOS SECTION	71. FENDI	DEDECIDATED
). :	CS	COOLING TOWER	73. POLYCE	POLYCAPRONATE
). 7	CTD	COULING TOWER	73. POLICE	POWDER
	CTC	CLIDDENT TRANSFORMERS	75. PFFI	PEEL ECTOR
). \	CIS	CONDENSING LINIT	75. NEI E	DECLUBED.
, \	CWB	CONDENSED WATER DUMP	70. KEQ D	REQUIRED PICID CALVANIZED STEEL
J.	CWP	DUDLEY CONVENIENCE OUTLET	77. KGS	CINCLE CONVENIENCE OUTLE
	DCO	DEDICATED	70. SUU	SUBFACE MOUNT
•	D //	DEDICATED	79. SM	SURFACE MOUNT
١.	D/I	DIRECT/INDIRECT	0U. SF	SUPPLI FAN
ŀ.	DRL	DOUBLE DOUBLE	OI. SPEC	SPECIFICATION OR SPECULAR
).	DFA	DOMN LYOW ABOVE	02. 33 97 CTI	STAINLESS STEEL
).	DIFF	DIFFUSER	OJ. SIL	TRANSFORMER
۲.	DMPR	DAMPER	O4. IFMK	TAMBED DESIGNANT
5.	DN	DOWN	85. IK	TAMPER RESISTANT
).	EDH	ELECTRIC DUCT HEATER	00. ITP	HALLEC OTHERWICE MOTER
).	Er -	EXHAUSI FAN	O7. UUN	VEDTICAL
١.	EL	ELEVATION ABOVE FINISHED FLOOR	OO. VEKI	VERTICAL
<u>′</u> .	LM CO	EMERGENCY OPERATION	09. VI2	WIDELESS ACCESS DOINT
١.	EQ	EQUAL	90. WAP	WATER LIFATER
ŀ.	EQUIV	EQUIVALENT	SI. WH	WAILK MEAILK
).	EX	EXISTING	92. WHI	WHILE PROCE
Š.	EXTRD	EXTRUDED	93. WP	WEATHER PROOF
7.	FAC	AIR COOLED CHILLER UNIT ACRYLIC ABOVE FINISHED FLOOR AIR HANDLING UNIT ALUMINUM ASYMMETRICAL AUDIO/VISUAL BLOWER COIL UNIT BLACK BUILDING AUTOMATION SYSTEM CONDUIT COMPACT FLOURESCENT CHILLER WATER PUMP CENTERLINE CEILING CLEAR CERAMIC METAL HALIDE COMMUNICATIONS CONTINUOUS CIRCULATION PUMP CONTROL PANEL COLOR RENDERING INDEX COLD ROLLED STEEL CROSS SECTION COOLING TOWER CENTER CURRENT TRANSFORMERS CONDENSING UNIT CONDENSER WATER PUMP DUPLEX CONVENIENCE OUTLET DEDICATED DIRECT/INDIRECT DOUBLE DOWN FROM ABOVE DIFFUSER DAMPER DOWN ELECTRIC DUCT HEATER EXHAUST FAN ELEVATION ABOVE FINISHED FLOOR EMERGENCY OPERATION EQUAL EQUIVALENT EXISTING EXTRUDED FIRE ALARM CABINET		

REFERENCE NOTES - ELECTRICAL

CONNECT TO NEAREST AVAILABLE 277V NORMAL LIGHTING CIRCUIT. LOAD SHALL NOT EXCEED 3500VA ON CIRCUIT.

2 CONNECT TO NEAREST AVAILABLE 2... LOAD SHALL NOT EXCEED 3500VA ON CIRCUIT. CONNECT TO NEAREST AVAILABLE 277V EMERGENCY LIGHTING CIRCUIT.

RUN EACH HOME RUN INDICATED TO A 20A, 1P, 120 VOLT CIRCUIT BREAKER IN 120V PANEL SERVING FLOOR. PROVIDE CIRCUIT BREAKER IN PANELBOARD IF REQUIRED.

 $\langle 4 \rangle$ existing circuit homerun to remain. See general note #3 on POWER SHEET

PROVIDE RED COLORED LIGHT SWITCH WITH LIGHTED HANDLE WHEN SWITCH IS OFF.

(6) COORDINATE AND CONNECT VIA BUILDING LIGHTING CONTROL PANEL ADJACENT TO SCHEDULED LIGHTING PANEL. ADD NECESSARY RELAYS AND PROGRAMMING. ALL LIGHTING CONTROL PROGRAMMING SHALL BE DONE BY COMPUTROLS PER BUILDING ENGINEER'S INSTRUCTIONS.

PROVIDE 40A/1P CIRCUIT BREAKER IN EXISTING 277/480V PANEL AND ROUTE 2 #8'S AND 1 #10 GROUND, 3/4"C TO NEW CIRCUIT BREAKER AND CONNECT THERETO.

(8) PROVIDE 20A/1P CIRCUIT BREAKER IN EXISTING 277/480V PANEL AND ROUTE 2 #12'S AND 1 #12 GROUND, 1/2"C TO NEW CIRCUIT BREAKER AND CONNECT THERETO.

CONNECT TO EXISTING ADEQUATE 480V, 3 PHASE CIRCUIT SERVING VAV'S

GENERAL NOTES:

1. DEMOLITION: PRIOR TO STARTING DEMOLITION CONFER WITH THE BUILDING ENGINEER FOR GENERAL INSTRUCTIONS.

A. REMOVE ALL EXISTING DEVICES NOTED ON THE PLAN TO BE REMOVED. REMOVE ALL EXISTING DEVICES IN WALLS TO BE DEMOLISHED. REMOVE ALL FLOOR BOXES NOT SCHEDULED TO BE REUSED. REMOVE ALL ASSOCIATED CONDUIT AND WIRING. PROVIDE ADDITIONAL CONDUIT AND WIRING NECESSARY TO MAINTAIN CIRCUIT CONTINUITY TO EXISTING DEVICES, FIXTURES, ETC. ON THE SAME CIRCUIT THAT ARE

REMOVE ALL EXISTING CONDUIT, WIRING, AND JUNCTION BOXES LOCATED IN AREAS THAT WILL HAVE NEW GYPSUM AND HARD CEILINGS INSTALLED.

PROVIDE NEW CIRCUITRY TO EXISTING FIXTURES IN SPACE NOT INCLUSIVE OF THE TENANT SPACE RENOVATION BUT IS PRESENTLY SERVICED FROM THE AREA TO BE

D. TURN ALL FIXTURES TO BE REMOVED AND NOT REUSED OVER TO THE OWNER IN GOOD CONDITION AND WORKING ORDER.

REMOVE TELEPHONE CABLES NOTED TO BE DEMOLISHED BACK TO THE TENANT MAIN NET/PHONE CLOSET BACKBOARD. TENANT TELEPHONE CABLES TO BE CUT AT SLAB LEVEL IF IT RISES TO THE FLOOR ABOVE OR BELOW. CONTACT BUILDING MANAGEMENT PRIOR TO CUTTING CABLES.

REMOVE DATA CABLES NOTED TO BE DEMOLISHED BACK TO THE TENANT MAIN NET/PHONE BACKBOARD. TENANT DATA CABLES TO BE CUT AT SLAB LEVEL IF IT RISES TO THE FLOOR ABOVE OR BELOW. CONTACT BUILDING MANAGEMENT PRIOR TO CUTTING CABLES.

G. REMOVE ALL FIRE ALARM DEVICES AND WIRING NOTED TO BE REMOVED AND/OR NOT SHOWN TO REMAIN OR BE RELOCATED. REMOVE ALL ASSOCIATED CONDUIT AND WIRING. PROVIDE ADDITIONAL CONDUIT AND WIRING NECESSARY TO MAINTAIN CIRCUIT CONTINUITY TO EXISTING DEVICES.

REMOVE ALL ABANDONED ELECTRICAL EMT AND CONDUIT.

REMOVE ALL OLD HANGERS. REMOVE EXISTING FURNITURE SYSTEM POWER. REMOVE ALL ASSOCIATED CONDUIT AND WIRING. PROVIDE ADDITIONAL CONDUIT AND WIRING NECESSARY TO MAINTAIN CIRCUIT CONTINUITY TO EXISTING ELECTRICAL ON THE SAME CIRCUIT THAT IS TO

2. WHERE EXISTING OUTLETS ARE SHOWN TO REMAIN, BUT ARE INDICATED WITH NEW CIRCUITRY PERFORM THE FOLLOWING:

REMOVE EXISTING CIRCUITRY IN ITS ENTIRETY BACK TO SOURCE. PROVIDE ADDITIONAL CONDUIT AND WIRING NECESSARY TO MAINTAIN CIRCUIT CONTINUITY TO EXISTING DEVICES ON THE SAME CIRCUIT THAT ARE NOT TO BE RE-CIRCUITED.

B. PROVIDE NEW RECEPTACLE. C. RE-CIRCUIT DEVICES AS SHOWN.

3. CONTRACTOR IS TO DETERMINE ALL EXISTING AND NEW DEVICE AND CIRCUIT DESIGNATIONS AND REFLECT THESE DESIGNATIONS ON THE AS-BUILTS.

4. INVESTIGATE AND REMOVE ALL BRANCH CIRCUITS FEEDING INTO TENANT SPACE THAT ARE NOT BEING USED. REMOVE THESE CIRCUITS IN THEIR ENTIRETY TO THE ORIGINAL POWER GRID OR TO THE PANEL. CONNECT NEW CIRCUITS TO THESE "SPARE" CIRCUIT BREAKERS IN THE PANEL.

5. PRIOR TO STARTING CONSTRUCTION CONTRACTOR SHALL ASCERTAIN THAT THERE ARE ENOUGH 208/120V CIRCUITS AVAILABLE TO HANDLE THE NEW 120V LOADS. IF THERE ARE NOT ENOUGH CIRCUITS AVAILABLE CONTRACTOR SHALL NOTIFY ARCHITECT AND ENGINEER BEFORE ANY WIRING IS STARTED.

6. REMOVE ALL EXISTING ELECTRICAL FIXTURES, DEVICES, PANELS, BOXES, CONDUIT, WIRING AND OTHER ELECTRICAL APPARATUS FROM ALL SECTIONS OF EXISTING WALLS AND PARTITIONS BEING REMOVED.

7. WHERE EXISTING TO REMAIN DEVICES ARE SHOWN THE EXISTING DEVICES AND FACEPLATES SHALL BE REPLACED. ROUGH-INS MAY BE REUSED.

8. WHERE REMOVAL OF EXISTING ELECTRICAL APPARATUS INTERRUPTS A CIRCUIT SERVING EXISTING DOWNSTREAM FIXTURES OR DEVICES TO REMAIN, MAINTAIN CIRCUIT CONTINUITY AS REQUIRED. PROVIDE NEW JB'S, PB'S, CONDUIT, WIRING AND OTHER APPURTENANCES AS NECESSARY.

9. WHERE AN EXISTING FIXTURE OR DEVICE IS REMOVED BUT THE CONDUIT AND BOX REMAIN FOR CIRCUIT CONTINUITY. PROVIDE AN APPROPRIATE BLANK COVER PLATE BOX OF MATERIAL AND FINISH TO MATCH THE COVER PLATES ON THE DEVICES IN THAT

9. UNLESS OTHERWISE NOTED ON THE PLANS, IN ROOMS WHERE NEW OUTLETS ARE BEING ADDED AND THE EXISTING OUTLETS TO REMAIN ARE 12" AFF. THE NEW OUTLETS SHALL BE MOUNTED 12" AFF. ALSO, IN ROOMS WHERE ALL OUTLETS IN THE ROOM ARE NEW, THE NEW OUTLETS SHALL BE MOUNTED 18" AFF.

10. FURNISH AND INSTALL GROUND BAR KIT IN EXISTING PANELBOARDS THAT DO NOT

HAVE A GROUND BAR. 11. CONTRACTOR SHALL SEPARATE ALL EXISTING BRANCH CIRCUITS SERVING THE AREA OF CONSTRUCTION FROM OTHER TENANT SPACES.

12. CONTRACTOR SHALL COORDINATE WITH ARCHITECTURAL DRAWINGS FOR ADDITIONAL

INFORMATION. NO ADDITIONAL COST WILL BE ALLOWED FOR PRICING BASED ON ENGINEERING DRAWINGS ALONE.

13. PROVIDE UPDATED TYPEWRITTEN PANEL DIRECTORIES. 14. CONTRACTOR SHALL REVISE OR ADD ADDITIONAL SUPPORTS TO ANY EXISTING CABLING OR EXISTING CONDUIT IN SCOPE OF WORK THAT IS CURRENTLY NOT

15. ALL MC CABLE FOR BRANCH WIRING TO MODULAR FURNITURE SHALL CONTAIN AN INCREASED (#8) NEUTRAL.

SUPPORTED PROPERLY.

Architects

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DATE ISSUED: 20 MAY 2022 REVISED: 18 AUGUST 2022 REVISED: **1**9 AUGUST 2022 REVISED: REVISED: DRAWN BY:

PHASE: CONSTRUCTION DOCUMENTS

21004-N

ELECTRICAL SPECIFICATIONS

SHEET:

CHECKED BY:

MECHANICAL ELECTRICAL PLUMBING FIRE PROTECTION 3501 N CAUSEWAY BLVD. (504) 456-3119 SUITE 710, METAIRIE, LA 70002

& Associates

Job No. 2202301 Designed By DB Drawn By _____ Checked By ___

LIGHTING SYMBOLS				
CEILING WALL DESCRIPTION				
	EXISTING FLUORESCENT, LED, OR HID LIGHT FIXTURE. LETTER DENOTES FIXTURE TYPE. SEE FIXTURE SCHEDULE.			
	RELOCATED EXISTING FLUORESCENT, LED, OR HID LIGHT FIXTURE. LETTER DENOTES FIXTURE TYPE. SEE FIXTURE SCHEDULE.			
$\boxtimes \boxtimes$	፼፟፟	NEW FLUORESCENT, LED, OR HID LIGHT FIXTURE. LETTER DENOTES FIXTURE TYPE. SEE FIXTURE SCHEDULE.		
	H	FLUORESCENT, LED, OR HID LIGHT FIXTURE. LETTER DENOTES FIXTURE TYPE. SEE FIXTURE SCHEDULE.		
\vdash	 	FLUORESCENT STRIP FIXTURE. LETTER DENOTES FIXTURE TYPE. SEE FIXTURE SCHEDULE.		
0	Q	INCANDESCENT, LED, FLUORESCENT, OR HID LIGHT FIXTURE. LETTER DENOTES FIXTURE TYPE. SEE FIXTURE SCHEDULE.		
₩	_⊗	"EXIT" LIGHT FIXTURE. ARROWS ON FACE INDICATE DIRECTION. SEE FIXTURE SCHEDULE.		
	₩	INCANDESCENT, FLUORESCENT, OR LED EMERGENCY LIGHT FIXTURE. LETTER DENOTES FIXTURE TYPE. SEE FIXTURE		
	Ø	SCHEDULE FIXTURE ON EMERGENCY CIRCUIT. LETTER DENOTES FIXTURE TYPE. SEE FIXTURE SCHEDULE.		
		FLUORESCENT, LED, OR HID POLE MOUNTED LIGHT FIXTURE. LETTER DENOTES FIXTURE TYPE. SEE FIXTURE SCHEDULE.		
	_ ,	WALL MOUNTED SCONCE. LETTER DENOTES FIXTURE TYPE. SEE FIXTURE SCHEDULE.		
D	R	POWER SUPPLY LED DRIVER. COORDINATE WITH LED LIGHT FIXTURE MANUFACTURER FOR SELECTION. SEE FIXTURE SCHEDULE.		
Р	Pa	POWER PACK FOR OCCUPANCY SENSOR. SP DENOTES SLAVE PACK. SEE SENSOR SCHEDULE.		
R		ROOM CONTROLLER FOR LIGHTING CONTROL		
6	<u></u>	OCCUPANCY SENSOR. SEE SENSOR SCHEDULE.		
(F	9	PHOTOCELL		
		WIRING SYMBOLS		
		DESCRIPTION		
	L:1,3	HOMERUN TO PANELBOARD WITH NOMENCLATURE (LETTERS). CIRCUIT NUMBERS (NUMBERS). NUMBER OF CIRCUITS (NUMBER OF ARROWS). EACH CIRCUIT TO HAVE GROUND.		
		WIRING (IN CONDUIT) CONCEALED IN CEILING OR WALL.		
/-		WIRING (IN CONDUIT) RUN EXPOSED.		
		EXISTING WIRING		
~	λ	FLEXIBILE CORD WIRE TO EQUIPMENT		
		GROUND CONNECTON. GROUND PER NEC ARTICLE 250.		
\$	\$	SWITCH		
ŞM	\$ ^{M2}	MOTOR RATED TOGGLE SWITCH, 20A/1P (M) OR 30A/2P (M2)		
\$ ³	\$ ³	THREE WAY SWITCH		
\$ ⁴	\$ ⁴	FOUR WAY SWITCH		
D		SINGLE POLE DIMMER SWITCH AT 48" A.F.F. (NON SCR, AUTO TRANSFORMER TYPE).		
\$° \$°		OCCUPANCY SENSOR, WALL MOUNTED, SEE SENSOR SCHEDULE		
Ş ^K \$ ^K		KEY SWITCH, COORDINATE KEY SCHEDULE WITH ARCHITECT		
Ş ^{LV}	\$ ^{LV}	LOW VOLTAGE SWITCH. REFER TO PLANS FOR ADDITIONAL NOTES AND/OR REQUIREMENTS.		
		DIMMER SWITCH		
-0		CONDUIT TURNED UP		
— ə		CONDUIT TURNED DOWN		
-7		CONDUIT STUBBED OUT		
		PULL BOX		

POWER SYMBOLS					
FLOOR WALL CEIL. DESCRIPTION					
Φ SIMPLEX OUTLET. SYMBOL AT 45 DEGREE ANGLE REPRESENTS CEILING MOUNTED					
DUPLEX OUTLET. SYMBOL AT 45 DEGREE ANGLE REPRESENTS CEILING MOUNT		DUPLEX OUTLET. SYMBOL AT 45 DEGREE ANGLE REPRESENTS CEILING MOUNTED			
	Φ	•	SPECIAL OUTLET— NEMA CONFIGURATION AS INDICATED SYMBOL AT 45 DEGREE ANGLE REPRESENTS CEILING MOUNTED		
±	Ħ	•	QUAD OUTLET. SYMBOL AT 45 DEGREE ANGLE REPRESENTS CEILING MOUNTED		
	P		CORD REEL WITH DUPLEX RECEPTACLE CEILING MOUNTED.		
SURFA	CE F	LUSH			
			BRANCH CIRCUIT PANELBOARD.		
	<u> </u>		DISTRIBUTION PANELBOARD.		
			DISCONNECT SWITCH. FUSED UNLESS OTHERWISE NOTED.		
	\boxtimes		COMBINATION STARTER/DISCONNECT SWITCH. FUSED U.O.N. FURNISHED BY DIVISION 15 AND INSTALLED BY DIVISION 16.		
	\boxtimes		MAGNETIC MOTOR STARTER OR VARIABLE FREQUENCY DRIVE. FURNISHED BY DIVISION 15 AND INSTALLED BY DIVISION 16.		
	\overline{O}		MOTOR, SINGLE-PHASE.		
			MOTOR, THREE-PHASE.		
	WH		WATER HEATER.		
	~~		DUCT HEATER.		
	J		JUNCTION BOX, WALL MOUNTED		
	<u> </u>		JUNCTION BOX, CEILING MOUNTED		
-(D~/	•	JUNCTION BOX WITH WHIP TO EQUIPMENT.		
	CPT		CONTROL POWER TRANSFORMER		
	T		TRANSFORMER		
	Ø		UTILITY POLE.		
			SYSTEM DEVICES		
FLOOR	WALL	CEIL.	DESCRIPTION		
	•		TELEPHONE OUTLET ROUGH—IN		
	T	②	COMBINATION DATA/TELEPHONE OUTLET ROUGH-IN		
	∇	Ø	DATA OUTLET ROUGH-IN		
CR AM			CABLE TV OUTLET ROUGH-IN, 4X4 BOX WITH SINGLE GANG PLASTER RING WITH 3/4" CONDUIT TO ACCESSIBLE CEILING		
			VGA CONNECTOR ROUGH-IN, 4X4 BOX WITH SINGLE GANG PLASTER RING WITH 3/4" CONDUIT TO ACCESSIBLE CEILING		
			SECURITY CARD READER ROUGH—IN, WALL MOUNTED. PROVIDE SINGLE GANG BOX WITH 1/2"C TO ACCESSIBLE CEILING. TERMINATIONS, HEAD—END, AND TERMINAL EQUIPMENT BY OTHERS		
			PROVIDE CHIEF PAC526F ENCLOSURE W/ ACOUSTICAL PUTTY KIT INSTALLED ON REAR OF 526 BOX, WITH 1-1/4°C TO ACCESSIBLE CEILING FOR A/V WIRING BY OTHERS		

	ONE-LINE SYMBOLS			
		DESCRIPTION		
	(M)	METER ENCLOSURE		
	00	CIRCUIT BREAKER		
		FUSE		
	->-	FUSE		
	ottho	FUSED SWITCH		
	BAS	BAS		
1	PANEL PANELBOARD			
SQUARE D PM820		METER/MONITOR: O/C=CIRCUIT BREAKER POSISTION STATUS, M2= SQUARE D PM820 OR EQUIV, M3=SQUARE D PM710 OR EQUIV		
		GROUND FAULT CURRENT INTERRUPTER		
		TRANSFORMER		
REFERENCE SYMBOLS				
		DESCRIPTION		
	1	REFERENCE NOTE.		
	1>	SPECIFIC NOTE REFERENCE.		
1 CALL OUT F		CALL OUT REFERENCE.		
feeder reference.		FEEDER REFERENCE.		
	\triangle	REVISION REFERENCE.		
1				

	FIRE ALARM SYSTEM DEVICES				
		DESCRIPTION			
	×	FIRE ALARM, COMBINATION SPEAKER/STROBE WALL MOUNTED AT 80" AFF, CANDELA AS INDICATED			
	S	FIRE ALARM SPEAKER, WALL MOUNTED			
	▼ ⊠c	FIRE ALARM, COMBINATION SPEAKER/STROBE CEILING MOUNTED, CANDELA AS INDICATED			
	∇ Sc	FIRE ALARM SPEAKER, CEILING MOUNTED			
	⊠ _c	STROBE, CEILING MOUNTED, CANDELA AS INDICATED			
	×	STROBE, WALL MOUNTED AT 80" AFF. (CANDELA AS INDICATED).			
5	F F ^K	FIRE ALARM PULL STATION, PROVIDE PROTECTIVE COVERS. MATCH EXISTING BUILDING TYPE. K= LOCKING TYPE			
	T	HEAT DETECTOR			
		SMOKE DETECTOR—CEILING MOUNTED, WALL MOUNTED			
J		DUCT SMOKE DETECTOR WITH SAMPLING TUBE MOUNTED IN DUCT WORK			
		SMOKE DETECTOR WITH SOUNDER BASE. WALL BRACKET INDICATES DEVICE SHALL BE WALL MOUNTED			
	FS	FLOW SWITCH			
	TS	TAMPER SWITCH			
	CM	COMMAND MODULE			
	мм	MONITORING MODULE			
	PS	PRESSURE SWITCH			
	LS	LEVEL SWITCH			
	(J)FSD	FIRE/SMOKE DAMPER. PROVIDE 120V POWER AND SIGNAL TO FACP.			
	▼ INT	2-WAY AREA OF REFUGE PHONE/INTERCOM			

SYMBOL NOTES:

- 1. ANY SYMBOL WITH AN "E" IS EXISTING TO REMAIN. MAINTAIN EXISTING CIRCUIT CONTINUITY AND REPLACE EXISTING DEVICE WITH NEW AS REQUIRED.
- 2. ANY DASHED SYMBOL OR SYMBOL WITH AN "X" IS EXISTING TO BE REMOVED.
- 3. ANY SYMBOL WITH AN "R" INDICATES TO BE RELOCATED.
- 4. SYMBOL MODIFIERS:
- "AC" INDICATES DEVICE TO BE MOUNTED 4 IN. ABOVE COUNTER.
 "GFI" INDICATES DEVICE TO BE GROUND FAULT INTERRUPTER.
 "IG" INDICATES DEVICE TO BE ISOLATED GROUND TYPE.
 "EM/NL" INDICATES FIXTURE TO BE WIRED FOR EMERGENCY AND NIGHT LIGHT
- "EM" INDICATES FIXTURE TO BE WIRED FOR EMERGENCY OPERATION. SWITCHED.
- "SM" INDICATES DEVICE TO BE SURFACE MOUNTED.
 "FLC" INDICATES RECEPTACLE MOUNTED FLUSH WITH CEILING

FIXTURE SCHEDULE

TAG NOTES	DESCRIPTION	CATALOG	LAMP
F1	4" ROUND DOWNLIGHT, MEDIUM BEAM, SPECULAR REFLECTOR FINISH, 277V		1100 LM 3500°K 80+CRI
F2	4" LINEAR RECESSED FIXTURE, FLUSH SATIN LENS, 375LM/FT WOOD SLAT CEILING, 4' LENGTH, 277V	FOCAL POINT SEEM 4 LED	600 LM 3500°K 80+CRI
F3	2'X4' BUILDING STANDARD, 4-LAMP PARABOLIC, 4" DEEP CELL, RELAMP ALL EXISTING TO BE REUSED AND/OR RELOCATED. 277V	2PM4	328LED RETROFIT 3500°K 85+CRI
F4	2'X2' BUILDING STANDARD, 4-LAMP PARABOLIC, 4" DEEP CELL, RELAMP ALL EXISTING TO BE REUSED AND/OR RELOCATED. 277V	2PM4	7T8LED RETROFIT 3500°K 85+CRI
EXIT SIGN	BUILDING STANDARD EXIT FIXTURE, WHITE POLYCARBONATE, RED LETTERS	QUANTUM THERMOPLASTO LQM SERIES	INCLUDED

OCCUPANCY SENSOR SCHEDULE

TAG	DESCRIPTION	COVERAGE	CATALOG	EQUAL
S ⁰¹	WALL SWITCH SENSOR, DUAL TECHNOLOGY PIR AND ULTRASONIC (OR MICROPHONIC), AUTO ADJUST TIME DELAY BASED ON USAGE PATTERNS, 277VAC	PIR WALKING MOTION — 35' X 30' PIR HAND MOTION — 20' X 15' UT WALKING MOTION — 20' X 20' UT HAND MOTION — 15' X 15'	WATTSTOPPER DW-100	SENSOR SWITCH WSD-PDT-SA
0	CEILING MOUNTED, DUAL TECHNOLOGY PIR AND ULTRASONIC (OR MICROPHONIC), 1000 SQFT 360° COVERAGE, AUTO ADJUST TIME DELAY BASED ON USAGE PATTERNS, 24VDO		WATTSTOPPER DT-300	SENSOR SWITCH CM-PDT-10



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REVISED:
DRAWN BY: DB
CHECKED BY: JC
PHASE:

CONSTRUCTION DOCUMENTS

21004-N

TITLE:

ELECTRICAL SYMBOL & LIGHTING SCHEDULES

E1.01





- 1. ALL 2X2 FIXTURES SHOWN ARE TYPE F4. ALL 2X4'S ARE F3. REFER TO E1.01.
- ALL F4'S ARE TO BE RELAMPED WITH BUILDING STANDARD LEDs AND F3'S ARE TO BE RELAMPED WITH BUILDING STANDARD LEDs.
- 3. CUT AND PATCH WHERE NECESSARY FOR INSTALLATION OF NEW DEVICES



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PHASE:	

CONSTRUCTION DOCUMENTS

21004-N

TITLE:

FLOOR PLAN - LIGHTING AND FIRE ALARM

SHEET:

& Associates

MECHANICAL ELECTRICAL PLUMBING FIRE PROTECTION 3501 N CAUSEWAY BLVD. (504) 456-3119 SUITE 710, METAIRIE, LA 70002

Job No. 2202301 Designed By DB

Drawn By ______DB Checked By _____JC

E2.00





EANS, LOUISIANA

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DATEISSUED: 20 MAY 2022
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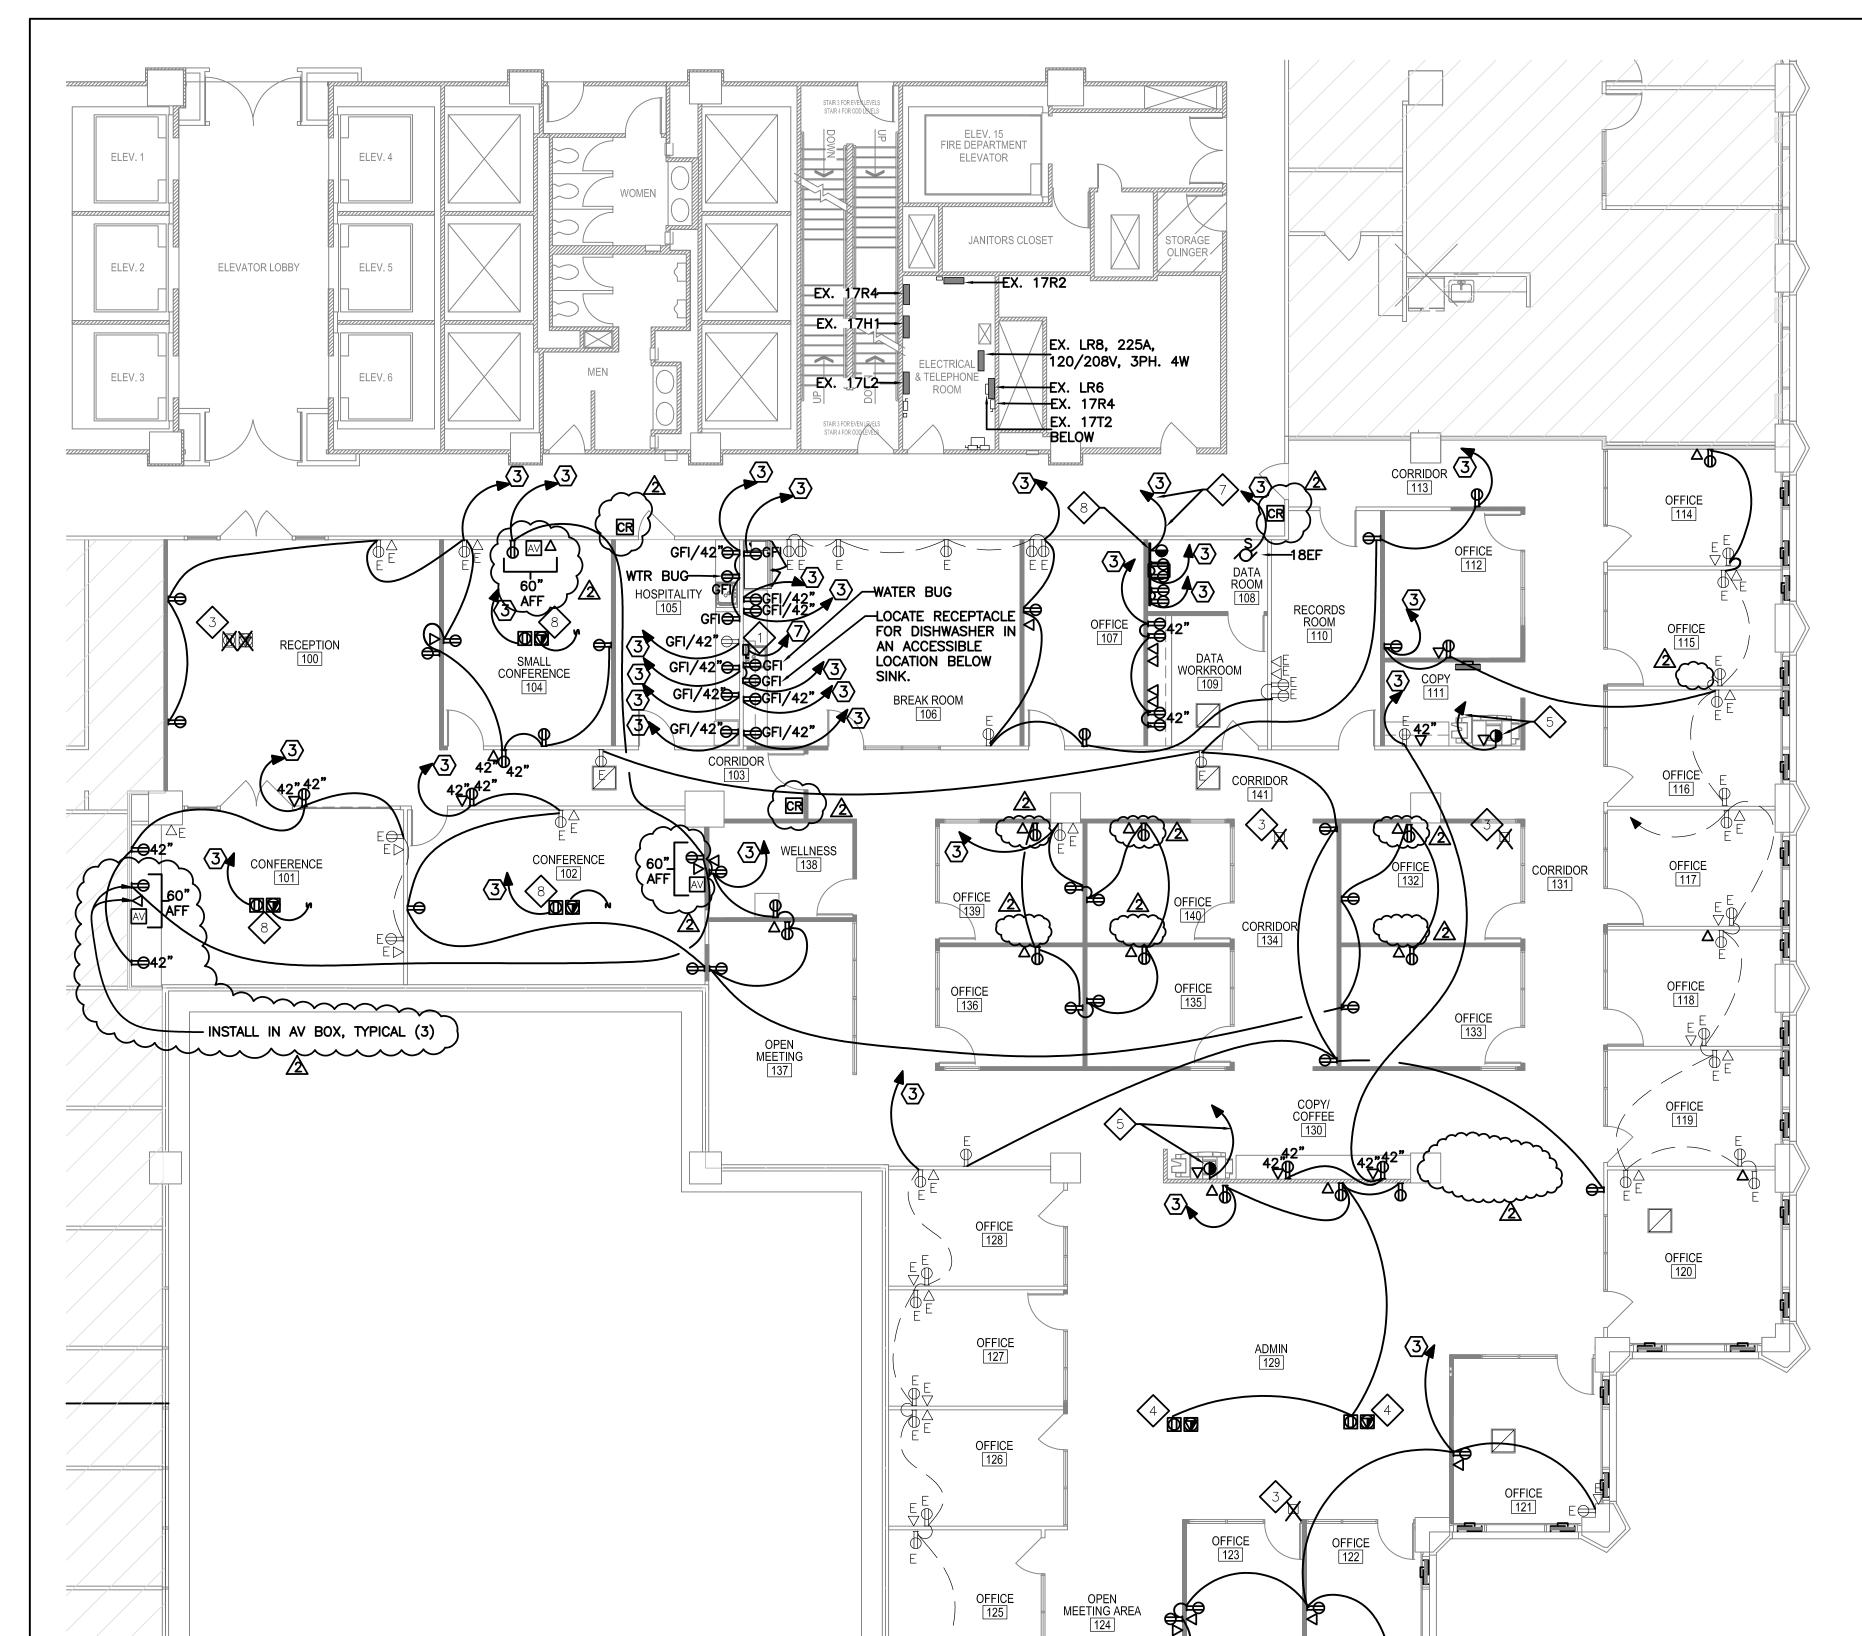
TITLE:

DRAWN BY:

FLOOR PLAN - POWER AND COMMUNICATIONS

SHEET:

E3.00



SPECIFIC NOTES:

- WATER HEATER 8.3 KW, 277V. PROVIDE 40A/2P SWITCH FOR SIGHT DISCONNECTING MEANS AND CONNECT TO WATER HEATER WITH 2 #8'S AND 1 #10 GROUND, 3/4" FLEXIBLE LIQUIDTIGHT CONDUIT.
- 2 3 #10'S, 1 #8N, 1 #8G, 1 ½"C AND 1 #10, 1#10N, 1#10G IN 1"C.
- APPROXIMATE LOCATION OF EXISTING FLOOR BOX/POWER POLE TO BE REMOVED. REMOVE FLOOR BOX, ASSOCIATED WIRING AND CONDUIT, AND PATCH PENETRATIONS AND FLOOR.
- ROVIDE POKE THROUGH (SIMILAR TO WIREMOLD 4AT SERIES) FOR POWER/COMMUNICATIONS ROUGH—IN. STUB—UP 1" CONDUIT WITH PULL STRING FOR AV/COMMUNICATIONS. STUB—UP 3/4" CONDUIT FOR POWER CONNECTIONS. ROUTE IN CEILING BELOW TO NEAREST WALL, TURN UP AND THEN ROUTE CONDUITS TO ABOVE CEILING. COORDINATE EXACT REQUIREMENTS AND LOCATIONS WITH TENANT'S REPRESENTATIVE PRIOR TO PURCHASE AND INSTALL. PROVIDE CIRCUITING AS SHOWN.
- SINGLE RECEPTACLE, 20A, 208V, PROVIDE RECEPTACLE TO MATCH PLUG ON COPIER. PROVIDE 20A/2P CIRCUIT BREAKER IN PANEL AND ROUTE 2 #12'S AND 1 #12 GROUND TO NEW CIRCUIT BREAKER AND CONNECT THERETO.
- COMMUNICATIONS BACKBOARD ₹ PLYWOOD, 4'X3' PAINTED WITH 2 COATS OF FIRE—RATED PAINT. COORDINATE EXACT LOCATION OF BACKBOARD WITH TENANT.
- SINGLE RECEPTACLE, 30A/1P 2 #10'S AND 1 #10 GROUND, \(\frac{3}{4}"C. \) PROVIDE 30A/1P CIRCUIT BREAKER IN EXISTING PANEL AND CONNECT CIRCUIT THERETO. COORDINATE NEMA CONFIGURATION WITH TENANT'S COMMUNICATIONS EQUIPMENT AND ADJUST ACCORDINGLY.
- PROVIDE POKE THROUGH (SIMILAR TO WIREMOLD 6AT SERIES) FOR AV/POWER/COMMUNICATIONS ROUGH—IN. STUB—UP 1 1/2" CONDUIT WITH PULL STRING FOR AV/COMMUNICATIONS. STUB—UP 3/4" CONDUIT FOR POWER CONNECTIONS. ROUTE IN CEILING BELOW TO NEAREST WALL, TURN UP AND THEN ROUTE CONDUITS TO ABOVE CEILING. COORDINATE EXACT REQUIREMENTS AND LOCATIONS WITH TENANT'S REPRESENTATIVE PRIOR TO PURCHASE AND INSTALL. PROVIDE CIRCUITING AS SHOWN.
- WATER HEATER 4.2 KW, 277V. PROVIDE 20A/2P SWITCH FOR SIGHT DISCONNECTING MEANS AND CONNECT TO WATER HEATER WITH 2 #12'S AND 1 #112 GROUND, 1/2" FLEXIBLE LIQUIDTIGHT CONDUIT.

SUPPLEMENTAL SYMBOL SCHEDULE:

AV/TV WITH HDMI ROUGH-IN, PROVIDE JUNCTION BOX AND 1 1/4" C TO ABOVE CEILING AND BUSH. COORDINATE WITH ARCHITECT/OWNER'S AV REPRESENTATIVE FOR EXACT REQUIREMENTS AND CONDUIT ROUTING.

POWER AND COMMUNICATIONS GENERAL NOTES:

- 1. ALL EXISTING RECEPTACLES AND DATA OUTLETS ARE NOT SHOWN ON DRAWINGS. ANY DEVICES NOT SHOWN TO BE REMOVED IN THE RENOVATED SPACE SHALL BE REMOVED AND BLANK PLATE PROVIDED. SEE DEMOLITION
- CUT AND PATCH WALLS AS REQUIRED TO INSTALL NEW DEVICES.
 EXISTING WIRING IS SHOWN PER AS—BUILT DRAWINGS. CONTRACTOR SHALL FIELD VERIFY AND REWORK/PROVIDE NEW AS REQUIRED TO PROVIDE CIRCUITING AS SHOWN.

1 NEW 18TH FLOOR PLAN - POWER AND COMMUNICATIONS E3.00 1/8" = 1'-0"



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