


WIND BORNE DEBRIS PROTECTION

WINDOWS IN BUILDING LOCATED IN WIND BORNE DEBRIS REGIONS SHALL HAVE GLAZED OPENINGS PROTECTED FROM WIND BORNE DEBRIS. WOOD STRUCTURAL PANELS WITH A MIN. THICKNESS OF 1/2" AND A MAX. SPAN OF 8 FEET SHALL BE PERMITTED FOR OPENING PROTECTION IN ONE AND TWO STORY BUILDINGS. PANELS SHALL BE PRECUT TO COVER THE GLAZED OPENINGS WITH ATTACHMENT HARDWARE PROVIDED.

CODE COMPLIANCE:


WIND SPEED 130 MPH.

1. THE 2015 INTERNATIONAL RESIDENTIAL CODE.
2. WOOD FRAME CONSTRUCTION MANUAL FOR ONE AND TWO FAMILY DWELLINGS. (WFCM).
3. INTERNATIONAL CODE COUNCIL (ICC) STANDARD FOR RESIDENTIAL CONSTRUCTION IN HIGH WIND REGIONS (ICC600).

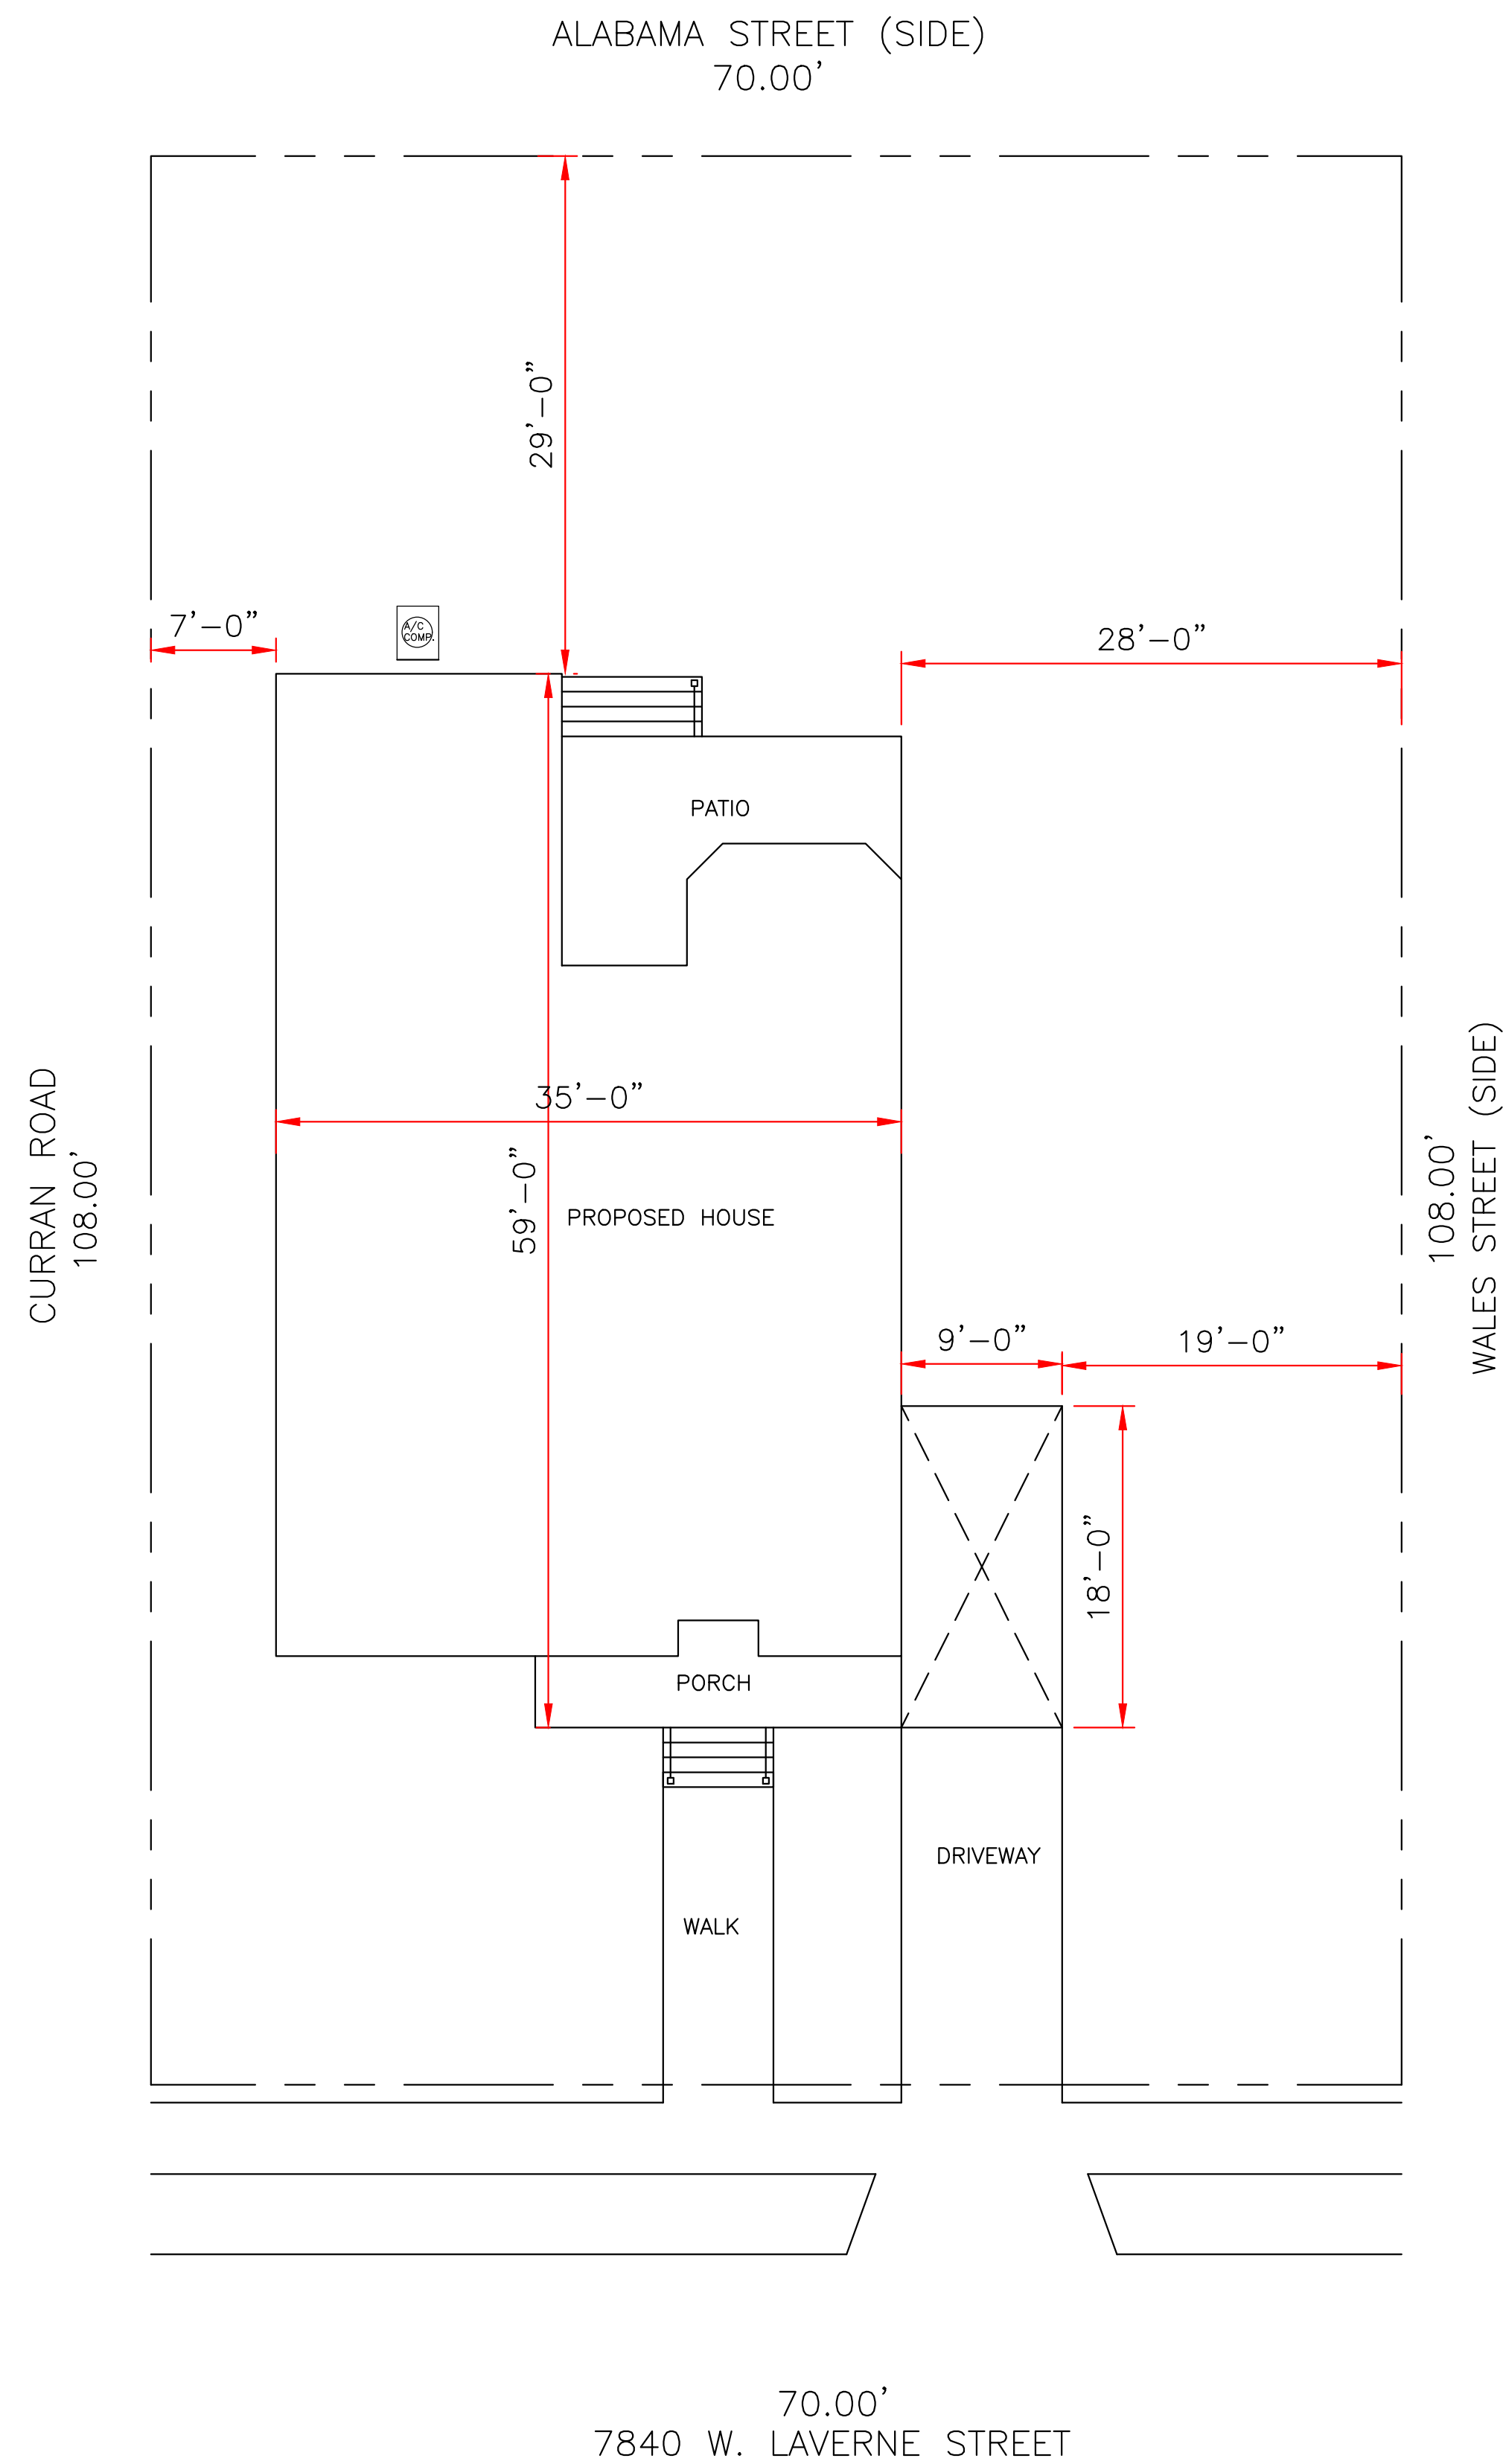


SITE PLAN
SCALE: 1/8" = 1'-0"

LOT# 25 SQ# 7
THIRD DISTRICT
PONCHATRIN PARK SEC. 1
ORLEANS PARISH, LA

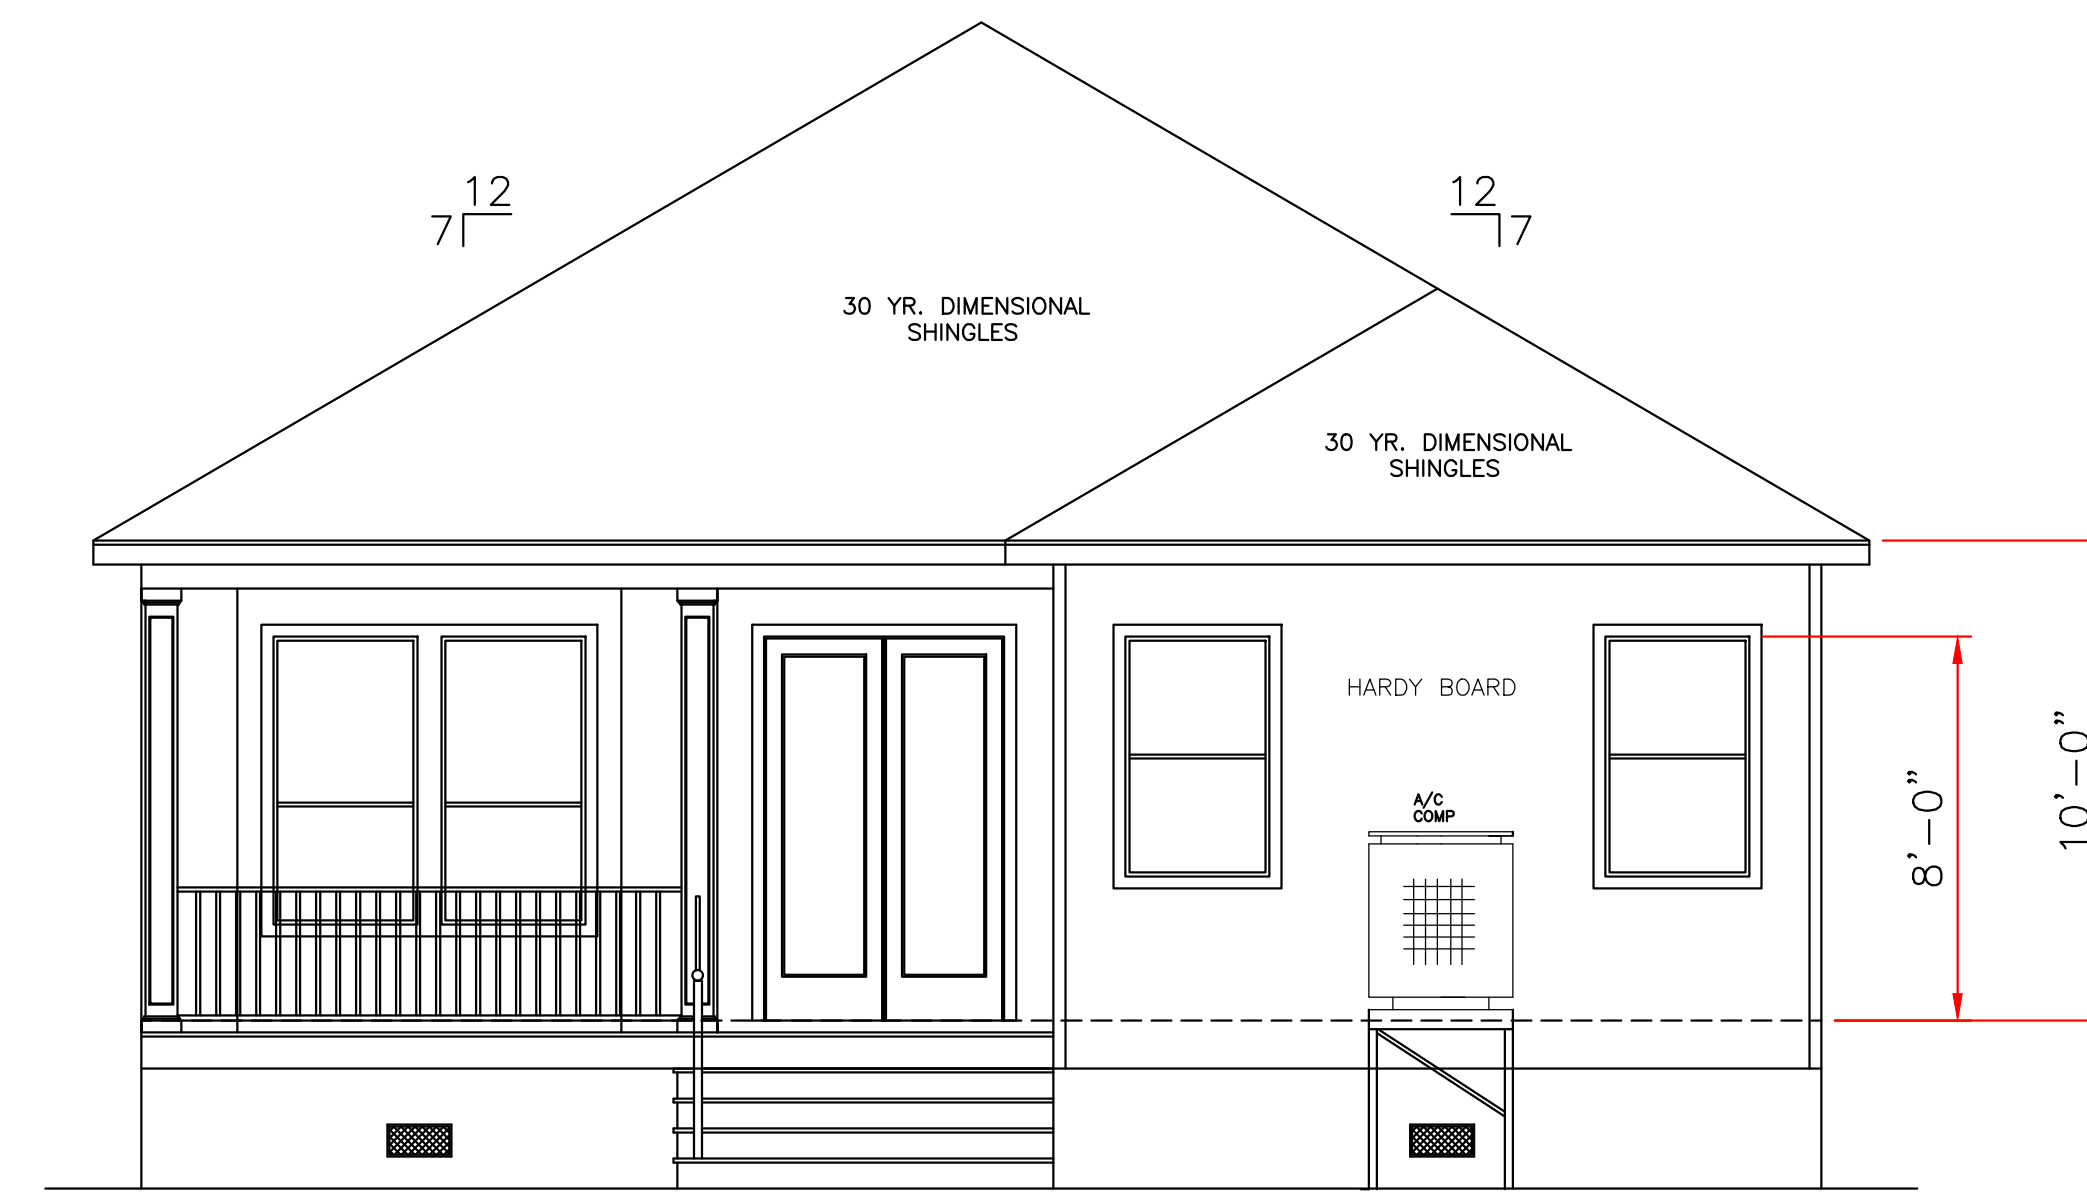


REAR ELEVATION
SCALE: 1/4" = 1'-0"

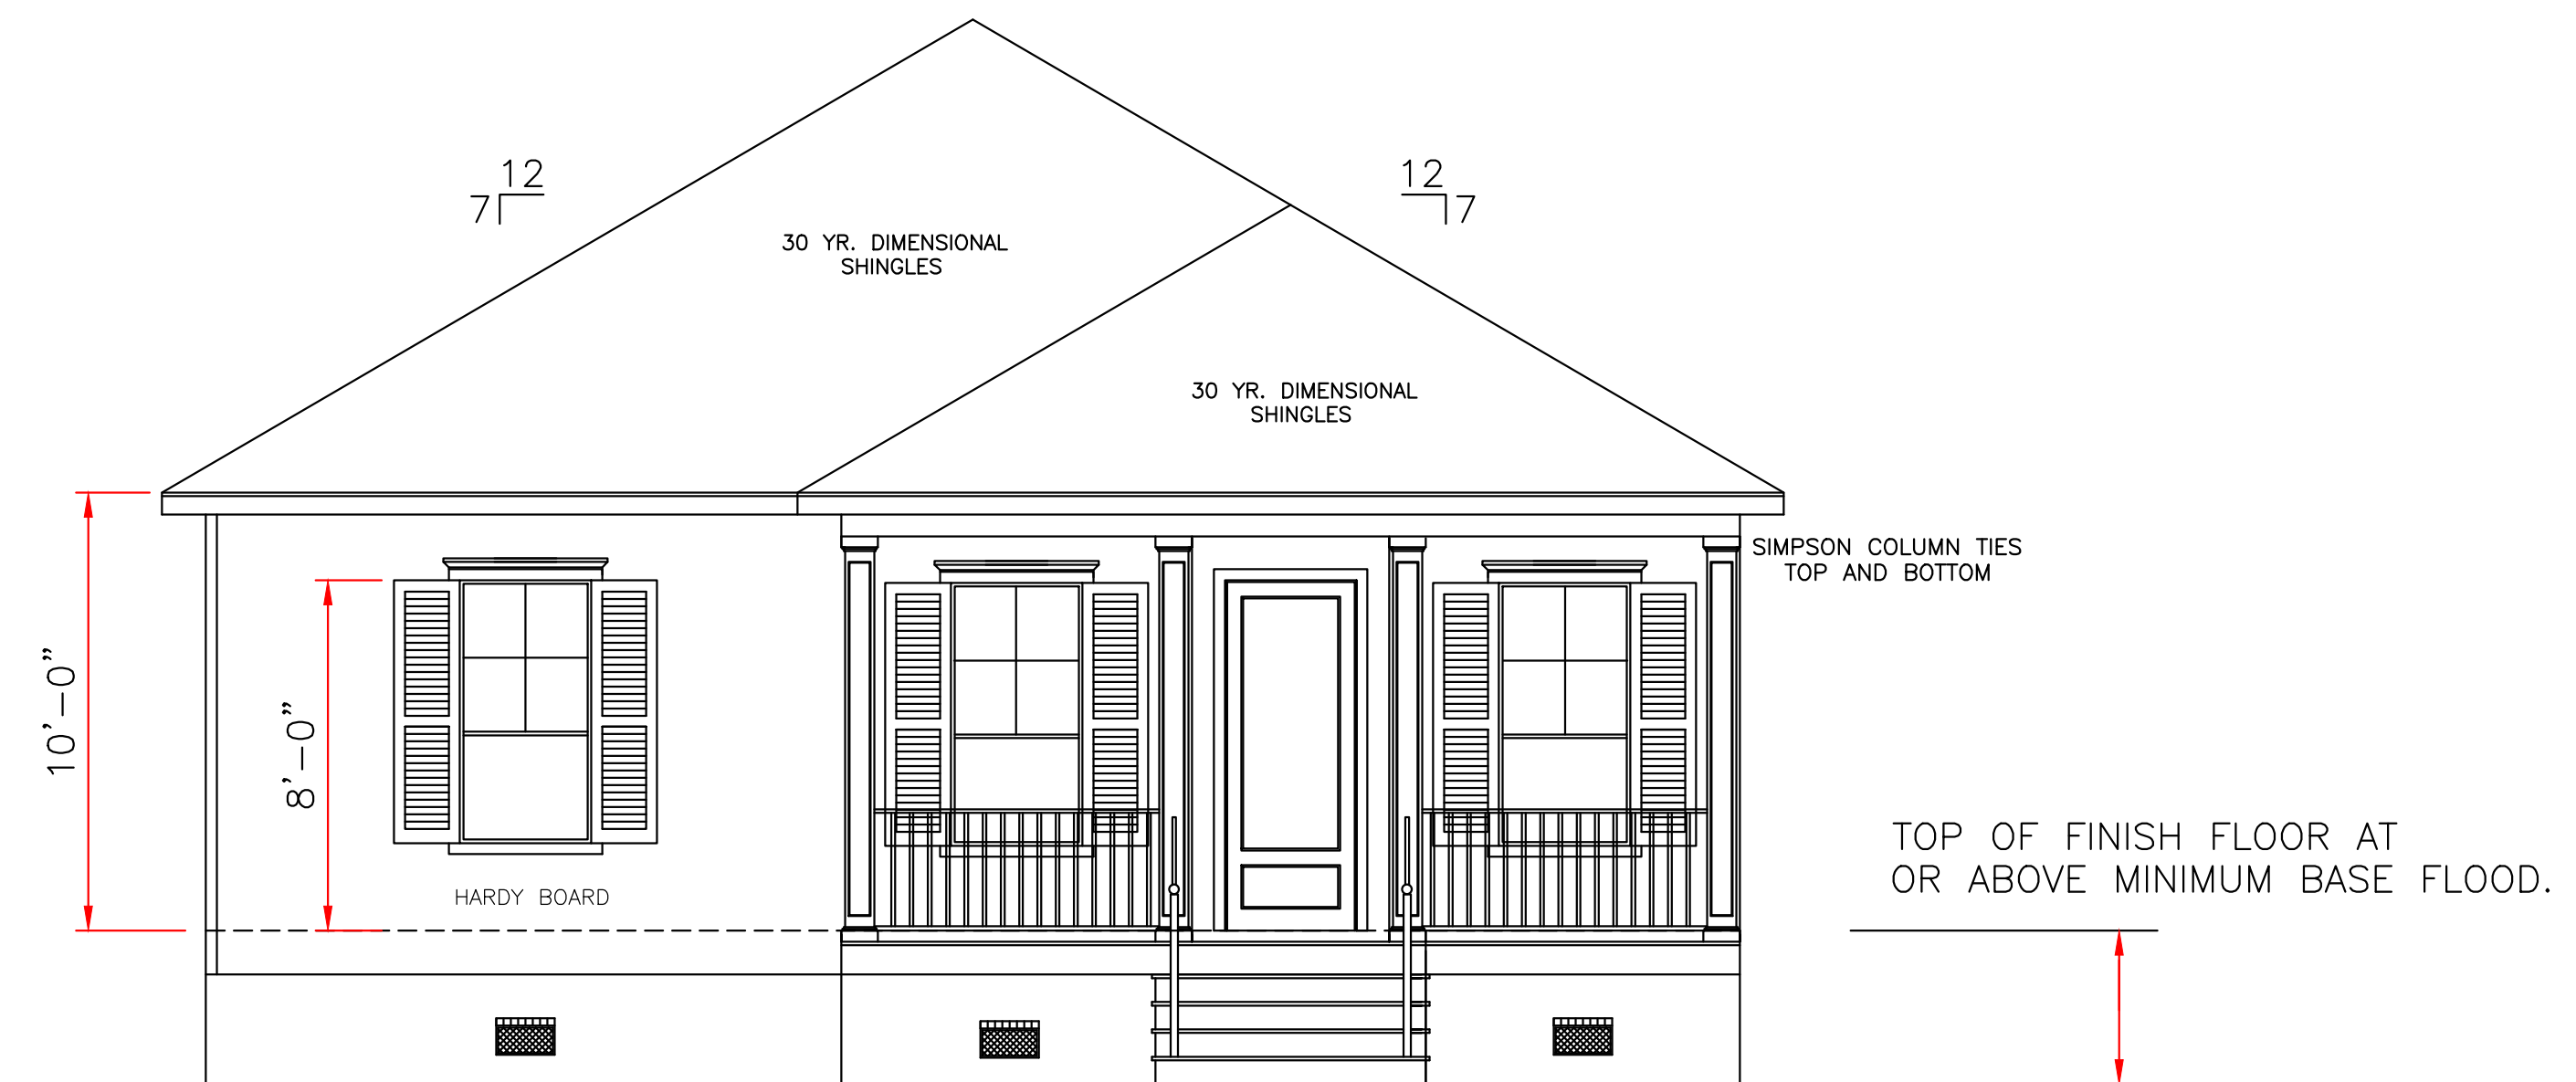

FRONT ELEVATION
SCALE: 1/4" = 1'-0"

ALL MATERIALS BELOW
BASE FLOOD MUST
BE WATER RESISTANT

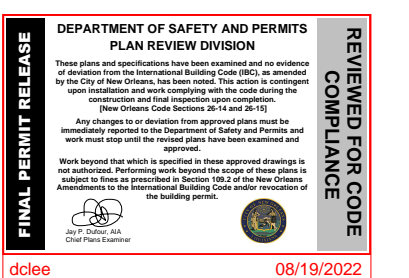

THESE PLANS HAVE BEEN PROPERLY EXAMINED BY THE UNDERSIGNED. I HAVE DETERMINED THAT THEY COMPLY WITH THE FOLLOWING EXISTING STATE AND LOCAL BUILDING CODES FOR THE JURISDICTION IN WHICH THE RESIDENCE IS TO BE LOCATED. ADVISED: 08/04/22

IN THE EVENT THAT A DIMENSIONAL DISCREPANCY IN THE DRAWINGS IS DISCOVERED BY THE GENERAL CONTRACTOR, SUBCONTRACTORS, ENGINEER, CONSULTANT, OR A SUPPLIER, SAID PARTY SHALL IMMEDIATELY NOTIFY THE ARCHITECT AND SUSPEND ALL ASSOCIATED WORK UNTIL SUCH TIME THAT A PROPER DETERMINATION HAS BEEN MADE BY THE ARCHITECT, WITH APPROPRIATE INSTRUCTIONS FOR RESOLUTION OF THE ISSUE. FAILURE TO REPORT KNOWN DISCREPANCIES AND CONTINUING WITH THE WORK WITHOUT NOTIFYING THE ARCHITECT SHALL RESULT IN AN ASSUMPTION OF RESPONSIBILITY FOR CORRECTIVE WORK TO ACHIEVE THE INTENDED DESIGN.

	LARRY TRUMBATURI		AMYRICK RUSSELL 7840 W. LAVERNE STREET ORLEANS PARISH, LA.	
	8307 LAFITTE CT. CHALMETTE, LA 70043	DATE 02/22/22	SHEET NO. 1 OF 6	
504-279-3508	JOB NO 8940			


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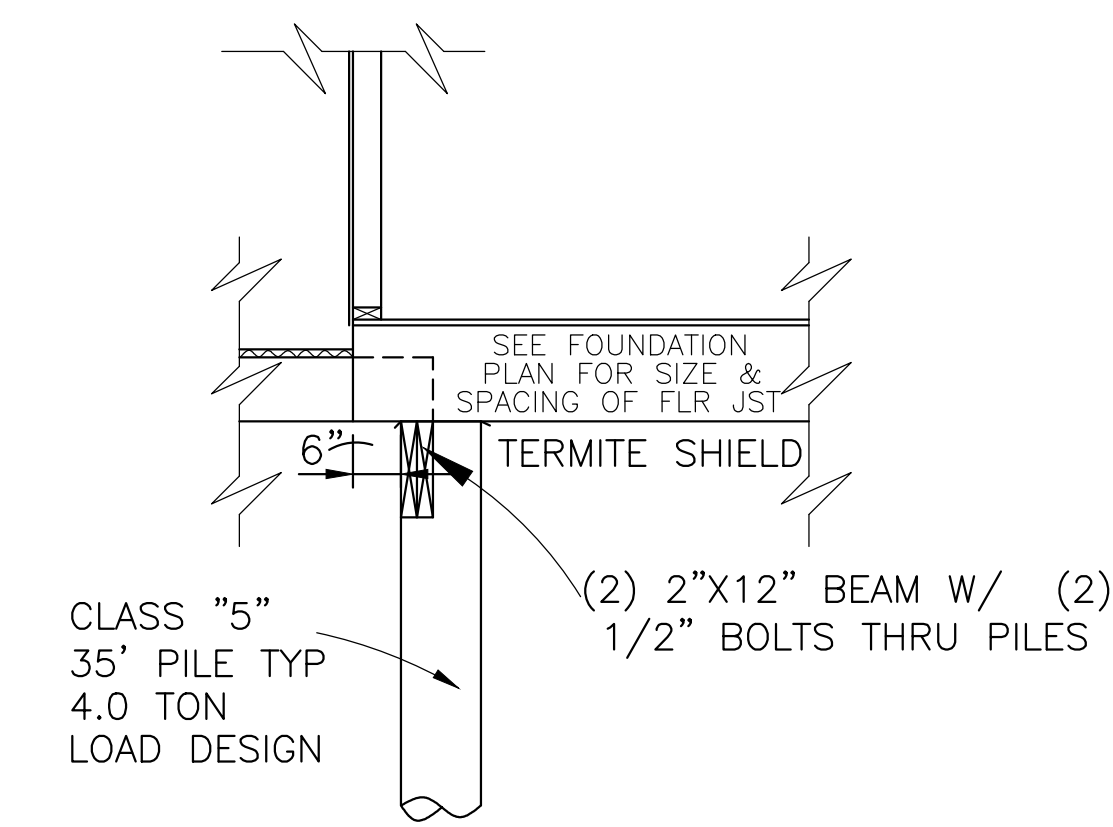
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WIND BORNE DEBRIS PROTECTION


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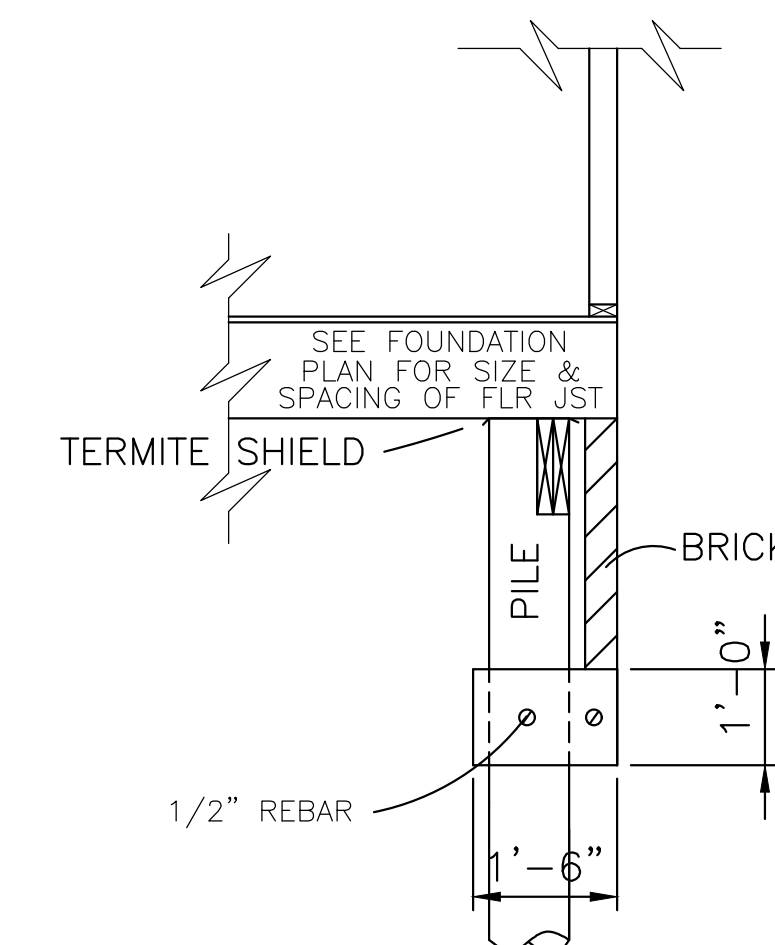
FOUNDATION PLAN
SCALE: 1/4" = 1'-0"



SECTION @ PORCH
SCALE: 1/2" = 1'-0"

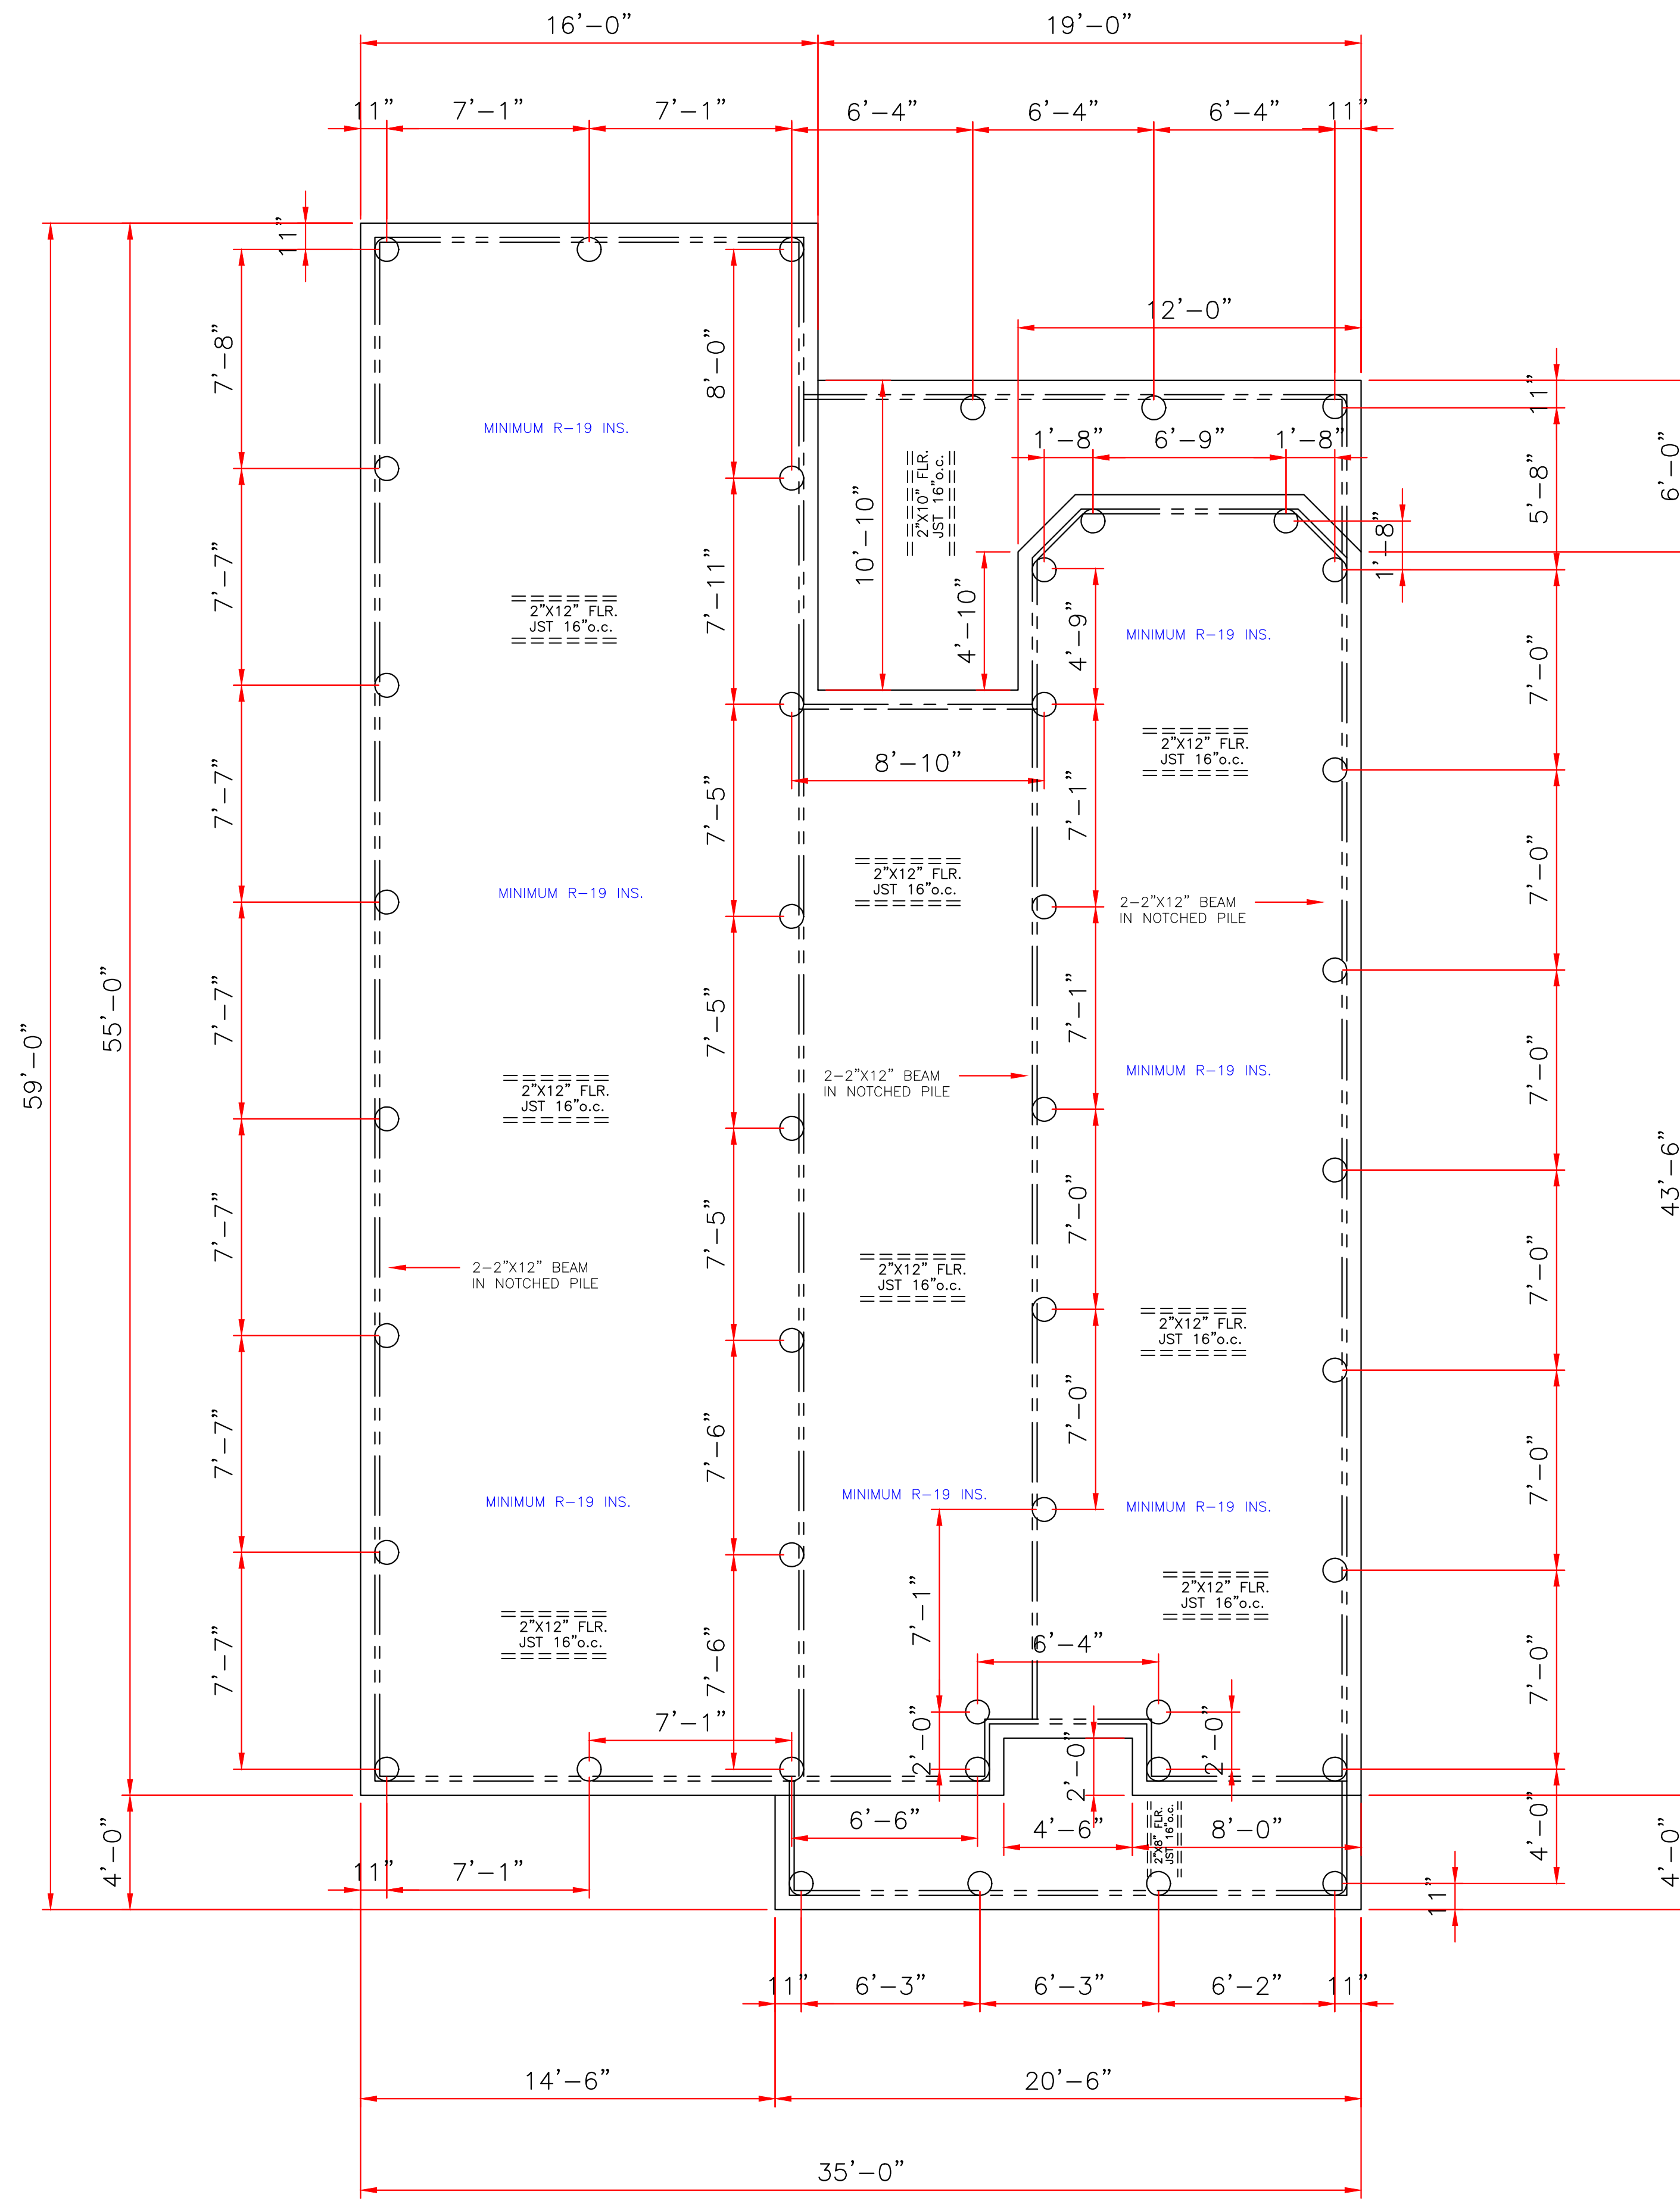


INTERIOR FOOTING DETAIL
SCALE: 1/2" = 1'

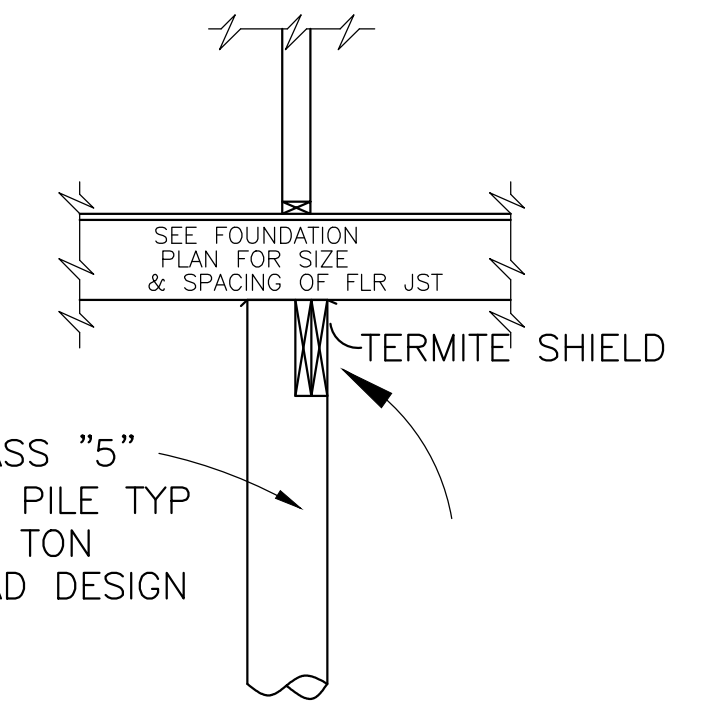

EXTERIOR BRICK DETAIL
SCALE: 1/2" = 1'-0"


OPTION

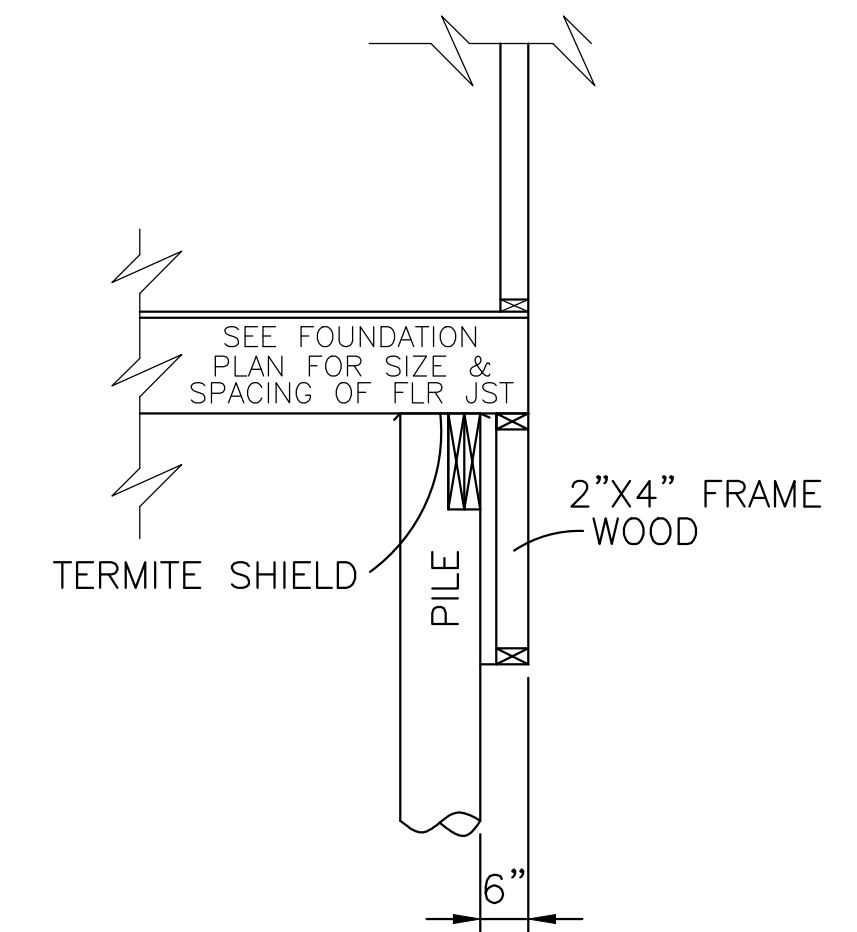

EXTERIOR WOOD DETAIL
SCALE: 1/2" = 1'-0"

OPTION

CLASS 5 35' PILE WITH 4.0 TON LOAD DESIGN
DRIVEN WITH STEEL DROP HAMMER OR RAPID
IMPACT HAMMER METHOD, TO REFUSAL

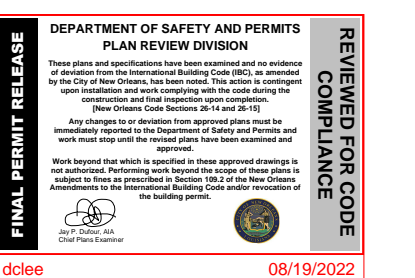

SOIL TREATMENT, CHEMICAL TERMITICIDE OR
TEMITE SHIELDS WILL BE USED FOR
TERMITE PROTECTION, BUILDER VERIFY

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LARRY TRUMBATURI 8307 LAFITTE CT. CHALMETTE, LA 70043 504-279-3508 JOB NO 8940		AMYRICK RUSSELL 7840 W. LAVERNE STREET ORLEANS PARISH, LA.	
		DATE 02/22/22	SHEET NO 2 OF 6

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DOORS		
1	3'0"x8'0"x1 3/4"	EXT. INSUL.
2	2-2'8"x8'0"x1 3/4"	EXT. INSUL. PAIR
3	2'8"x8'0"x1 3/8"	INTERIOR RAISED PANEL
4	2'6"x8'0"x1 3/8"	INTERIOR RAISED PANEL
5	2'4"x8'0"x1 3/8"	INTERIOR RAISED PANEL
6	2'0"x8'0"x1 3/8"	INTERIOR RAISED PANEL
7	2-2'0"x8'0"x1 3/8"	INTERIOR RAISED PANEL PAIR
8	2-2'6"x8'0"x1 3/8"	INTERIOR RAISED PANEL PAIR
9	3'0"x8'0"x1 3/8"	BARN DOOR

WINDOWS		
A	3'0"x6'0"	VINYL S.H. 4/1 LTS
B	3'0"x5'2"	VINYL S.H. 1/1 LTS
C	4'0"x1'0"	FIXED W/ SAFETY GLAZING (SECT. R308 IRC)

ENERGY PERFORMANCE RATING: U-FACTOR=.55; SOLAR HEAT GAIN COEFFICIENT=.35

GENERAL NOTES:

ATTIC VENTILATION WILL BE CONTINUOUS RIDGE VENTS AND PERFORATED SOFFITS. OR EQUAL

TERMITE SHIELDS WILL BE 26 GA GALVANIZED AT EACH PIER UNDER SILLS

#2 PINE LUMBER WILL BE USED FOR FRAMING LUMBER

CONTRACTOR TO REMOVE DEBRIS FROM PROPERTY

ENCLOSED AREAS BELOW FLOOD GRADE SHALL HAVE A MINIMUM OF 1 SQ. IN. PER 1 SQ. FT. OF WATER FLOW VENTING.

MINIMUM INSULATION REQUIRED

FLOORS- R-19

WALL- R-13


CEILING- R-38

BUILDING MATERIAL USED BELOW DESIGN FLOOD ELEVATION MUST BE WATER RESISTANT

WINDOWS INSTALLED IN BATHTUB ENCLOSURES LESS THAN 60" F.F.F. REQUIRE SAFETY GLAZING AND WINDOWS WITHIN 2' OF DOORS AND WITHIN 5' OF STAIRS

FLOOD VENTS WHERE APPLICABLE SHALL BE 1'-0" OR LESS ABOVE GRADE.

WINDOWS WHERE BOTTOM EDGE IS LESS THAN 18" REQUIRES SAFETY

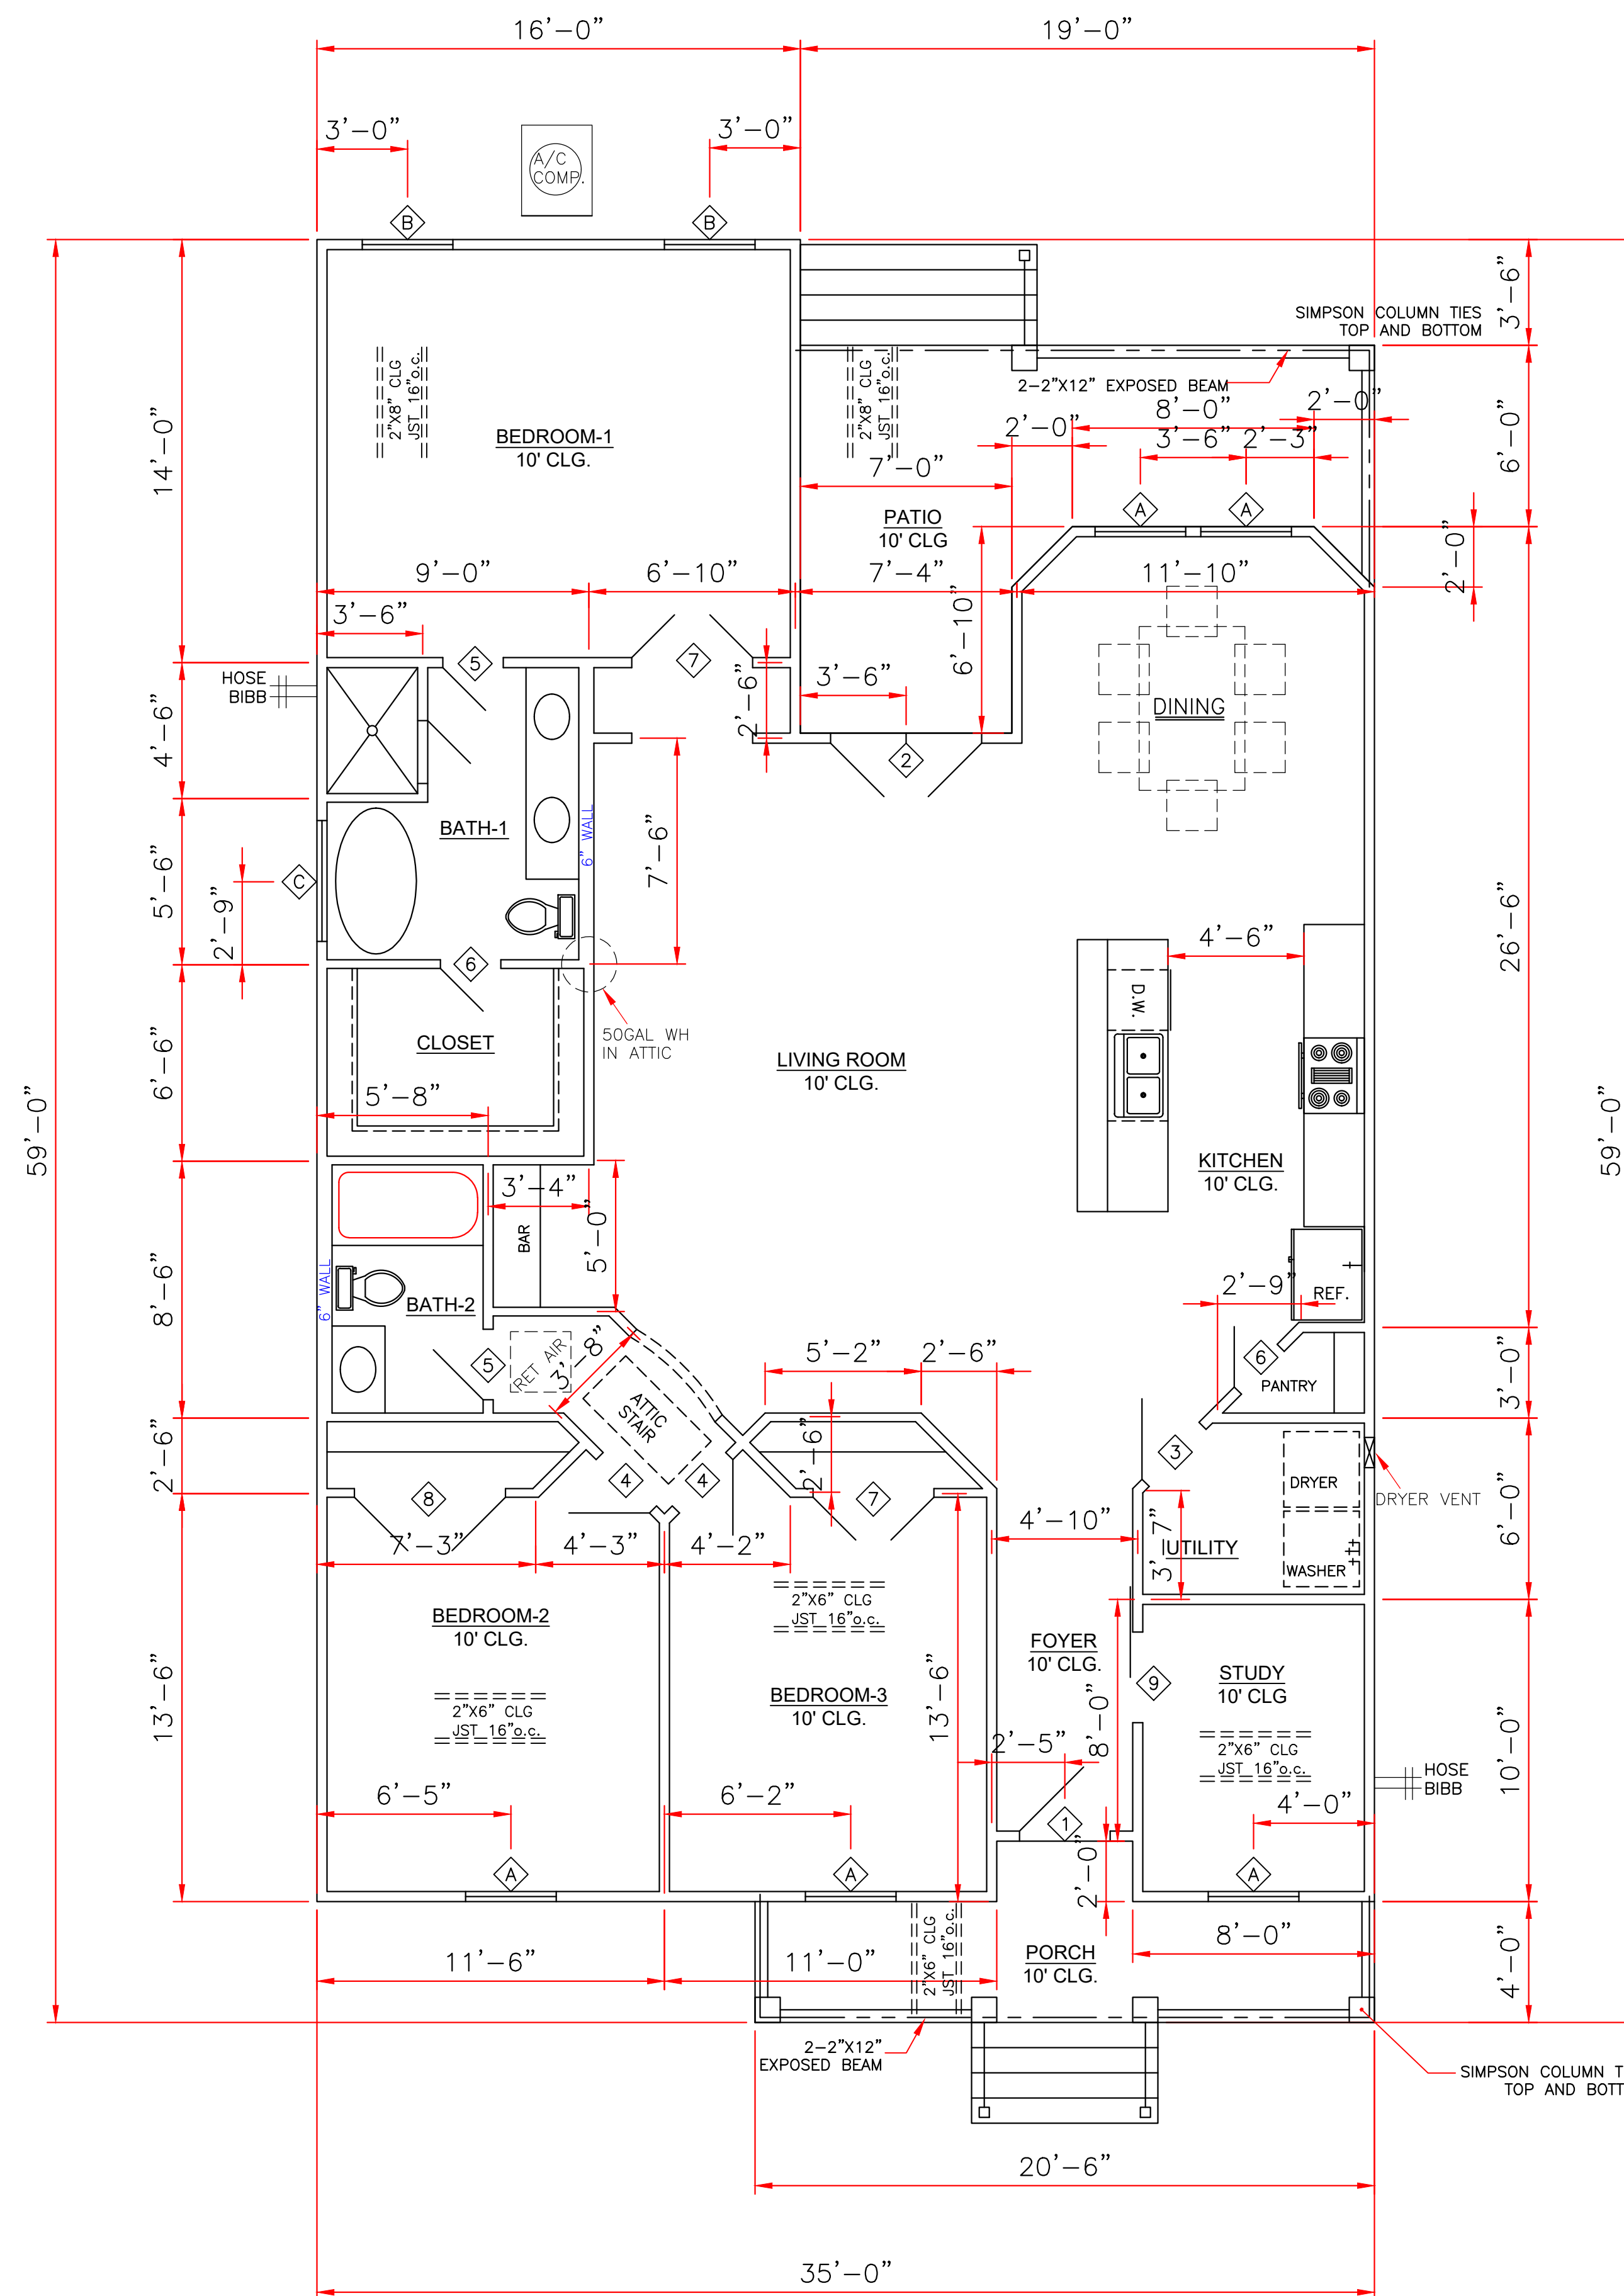

FLOOR PLAN


SCALE: 1/4" = 1'-0"

SQUARE FOOTAGE	
LIVING	1684
PORCH	69
PATIO	166
TOTAL	1919

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	<p>8307 LAFITTE CT. CHALMETTE, LA 70043</p>	<p>504-279-3508</p>	<p>DATE: 02/22/22</p>	<p>SHEET NO: 3 OF 6</p>





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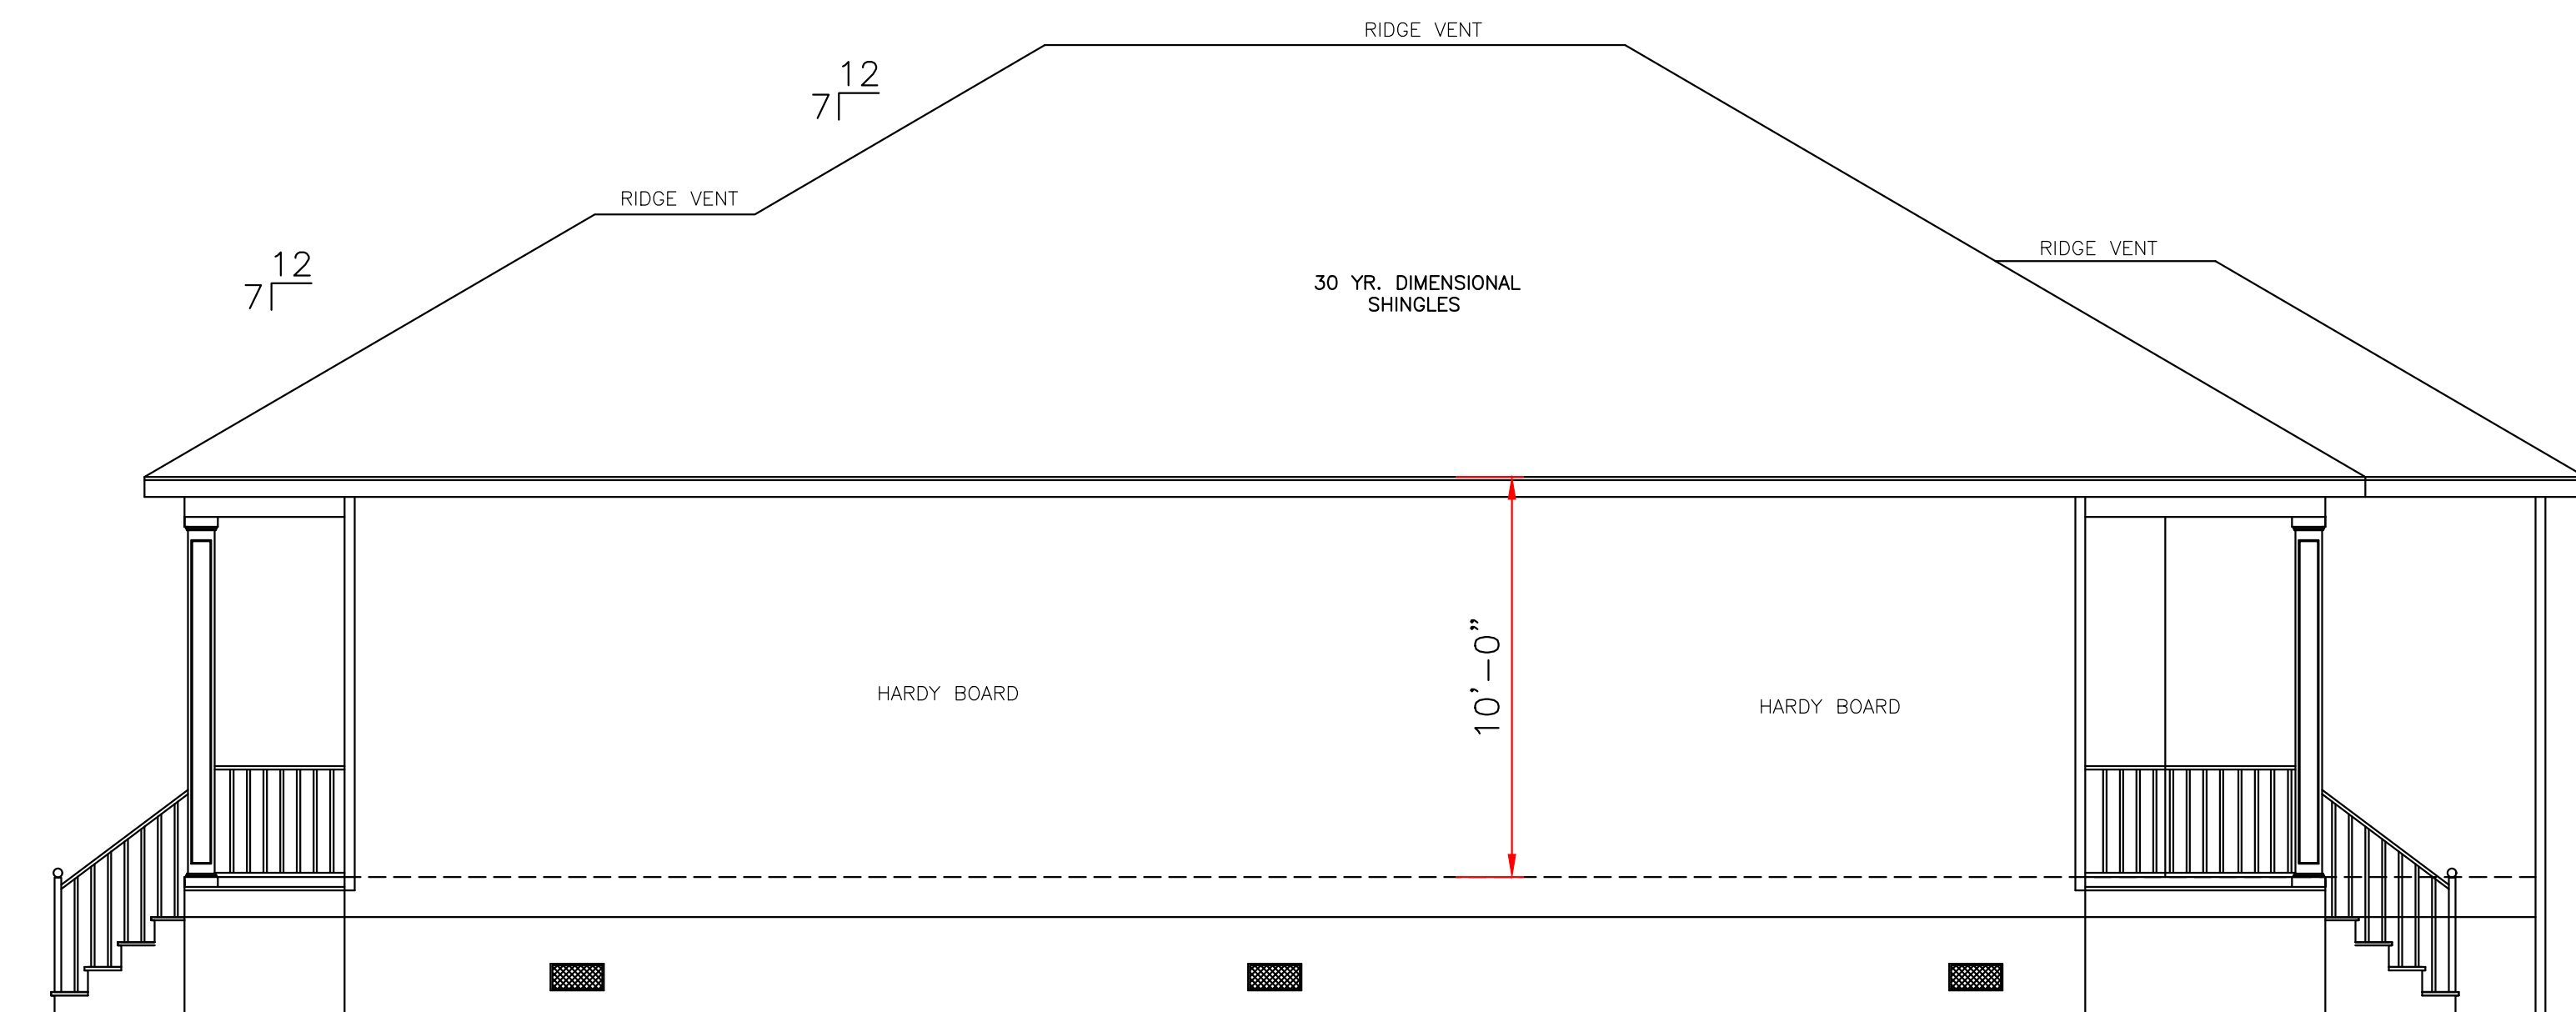
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WIND BORNE DEBRIS PROTECTION

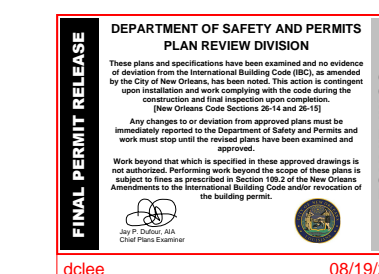
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LEFT ELEVATION
SCALE: 1/4" = 1'-0"



RIGHT ELEVATION
SCALE: 1/4" = 1'-0"

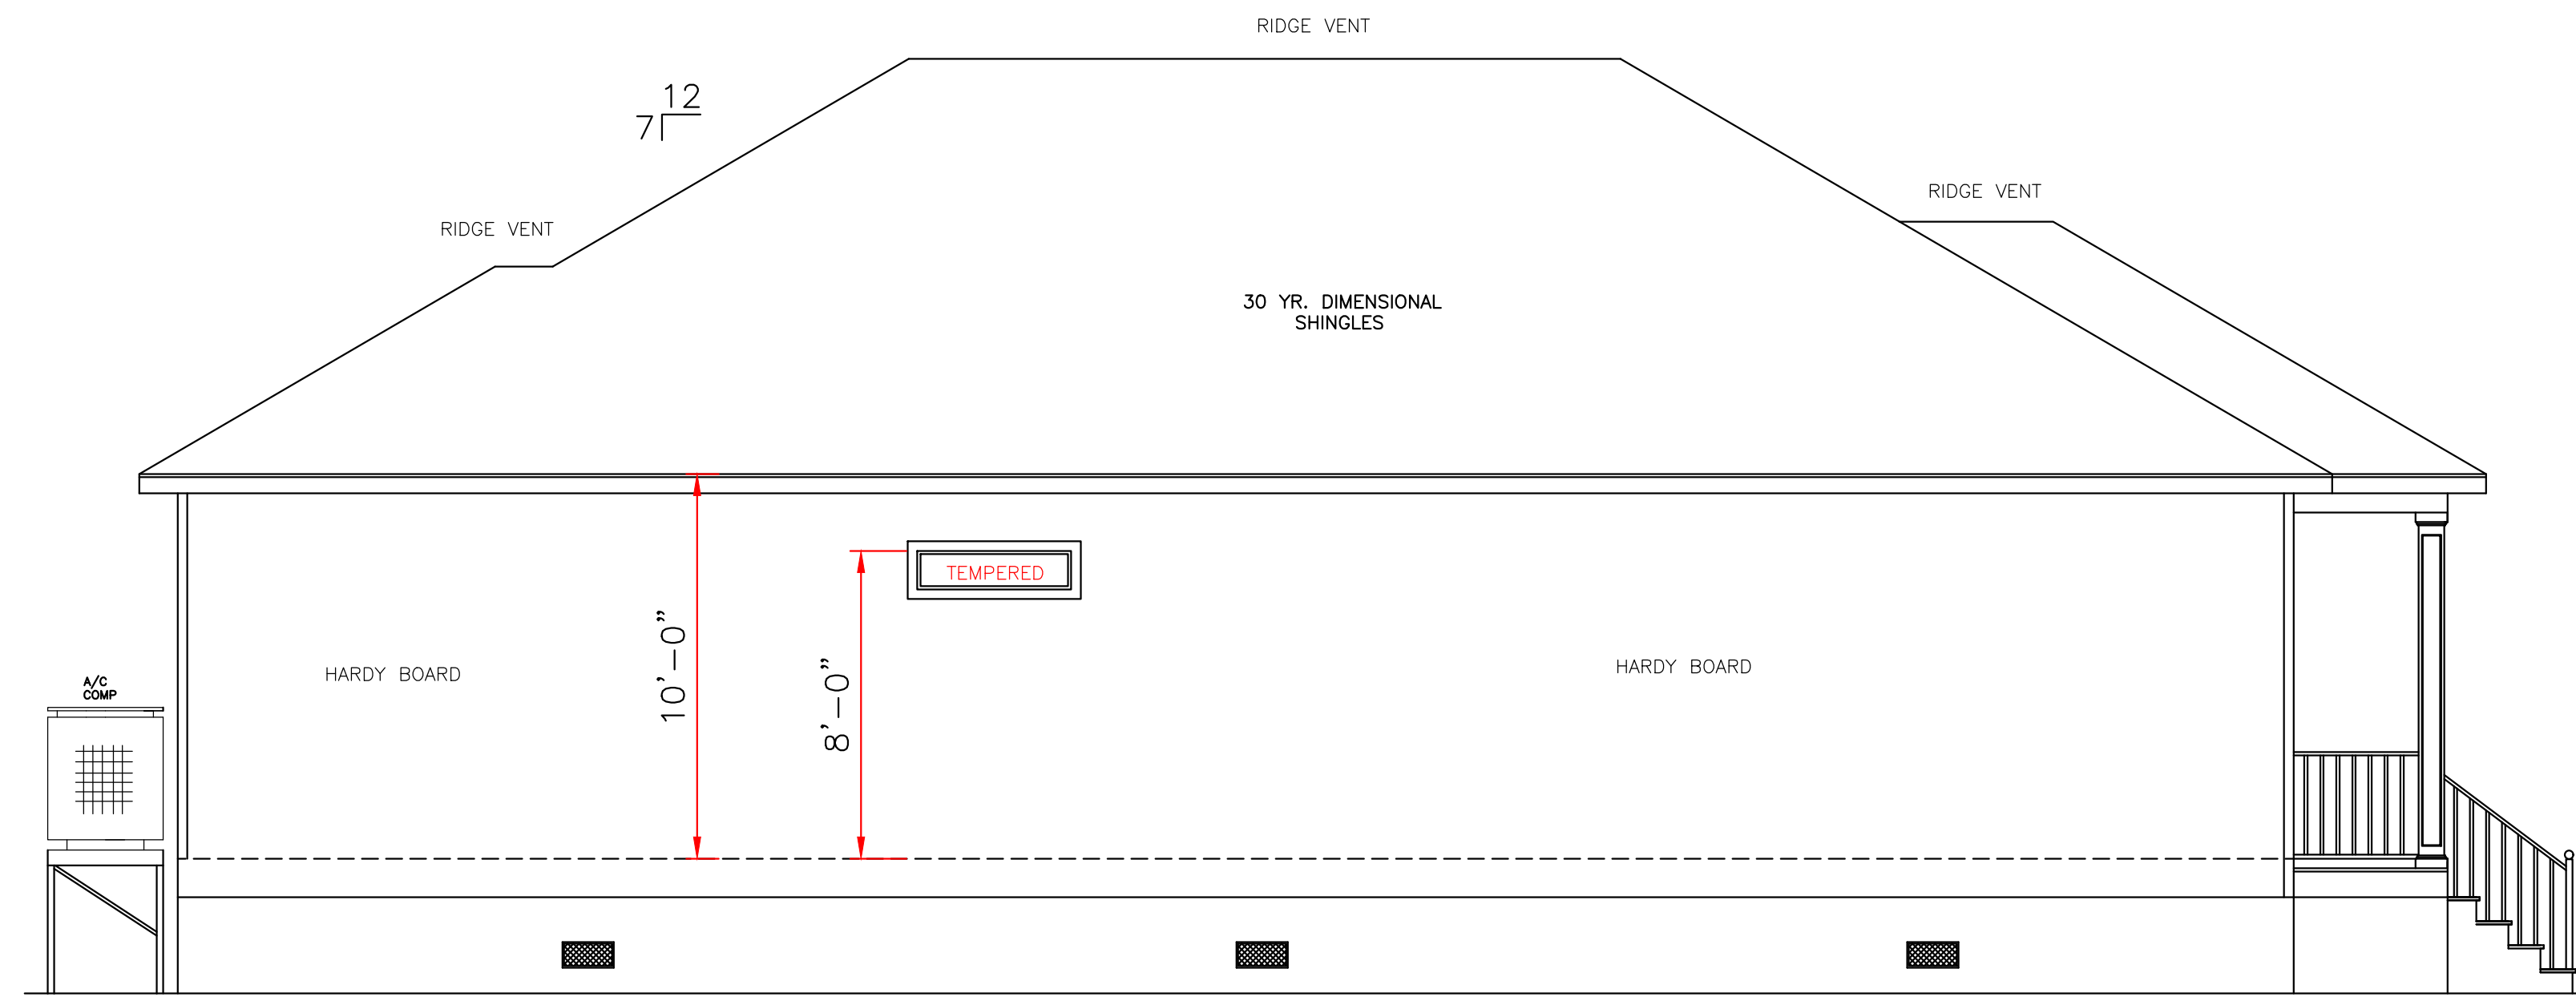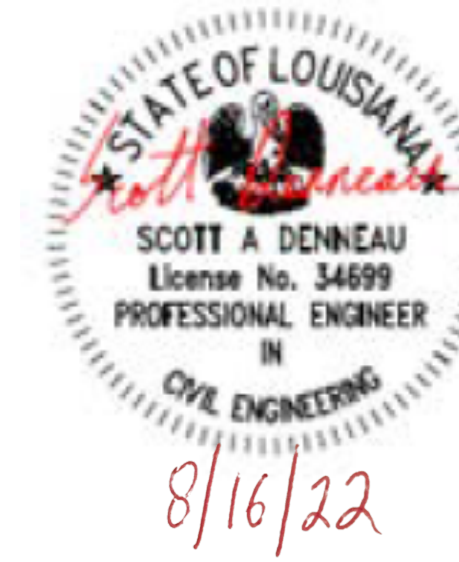


ROOF PLAN
SCALE: 1/8" = 1'-0"

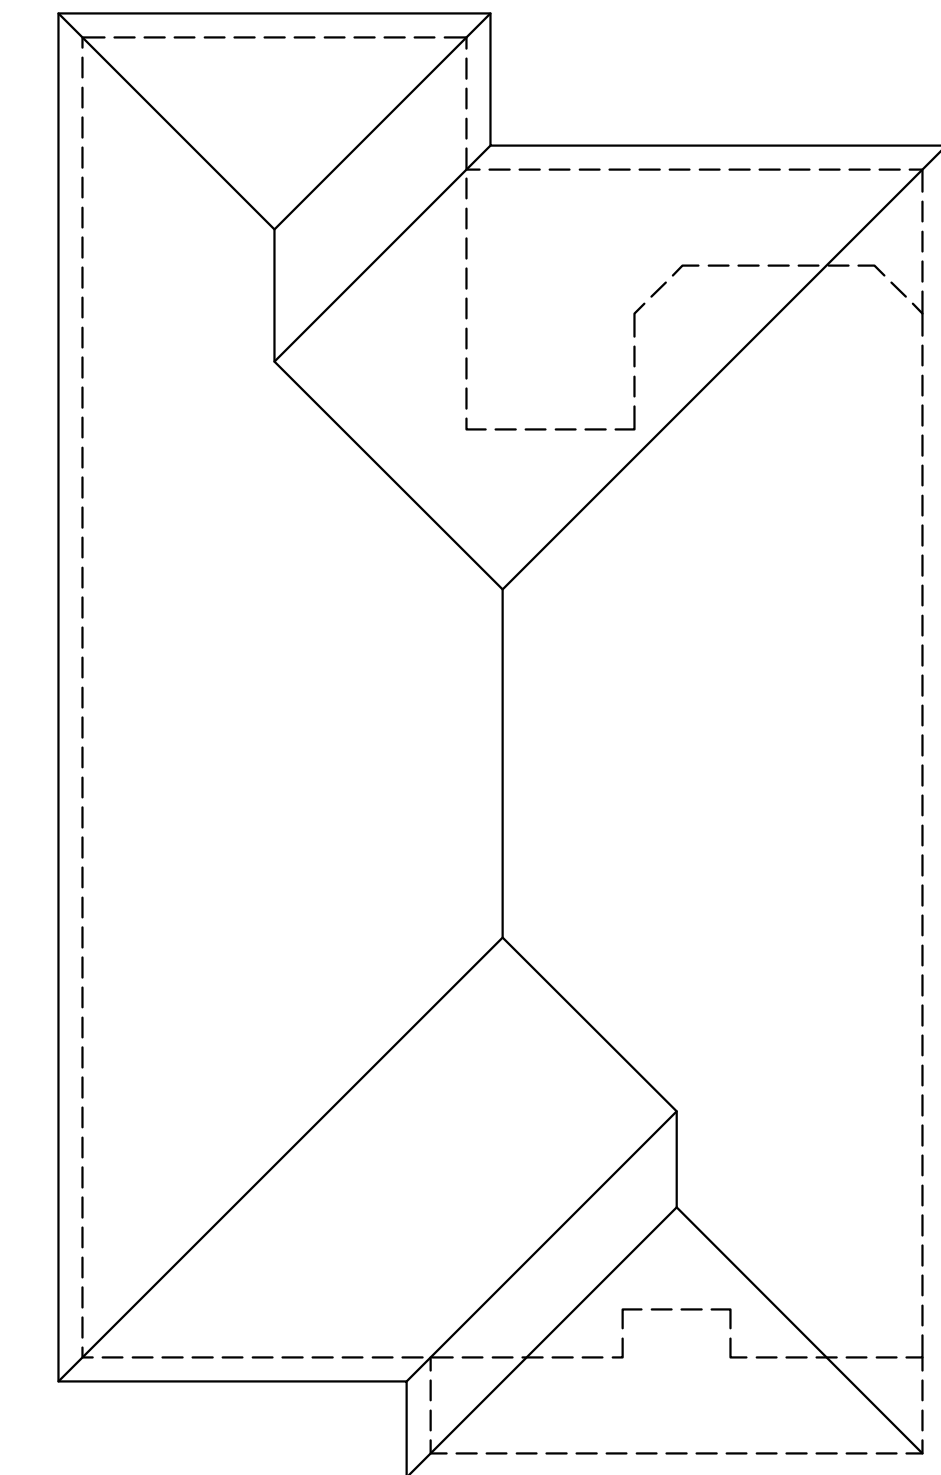ALL MATERIALS BELOW
BASE FLOOD MUST
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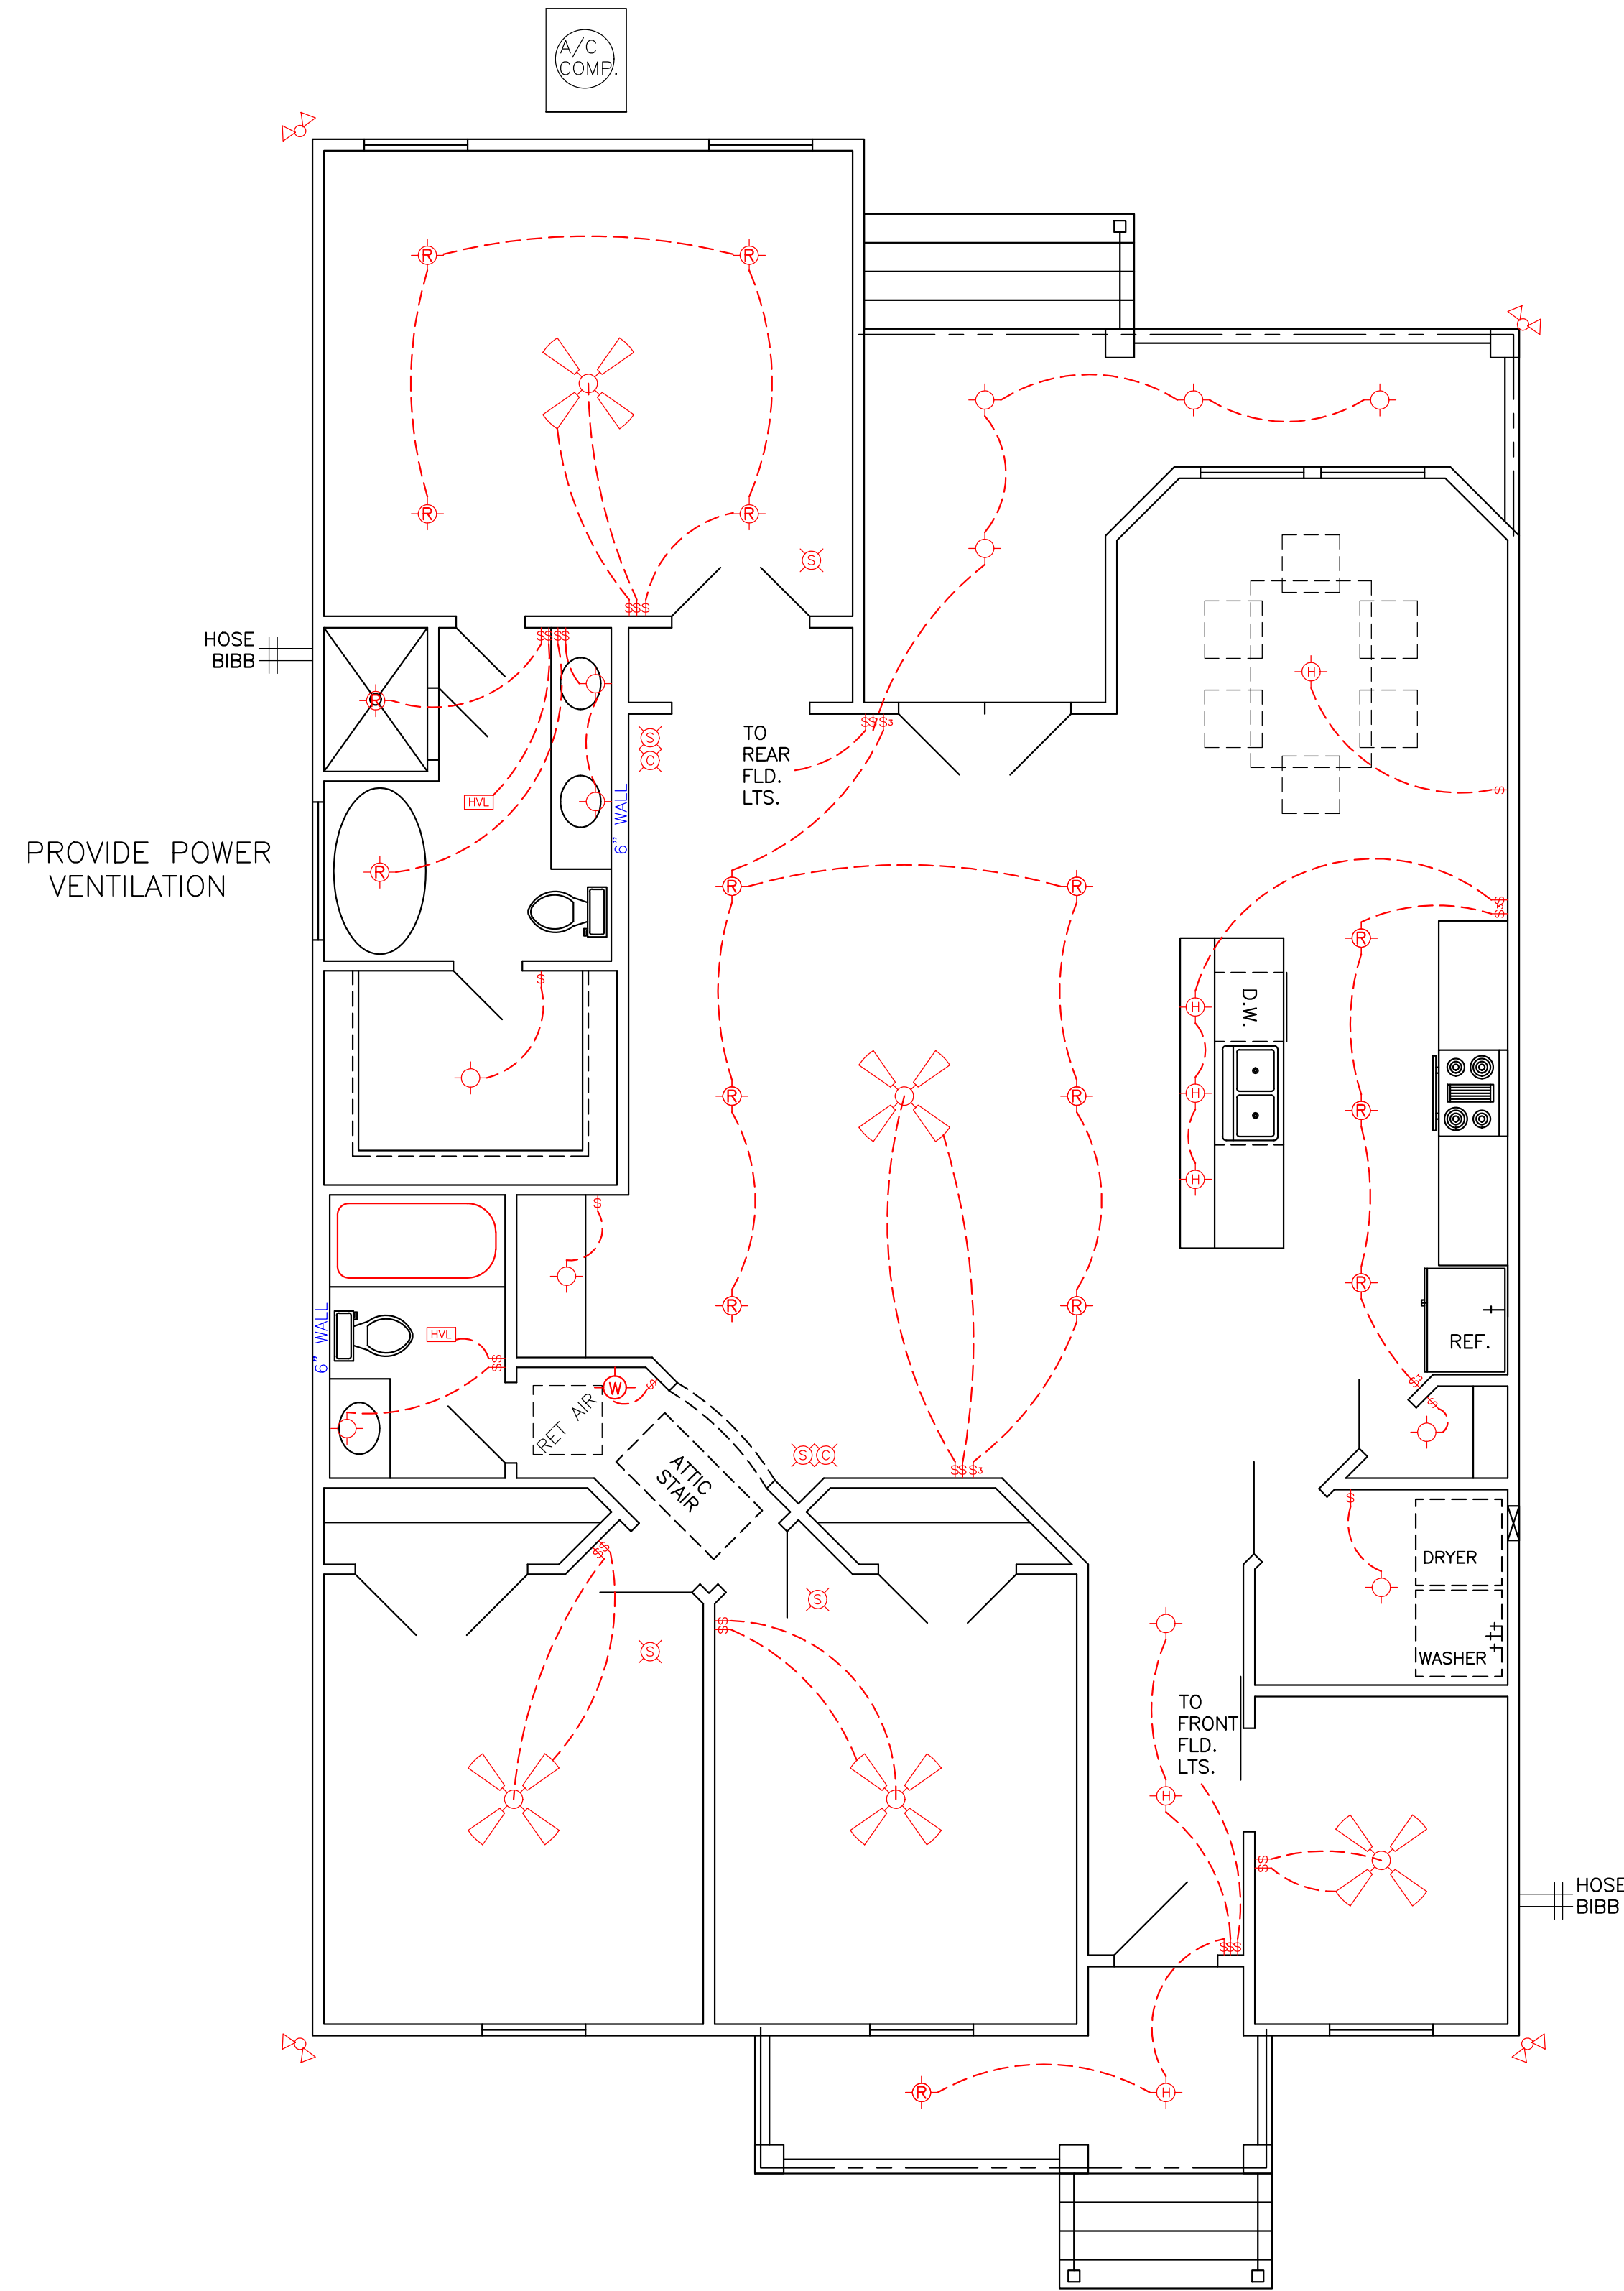
	LARRY TRUMBATURI		AMYRICK RUSSELL 7840 W. LAVERNE STREET ORLEANS PARISH, LA.	
	8307 LAFITTE CT. CHALMETTE, LA 70043 504-279-3508	JOB NO 8940	DATE 02/22/22	SHEET NO 4 OF 6

ELECTRICAL NOTES

1. AFCI PROTECTION SHALL BE PROVIDED FOR DINING ROOMS, FAMILY ROOMS, LIVING ROOMS, HALLWAYS, CLOSETS, BEDROOMS, ETC.
2. SMOKE DETECTORS: (A) SHALL BE INSTALLED IN EACH SLEEPING ROOM. (B) SHALL BE INSTALLED OUTSIDE, IN THE VICINITY OF EACH SLEEPING ROOM. (C) SHALL BE 120 VOLT, HARDWIRED, INTERCONNECTED, WITH A BATTERY BACKUP. (D) SHALL NOT BE INSTALLED WITHIN 36 INCHES OF A RETURN AIR GRILLE OR ANY PADDLE FAN BLADE.
3. KITCHEN: (A) ALL RECEPTACLES OVER COUNTERTOP SHALL BE GFI PROTECTED REGARDLESS OF DISTANCE FROM THE SINK. (B) THE DISHWASHER SHALL BE CONNECTED BY MEANS OF AN APPLIANCE CORD TO A RECEPTACLE UNDER THE SINK. THE RECEPTACLE WILL NOT BE GFI PROTECTED.
4. BATHROOMS: (A) ALL RECEPTACLES SHALL BE GFI PROTECTED. (B) LIGHTS OVER BATHTUBS SHALL HAVE COVERS THAT ARE LISTED FOR "DAMP LOCATION" (C) LIGHTS OVER SHOWERS SHALL HAVE COVERS LISTED FOR "WET LOCATION."
5. EXTERIOR RECEPTACLES SHALL ALL BE GFI PROTECTED AND SHALL HAVE WEATHERPROOF COVERS.
6. A RECEPTACLE (NOT SHOWN ON THE PLAN) WILL BE INSTALLED ON THE EXTERIOR WALL WITHIN 25 FEET OF THE AIR CONDITIONING EQUIPMENT.
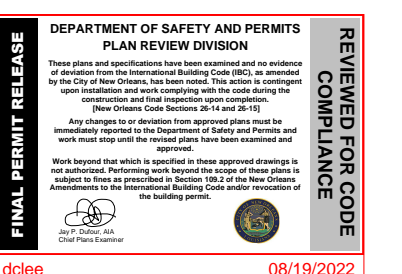
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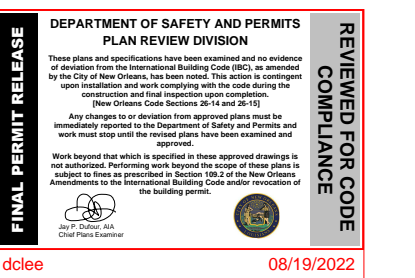
LEGEND	
	CEILING FAN
	RECESSED LIGHTS
	WALL SWITCH 15A., 120V., SINGLE POLE SINGLE THROW, MOUNT AT 60" AFF
	3 WAY WALL SWITCH 15A., 120V. MOUNT AT 60" AFF
	CEILING LIGHT INCANDESCENT, 2-60 WATT
	VENT/LIGHT FIXTURE
	CARBON MONOXIDE DETECTOR
	110 VOLT WATER PROOF OUTLET
	FLOOD LIGHTS
	110 VOLT SMOKE DETECTOR
	110 VOLT OUTLET
	HANGING LIGHT FIXTURE
	WALL LIGHT FIXTURE
	DIMMER LIGHT FIXTURE

ELECTRICAL PLAN
SCALE: 1/4" = 1'-0"

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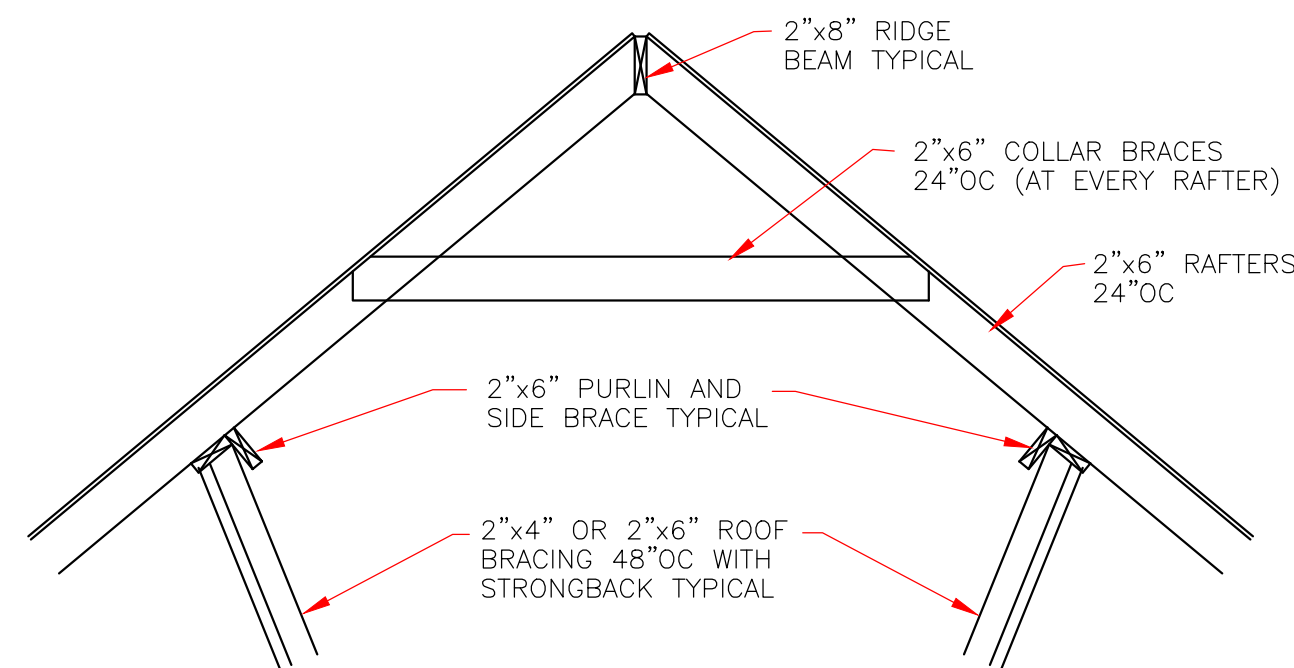
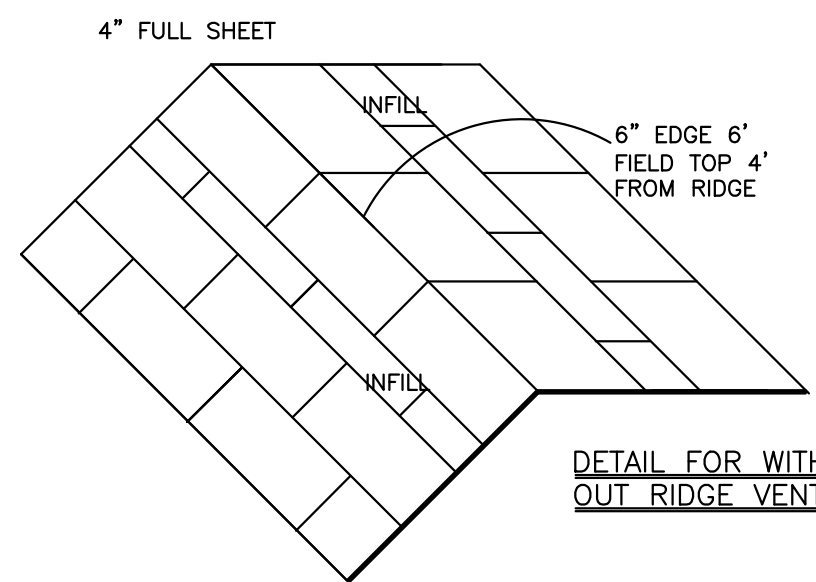
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	<p>DATE: 02/22/22 SHEET NO: 5 OF 6</p>


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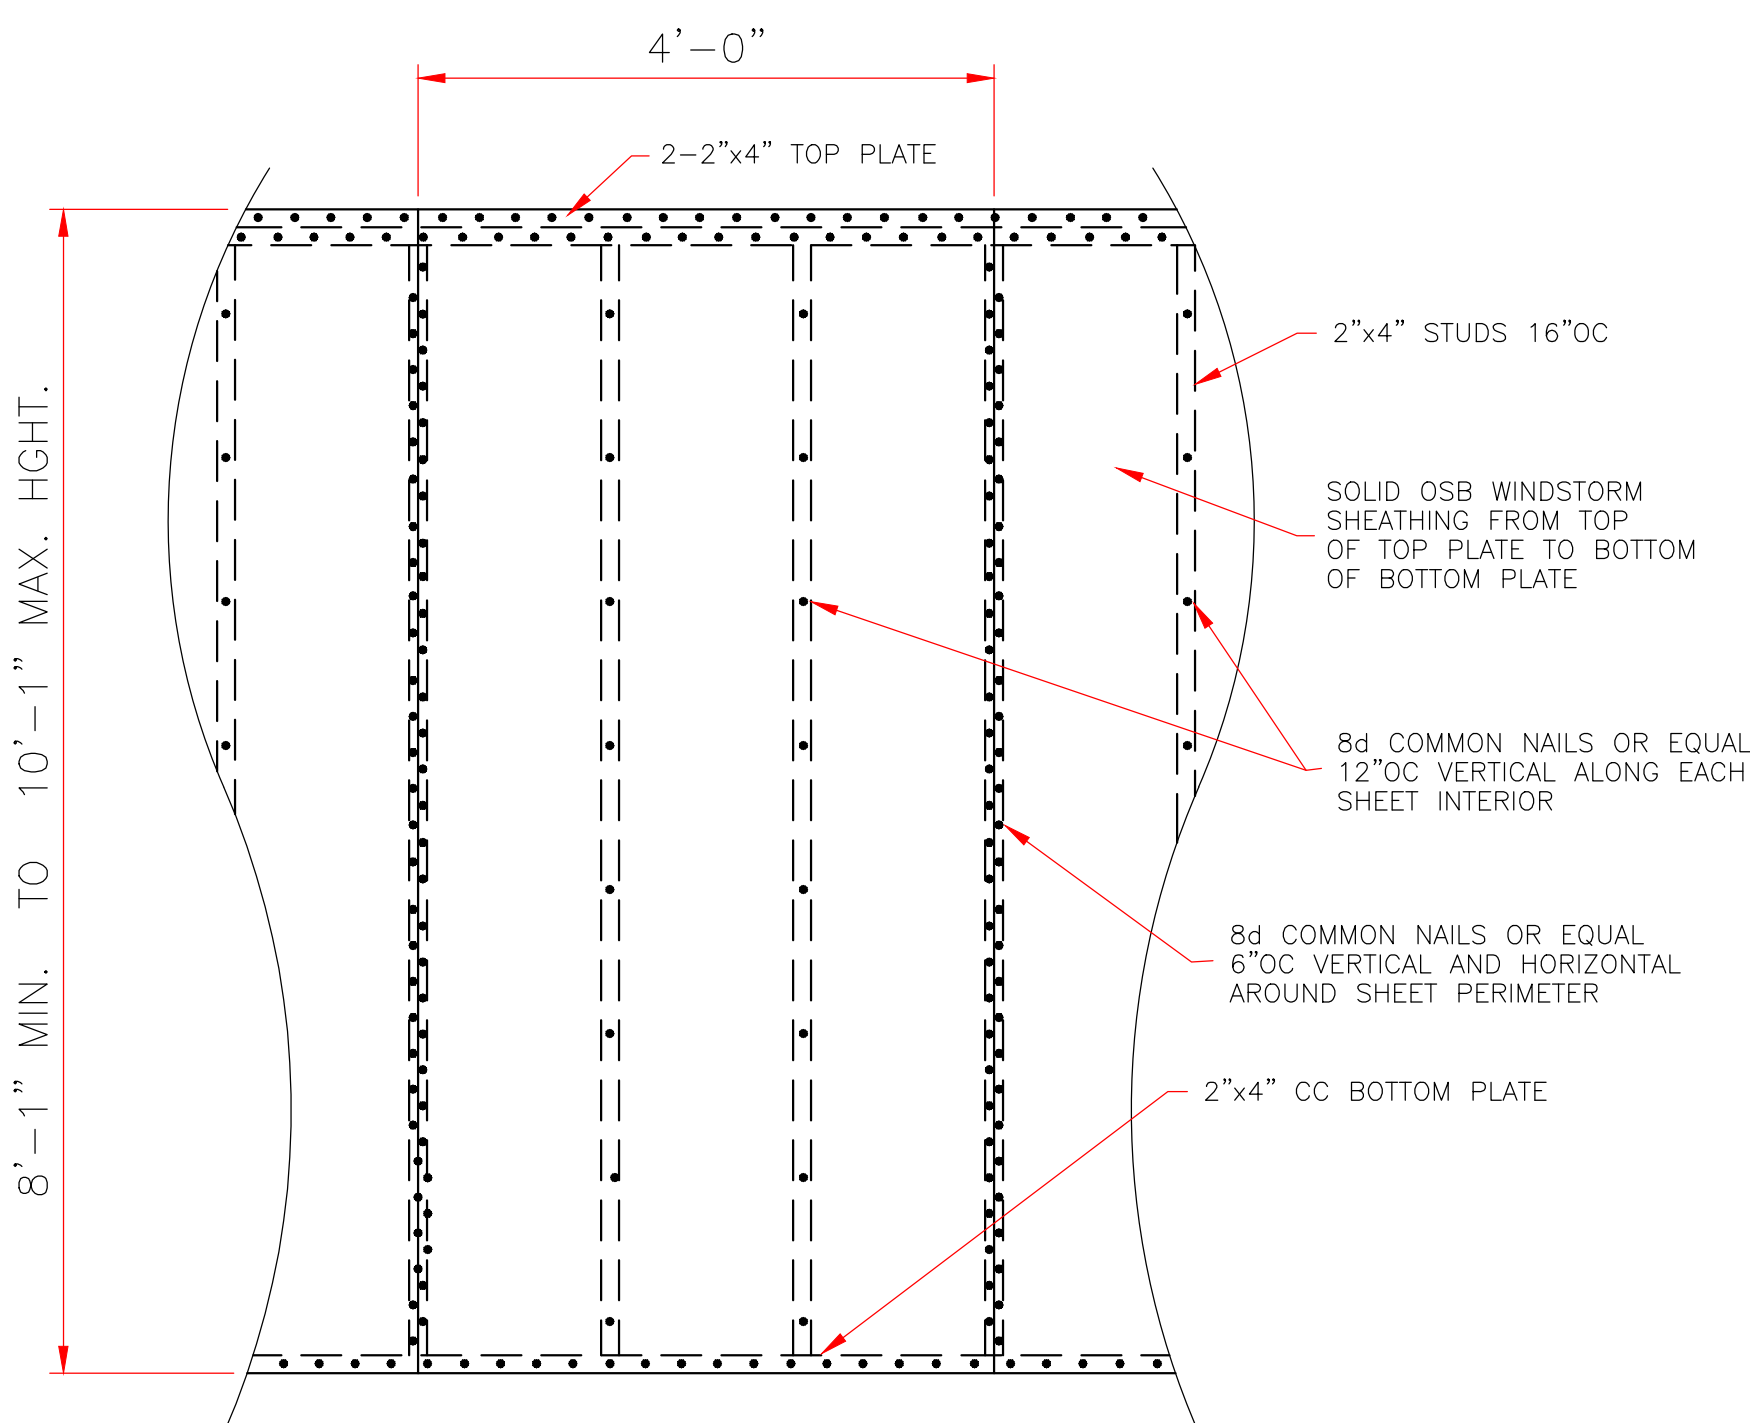
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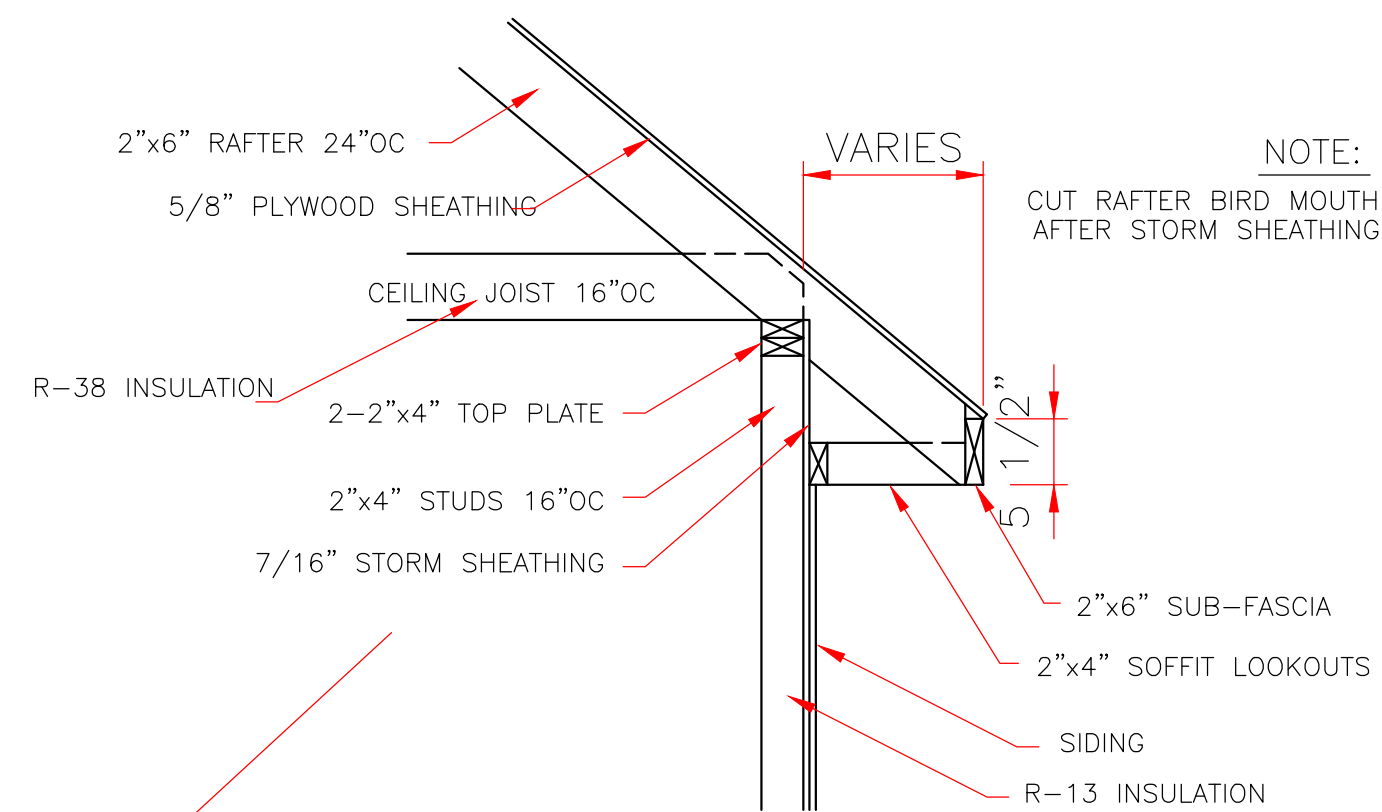
TYPICAL ROOF BRACING DETAIL
NOT TO SCALE




RAFTER TO TOP PLATES
NOT TO SCALE




7/16\"/>

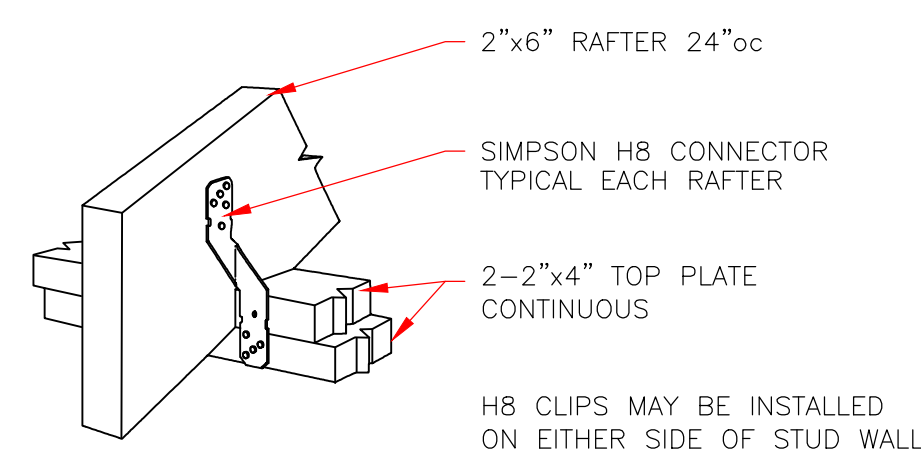

ROOF SOFFIT DETAIL
SCALE: 3/4" = 1'-0"

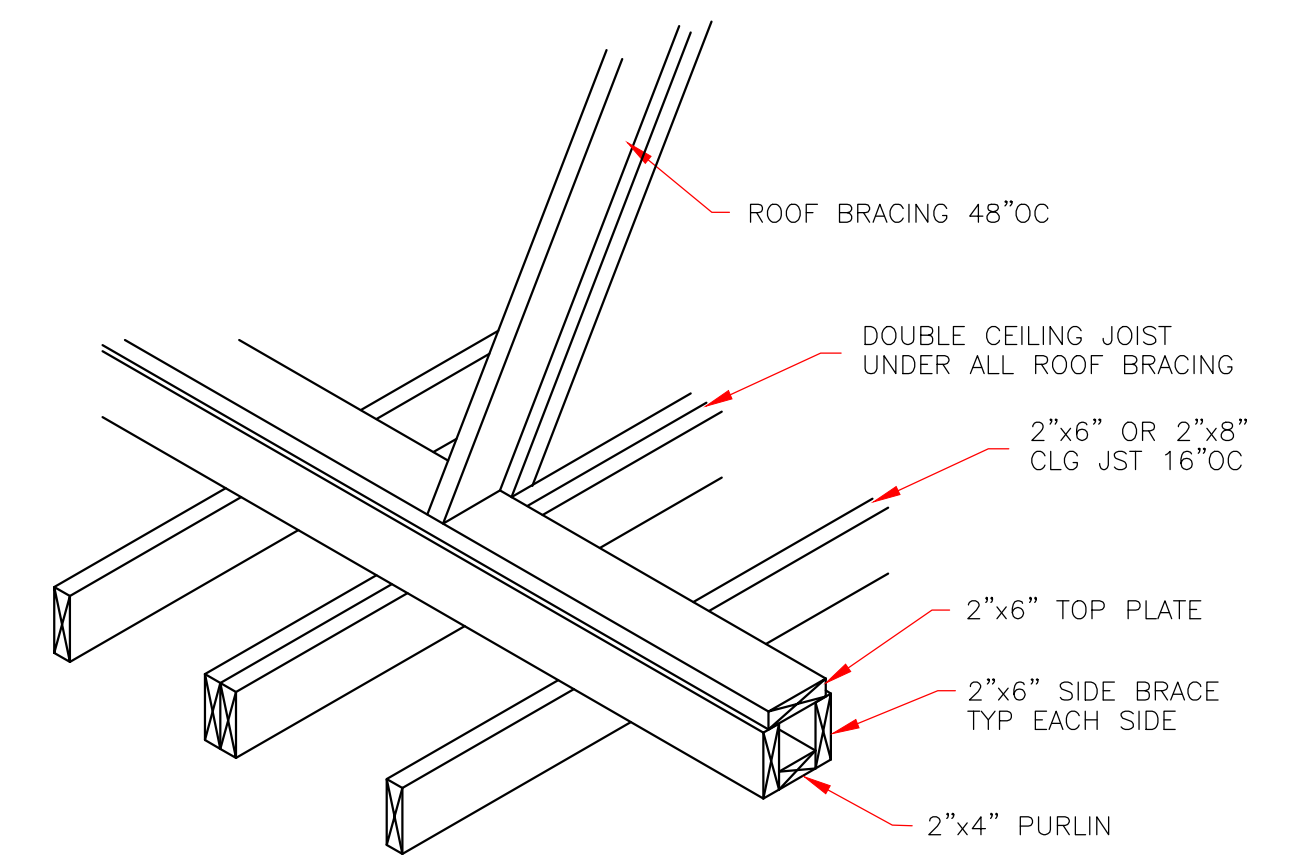

STRONGBACK DETAIL
FOR 2" X 6" OR 2" X 8" JOIST
NOT TO SCALE

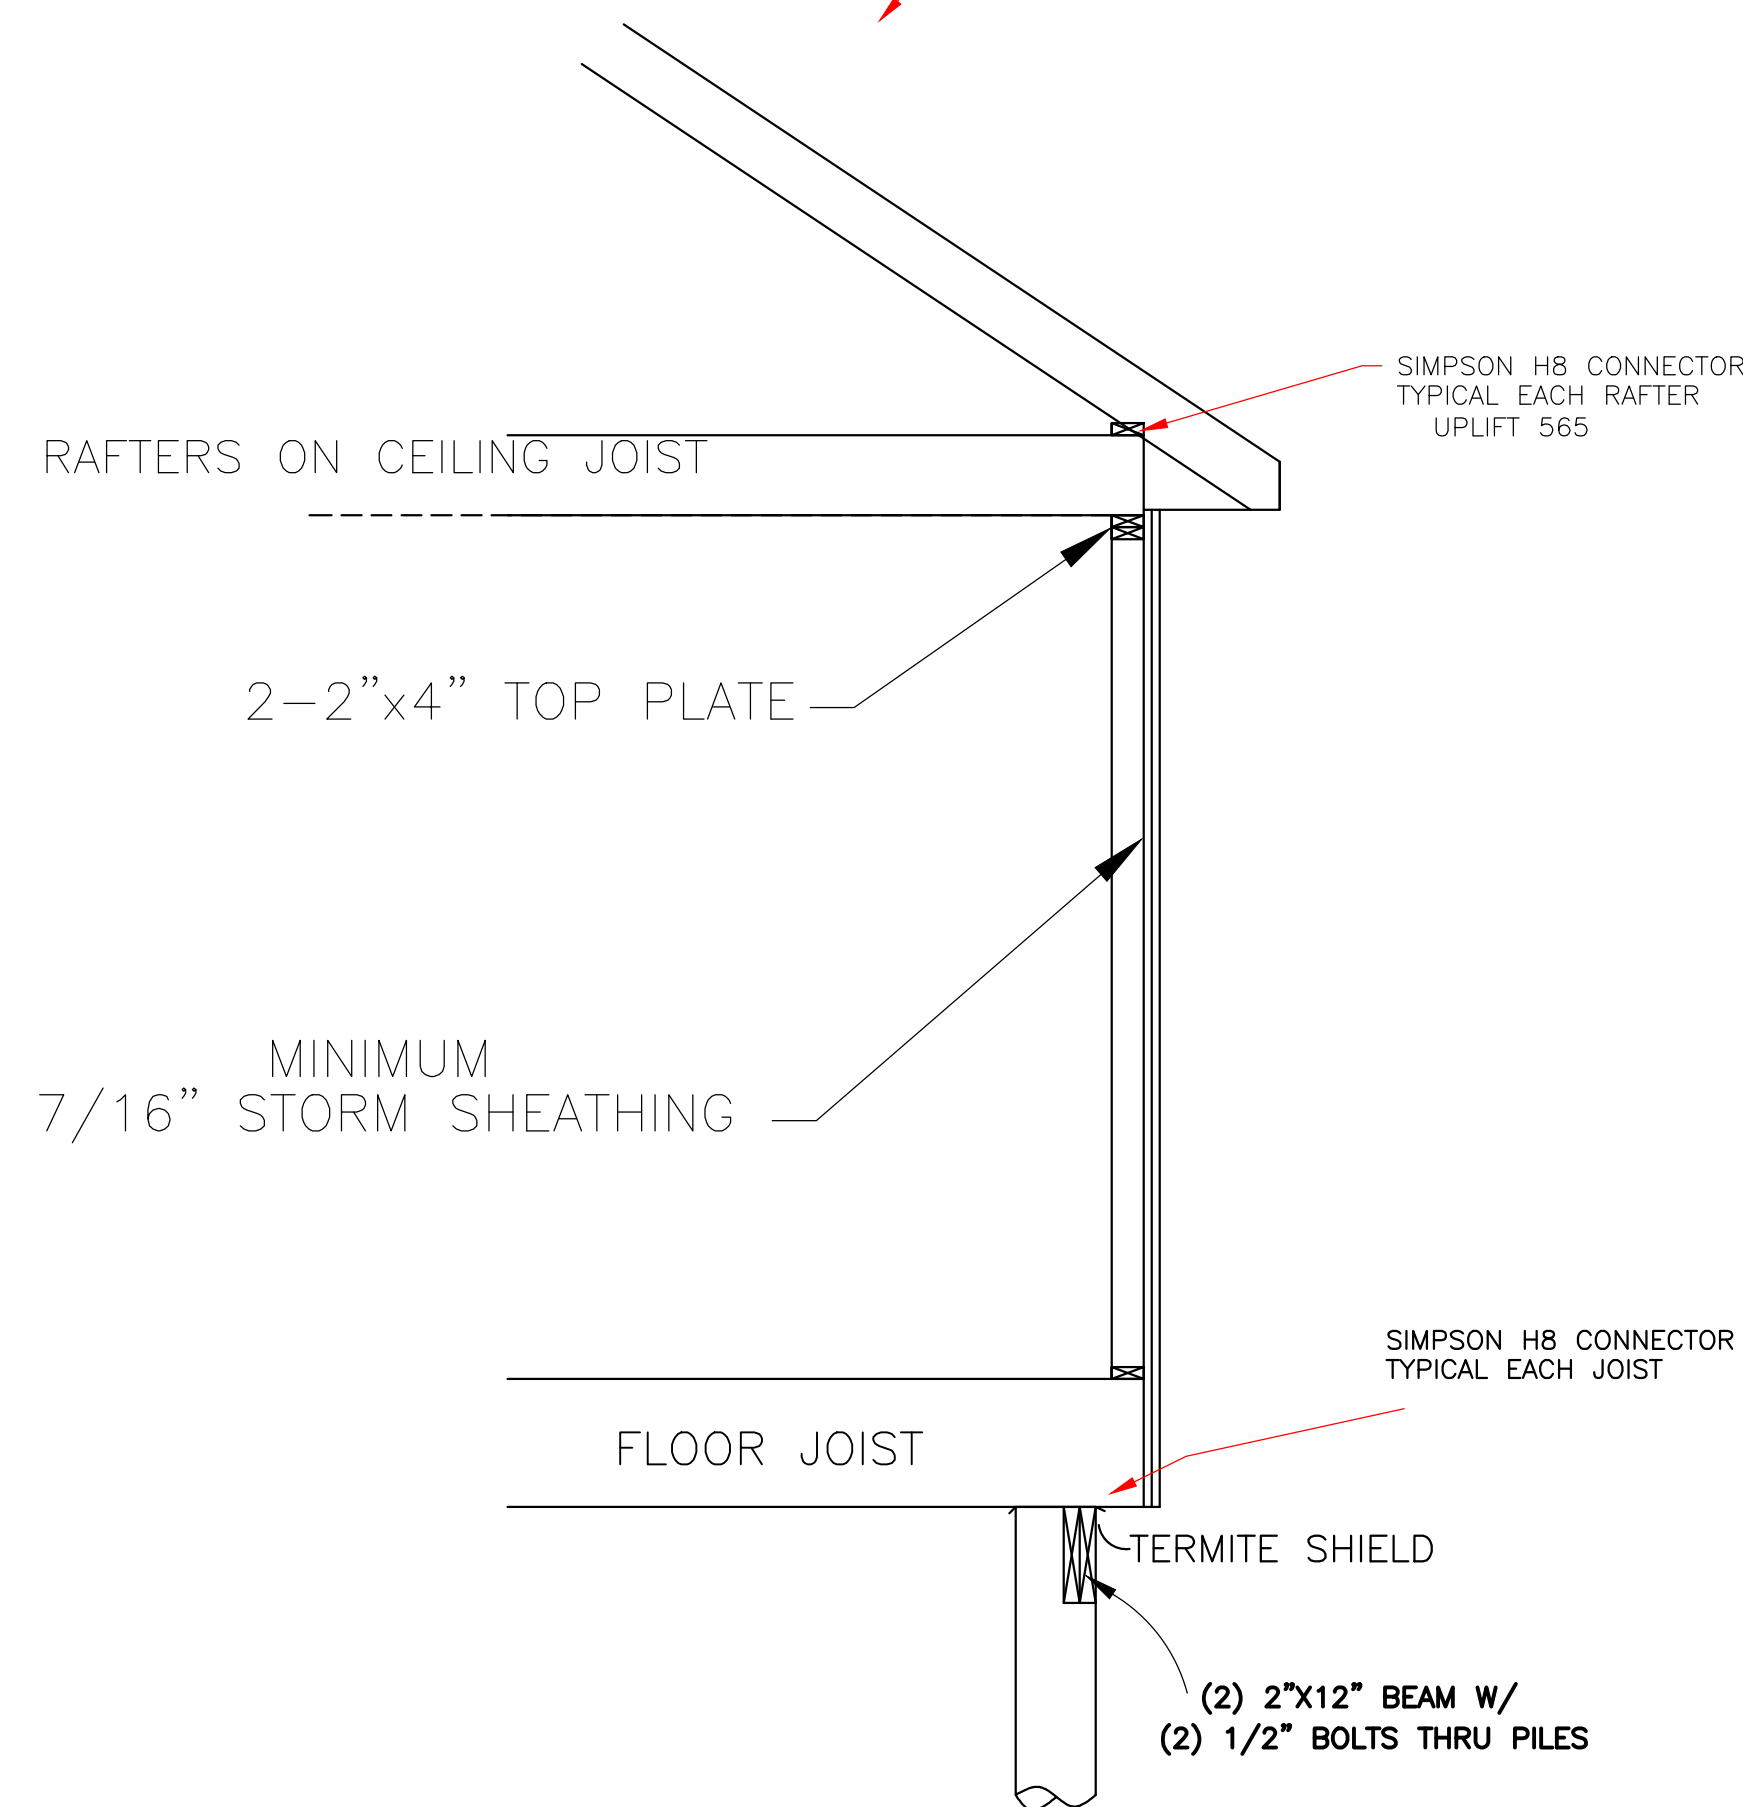


SEE FOUNDATION DETAIL
CONTINUOUS LOAD PATH
1/2" SCALE


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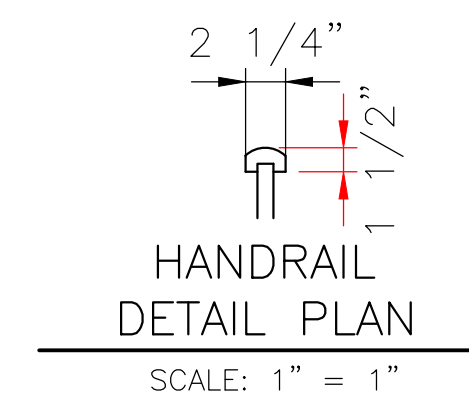
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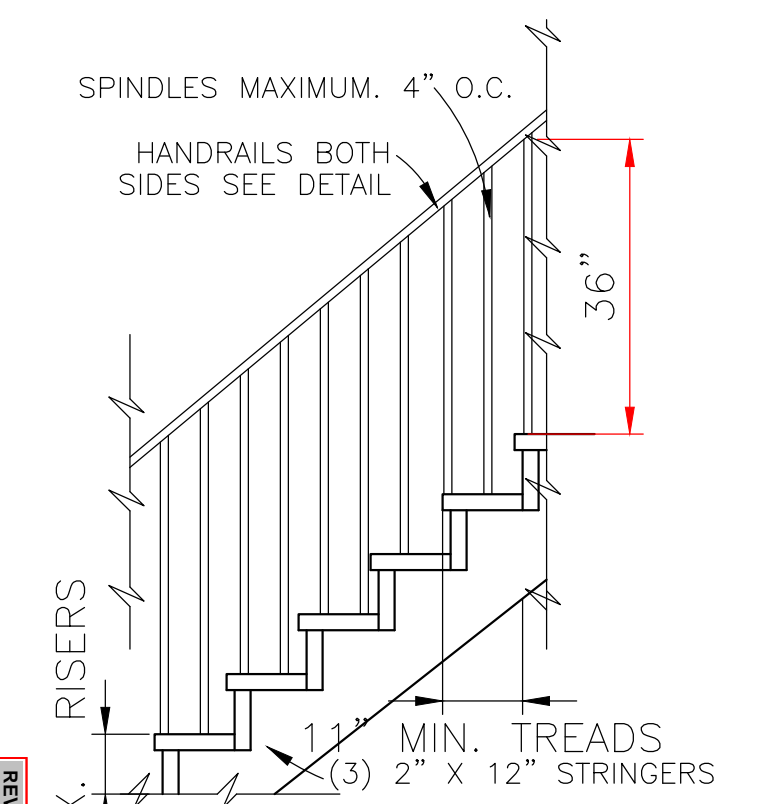
COLUMN SECTION
NOT TO SCALE



TYPICAL EXTERIOR DOOR OR WINDOW HEADER
SCALE: 3/4" = 1'-0"

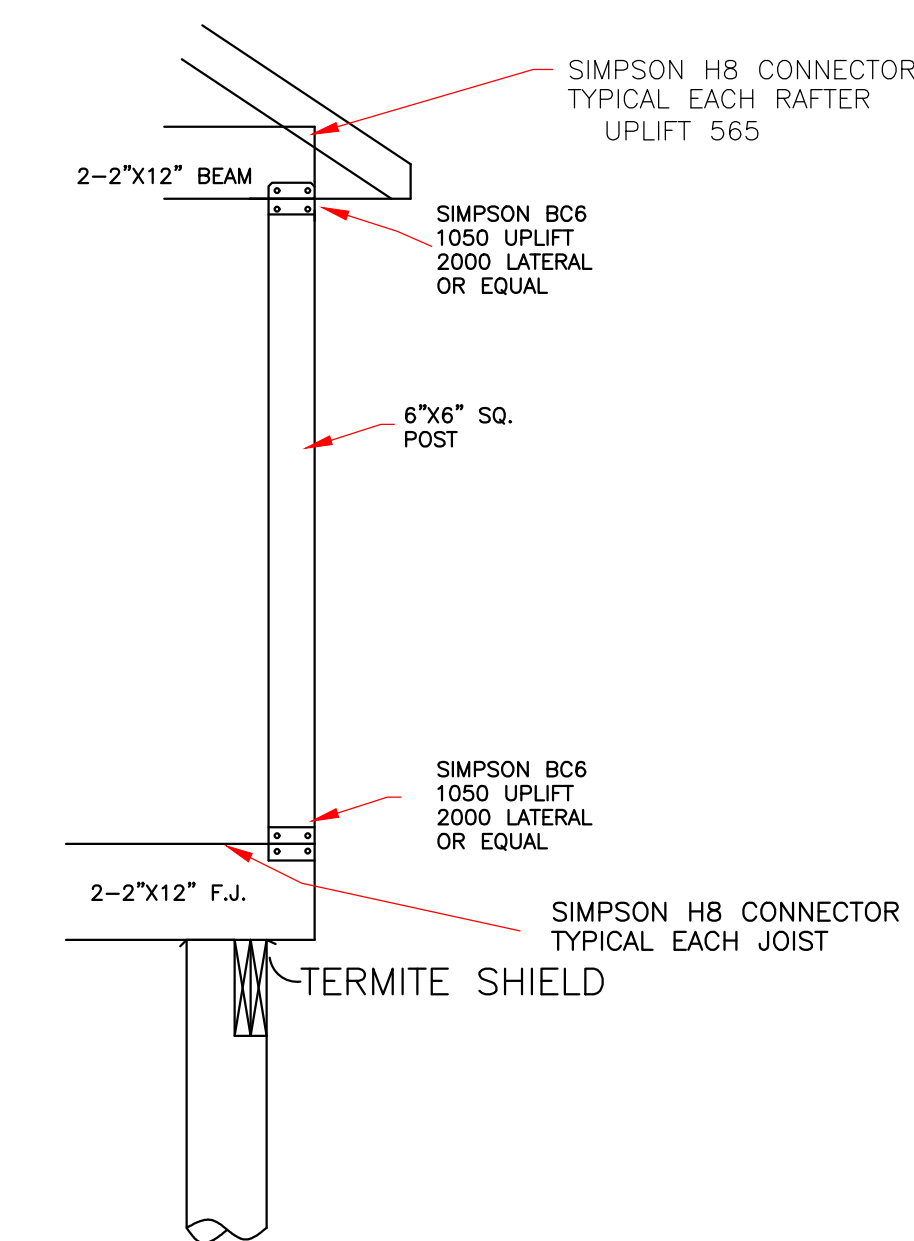

HANDRAIL DETAIL PLAN
SCALE: 1" = 1"

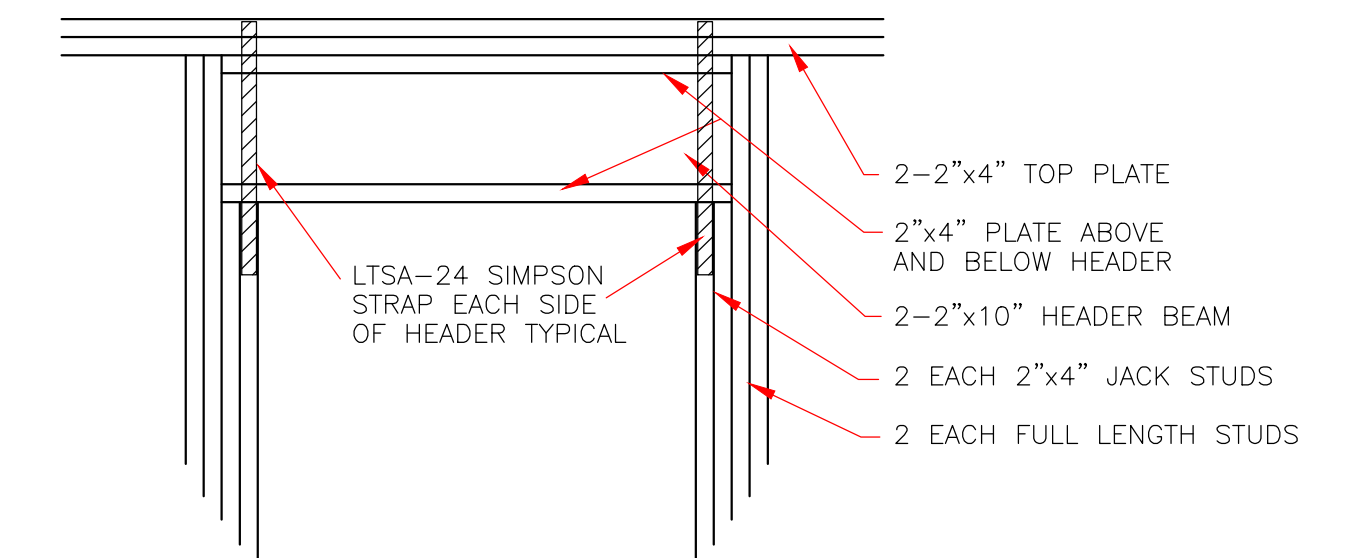

STAIR DETAIL PLAN
SCALE: 1/2" = 1'-0"

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504-279-3508	JOB NO 8940	02/22/22	6 OF 6

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