

CONSTRUCTION DOCUMENTS

936 ST ROCH AVE - INTERIOR RENOVATION

936 ST ROCH AVE.
NEW ORLEANS, LA 70117

PROPERTY DESCRIPTION
ROCH AND N RAMPART 36X63 DBLE/FR 2/STORY 10/RM AND BAR A/R
2476 N RAMPART & 936-39 ST ROCH AVE

PROJECT DESCRIPTION
INTERIOR RENOVATION OF AN EXISTING 'WHITE BOX' 2 STORY
WOOD FRAMED STRUCTURE. TENANT BUILDOUT ON 1ST FLOOR -
RETAIL, BUILDOUT ON 2ND FLOOR - 2 APARTMENT RESIDENTIAL

ZONING DISTRICT: HMR-3, RDO-1 RESIDENTIAL DIVERSITY OVERLAY
DISTRICT
HDLC DISTRICT: FAUBOURG MARIGNY

NO. OF STORIES: 2 (EXISTING)
1: 2,000 SF
2: 1,500 SF
TOTAL: 3,500 SF GROSS SF

CONSTRUCTION TYPE:
IBCFIC: NFPA COMMON TERMINOLOGY:
TYPE V-B V (000) UNPROTECTED COMBUSTIBLE

SPRINKLERED / FIRE ALARM:
NO / NO

APPLICABLE CODES:
2015 IBC
2015 INTERNATIONAL MECHANICAL CODE
2013 LOUISIANA STATE PLUMBING CODE
2014 NATIONAL ELECTRIC CODE
2015 ADA ADDA GUIDELINES

ELECTRICAL ENGINEER:
EDS LLC
RAUL VALDEZ
3328 BANKS ST.
NEW ORLEANS, LA 70119
RAUL@EWITHD.COM



STRUCTURAL/CIVIL ENGINEER:
PACE GROUP LLC
JOHANN PALACIOS
400 S JEFF PARKWAY
NEW ORLEANS, LA 70119
JOHANN@PACEGROUPLLC.COM

MECHANICAL / PLUMBING ENGINEER:
RITTER CONSULTING ENGINEERS
ANDREA MANCAUX, P.E.
2014 WEST PINHOOK ROAD
SUITE 200
LAFAYETTE, LA 70508
PHONE: 337-984-8498
ANDREA@RITTERCONSULTINGENGINEERS.COM

PROJECT INFORMATION

- THE GENERAL CONTRACTOR IS RESPONSIBLE TO SUPPLY ALL SUBCONTRACTORS WITH CONSTRUCTION DRAWINGS AND SPECIFICATIONS NECESSARY TO BID AND/OR CONSTRUCT THIS PROJECT.
- TO THE GENERAL CONTRACTOR AND ALL SUBCONTRACTORS, ALL CONTRACTORS ARE RESPONSIBLE TO NOTIFY THE ARCHITECT OF ANY ERRORS, OMISSIONS OR DISCREPANCIES PRIOR TO MAKING ANY CHANGES TO THE CONSTRUCTION DOCUMENTS.
- ALL DIMENSIONS ON THE FLOOR PLANS, UNLESS OTHERWISE NOTED, ARE TAKEN FROM INSIDE FACE OF STUDS OF EXTERIOR WALLS, INSIDE FACE OF STUDS OF NEW INTERIOR PARTITIONS, FACES OR CENTERLINE OF STRUCTURAL COLUMNS, AND FACES OF EXISTING WALLS. THE OWNER SHALL BE RESPONSIBLE FOR NOTIFYING THE GENERAL CONTRACTOR FOR ALL WALL HUNG ITEMS TO BE INSTALLED THAT ARE NOT ON THE DRAWINGS.
- IN ACCORDANCE WITH GENERALLY ACCEPTED CONSTRUCTION PRACTICES, THE CONTRACTOR WILL BE SOLELY AND COMPLETELY RESPONSIBLE FOR CONDITIONS OF THE JOB SITE, INCLUDING SAFETY OF ALL PERSONS AND PROPERTY DURING PERFORMANCE OF WORK. THIS REQUIREMENT WILL APPLY CONTINUOUSLY AND NOT BE LIMITED TO NORMAL WORKING HOURS. THE CONTRACTOR SHALL TAKE ALL NECESSARY PRECAUTIONS TO INSURE THE SAFETY OF THE PUBLIC AND/OR WORK PERSONS ON THE JOB TO PREVENT ACCIDENTS OR INJURY TO ANY PERSON ON, ABOUT OR ADJACENT TO THE PREMISES. THE CONTRACTOR SHALL COMPLY WITH ALL LAWS, ORDINANCES, CODES, RULES AND REGULATIONS RELATIVE TO SAFETY AND THE PREVENTION OF ACCIDENTS.
- WHETHER OR NOT SPECIFICALLY INDICATED ON THE DRAWINGS, ALL CONTRACTORS SHALL BE RESPONSIBLE FOR REMOVING OR DEMOLISHING EXISTING CONSTRUCTION (INCLUDING UTILITIES) WHICH WILL INTERFERE WITH NEW WORK.
- PRIOR TO THE SHUT-DOWN OF TYING INTO ANY UTILITY, APPROVAL SHALL BE OBTAINED FROM THE OWNER'S REPRESENTATIVE.
- THE CONSTRUCTION DRAWINGS CONTAIN INFORMATION FOR MULTIPLE CONTRACTORS.
- CONTRACTOR SHALL PROVIDE AND INSTALL ALL MATERIALS IN ACCORDANCE WITH ALL LOCAL, STATE, AND FEDERAL CODES.
- ALL PERMIT FEES SHALL BE PAID BY CONTRACTOR.
- CONTRACTOR SHALL BE RESPONSIBLE FOR AND PAY FOR ALL UTILITY DEPOSITS, IMPACT FEES AND CONNECTION FEES REQUIRED.

GENERAL NOTES

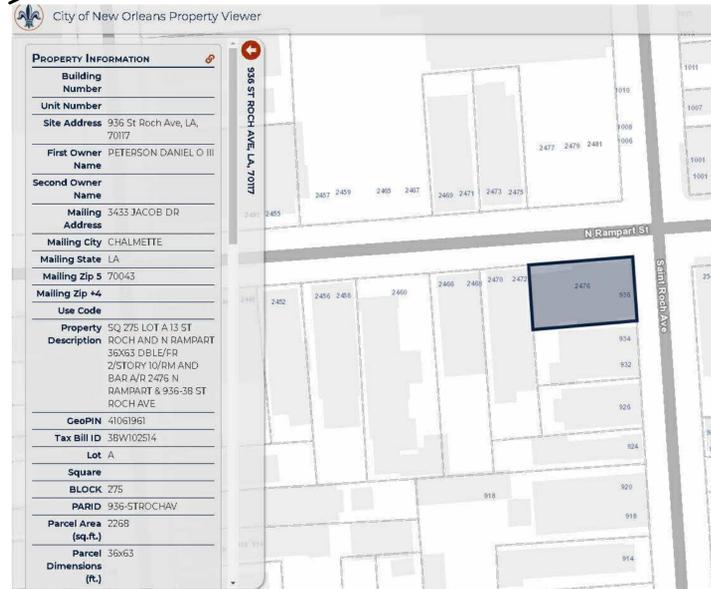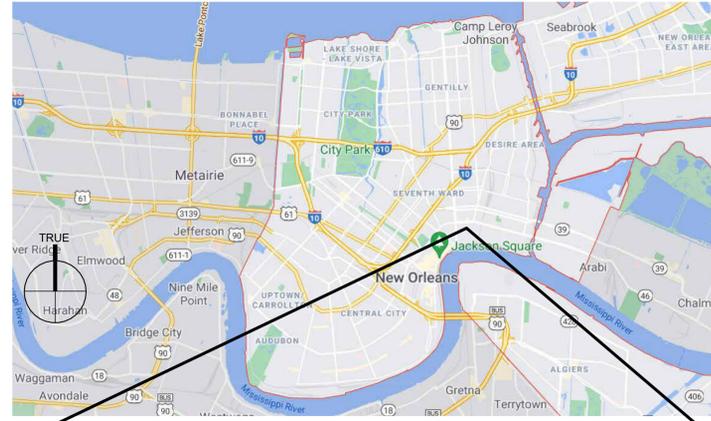

ELEVATION:

	GYPSUM BOARD
	CLEAR GLASS
	ACCENT GLAZING
	PLASTIC LAMINATE
	ACCENT PLASTIC LAMINATE

SECTION:



	PLYWOOD
	BATT INSULATION
	SPRAY INSULATION
	CONCRETE
	STEEL

LEGEND - HATCH

	ELEMENT TO BE REMOVED
	NEW WALL
	EXISTING WALL
	COLUMN LINE & TAG
	ELEVATION TAG
	DOOR TAG
	PARTITION TAG
	SPECIFIC NOTE
	WINDOW TAG

	SPECIFICATION #	A#	ITEM TAG
	ROOM NAME	101	ROOM TAG
	1	AXX	DETAIL TAG
	1	A1.0	SECTION TAG

LEGEND - PLAN

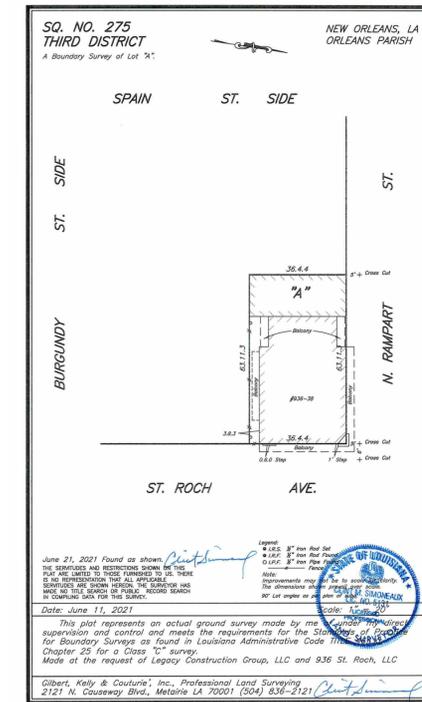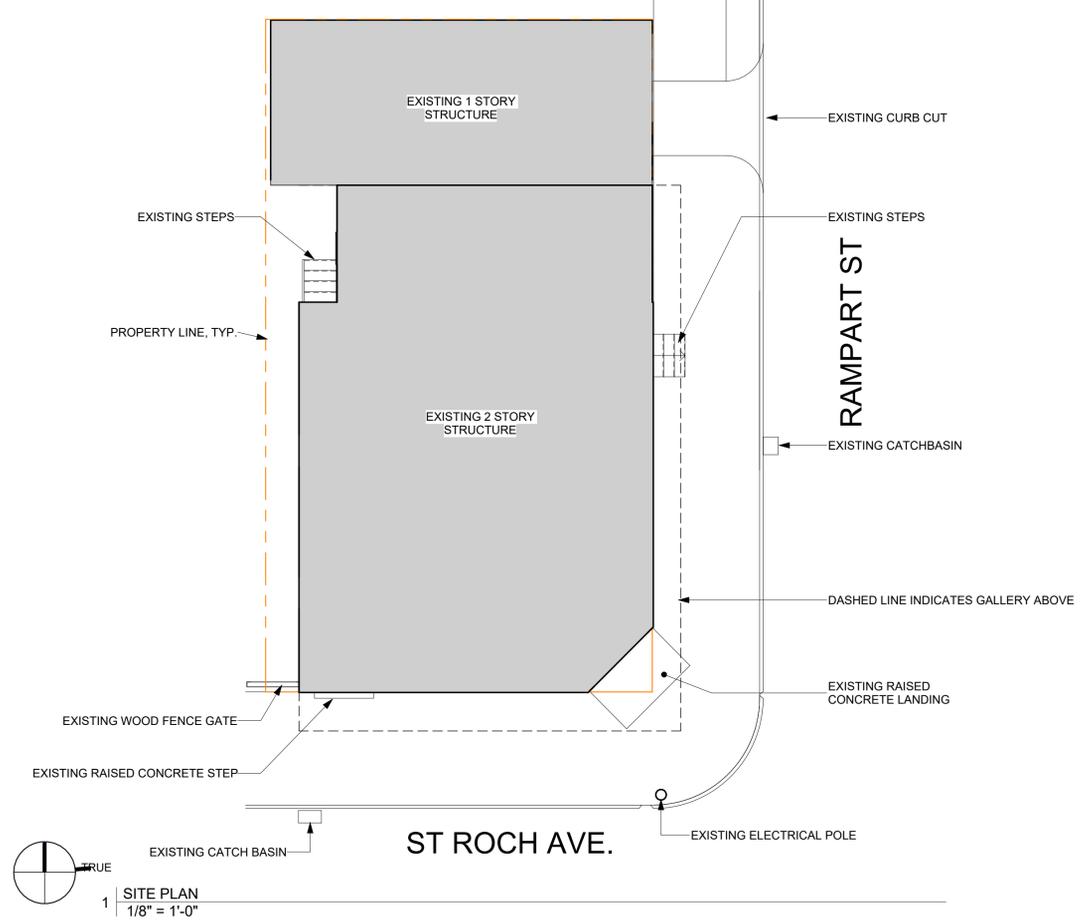

SHEET LIST

Sheet Number	Sheet Name	Sheet Issue Date	Current Revision	Current Revision Date	Current Revision Description
A1.0	TITLE SHEET	08/09/22			
A1.1	EXISTING PLANS & ELEVATIONS	08/09/22			
A1.2	NOTES	08/09/22			
A2.0	LIFE SAFETY PLAN	08/09/22			
A3.0	FLOOR PLANS	08/09/22			
A4.0	REFLECTED CEILING PLAN	08/09/22			
A5.0	BUILDING SECTIONS	08/09/22			
A6.0	DOORS	08/09/22			

CONSULTANTS SHEET LIST

Sheet Number	Sheet Name	Sheet Issue Date	Current Revision Date
M1.0	MECHANICAL SITE AND ROOF PLANS	08/01/22	
M2.0	PLUMBING PLANS	08/01/22	
M3.0	PLUMBING SCHEDULE	08/01/22	
M3.2	MECHANICAL PLANS	08/01/22	
M4.0	MECHANICAL SCHEDULE	08/01/22	
E0.0	SCHEDULES AND ABBREVIATIONS	08/01/22	
E0.1	GENERAL ELECTRICAL	08/01/22	
E0.2	SPECIFICATIONS	08/01/22	
E2.0	LIGHTING	08/01/22	
E3.0	POWER & SS	08/01/22	
E6.0	PANEL SCHEDULES & POWER RISER DIAGRAM	08/01/22	

21_089

DATE

TYPE (SEE CHANGE LOG)

#



M3 DESIGN GROUP
3328 BANKS ST | NO. LA 70019 | (504) 345-8950
WWW.M3-DESIGN-GROUP.COM

PERMIT SET
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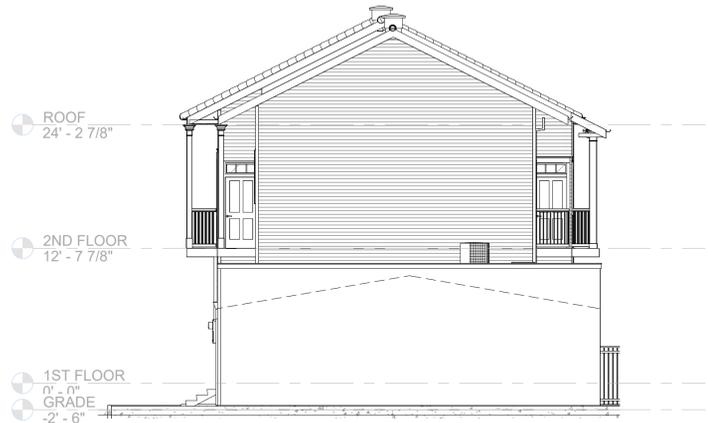
A1.0
TITLE SHEET

936 ST ROCH AVE - INTERIOR RENOVATION
936 ST ROCH AVE.
NEW ORLEANS, LA 70117

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3 | PLAN EAST ELEVATION
1/8" = 1'-0"




4 | PLAN NORTH ELEVATION
1/8" = 1'-0"



5 | PLAN SOUTH ELEVATION
1/8" = 1'-0"




6 | PLAN WEST ELEVATION
1/8" = 1'-0"

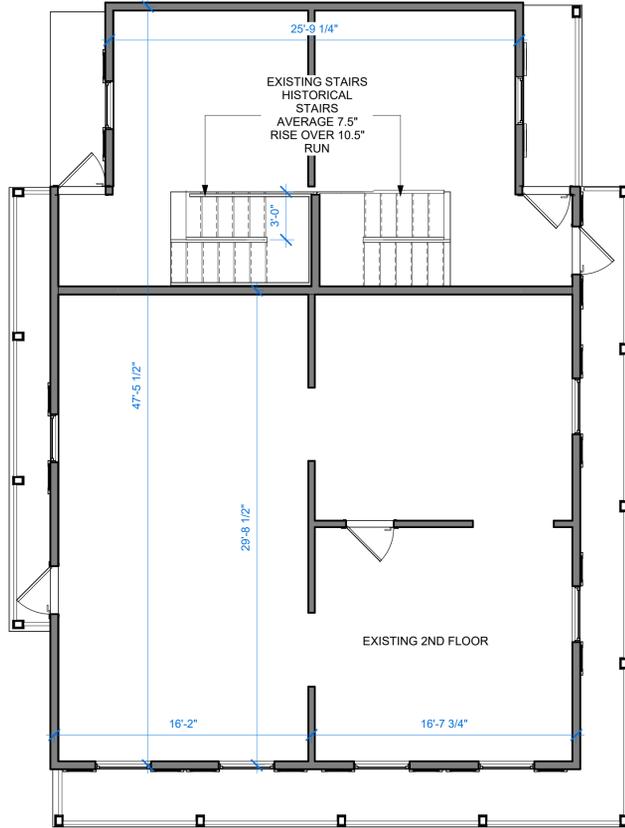

2ND FLOOR

2 | 2ND FLOOR - EXISTING
3/16" = 1'-0"

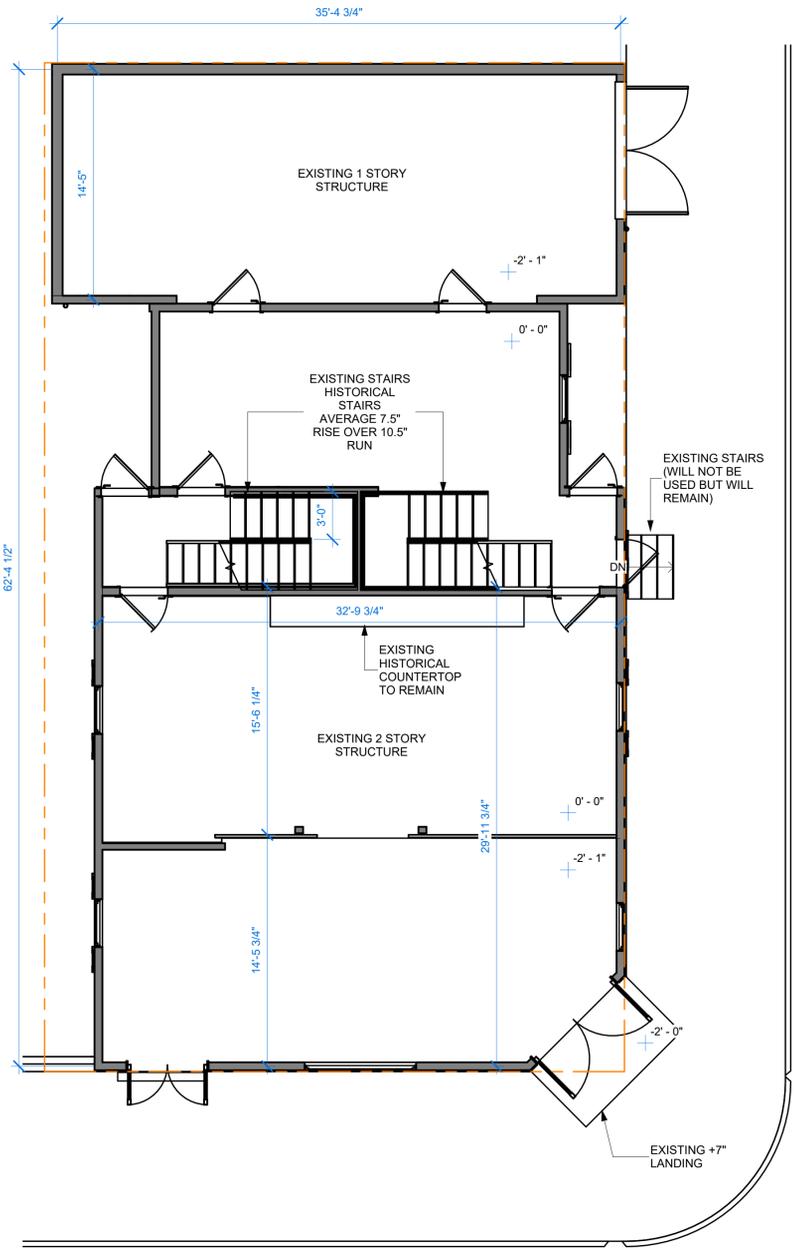

1ST FLOOR

1 | 1ST FLOOR - EXISTING
3/16" = 1'-0"

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A1.1
EXISTING PLANS & ELEVATIONS

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FINISH SCHEDULE						
NUMBER	NAME	FLOOR	WALL	BASE	CEILING	COMMENTS
2	MERCANTILE SPACE	NEW T&G SOLID WOOD FLOOR	PAINTED CMU / PAINTED GYPSUM		PAINTED GYPSUM	
6	UNI-SEX ADA RESTROOM	CERAMIC TILE	PAINTED GYSPUM W/ CERAMIC WAINSCOTT	COVE TILE	2X2 CEILING GRID	
7	STAIR 2	EXISTING REFINISHED WOOD	PAINTED GYSPUM		PAINTED GYPSUM	
9	UNI-SEX RESTROOM	CERAMIC TILE	PAINTED GYSPUM W/ CERAMIC WAINSCOTT	COVE TILE	PAINTED GYPSUM	
21	BR 4	CERAMIC TILE	PAINTED GYSPUM W/ CERAMIC WAINSCOTT	COVE TILE	PAINTED GYPSUM	
22	STAIR 2.2	EXISTING REFINISHED WOOD	PAINTED GYSPUM		PAINTED GYPSUM	
23	STAIR 1.2	EXISTING REFINISHED WOOD	PAINTED GYSPUM		PAINTED GYPSUM	
24	UNIT 1.2					
25	UNIT 2	NEW T&G SOLID WOOD FLOOR	PAINTED GYSPUM		PAINTED GYPSUM	
28	JANITOR	NEW T&G SOLID WOOD FLOOR	PAINTED GYSPUM		PAINTED GYPSUM	
31	UNCONDITIONED SPACE	SEALED CONCRETE FLOOR	PAINTED GYSPUM		EXPOSED	
32	MERCANTILE REAR	NEW T&G SOLID WOOD FLOOR	PAINTED GYSPUM		PAINTED GYPSUM	
35	STAIR 1	EXISTING REFINISHED WOOD	PAINTED GYSPUM		PAINTED GYPSUM	
37	BR 2.2	CERAMIC TILE	PAINTED GYSPUM W/ CERAMIC WAINSCOTT	COVE TILE	PAINTED GYPSUM	
38	CL 2.2	NEW T&G SOLID WOOD FLOOR	PAINTED GYSPUM		PAINTED GYPSUM	
39	CL 2.3	NEW T&G SOLID WOOD FLOOR	PAINTED GYSPUM		PAINTED GYPSUM	
40	BR 2.1	CERAMIC TILE	PAINTED GYSPUM W/ CERAMIC WAINSCOTT	COVE TILE	PAINTED GYPSUM	

INSULATION SCHEDULE - CLIMATE ZONE 2		
AREA	Type	VALUE
UNDERSIDE OF 1ST FLOOR	Fiberglass Batt w/Vapor Barrier	R13
EXTERIOR WALLS	Fiberglass Batt	R13
ATTIC	Rigid Board	R25

- FINISHES: PAINT COLOR AND SELECTION TO BE COORDINATED WITH OWNER.
- INTERIOR WALLS:
PRIMER - HI-BUILD PRIMER SEALER (KILZ II OR EQUAL)
TOPCOAT - 2 COATS SHERWIN WILLIAMS DURATION HOME SATIN WALL PAINT
 - CEILING:
PRIMER - HI-BUILD PRIMER SEALER (KILZ II OR EQUAL)
TOPCOAT - 2 COATS SHERWIN WILLIAMS 400 ZERO FLAT
 - CEILING ABOVE SHOWER ENCLOSURE:
PRIMER - HI-BUILD PRIMER SEALER (KILZ II OR EQUAL)
TOPCOAT - 2 COATS SHERWIN WILLIAMS DURATION HOME SATIN WALL PAINT
 - TRIM AND DOORS:
PRIMER: SHWER WILLIAMS PRO-CLASSIC ALKYD SEMI-GLOSS ENAMEL
TOPCOAT - 2 COATS SHERWIN WILLIAMS A-100 SATIN ACRYLIC HOUSE AND TRIM PAINT


GENERAL NOTES - PAINT

- ALL BEDROOM CLOSETS TO RECEIVE HANGING ROD AND UPPER WOODEN SHELF. SHOULD THE CLOSET ALLOW FOR A 2 SIDED INSTALL, PROVIDED ROD AND SHELF ON 2 SIDES
- ALL PANTRIES TO BE PROVIDED WITH 4 WOOD SHELVES ON ADJUSTABLE SHELF BRACKETS RUNNING THE VERTICAL DIMENSION OF THE REAR WALL
- PROVIDED WOOD BLOCKING OR METAL SHEETING FOR INSTALLATION OF FUTURE GRAB BARS AS SHOWN IN THE MOUNTING HEIGHT AND BLOCKING DIAGRAMS FOR BATHROOMS.

GENERAL NOTES - MISC WOOD

- CONSTRUCT ALL FRAMING TRUE AND SQUARE USING #2 SYP OR SPRUCE MATERIALS. PROVIDE PRESSURE TREATED FRAMING AT INTERIOR WET AREAS AND EXTERIOR DECK & PORCH LUMBER EXPOSED TO THE ELEMENTS.
- TREATED MATERIALS SHALL BE OF GRADE AS REQUIRED BY CONDITION AND KILN DRIED AFTER TREATMENT.
- SET ALL EXTERIOR BASE PLATES IN 2 LINES OF WATERPROOF CAULKING @ INSTALLATION. CAULK BUILDING EXTERIOR FOR A COMPLETELY WATERPROOFED INSTALLATION. CAULK ALL PENETRATIONS, MATERIAL TRANSITIONS AND SEAMS INCLUDING UNDERSIDE OF LAP SIDING WITH GE MAX 3500 (OR EQUAL).
- SEAL ALL ROUGH OPENINGS INTERIOR CAVITY VOIDS (DOORS, WINDOWS AND PENETRATIONS) WITH EXPANDABLE FOAM SEALANT PRIOR TO ENCLOSING WITH FINISH TRIM.


GENERAL NOTES - FRAMING

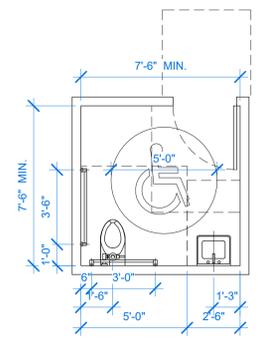

1 TYP. ADA RESTROOM DETAILS
1/4" = 1'-0"

TYPICAL MOUNTING HEIGHTS: MOUNT ITEMS AT HEIGHTS ABOVE FLOOR LEVEL AS SHOWN ON THIS SHEET. UNLESS OTHERWISE NOTED ON INTERIOR ELEVATIONS OR OTHER DRAWINGS. NOTIFY ARCHITECT OF POTENTIAL CONFLICTS PRIOR TO PURCHASE OR INSTALLATION.

MOUNTING HEIGHTS

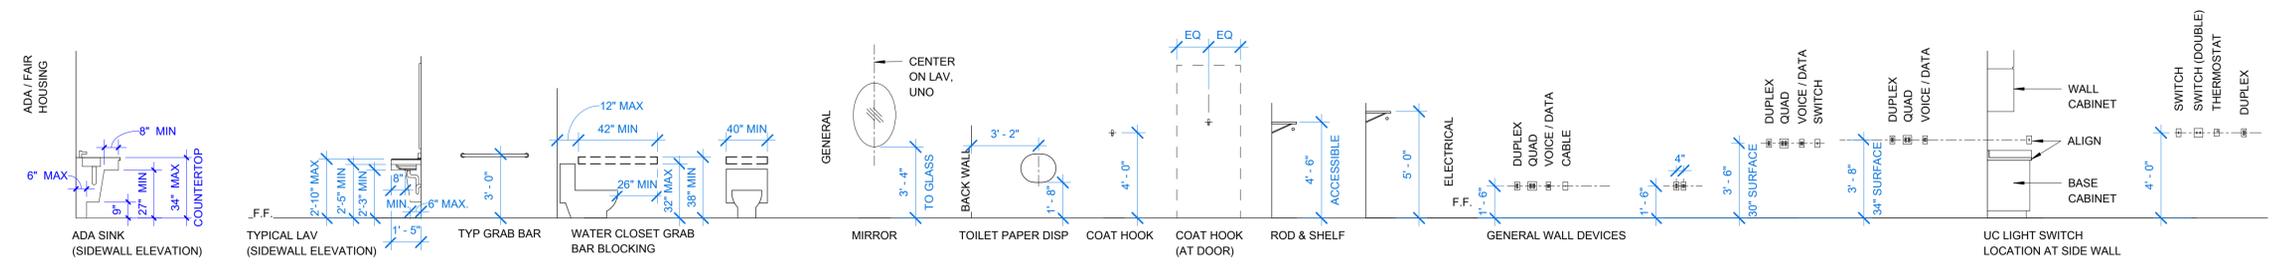

TYPE (SEE CHANGE LOG) DATE



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PERMIT SET
A1.2
NOTES


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NEW ORLEANS, LA 70117

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2ND FLOOR

2 | 2ND FLOOR PLAN
3/16" = 1'-0"



1ST FLOOR

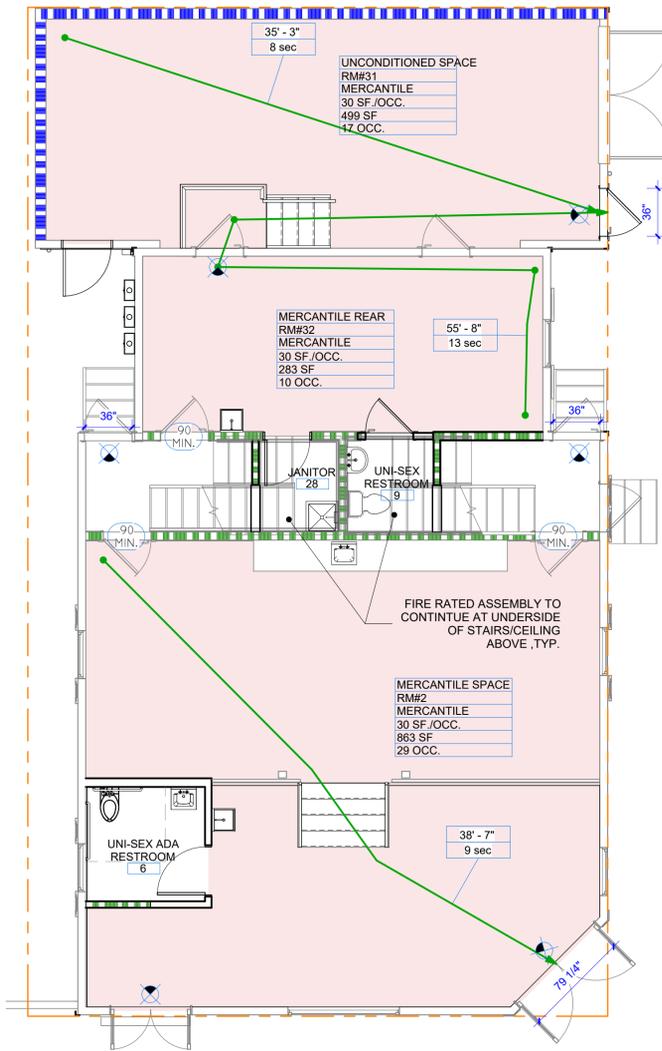1 | 1ST FLOOR PLAN - LIFE SAFETY
3/16" = 1'-0"



3 | LIFE SAFETY
1/8" = 1'-0"

NFPA LEGEND

	2 HOUR FIRE RATED PARTITION UL DESIGN # U419
	EXISTING 8" CMU MASONRY WALL 3 HOUR+ CALCULATED IBC
	EXIT TO EGRESS STAIR
	EMERGENCY DIRECTIONAL LIGHT. RE: ELECTRICAL DRAWINGS
	FIRE EXTINGUISHER. RE: SPECIFICATIONS
	TRAVEL DISTANCE
	DOOR & FRAME FIRE RATING RE: DOOR SCHEDULE

OCCUPANY ROOM TAG LEGEND

NAME OF ROOM OR SPACE	RM. NAME
ROOM NUMBER	RM. #
AREA CLASSIFICATION	OCCUPANCY
ALLOWED SF PER OCCUPANT	SF PER OCC
SF OF ROOM	RM SF.
TOTAL OCCUPANTS OF ROOM	# OF OCC.

LEGEND - LS

- U.L. APPROVED PORTABLE FIRE EXTINGUISHERS TO BE INSTALLED IN ACCORDANCE WITH SECTION 906.1 OF IBC AND NFPA 10 (LAC 17.4.4.5), (MIN. 2A-10B-C).
- INTERIOR WALL AND CEILING FINISHES TO HAVE A FLAME SPREAD INDEX IN ACCORDANCE WITH IBC SECTION 803.9 AND COMPLY WITH NFPA 101:18.3.3 (0-75) FLAMESPREAD WITH SMOKE DEVELOPMENT OF (0-450).
- INTERIOR FLOOR MATERIAL AND COVERINGS TO COMPLY WITH IBC SECTION 804.1, 804.4.1, AND 804.2.
- EMERGENCY LIGHTING SHALL BE PROVIDED AS PER NFPA 101 SECTION 7.9.
- DIRECTIONAL EXIT MARKINGS TO BE CONNECTED TO EMERGENCY POWER AND TO BE INSTALLED IN ACCORDANCE WITH NFPA SECTION 7.10.
- FIRE DETECTION & ALARM SYSTEM TO BE INSTALLED IN ACCORDANCE WITH NFPA SECTION 9.6.
- FIRE RESISTIVE-RATED BUILDING ASSEMBLIES SHALL BE OF A DESIGN THAT HAS BEEN TESTED AND LISTED BY AN APPROVED TESTING LABORATORY FOR THE INTENDED APPLICATION.
- AS PER NFPA 101:20.7.5 DRAPERIES, CURTAINS, AND OTHER SIMILAR LOOSELY HANGING FURNISHINGS AND DECORATIONS ARE FLAME RESISTANT AS DEMONSTRATED BY TESTING IN ACCORDANCE WITH NFPA 701.

GENERAL NOTES - LIFE SAFETY

21_089

DATE

TYPE (SEE CHANGE LOG)

#

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NEW ORLEANS, LA 70117






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3328 BANKS ST | NO. LA 70019 | (504) 345-8950
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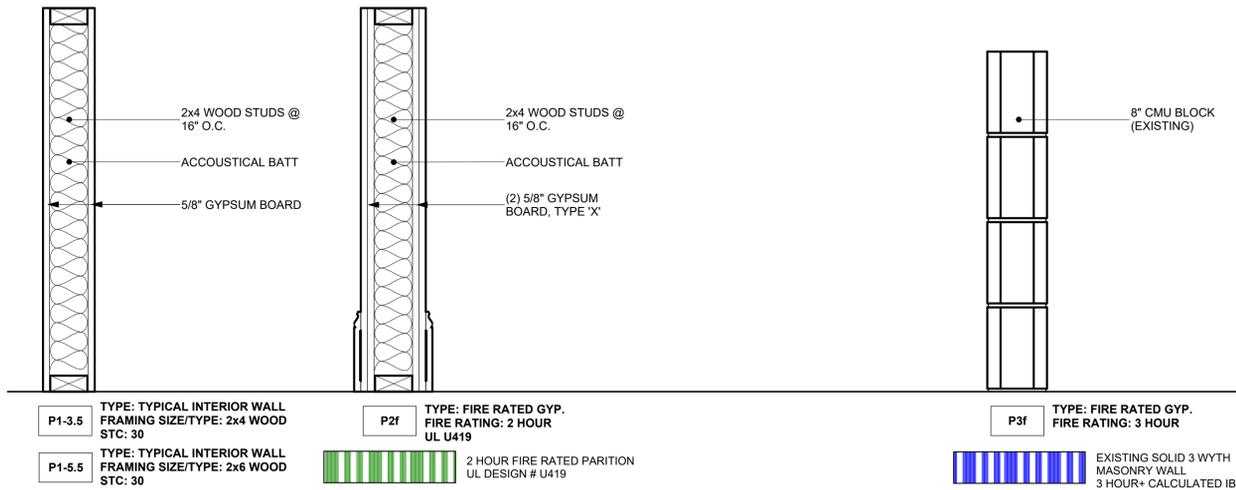
A2.0

LIFE SAFETY PLAN



ROOF

3 | ROOF.
3/16" = 1'-0"

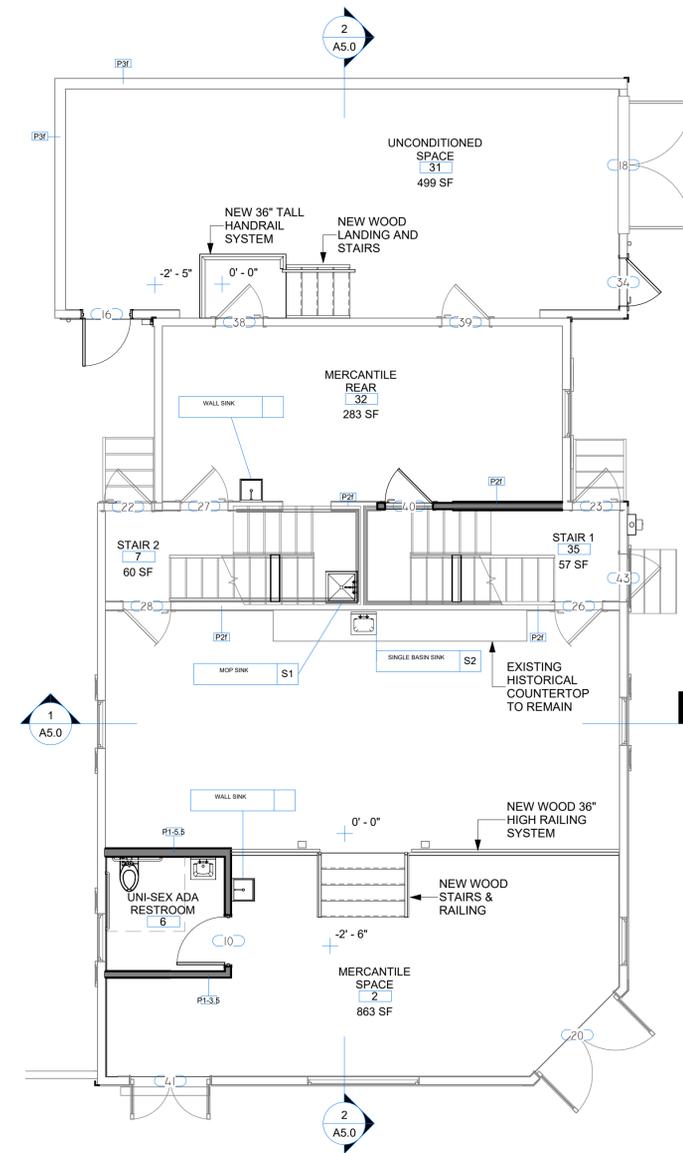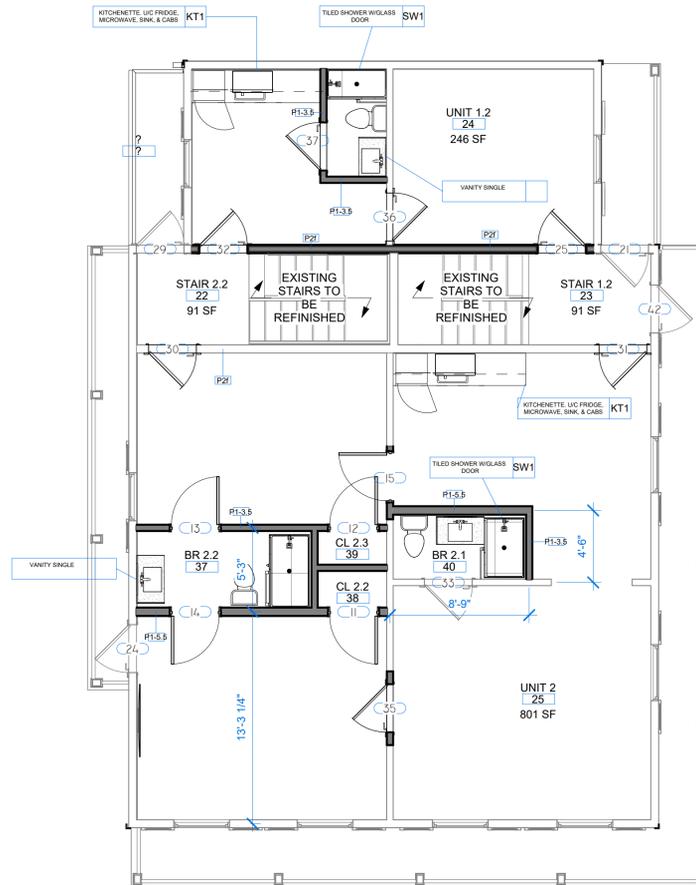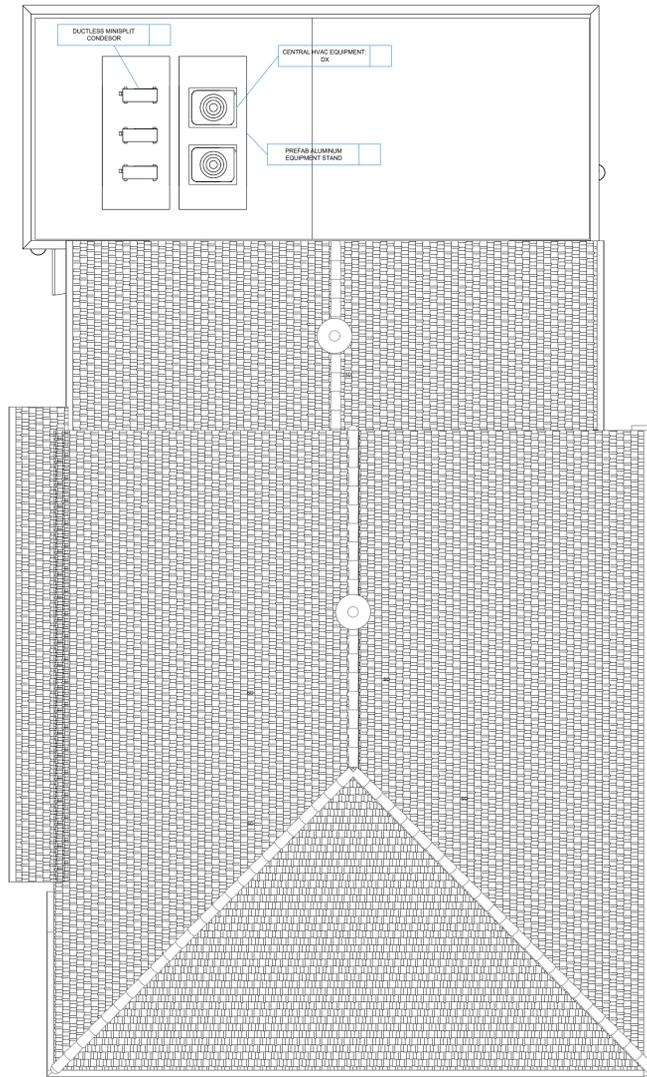


2ND FLOOR

2 | 2ND FLOOR PLAN
3/16" = 1'-0"

1ST FLOOR

1 | 1ST FLOOR PLAN
3/16" = 1'-0"

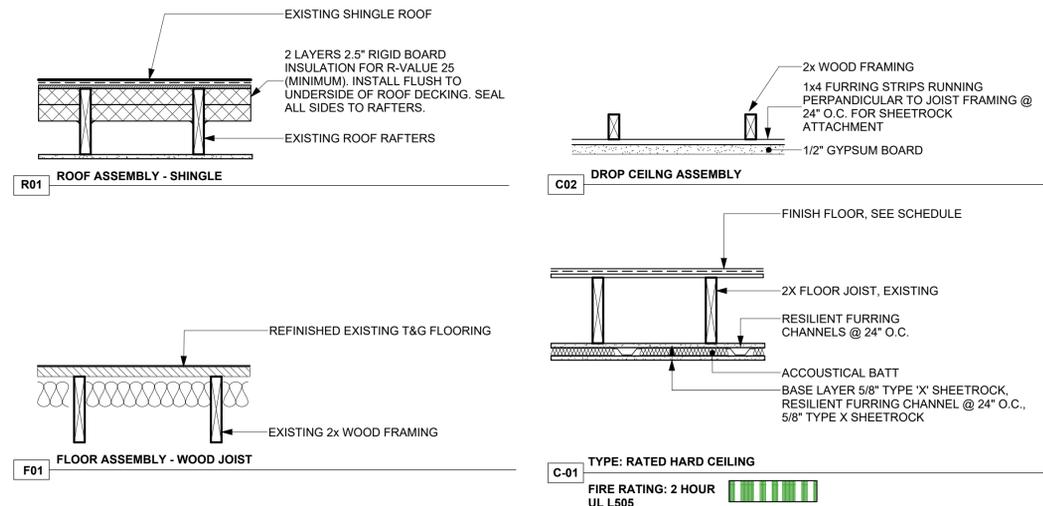

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A3.0
 FLOOR PLANS


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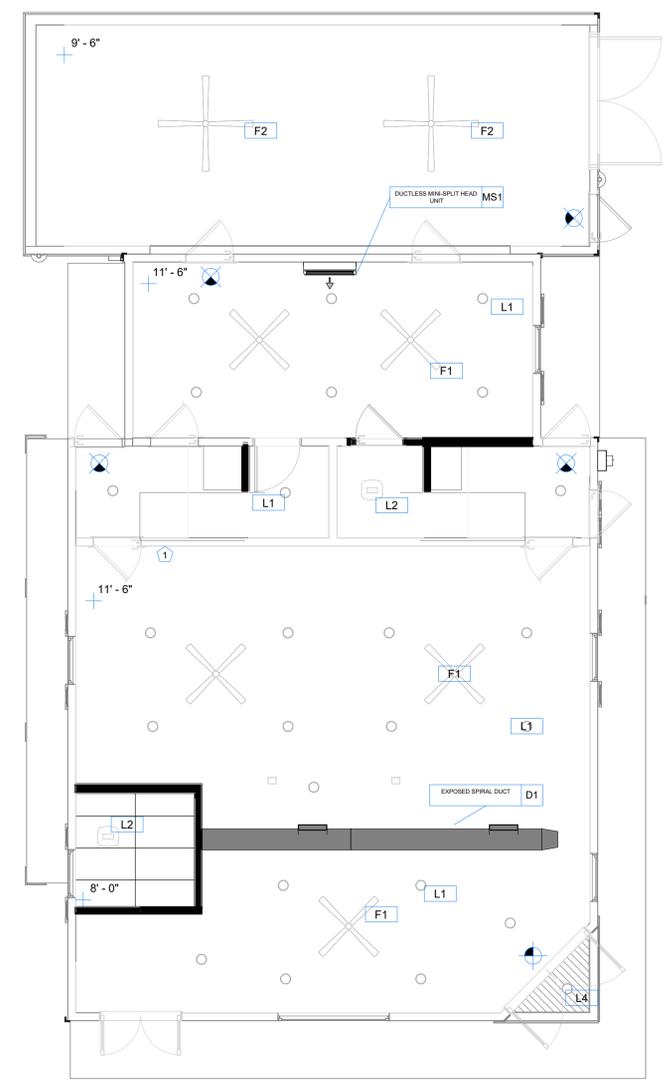
A4.0
 REFLECTED
 CEILING PLAN



2ND FLOOR

2 | 2ND FLOOR
 3/16" = 1'-0"

LIGHTING FIXTURE SCHEDULE		
Type Mark	Description	Comments
F1	Ceiling Fan, no light kit	
F2	Garage ceiling fans	
L1	Recessed LED can light	
L2	Exhaust Fan	
L3	24 1/4" Vanity	
L4	Exterior grade recessed LED can light	

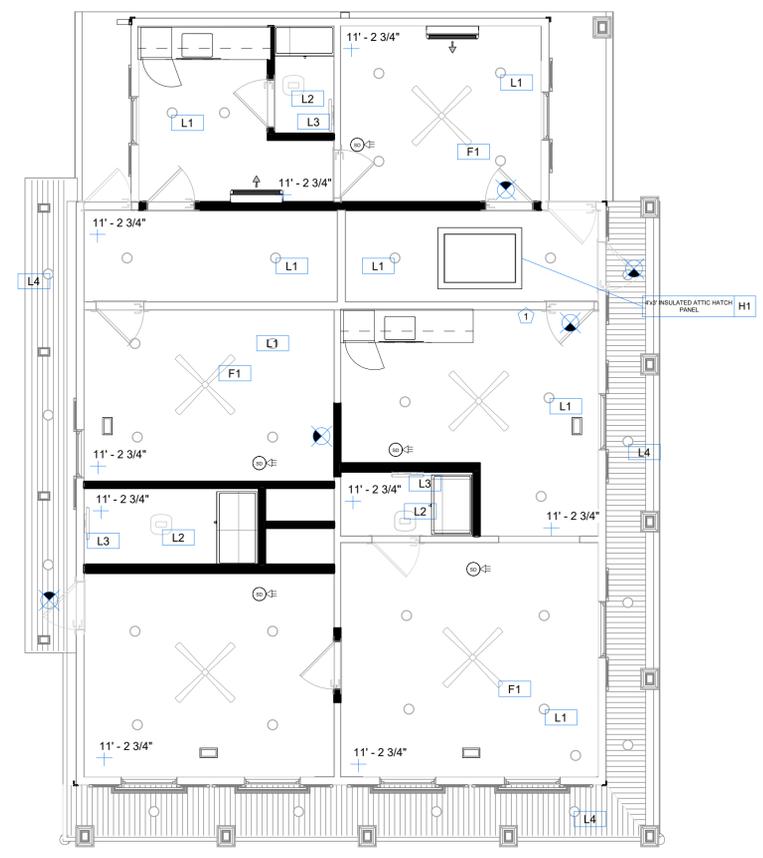

1ST FLOOR


1 | 1ST FLOOR
 3/16" = 1'-0"

1 THERMOSTAT LOCATION
 SPECIFIC NOTES - RCP

- (J2) J-BOX
- (J1) CHANDELIER RATED J-BOX
- (□) LIGHT VENT COMBO, RE: ELEC. PACKAGE
- (✱) LIGHT FAN COMBO, RE: ELEC. PACKAGE
- (□) CAN FIXTURE, RE: ELEC. PACKAGE
- (1) SPECIFIC NOTE
- (+ AFF) 1'-0" CEILING HEIGHT ELEVATION

LEGEND - RCP

8/9/2022 9:53:40 AM

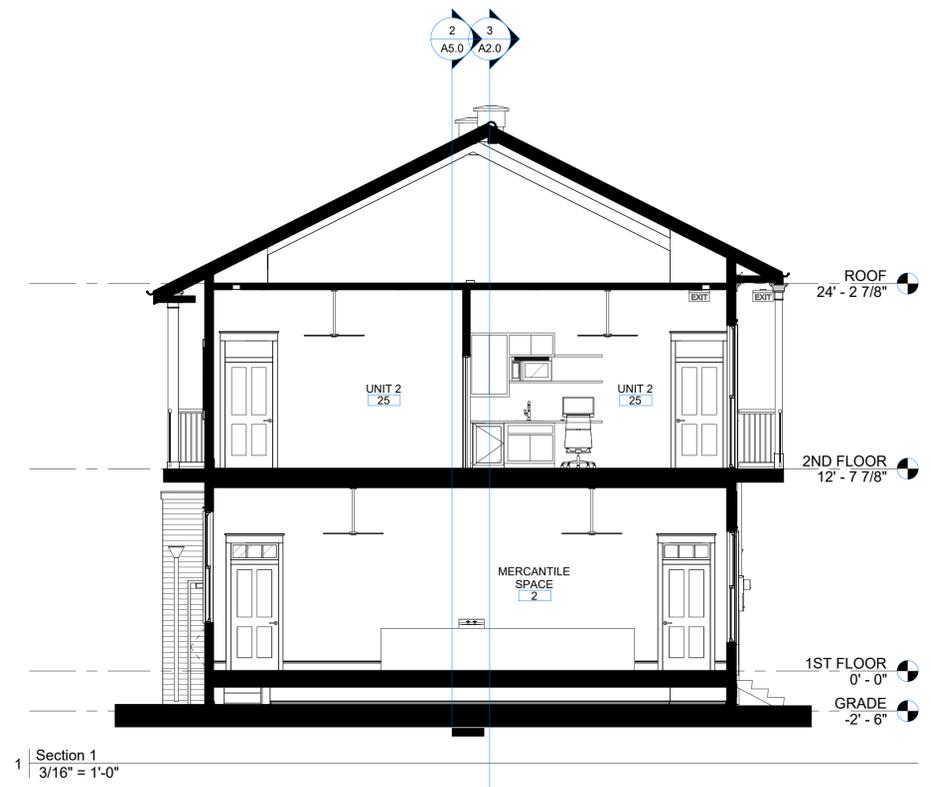

1 Section 1
3/16" = 1'-0"



2 Section 2
3/16" = 1'-0"


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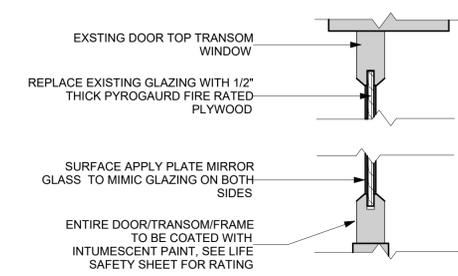
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A5.0
 BUILDING SECTIONS


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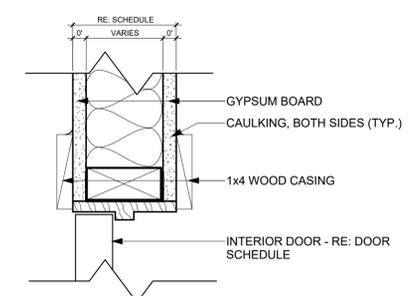
LEGEND - DOOR ELEVATIONS
1/4" = 1'-0"




DOOR DETAIL - FIRE RATED TRANSOM DETAIL

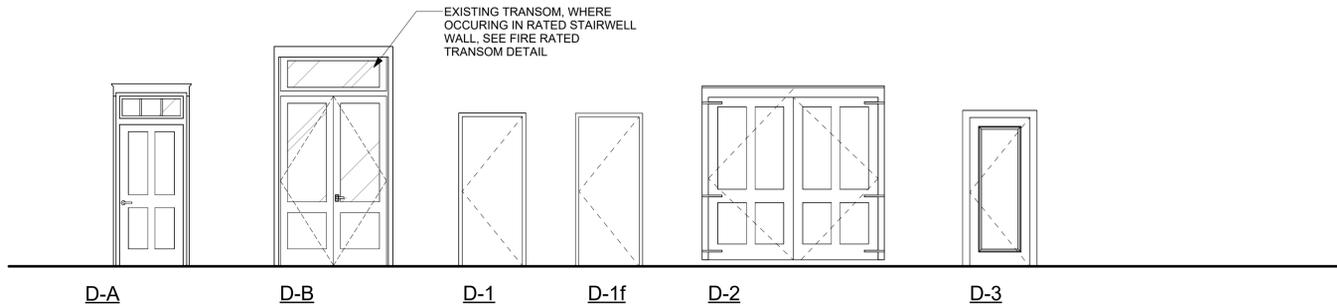

HEAD H2 - INTERIOR WOOD

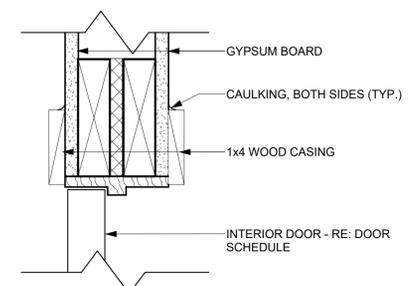

J2 - INTERIOR WOOD

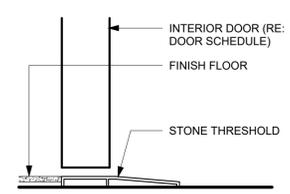

SILL S1 - INTERIOR TILE TRANSITION

DOOR DETAILS - WOOD FRAMED

DOOR SCHEDULE - LONG										
Mark	Type Mark	Description	Phase Created	SIZE		Transom	Frame Type	Door Material	HDWR TYPE	COMMENTS
				WIDTH	HEIGHT					
10	D-1	WOOD, FLUSH PANEL, SINGLE	New Construction	3' - 0"	7' - 0"	No	Metal	Wood	PRIVACY LOCK, LEVER HANDLE	ADA BATHROOM
11	D-1	WOOD, FLUSH PANEL, SINGLE	New Construction	3' - 0"	7' - 0"	No	Wood	Wood		CLOSET DOOR
12	D-1	WOOD, FLUSH PANEL, SINGLE	New Construction	3' - 0"	7' - 0"	No	Wood	Wood		CLOSET DOOR
13	D-1	WOOD, FLUSH PANEL, SINGLE	New Construction	3' - 0"	7' - 0"	No	Wood	Wood		BATHROOM DOOR
14	D-1	WOOD, FLUSH PANEL, SINGLE	New Construction	3' - 0"	7' - 0"	No	Wood	Wood		BATHROOM DOOR
15	D-1	WOOD, FLUSH PANEL, SINGLE	New Construction	3' - 0"	7' - 0"		Wood	Wood		ROOM DOOR
16	D-1f	Single Hollow Metal Door	New Construction	3' - 0"	8' - 0"		Metal	Hollow Metal		GARAGE REAR DOOR
18	D-2	WOOD, EXTERIOR GARAGE DOOR	Existing	8' - 0"	7' - 7 1/2"		Wood	Wood		CUSTOM WOOD GARAGE DOOR
19	D-3	WOOD, FLUSH PANEL, SINGLE	New Construction	2' - 10"	7' - 0"	No	Wood	Wood		MOP ROOM
20	D-4	WOOD, DOUBLE DOOR, SINGLE PANEL, HALF LIGHT, W TRANSOM	Existing	7' - 0"	8' - 0"	Yes	Wood	Wood		EXISTING EXTERIOR DOOR
21	D-A	WOOD, 4 PANEL WITH TRANSOM	Existing	3' - 0"	8' - 0"	Yes	Wood	Wood		BALCONY DOOR
22	D-A	WOOD, 4 PANEL WITH TRANSOM	Existing	3' - 0"	6' - 8"	Yes	Wood	Wood		REAR EXIT DOOR
23	D-A	WOOD, 4 PANEL WITH TRANSOM	Existing	3' - 0"	8' - 0"	Yes	Wood	Wood		SIDE EXIT FROM STAIR
24	D-A	WOOD, 4 PANEL WITH TRANSOM	Existing	3' - 0"	8' - 0"	Yes	Wood	Wood		BALCONY DOOR
25	D-A	WOOD, 4 PANEL WITH TRANSOM	New Construction	3' - 0"	8' - 0"	Yes	Wood	Wood		UNIT DOOR
26	D-A	WOOD, 4 PANEL WITH TRANSOM	Existing	3' - 0"	8' - 0"	Yes	Wood	Wood		EXISTING STAIRWELL DOOR, FIRE RATE TRANSOM PER DETAIL
27	D-A	WOOD, 4 PANEL WITH TRANSOM	Existing	3' - 0"	8' - 0"	Yes	Wood	Wood		EXISTING STAIRWELL DOOR, FIRE RATE TRANSOM PER DETAIL
28	D-A	WOOD, 4 PANEL WITH TRANSOM	Existing	3' - 0"	8' - 0"	Yes	Wood	Wood		EXISTING STAIRWELL DOOR, FIRE RATE TRANSOM PER DETAIL
29	D-A	WOOD, 4 PANEL WITH TRANSOM	Existing	3' - 0"	8' - 0"	Yes	Wood	Wood		BALCONY DOOR
30	D-A	WOOD, 4 PANEL WITH TRANSOM	New Construction	3' - 0"	8' - 0"	Yes	Wood	Wood		STAIR DOOR
31	D-A	WOOD, 4 PANEL WITH TRANSOM	New Construction	3' - 0"	8' - 0"	Yes	Wood	Wood		STAIR DOOR
32	D-A	WOOD, 4 PANEL WITH TRANSOM	New Construction	3' - 0"	8' - 0"	Yes	Wood	Wood		STAIR DOOR
33	D-A	WOOD, 4 PANEL WITH TRANSOM	Existing	3' - 0"	8' - 0"	Yes	Wood	Wood		BATHROOM DOOR
34	D-A	WOOD, 4 PANEL WITH TRANSOM	New Construction	3' - 0"	8' - 0"	Yes	Wood	Wood		GARAGE PERSONAL DOOR
35	D-A	WOOD, 4 PANEL WITH TRANSOM	New Construction	3' - 0"	6' - 8"		Wood	Wood		ROOM DOOR
36	D-A	WOOD, 4 PANEL WITH TRANSOM	New Construction	3' - 0"	6' - 8"	No	Wood	Wood		ROOM DOOR
37	D-A	WOOD, 4 PANEL WITH TRANSOM	New Construction	3' - 0"	6' - 8"		Wood	Wood		BATHROOM DOOR
38	D-A	WOOD, 4 PANEL WITH TRANSOM	Existing	3' - 0"	8' - 0"	Yes	Wood	Wood		REAR DOOR
39	D-A	WOOD, 4 PANEL WITH TRANSOM	Existing	3' - 0"	8' - 0"	Yes	Wood	Wood		REAR DOOR, SEAL SHUT
40	D-A	WOOD, 4 PANEL WITH TRANSOM	New Construction	3' - 0"	6' - 8"		Wood	Wood		BATHROOM DOOR
41	D-B	WOOD, DOUBLE DOOR, SINGLE PANEL, HALF LIGHT, W TRANSOM	Existing	5' - 0"	8' - 0"	Yes	Wood	Wood		EXISTING EXTERIOR DOOR
42	D-C	8 Panel Door with Transom	Existing	3' - 0"	8' - 0"	Yes	Wood	Wood		BALCONY DOOR
43	D-C	8 Panel Door with Transom	Existing	3' - 0"	6' - 8"		Wood	Wood		SIDE DOOR

936 ST ROCH AVE - INTERIOR RENOVATION
 936 ST ROCH AVE,
 NEW ORLEANS, LA 70117

TYPE (SEE CHANGE LOG) DATE



PERMIT SET
ISSUED 08/09/22

A6.0

DOORS

8/9/2022 9:53:41 AM