



TREME HOUSE 2

1900 DUMAINE ST.
NEW ORLEANS, LA 70116

- A0.0

TITLE SHEET
- A0.1

PROJECT INFO
- A0.2

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PLUMBING RISER


TREME HOUSE 2

1900 Dumaine St.
New Orleans, LA, 70116

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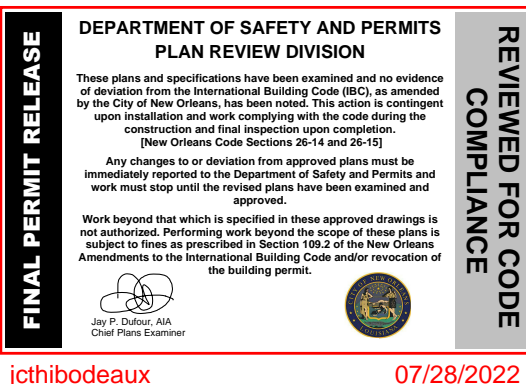
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Revision Schedule		
Revision Number	Revision Description	Revision Date
2	ISSUE FOR PERMIT	22.06.28

ISSUANCE:

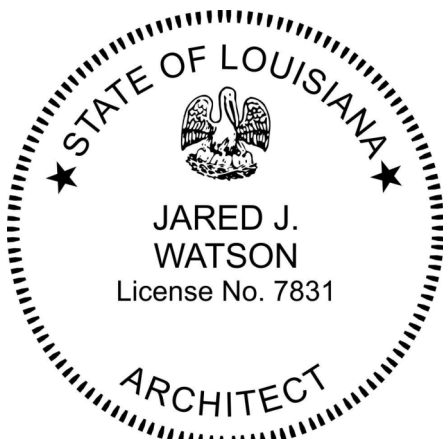

SHEET TITLE:

Title Sheet

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DATE: FOR PERMIT

SCALE:

NOTES

AC RETURN AIR CHASE SHALL BE 1-HR RATED CONSTRUCTION

NEW WINDOWS ARE PROVIDED AS A MEANS OF EGRESS OR RESCUE. THEY SHALL HAVE A SILL HEIGHT OF NOT MORE THAN 44" ABOVE THE FLOOR.

WALLS WITH WATER SERVICES TO BE 6" WALL, MINIMUM.

SITE TO HAVE POSITIVE DRAINAGE AWAY FROM STRUCTURES.

DETAILS IN THE DRAWINGS ARE DESIGNED TO MEET CURRENT BUILDING CODES. ANY PROPOSED CHANGES TO DETAILS TO BE SUBMITTED TO ARCHITECT AND OWNER FOR REVIEW. ANY CHANGES TO DETAILS ARE NOT TO COMPROMISE BUILDING INTEGRITY AND ARE NOT TO VIOLETE BUILDING CODES.

WATER HEATERS TO BE LOCATED IN THE ATTIC AND TO BE SIZED BY PLUMBING SUB-CONTRACTOR. NUMBER OF WATER HEATERS TO BE DETERMINED BY PLUMBING SUB-CONTRACTOR. OVERFLOR PAN SHALL BE PROVIDED FOR EVERY WATER HEATER.

ALTERNATE PRICE FOR TANKLESS ON-DEMAND WATER HEATER.

PLUMBING SHALL BE DESIGNED AS PER UNIFORM PLUMBING CODE STANDARDS. PLUMBER SHALL DETERMINE PIPE SIZE, AND ALL OTHER RELATED ITEMS AS NEEDED.

EGRESS OR RESCUE WINDOWS FROM BEDROOMS TO HAVE NET CLEAR OPENING OF 5.7 SF MIN. THE MIN. NET CLEAR OPENING HEIGHT SHALL BE 22". THE MIN. NET CLEAR OPENING WIDTH SHALL BE 20".

PLUMBER TO PROVIDE ACCESS ALL SHUTOFFS, INSTALL ACCESS PANEL IF REQUIRED.

HVAC SHALL BID A MINIMUM 16 SEER UNIT. SUBMITTALS OF PRODUCTS SHALL BE SUBMITTED BEFORE PURCHASE AND INSTALLATION.

ALL EXTERIOR WALLS SHALL BE 2X6 UNLESS OTHERWISE INDICATED. ALL OCCUPIED SPACES SHALL RECEIVE AN INSULATION BARRIER THAT IS CONTINUOUS AT ALL EXTERIOR WALLS, CEILINGS AND FLOOR SURFACES.

THESE DRAWINGS REPRESENT THE DESIGNERS INTENT ONLY. COMPLIANCE WITH ALL STATE AND LOCAL CODES IS THE CONTRACTORS RESPONSIBILITY. DIMENSIONS ARE APPROXIMATE, AND FIELD VERIFICATION IS REQUIRED.

SEE STRUCTURAL DRAWING FOR STEEL INFORMATION AND FOR PILE AND FOUNDATION INFORMATION.

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NOTES

THE DRAWINGS AND SPECS, INCLUDING CONSULTANT DRAWINGS, ARE COMPLIMENTARY. ITEMS SHOWN IN ANY ONE LOCATION SHALL BE REQUIREMENTS OF THE CONTRACT FOR CONSTRUCTION. THE ARCHITECT SHALL BE NOTIFIED OF ANY DISCREPANCIES OR OMISSIONS WHICH WOULD INTERFERE WITH THE SATISFACTORY COMPLETION OF THE WORK.

ALL MANUFACTURED ARTICLES, MATERIALS AND EQUIPMENT SHALL BE SUPPLIED, INSTALLED, CONNECTED, ERECTED, USED, CLEANED AND CONDITIONED AS DIRECTED BY THE MANUFACTURERS, UNLESS NOTED OTHERWISE.

ALL STANDARDS FOR CONSTRUCTION, MATERIALS AND EXECUTION OF THE WORK SHALL CONFORM TO ALL CODES AND STANDARDS AND TO REGULATIONS OF THE AUTHORITIES HAVING JURISDICTION.

WHEN ALL OR PART OF THE STRUCTURE IS OPEN TO THE EXTERIOR, PROTECT INTERIOR FROM WIND, STORM, RAIN AND VANDALISM.

PROVIDE BLOCKING FOR ALL SURFACE MOUNTED, SEMI-RECESSED OR RECESSED ITEMS SUCH AS ACCESSORIES, GRAB BARS, CLOSET RODS, SHELVES, MIRRORS, WALL-MOUNTED VANITIES, COUNTERTOPS, ETC. PROVIDE WALKTHROUGH WITH OWNER BEFORE CLOSING WALLS TO CONFIRM BLOCKING LOCATIONS.

DO NOT SCALE DRAWINGS. IF ANY DIMENSIONS ARE CONFLICTING OR IN QUESTION THEN THE CONTRACTOR IS TO CONSULT THE ARCHITECT FOR CLARITY.

CONTRACTOR SHALL KEEP PROJECT FREE FROM ACCUMULATION OF DEMOLITIONS DEBRIS, WASTE MATERIALS CAUSED BY OPERATION AND SHALL REMOVE NO LESS THAN ONCE PER WEEK ALL DEBRIS FROM THE PROJECT.

ALL EXTERIOR EXPOSED WOOD SHALL BE INSTALLED TO ASSURE WEATHER TIGHT CONDITIONS. CONTRACTOR SHALL PROVIDE ALL CAULKING AND WEATHER BARRIER MATERIALS REQUIRED FOR WEATHER TIGHT CONDITIONS.

THE GENERAL CONTRACTOR SHALL SUBMIT IN WRITING ANY PROPOSAL FOR ADDITIONAL WORK OR ADDITIONAL SERVICES. SUBMIT TO THE OWNER FOR REVIEW AND APPROVAL. NO WORK IS TO PROCEED UNTIL A SIGNED PROPOSAL IS RETURNED TO THE GENERAL CONTRACTOR.

THE GENERAL CONTRACTOR SHALL SUBMIT ALL SHOP DRAWINGS TO THE OWNER FOR WRITTEN APPROVAL PRIOR TO WORK BEING PERFORMED.

THE GENERAL CONTRACTOR IS RESPONSIBLE FOR THE FINAL CLEAN. FINAL CLEAN STO DELIVER PROJECT IN 'MOVE-IN' CONDITION.

GC AND SUBS ARE TO FAMILIARIZE THEMSELVES WITH THE CONSTRUCTION SITE AND VERIFY EXISTING CONDITIONS, SITE GRADES AND LOCATIONS OF ALL UTILITIES PRIOR TO COMMENCING CONSTRUCTION. ANY DEVIATION OR CHANGES NECESSARY TO ACHIEVE THE INSTALLATIONS SHOWN SHALL BE CALLED TO THE ATTENTION OF THE ARCHITECT.

PROVIDE TERMITE PROTECTION AS REQUIRED PER 2015 IRC.

CODE COMPLIANCE

BUILDING CODE	2015 INTERNATIONAL RESIDENTIAL CODE
WIND DESIGN	ICC STANDARD CONSTRUCTION IN HIGH WIND REGIONS
ACCESSIBILITY	ADAAG
LIFE SAFETY	2015 NFPA 101
MECHANICAL	2015 INTERNATIONAL MECHANICAL CODE
ENERGY	ASHRAE 90.1-2007
ELECTRIC	2015 NATIONAL ELECTRIC CODE
PLUMBING	2000 LOUISIANA PLUMBING CODE
DESIGN LOADS	40 PSF FLOORS 20 PSF ROOF

PROJECT DIRECTORY

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BUILDING INFORMATION

ADDRESS	1900 DUMAINE ST. NEW ORLEANS, LA 70116
INFO	NEW CONSTRUCTION OF A SINGLE-FAMILY RESIDENCE.
SQ FOOTAGE	FLOOR 1 730 SF FLOOR 2 910 SF TOTAL LIVING SF 1,640 SF FRONT PORCH 30 SF REAR PORCH 30 SF
NUMBER OF FLOORS	2
BUILDING HEIGHT	TOP OF RIDGE AT 31'-5" ABOVE GRADE
ZONING	HU-RD2
HISTORIC DISTRICT	HDLC TREME - PARTIAL CONTROL
PARKING REQUIRED PARKING PROVIDED	ZERO 1
OCCUPANCY	R-3
CONSTRUCTION TYPE	TYPE V

NO CONSTRUCTION ADMINISTRATION


ARCHITECT WILL NOT BE PERFORMING CONSTRUCTION ADMINISTRATION SERVICES DURING CONSTRUCTION.

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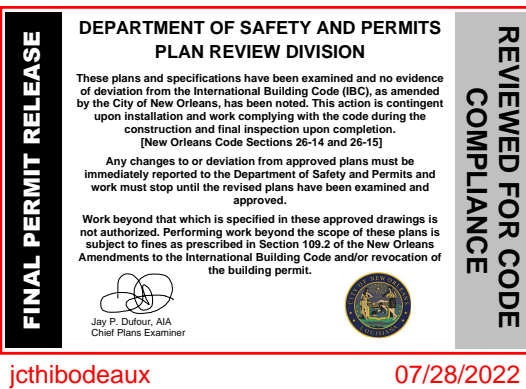
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2	ISSUE FOR PERMIT	22.06.28

ISSUANCE:



SHEET TITLE:

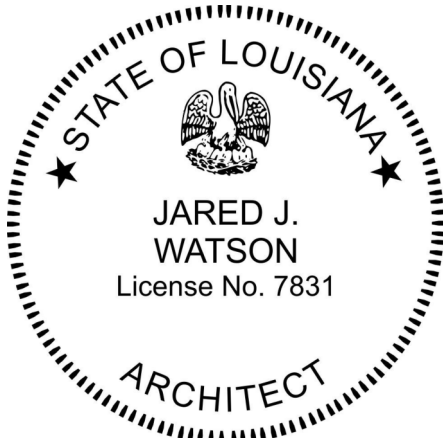Project Info

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A0.1

DATE: FOR PERMIT

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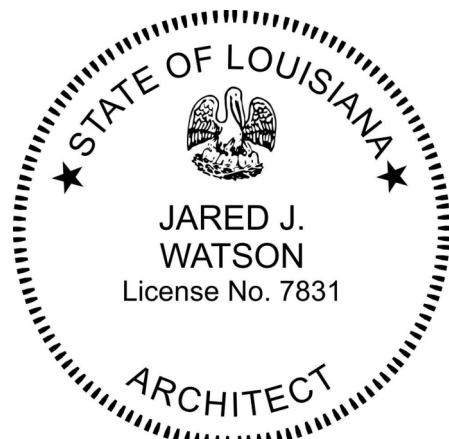


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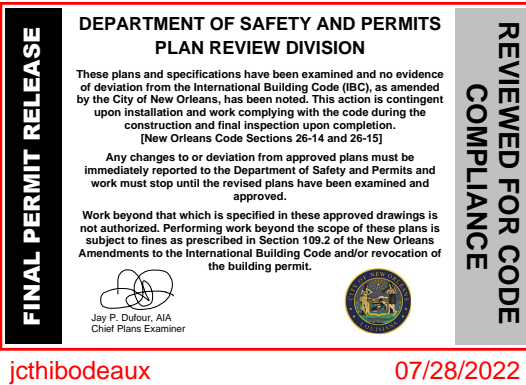
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Renderings

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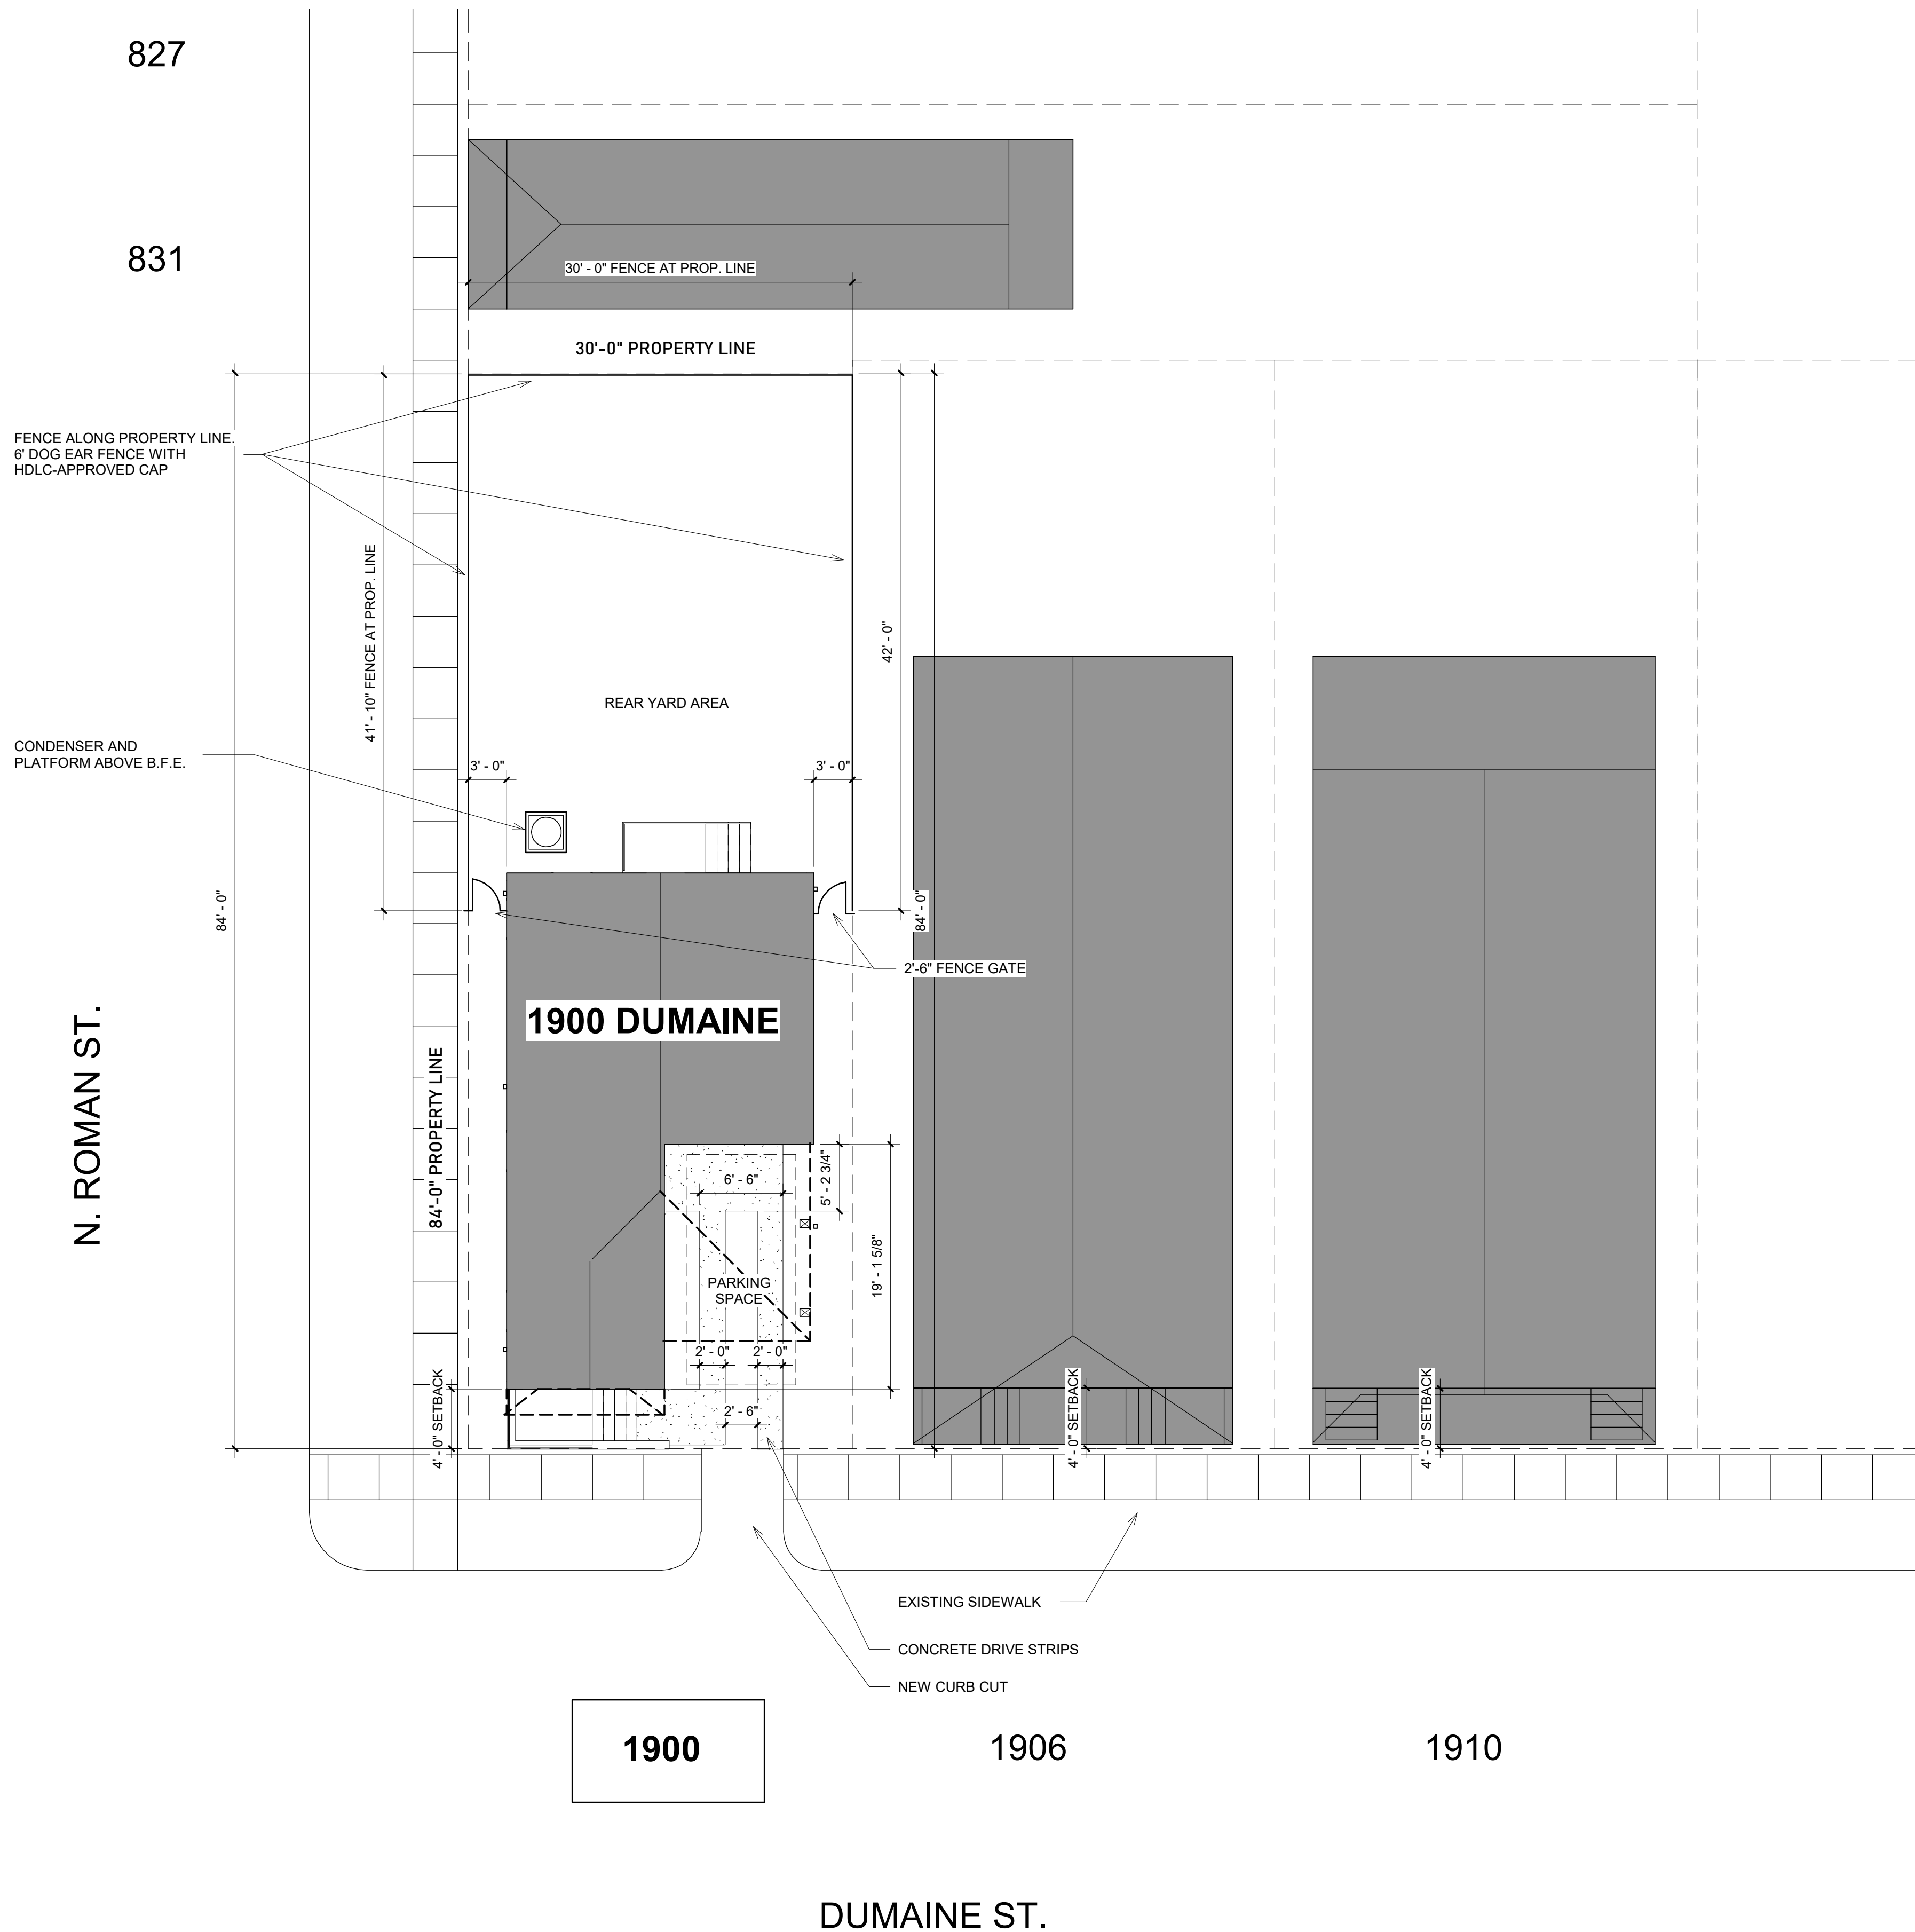
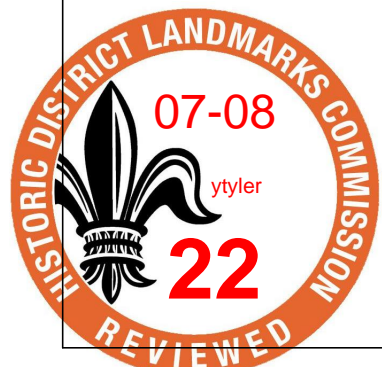


2 3D View 4 Copy 1



1 3D View 4





ZONING INFORMATION

ADDRESS	1900 DUMAINE ST. NEW ORLEANS, LA 70116	
ZONING	HU-RD2	
LOT DIMENSIONS	30'-0" X 84'-0"	
LOT AREA	2,520 SF	
LOT COVERAGE	744 SF	
OPEN SPACE	1,776 SF (70%)	
SETBACKS	4'-0" FRONT SIDE 3'-0" LEFT SIDE 3'-0" RIGHT SIDE 15'-0" BACK SIDE	
HEIGHT	31'-5" 35'-0" MAX ALLOWABLE	
DRIVEWAY	1 CURB CUT	


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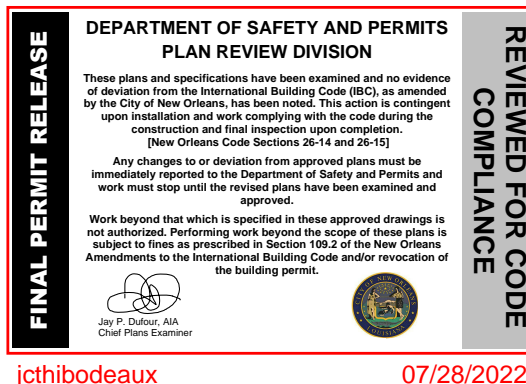
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ISSUANCE:



SHEET TITLE:
**Site Plan and
Context**

SHEET NUMBER:

A1.1

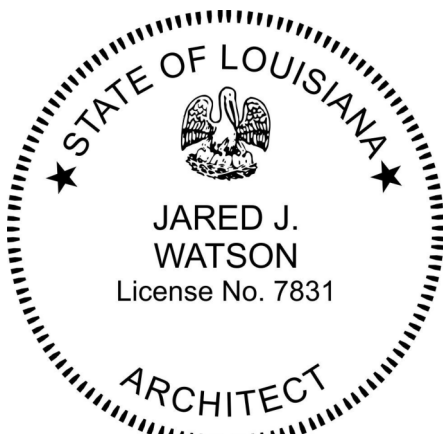DATE: FOR PERMIT


SCALE: 1/8" = 1'-0"

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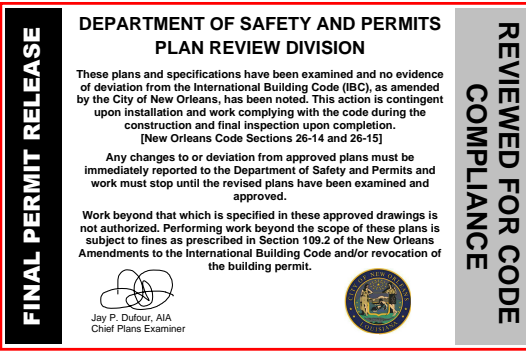
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ISSUANCE:



SHEET TITLE:
Survey and
Benchmark

SHEET NUMBER:

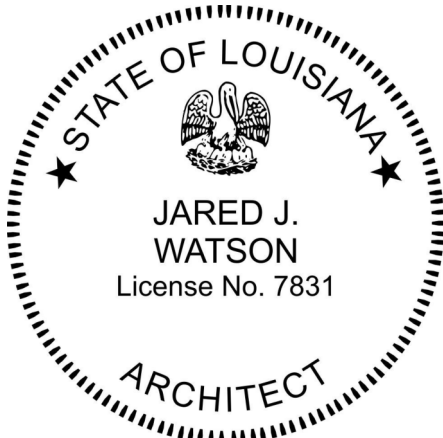A1.2

DATE: FOR PERMIT

SCALE:

CONSTRUCTION BENCHMARK SURVEY

PROPERTY SURVEY




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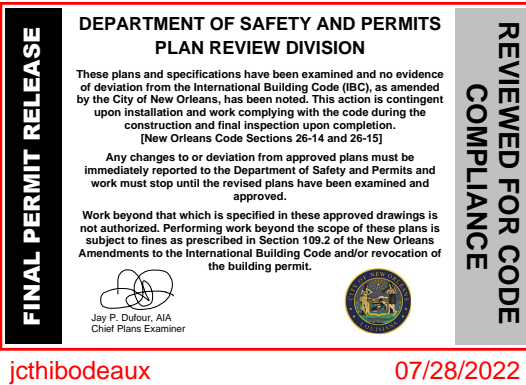
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ISSUANCE:



SHEET TITLE:

Floor Plans

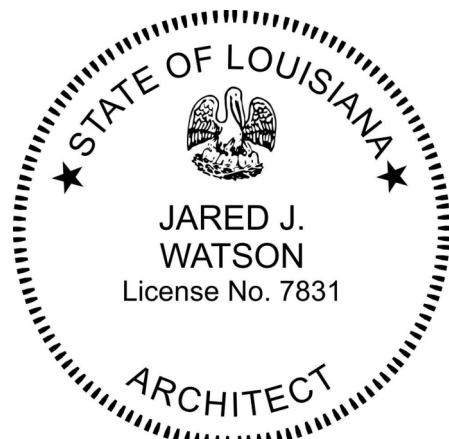SHEET NUMBER:

A1.3

DATE: FOR PERMIT

SCALE: 1/4" = 1'-0"

PLAN NOTES

PAINTED 1X6 WALL BASE THROUGHOUT, U.N.O.

ALL RAILINGS TO MEET CODE-REQUIRED MINIMUM OF 200 POUNDS OF LIVE LOAD PER IRC 2015, TABLE R301.5


GREEN BOARD TO BE USED FOR ALL WALLS IN DAMP AREAS. CEMENT TILE BACKER BOARD TO BE USED IN TUB AND SHOWER SURROUNDS. CEMENT BOARD TO BE USED AT TILE FLOORS.

CEILINGS TO BE 1/2" GYP. BATHROOM CEILINGS TO BE 1/2" GREEN BOARD.


NO FURRED CEILINGS UNLESS NOTED OTHERWISE.

WOOD FLOOR AT ALL LOCATIONS EXCEPT BATHROOMS AND SHOWERS

DIMS TO FACE OF FRAMING, U.N.O..
PLUMBING WALLS TO BE 2X6 CONSTRUCTION
INTERIOR NON-STRUCTURAL WALLS TO BE 2X4 CONSTRUCTION
EXTERIOR WALLS TO BE 2X6 CONSTRUCTION

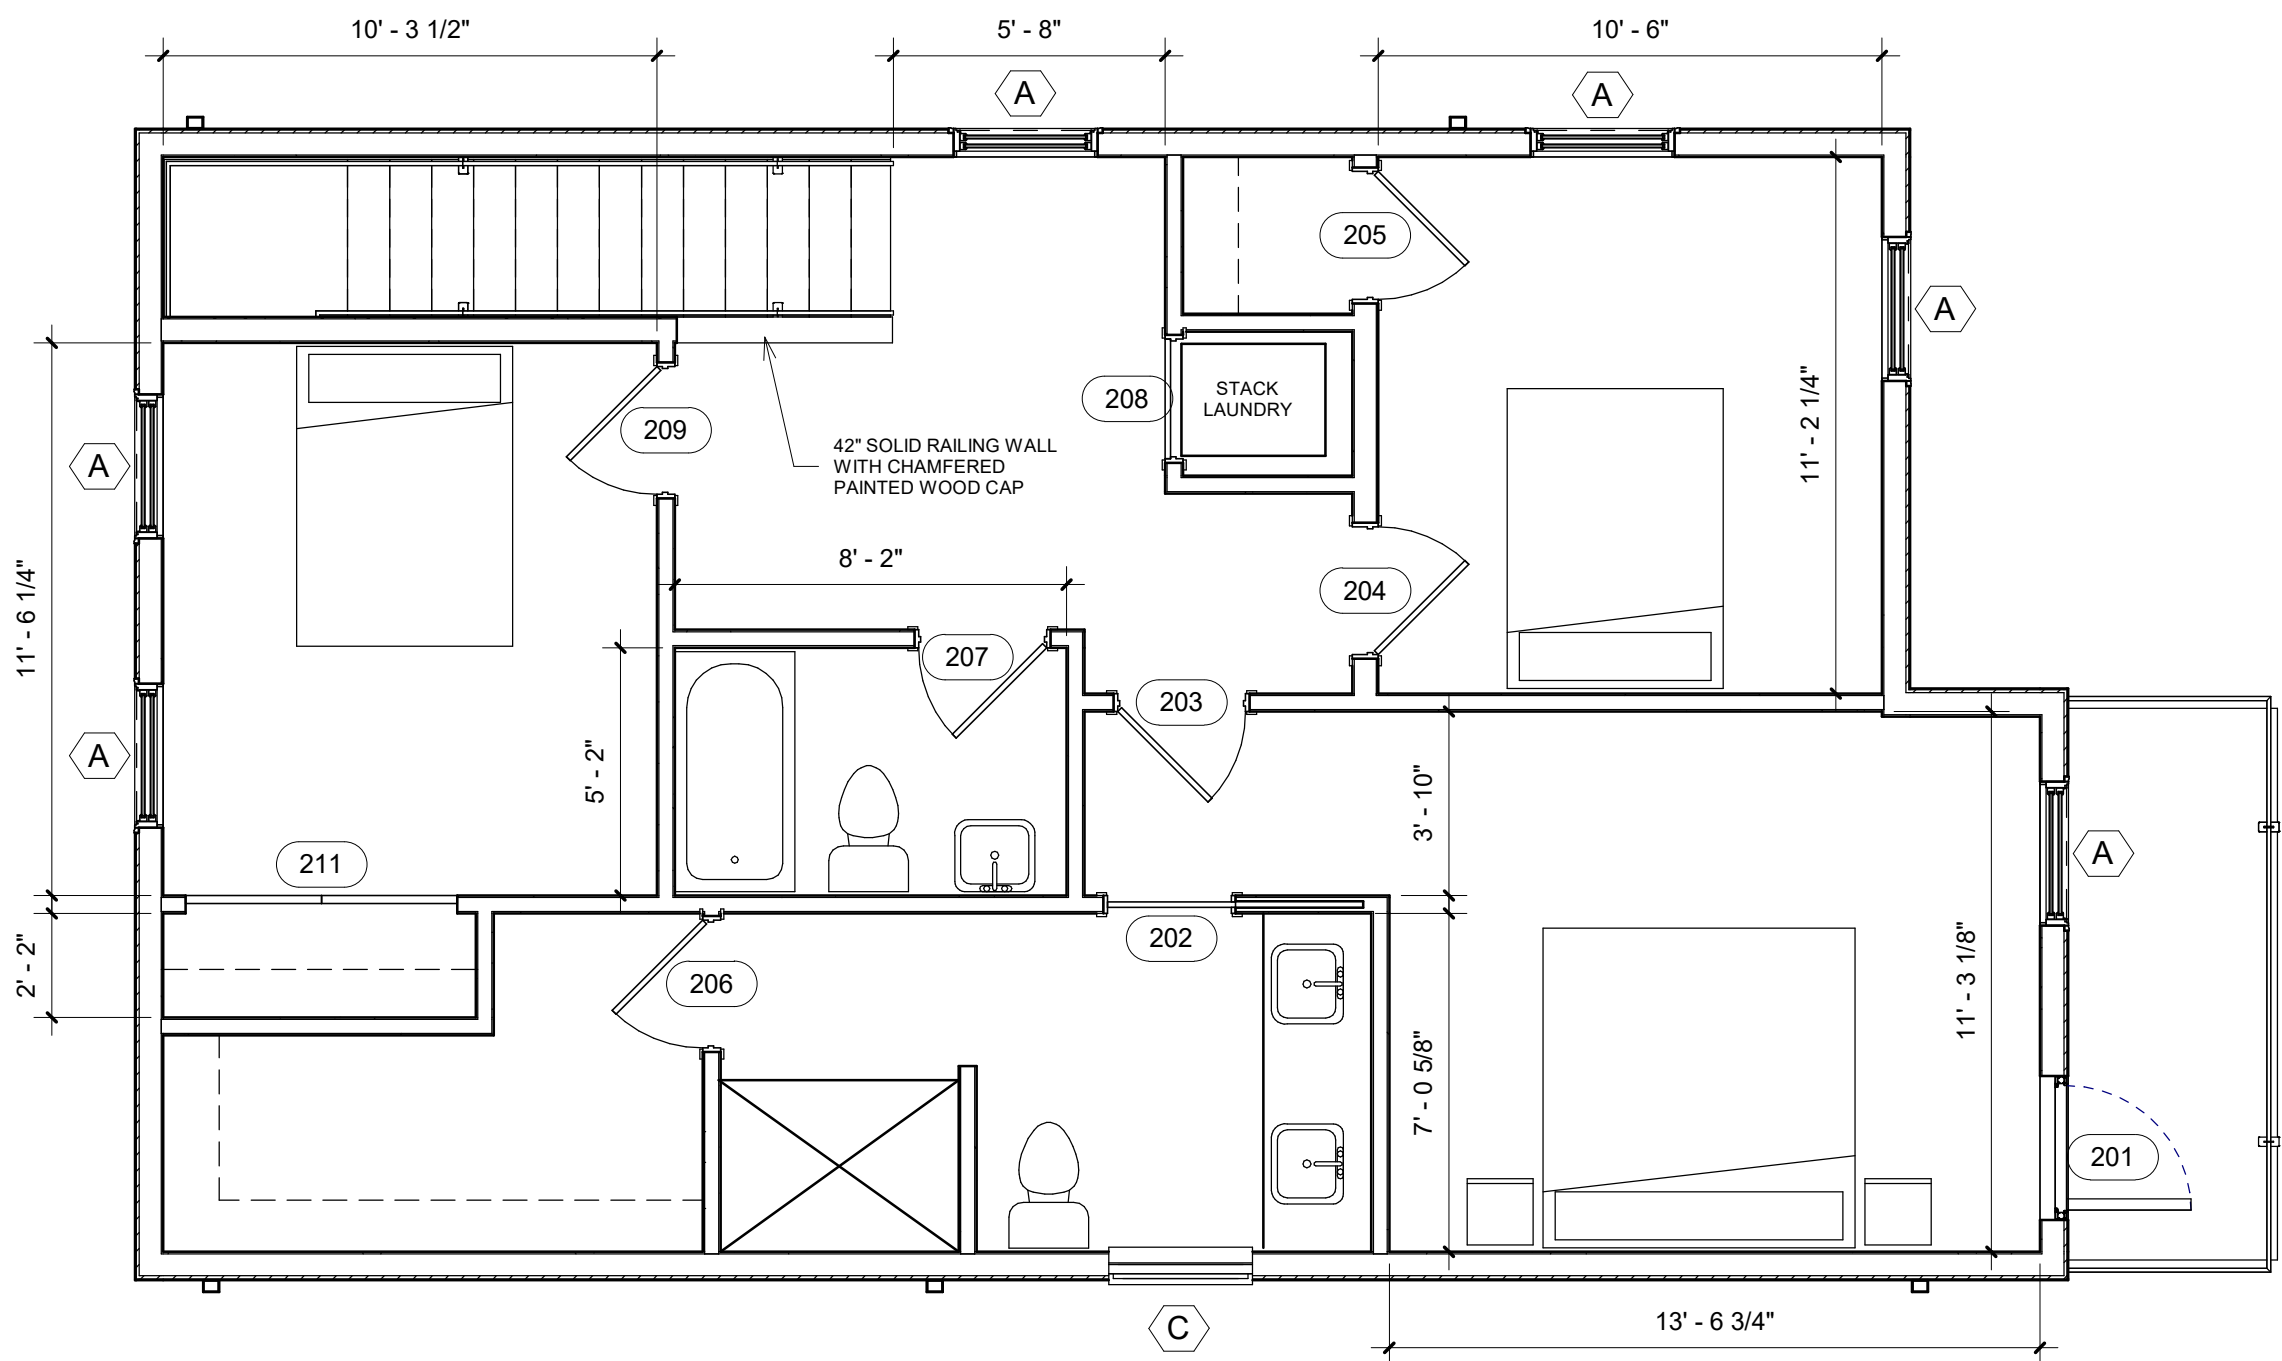

2 Level 2
1/4" = 1'-0"

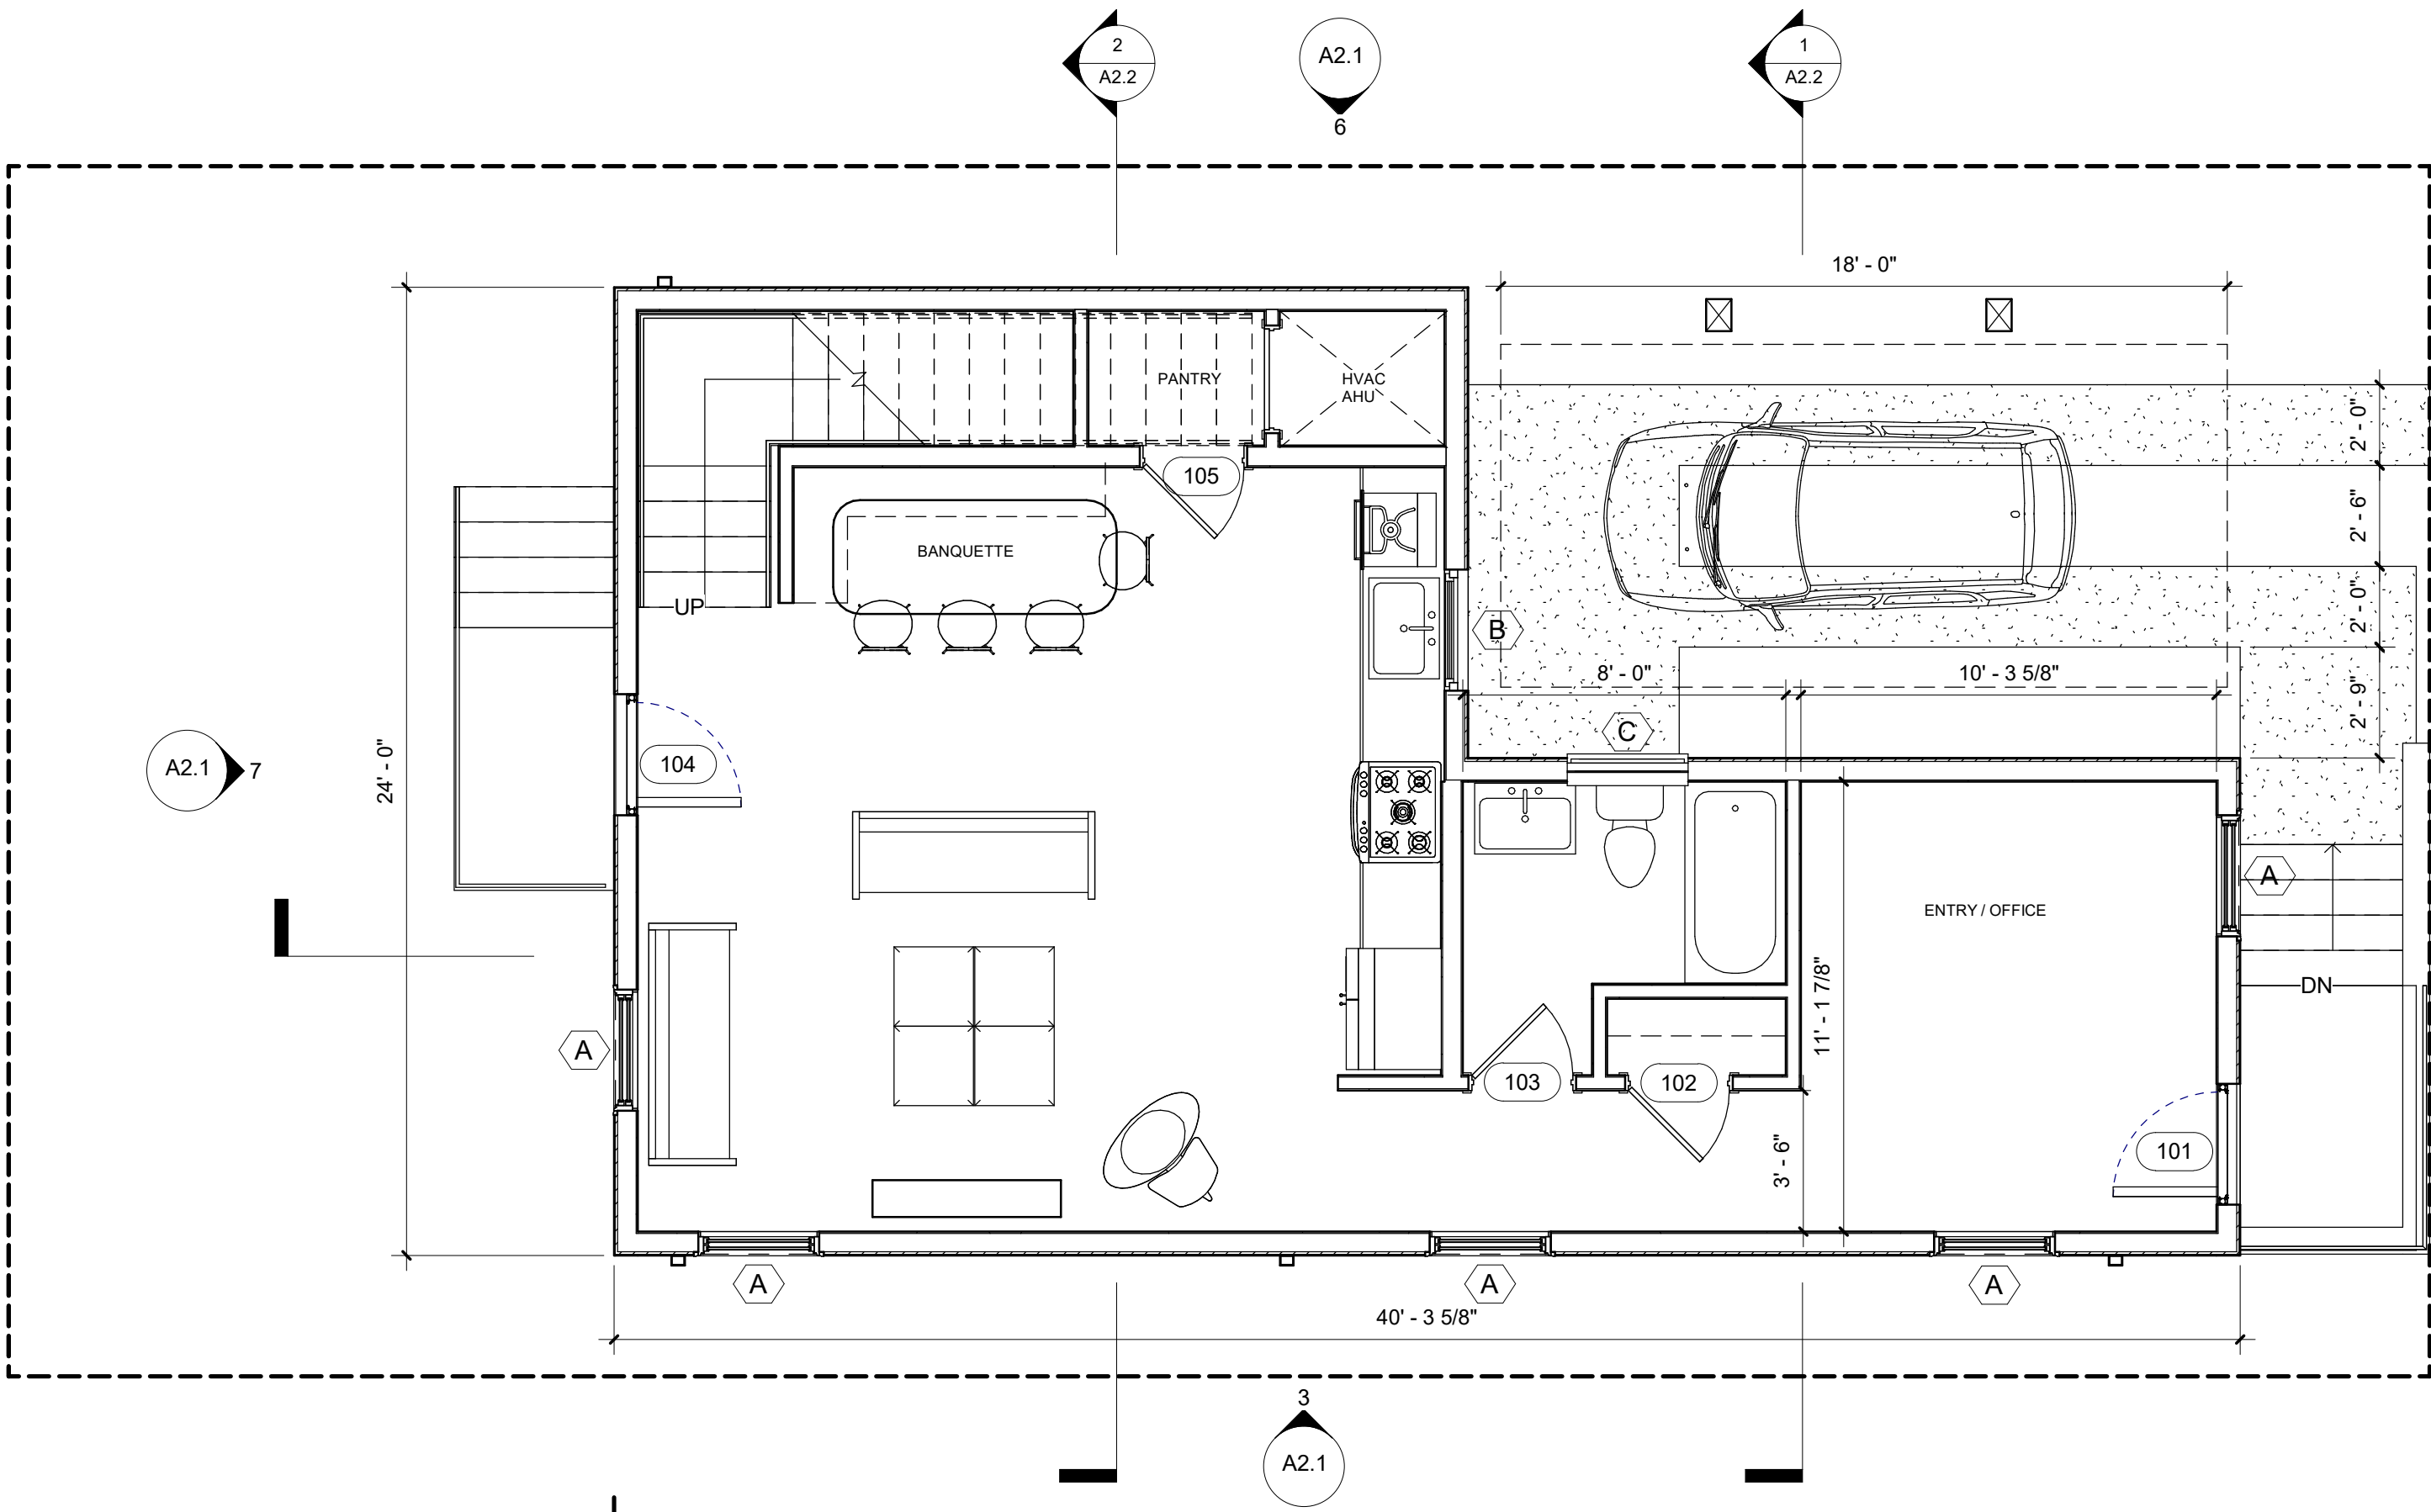

1 Level 1
1/4" = 1'-0"



ROOFING AND ATTIC NOTES

GUTTER AND DOWNSPOUT DESIGN TO BE CALCULATED BY GUTTER SUBCONTRACTOR TO MEET SMACNA REQUIREMENTS AND 100 YEAR RAIN REQUIREMENTS. GUTTER AND DOWNSPOUT SIZES ON SHEET ARE FOR REFERENCE AND TO BE VERIFIED.

PROVIDE 300 SF OF 3/4" PLYWOOD DECKING IN ATTIC, GLUED AND SCREWED. OWNER TO LOCATE. CONSULT WITH OWNER AND HVAC SUB-CONTRACTOR PRIOR TO START OF WORK. PLYWOOD ACCESS PATH TO BE INSTALLED AS REQUIRED TO ACCESS ATTIC AND SERVICE EQUIPMENT.


ROOF AND ATTIC VENTILATION TO CONFORM TO IRC 2015 SECTION R806.

LOW-PROFILE POWERED ROOF VENTS TO BE SELECTED BY GC AND SUBMITTED TO HDLC FOR APPROVAL.

LEVEL 2 ROOF : 960 SF REQUIRES 6.4 SF OF VENTILATION

VENTILATION DESIGN INCLUDING TYPE, QUANTITY AND LOCATIONS TO BE DESIGNED BY ROOFING SUBCONTRACTOR. VENTS TO MATCH ROOF FINISH MATERIAL.

NOTE:
ROOFING SYSTEM TO BE INSTALLED PER THE MANUFACTURER'S NEW CONSTRUCTION INSTALLATION DETAILS

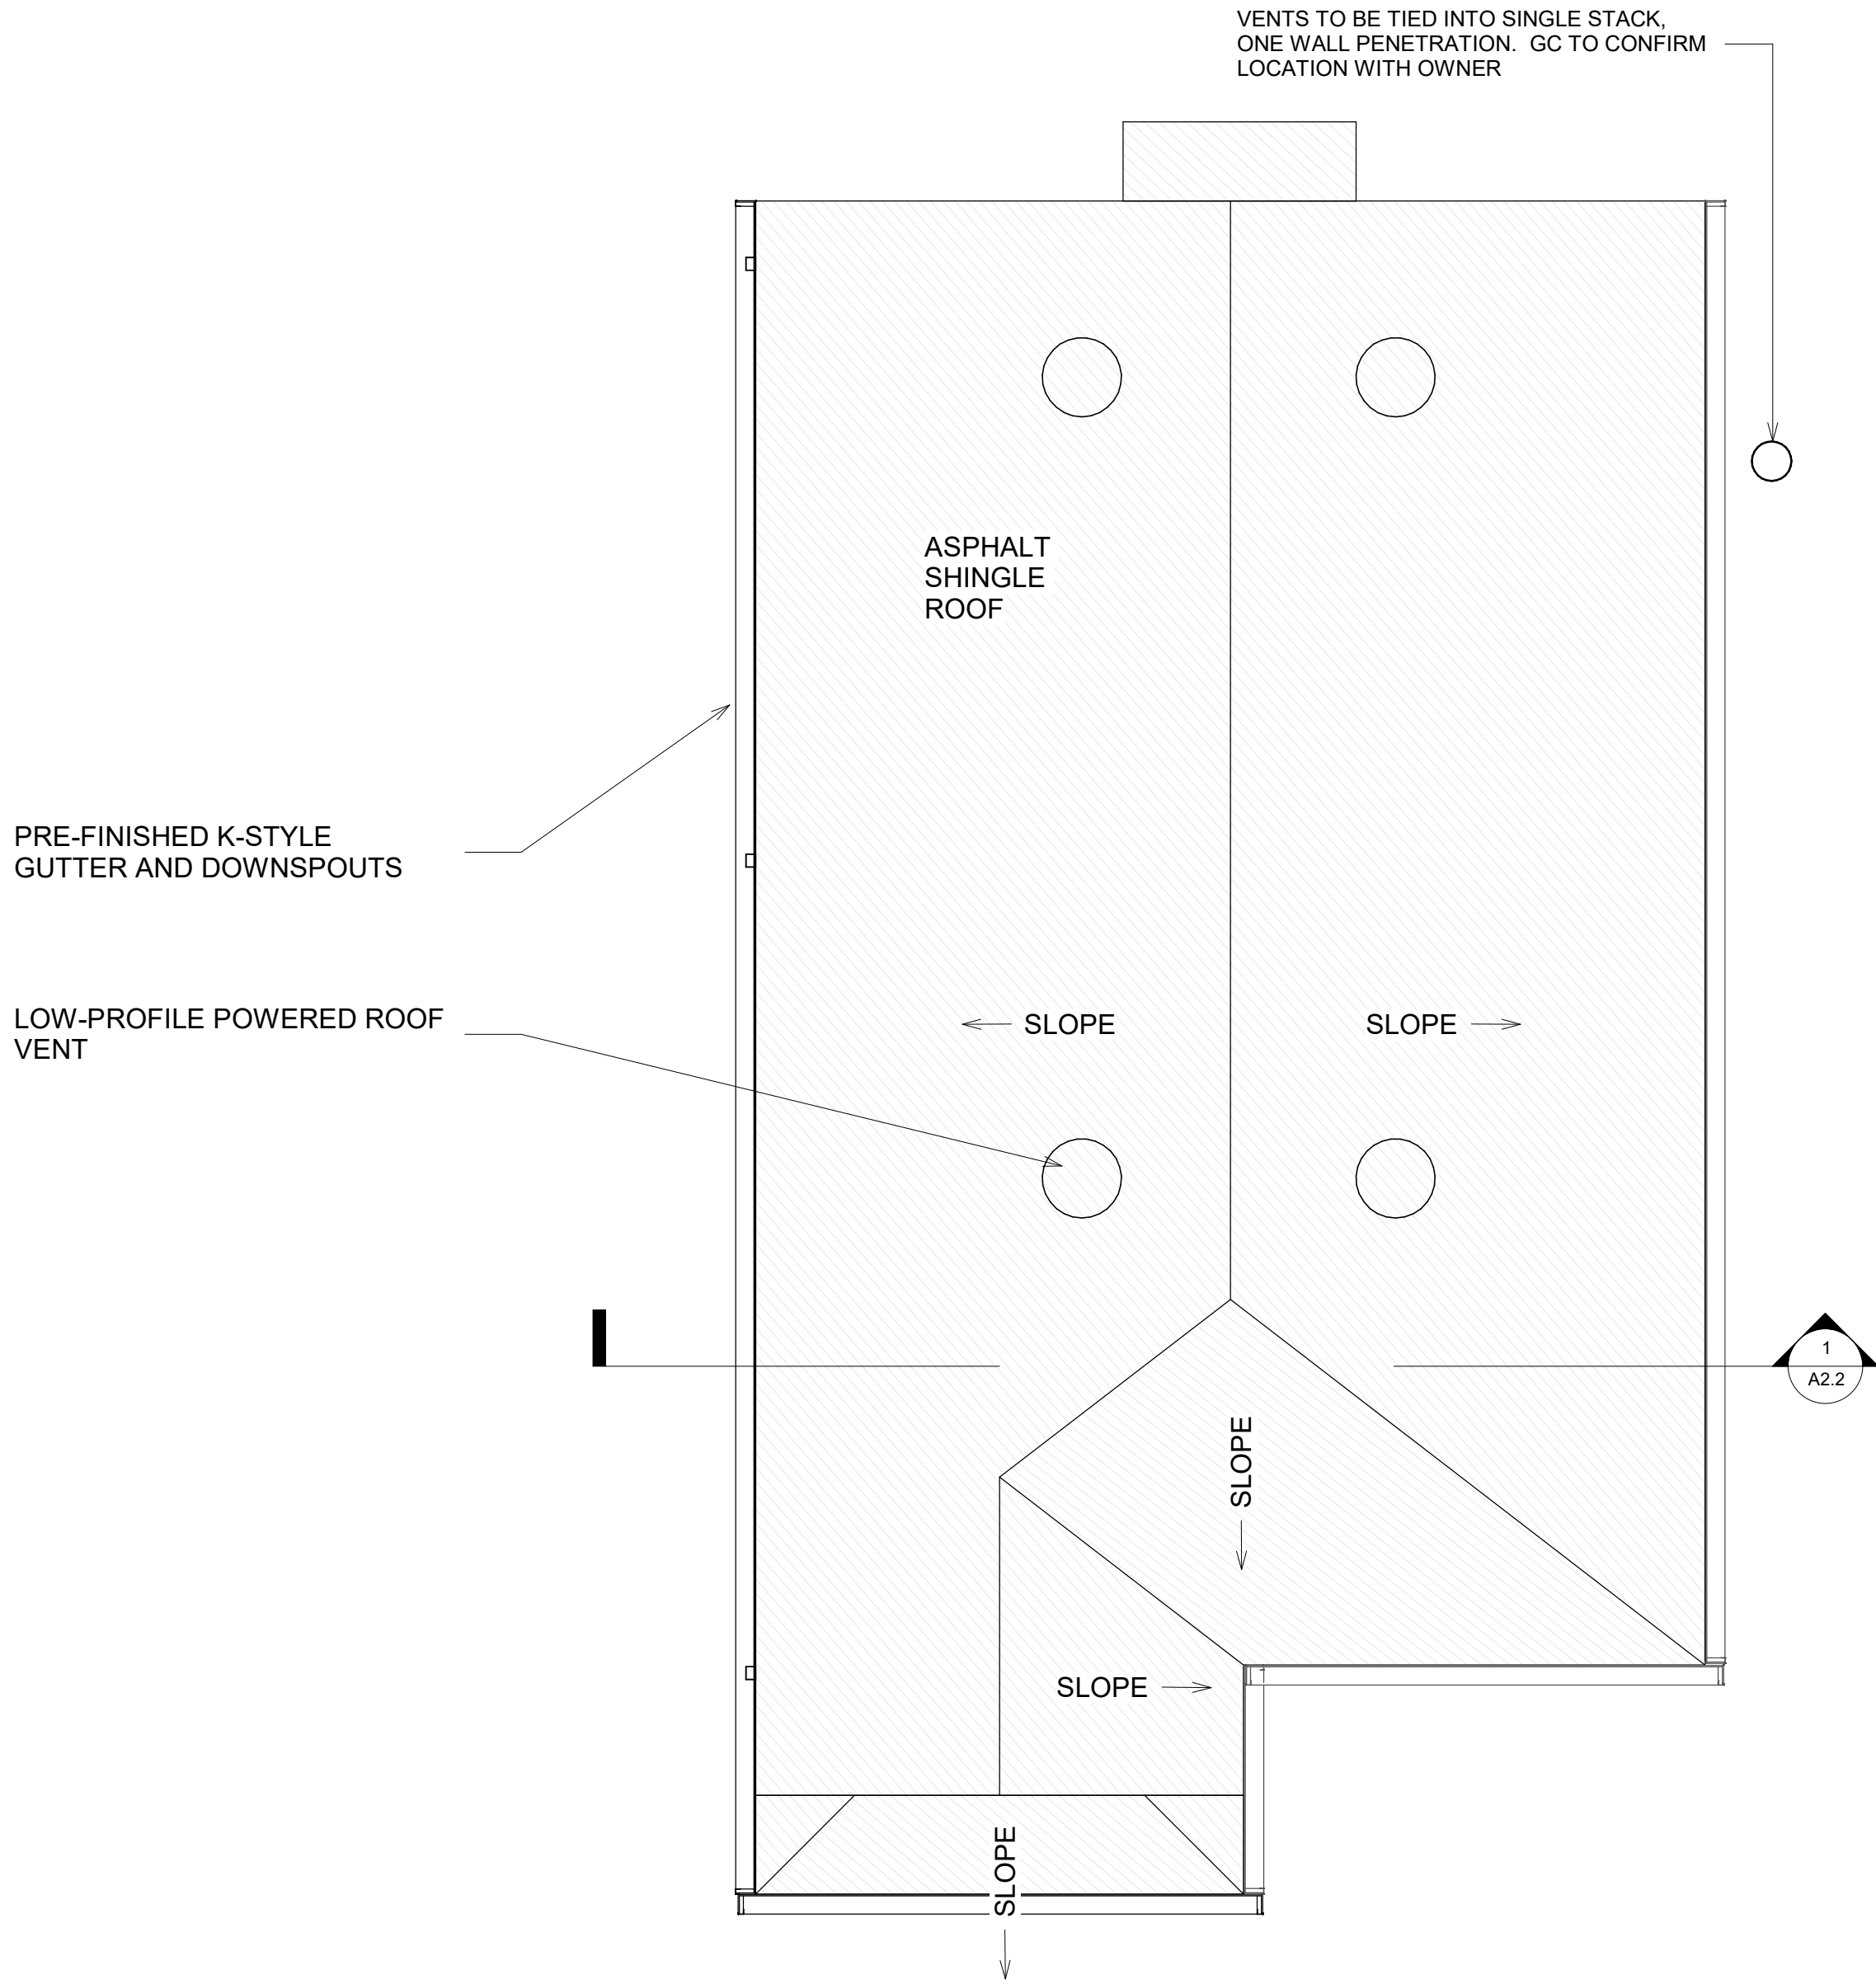


1 Roof Plan
1/4" = 1'-0"

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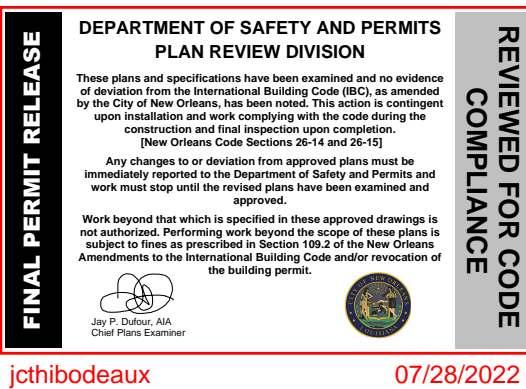
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SHEET TITLE:

Roof Plan

SHEET NUMBER:

A1.4
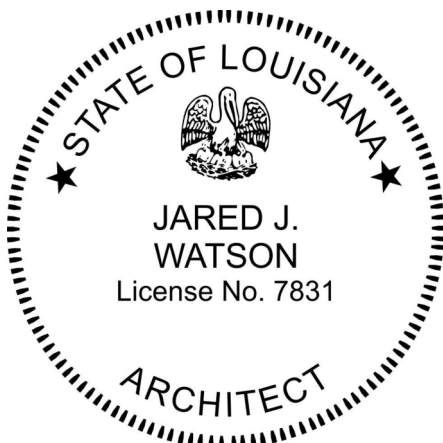
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SCALE: 1/4" = 1'-0"




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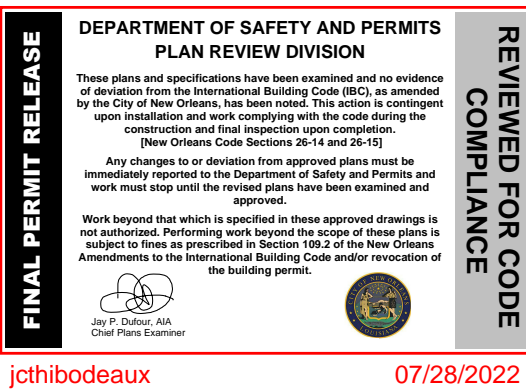
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2	ISSUE FOR PERMIT	22.06.28

ISSUANCE:



SHEET TITLE:
Reflected
Ceiling Plans
SHEET NUMBER:

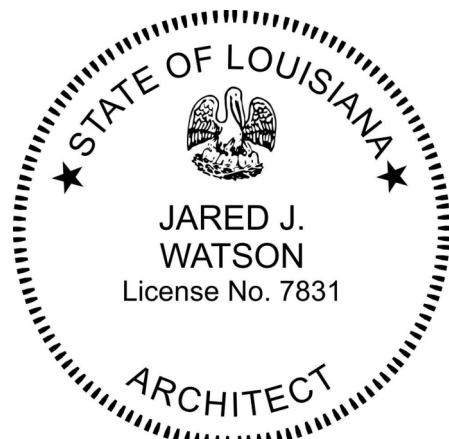A1.5

DATE: FOR PERMIT

SCALE: 1/4" = 1'-0"

MECHANICAL NOTES

GENERAL CONTRACTOR RESPONSIBLE FOR PROVIDING DESIGN/BUILD MECHANICAL SERVICES FOR PROJECT. ORGANIZATION AND LAYOUT IN ARCHITECTURAL PLANS IS SUGGESTIVE ONLY, AND FOR REFERENCE ONLY. DETAILS AND MECHANICAL SYSTEM DESIGN TO BE COORDINATED WITH DESIGN BY HVAC SUB.

WORK TO BE SUBMITTED TO OWNER TO REVIEW FOR CONFORMANCE WITH DESIGN REQUIREMENTS.

IT IS INTENDED THAT ALL OCCUPIED SPACES ARE TO BE CONDITIONED.

GENERAL CONTRACTOR IS RESPONSIBLE FOR MAINTAINING ALL FIRE BARRIERS. INCLUDING REQUIRED BLOCKING, GYP BD. AND FIRE CAULKING AS NEEDED TO PROVIDE REQUIRED FIRE AND SMOKE RESISTANCE RATING AT ALL FLOOR, WALL AND ROOF ASSEMBLIES AND SEPARATIONS PER CODE REQUIREMENTS.

WHERE TOILET ROOMS AND BATHROOMS ARE MECHANICALLY VENTILATED, THE VENTILATION EQUIPMENT SHALL BE INSTALLED IN ACCORDANCE WITH IRC 2015 SECTION 1507.

ELECTRICAL NOTES

COORDINATE ALL SCONCE HEIGHTS AND OUTLET HEIGHTS WITH OWNER PRIOR TO ROUGH-IN.

GENERAL CONTRACTOR RESPONSIBLE FOR PROVIDING DESIGN/BUILD ELECTRICAL SERVICES FOR PROJECTS. WORK TO COMPLY WITH ALL APPLICABLE CODES AND BE PERFORMED BY APPROPRIATELY LICENSED COMPANIES.

ELECTRICAL POWER INFORMATION SHOWN ON PLAN IS TO INDICATE BASIC INTENT AND SPECIFIC CONDITIONS ONLY. ELECTRICAL SUBCONTRACTOR IS RESPONSIBLE FOR PROVIDING ALL CODE-REQUIRED LIGHTING, OUTLETS AND POWER TO EQUIPMENT, FIXTURES, LIGHTING, ETC FOR A COMPLETE SYSTEM.

SMOKE DETECTORS SHALL BE PROVIDED OUTSIDE SLEEPING AREAS AND INSIDE EACH BEDROOM AS REQUIRED BY CODE. SMOKE DETECTORS SHALL BE 120V, HARDWIRED, INTERCONNECTED WITH A BATTERY BACKUP AND SHALL NOT BE INSTALLED WITHIN 36" OF A RETURN AIR GRILLE OR ANY PADDLE FAN BLADE.

LIGHTING LAYOUT SHOWN ON PLANS IS TO DESCRIBE DESIGN INTENT ONLY. ELECTRICAL CONTRACTOR TO PROVIDE ALL RECEPTACLES AT STANDARD LOCATIONS AND INTERVALS WHICH ARE NOT SHOWN ON THE PLANS, CODE-REQUIRED LIGHTING.

FINAL LIGHT FIXTURE SELECTIONS AND LAYOUT TO BE COORDINATED WITH OWNER.
GENERAL CONTRACTOR TO PROVIDE ALLOWANCES FOR FANS AND LIGHT FIXTURES TO BE REVIEWED WITH OWNER.

KITCHEN: OUTLETS TO BE INSTALLED ON KITCHEN ISLAND PER CODE REQUIREMENTS. ALL RECEPTACLES OVER COUNTERTOP TO BE GFI PROTECTED.

BATHROOMS: ALL OUTLETS SHALL BE GFI PROTECTED. LIGHTS OVER BATHTUBS TO HAVE COVERS LISTED FOR DAMP LOCATION. LIGHTS OVER SHOWERS SHALL HAVE COVERS LISTED FOR WET LOCATIONS. WHERE TOILET ROOMS AND BATHROOMS ARE MECHANICALLY VENTILATED, THE VENTILATION EQUIPMENT SHALL BE INSTALLED IN ACCORDANCE WITH 2015 IRC SECTION 1507.

AFCI PROTECTION SHALL BE PROVIDED FOR DINING ROOMS, FAMILY ROOMS, LIVING ROOMS, HALLWAYS, CLOSETS, ETC.


EXTERIOR RECEPTACLES SHALL BE GFI PROTECTED WITH WEATHERPROOF COVERS.

CONFIRM ANY LOW-VOLTAGE REQUIREMENTS WITH OWNER.


PROVIDE DEDICATED CIRCUITS FOR ALL A/V EQUIPMENT. CONFIRM WITH OWNER.

GC TO PROVIDE CAT5 AND DATA CONNECTION AT LOCATIONS INDICATED ON PLANS. CONFIRM LOCATIONS WITH OWNER.

RECEPTACLES, SWITCHES AND ALL OUTLET BOX COVERS TO BE WHITE, UNLESS NOTED OTHERWISE.

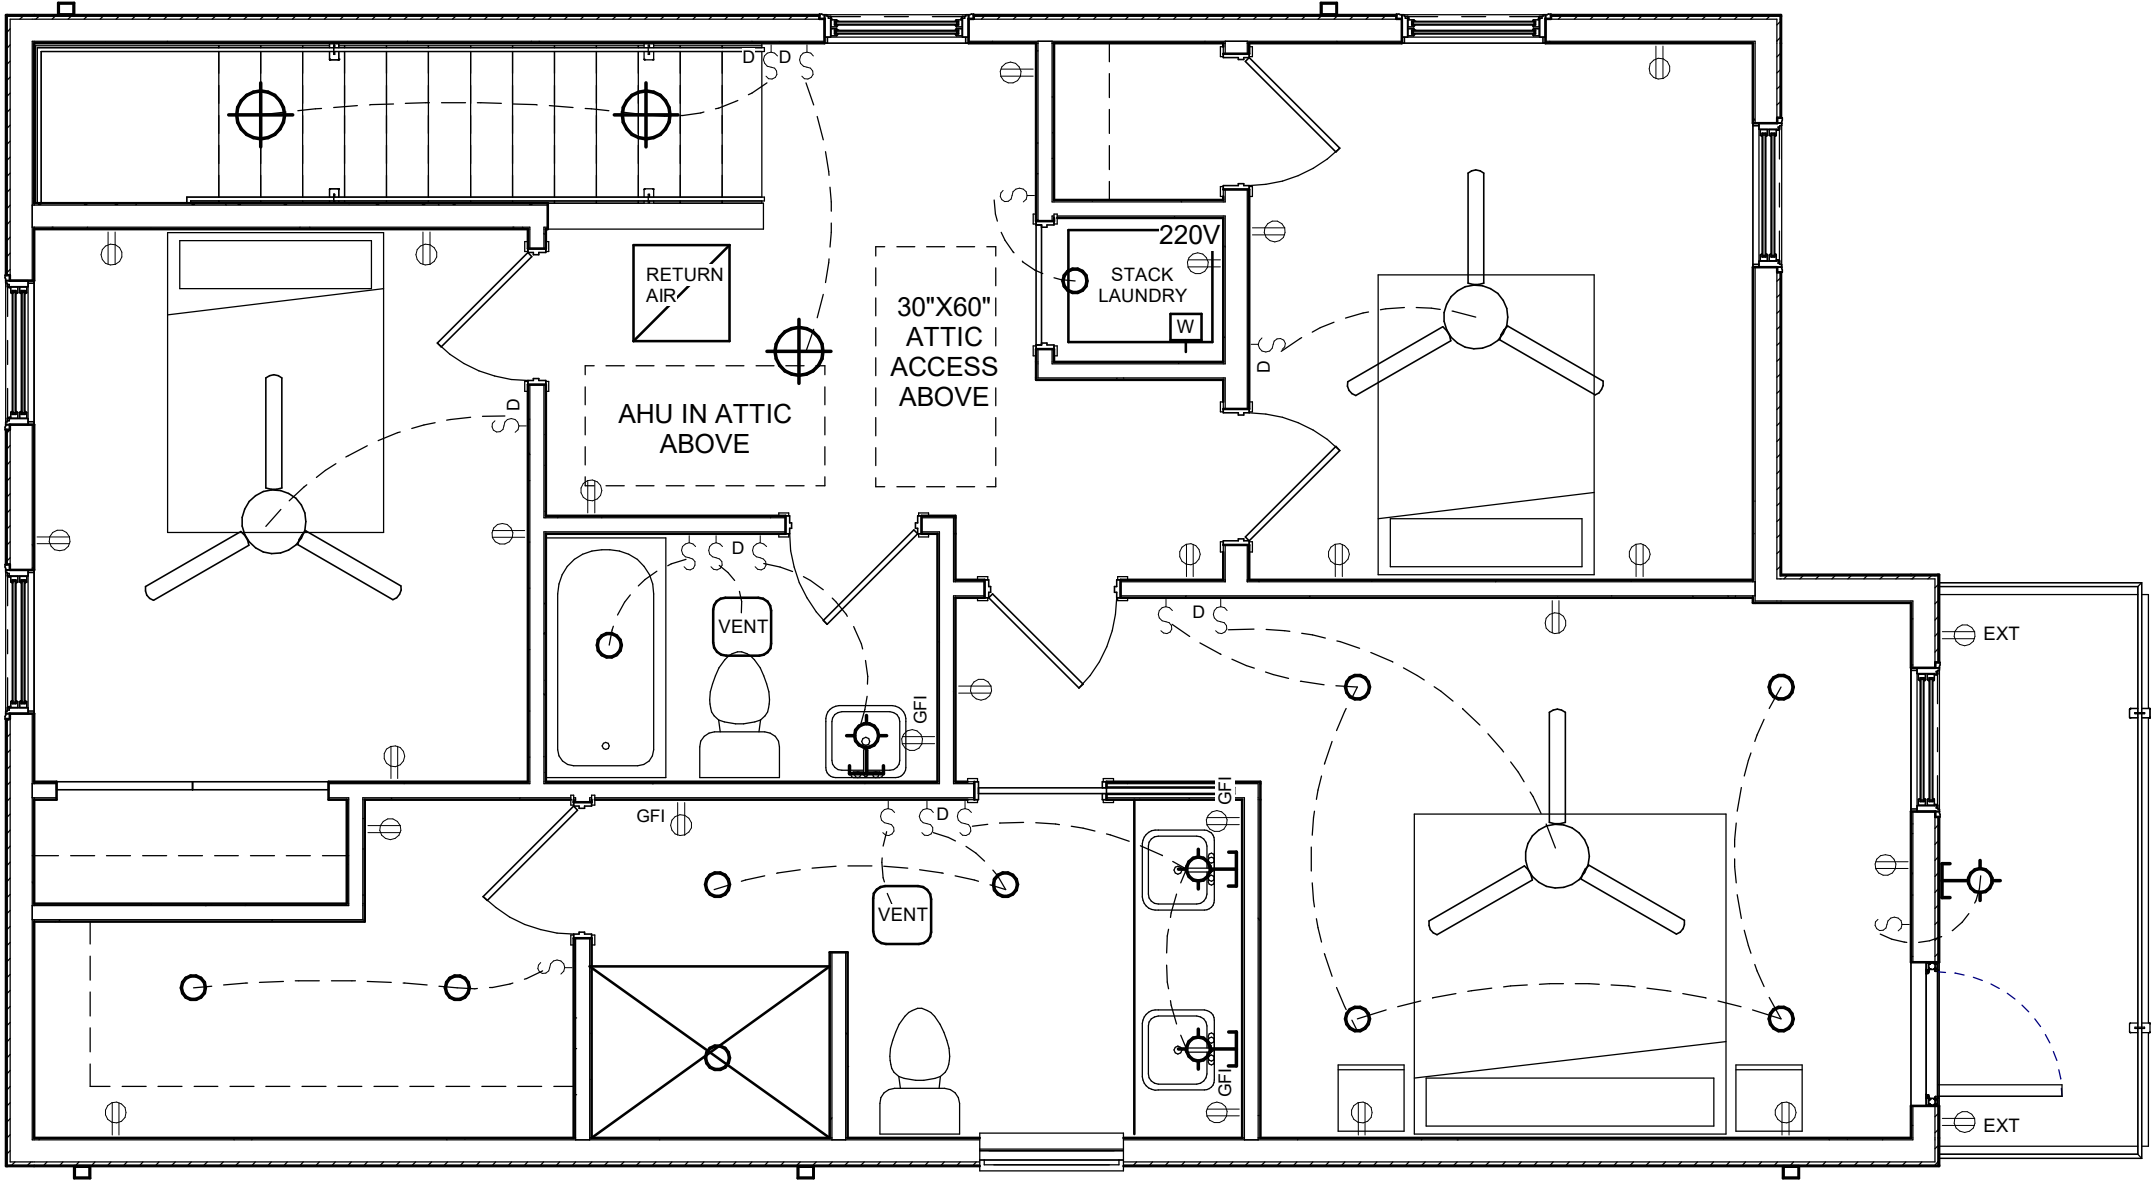

2 RCP - Floor 2
1/4" = 1'-0"

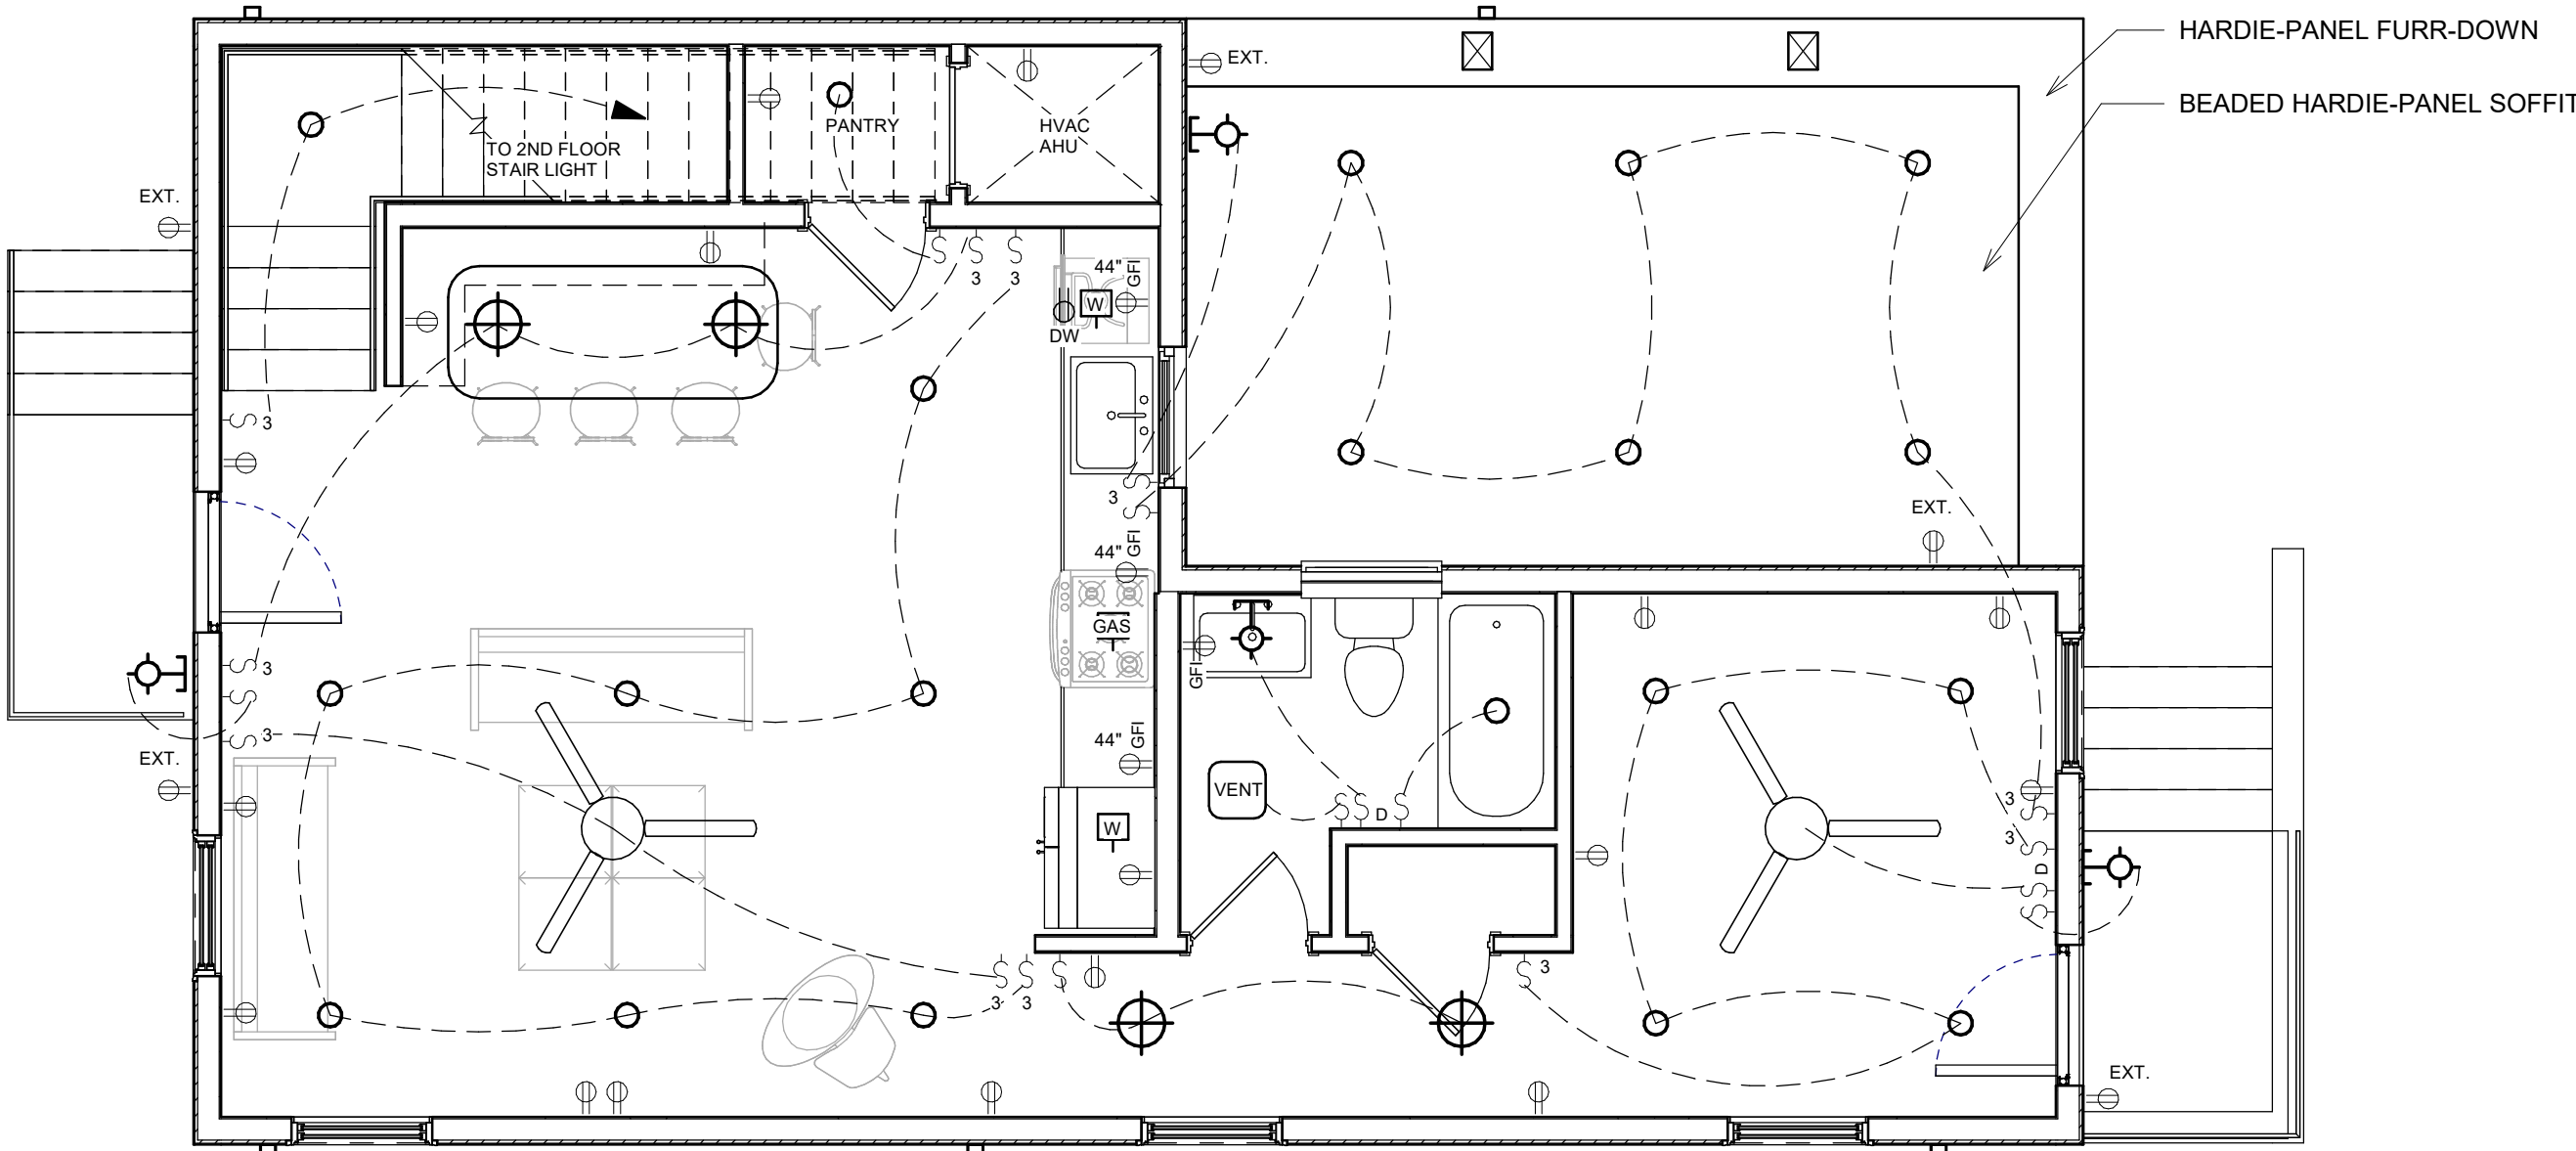

1 RCP - Floor 1
1/4" = 1'-0"



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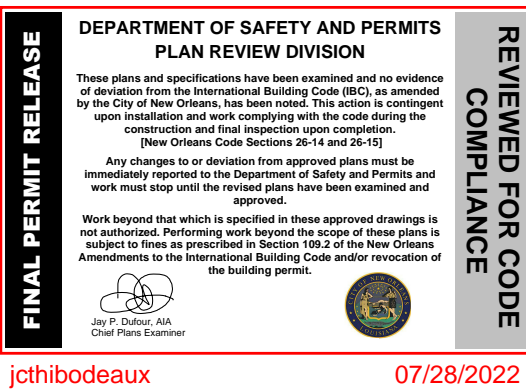
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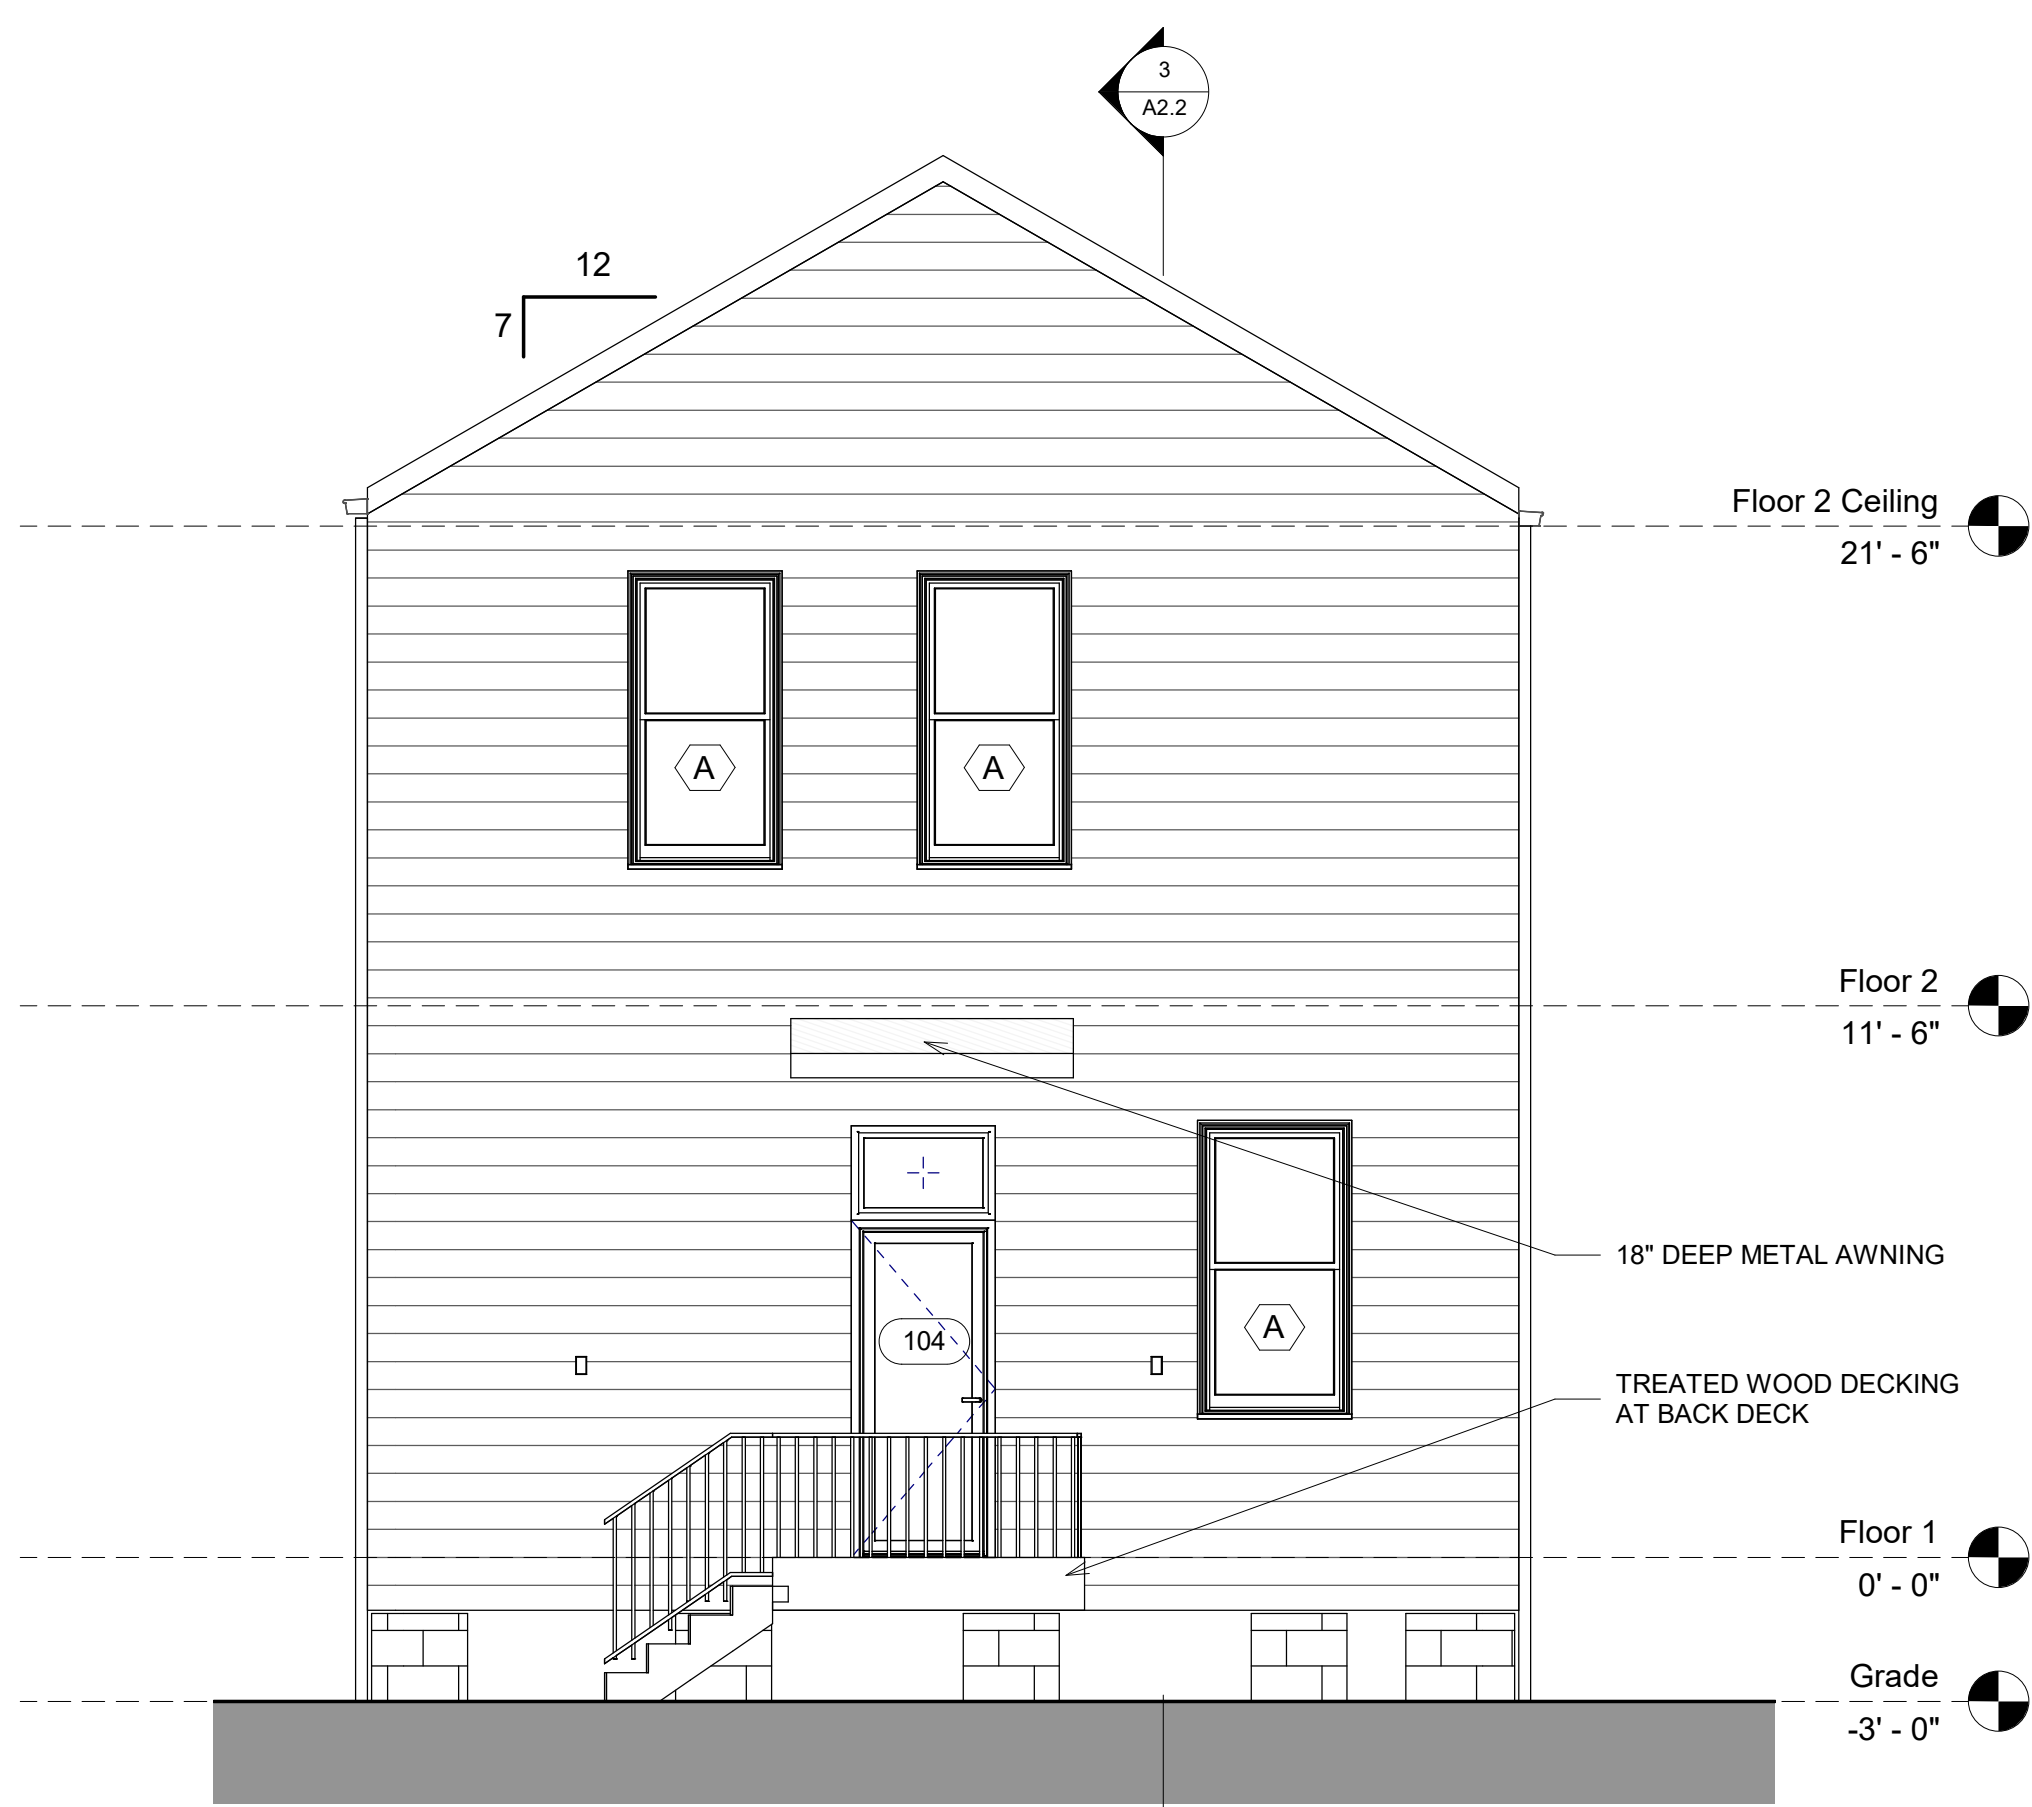
Elevations

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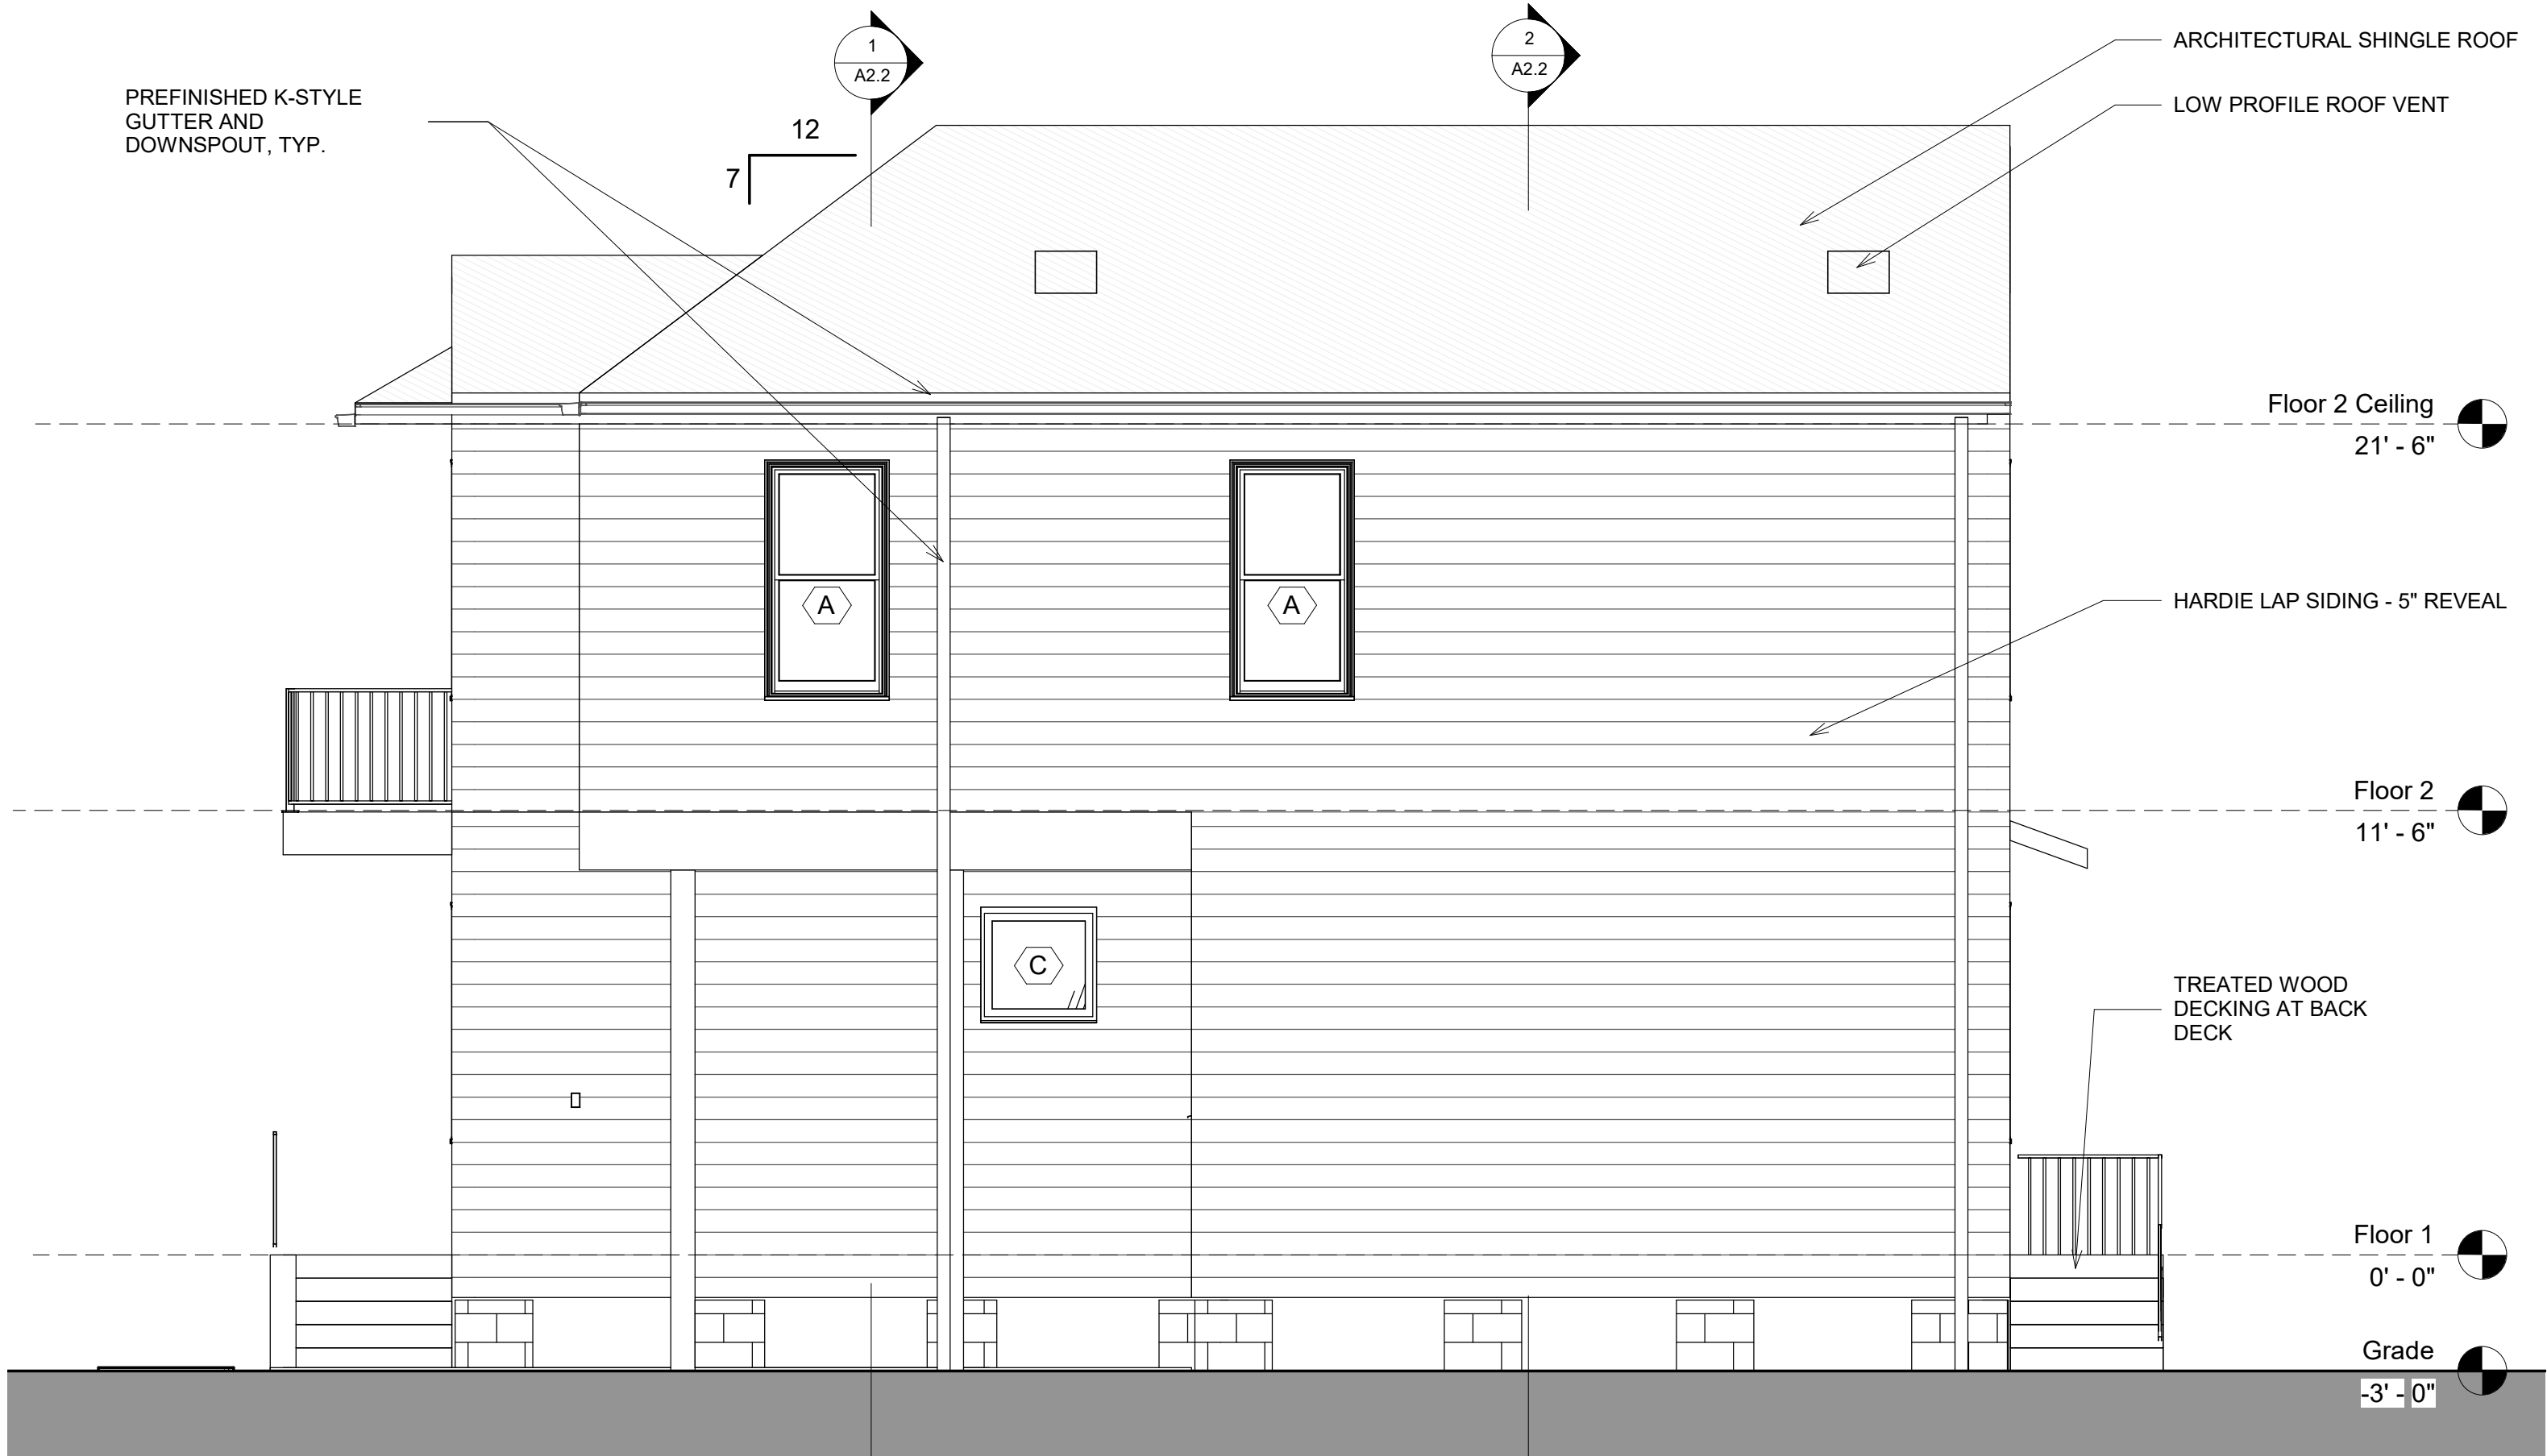
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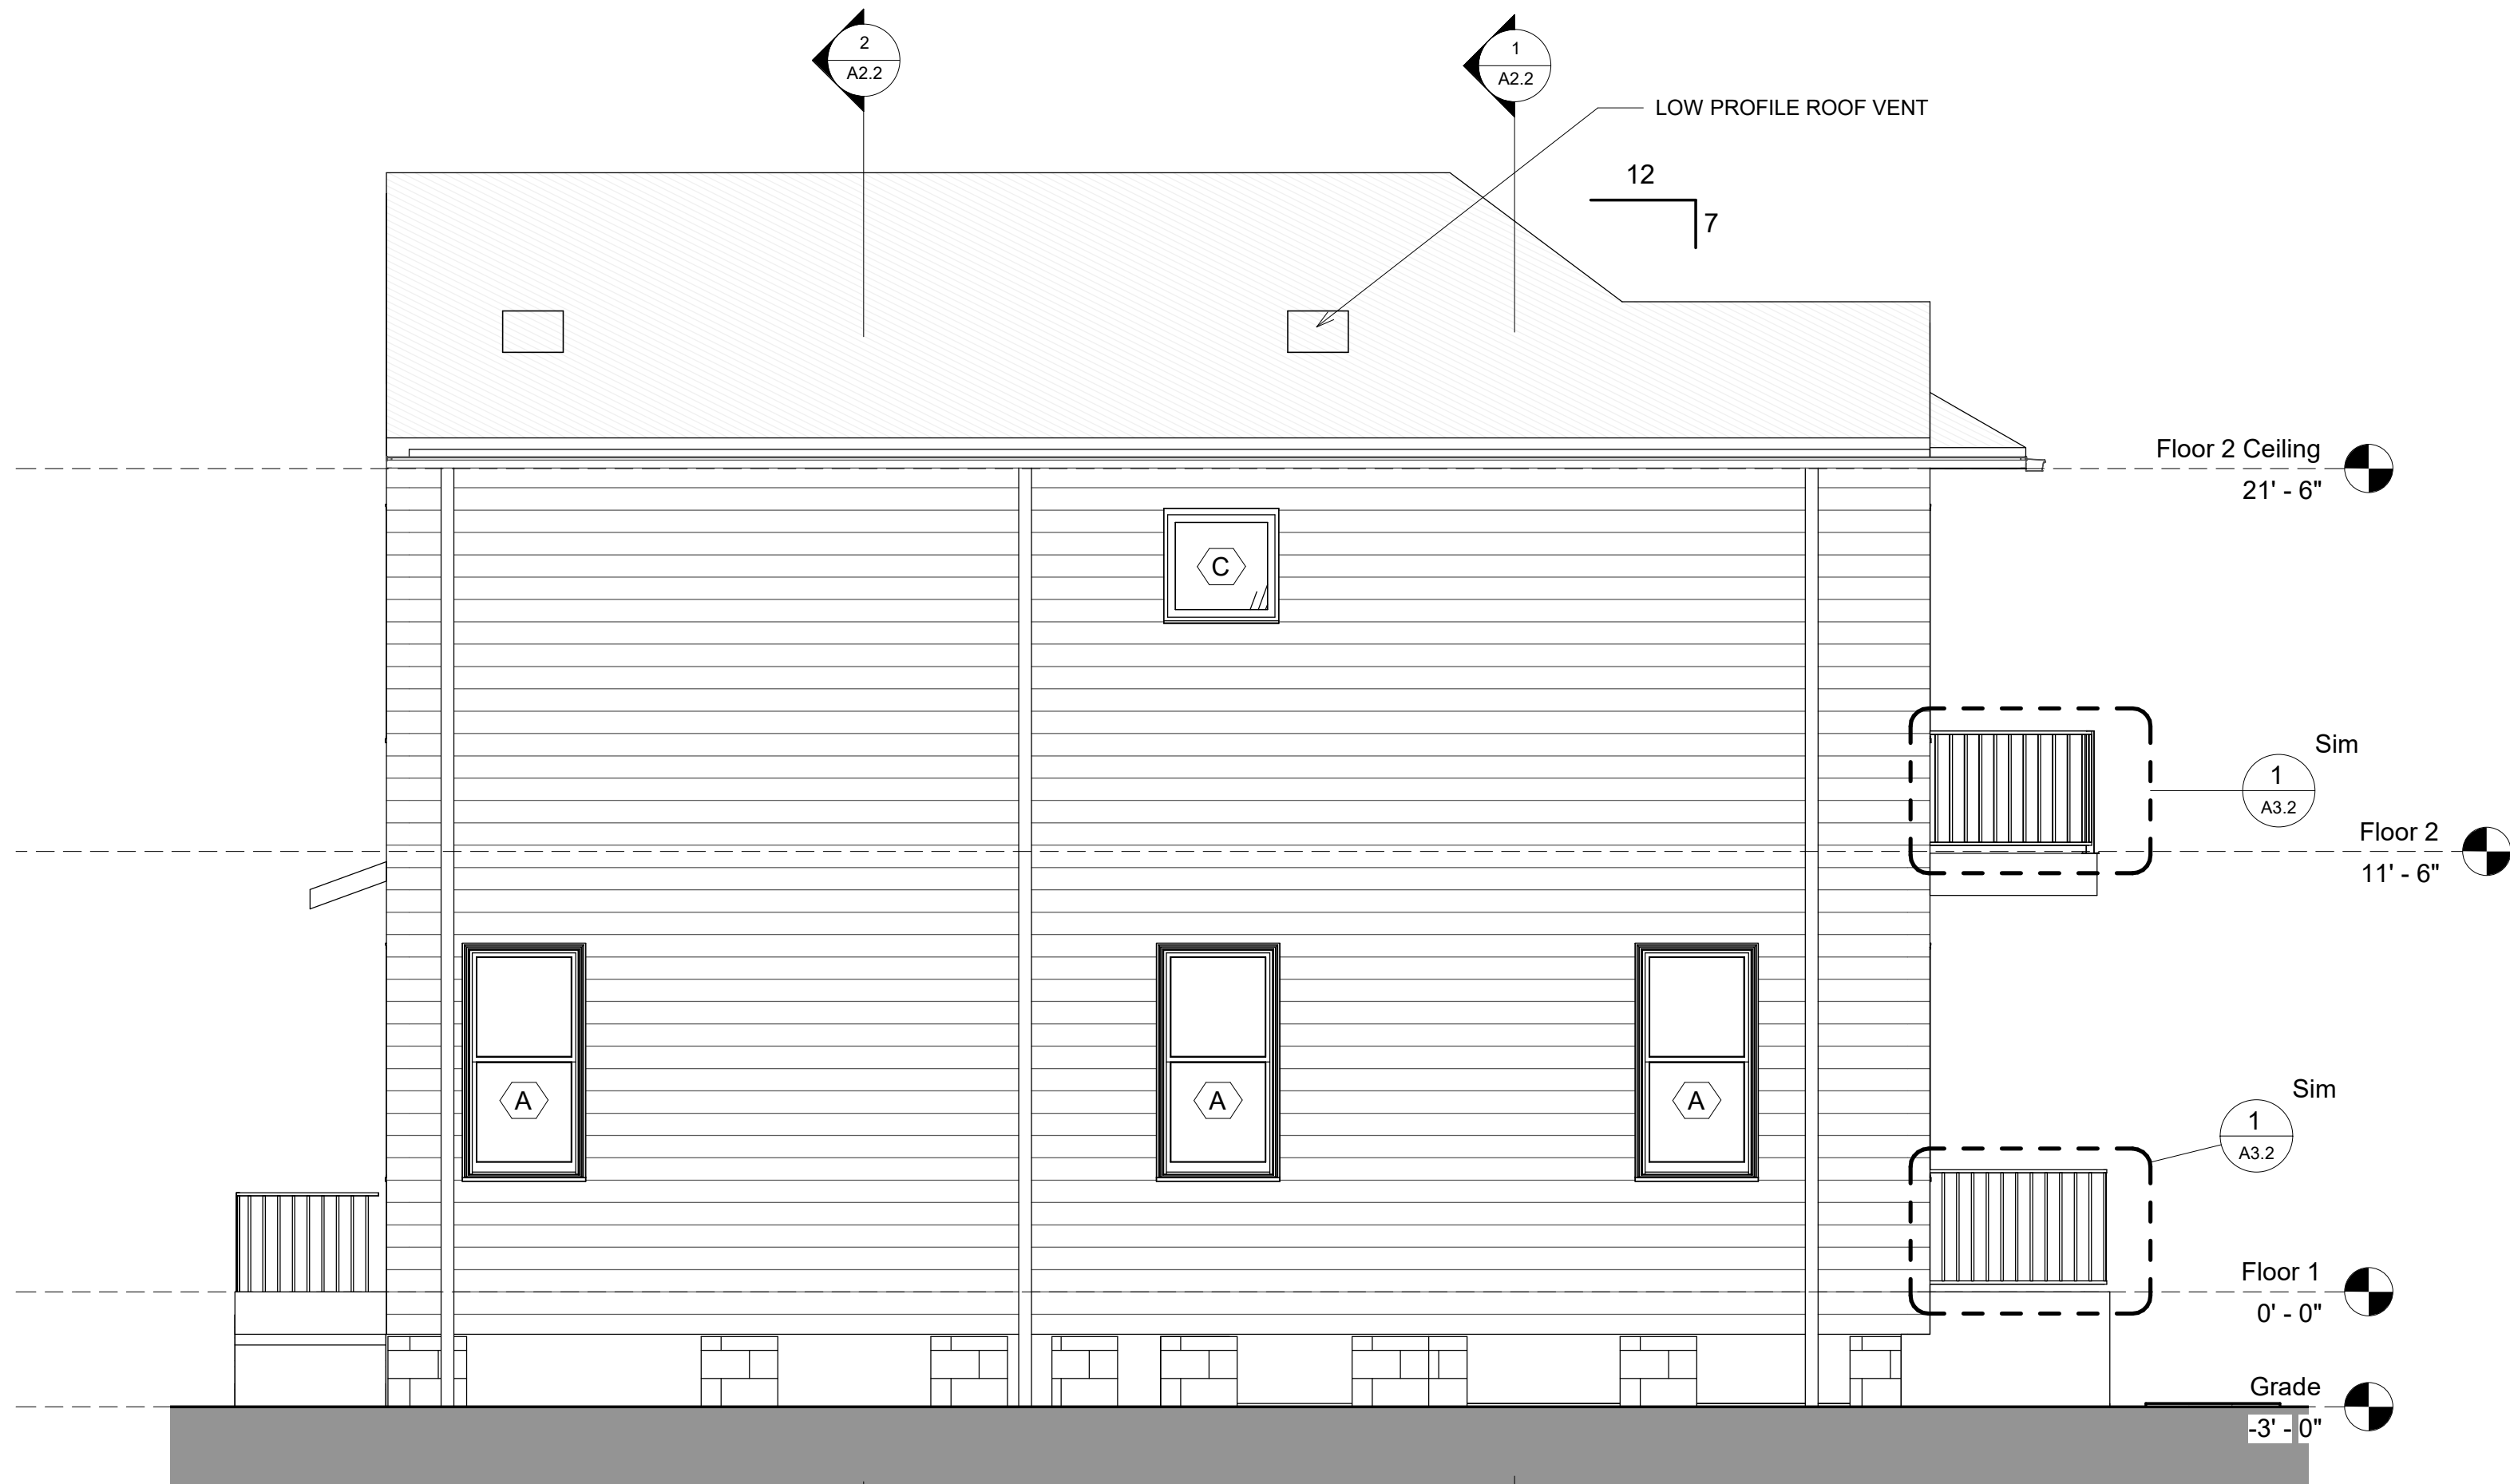
SCALE: 1/4" = 1'-0"



7 Elevation Rear
1/4" = 1'-0"




6 Elevation Right Side
1/4" = 1'-0"



3 Elevation Left
1/4" = 1'-0"

NOTES:
CONTRACTOR IS RESPONSIBLE FOR LOCATING FINISH FLOOR HEIGHT ACCORDING TO FLOOD ZONE REQUIREMENTS.
MATERIAL BELOW B.F.E. SHALL COMPLY WITH SEC R-222.2 IRC 2015 FOR WATER RESISTANCE AND USE OF SPACE.
ALL OBTAINED INFORMATION SHALL BE CORRESPONDED TO THE OWNER AND ENGINEER BEFORE ANY WORK IS STARTED.
UNDER FLOOR SPACES SHALL COMPLY WITH SECTION R408 OF THE IRC 2015 FOR VENTILATION, OPENINGS AND ACCESS.

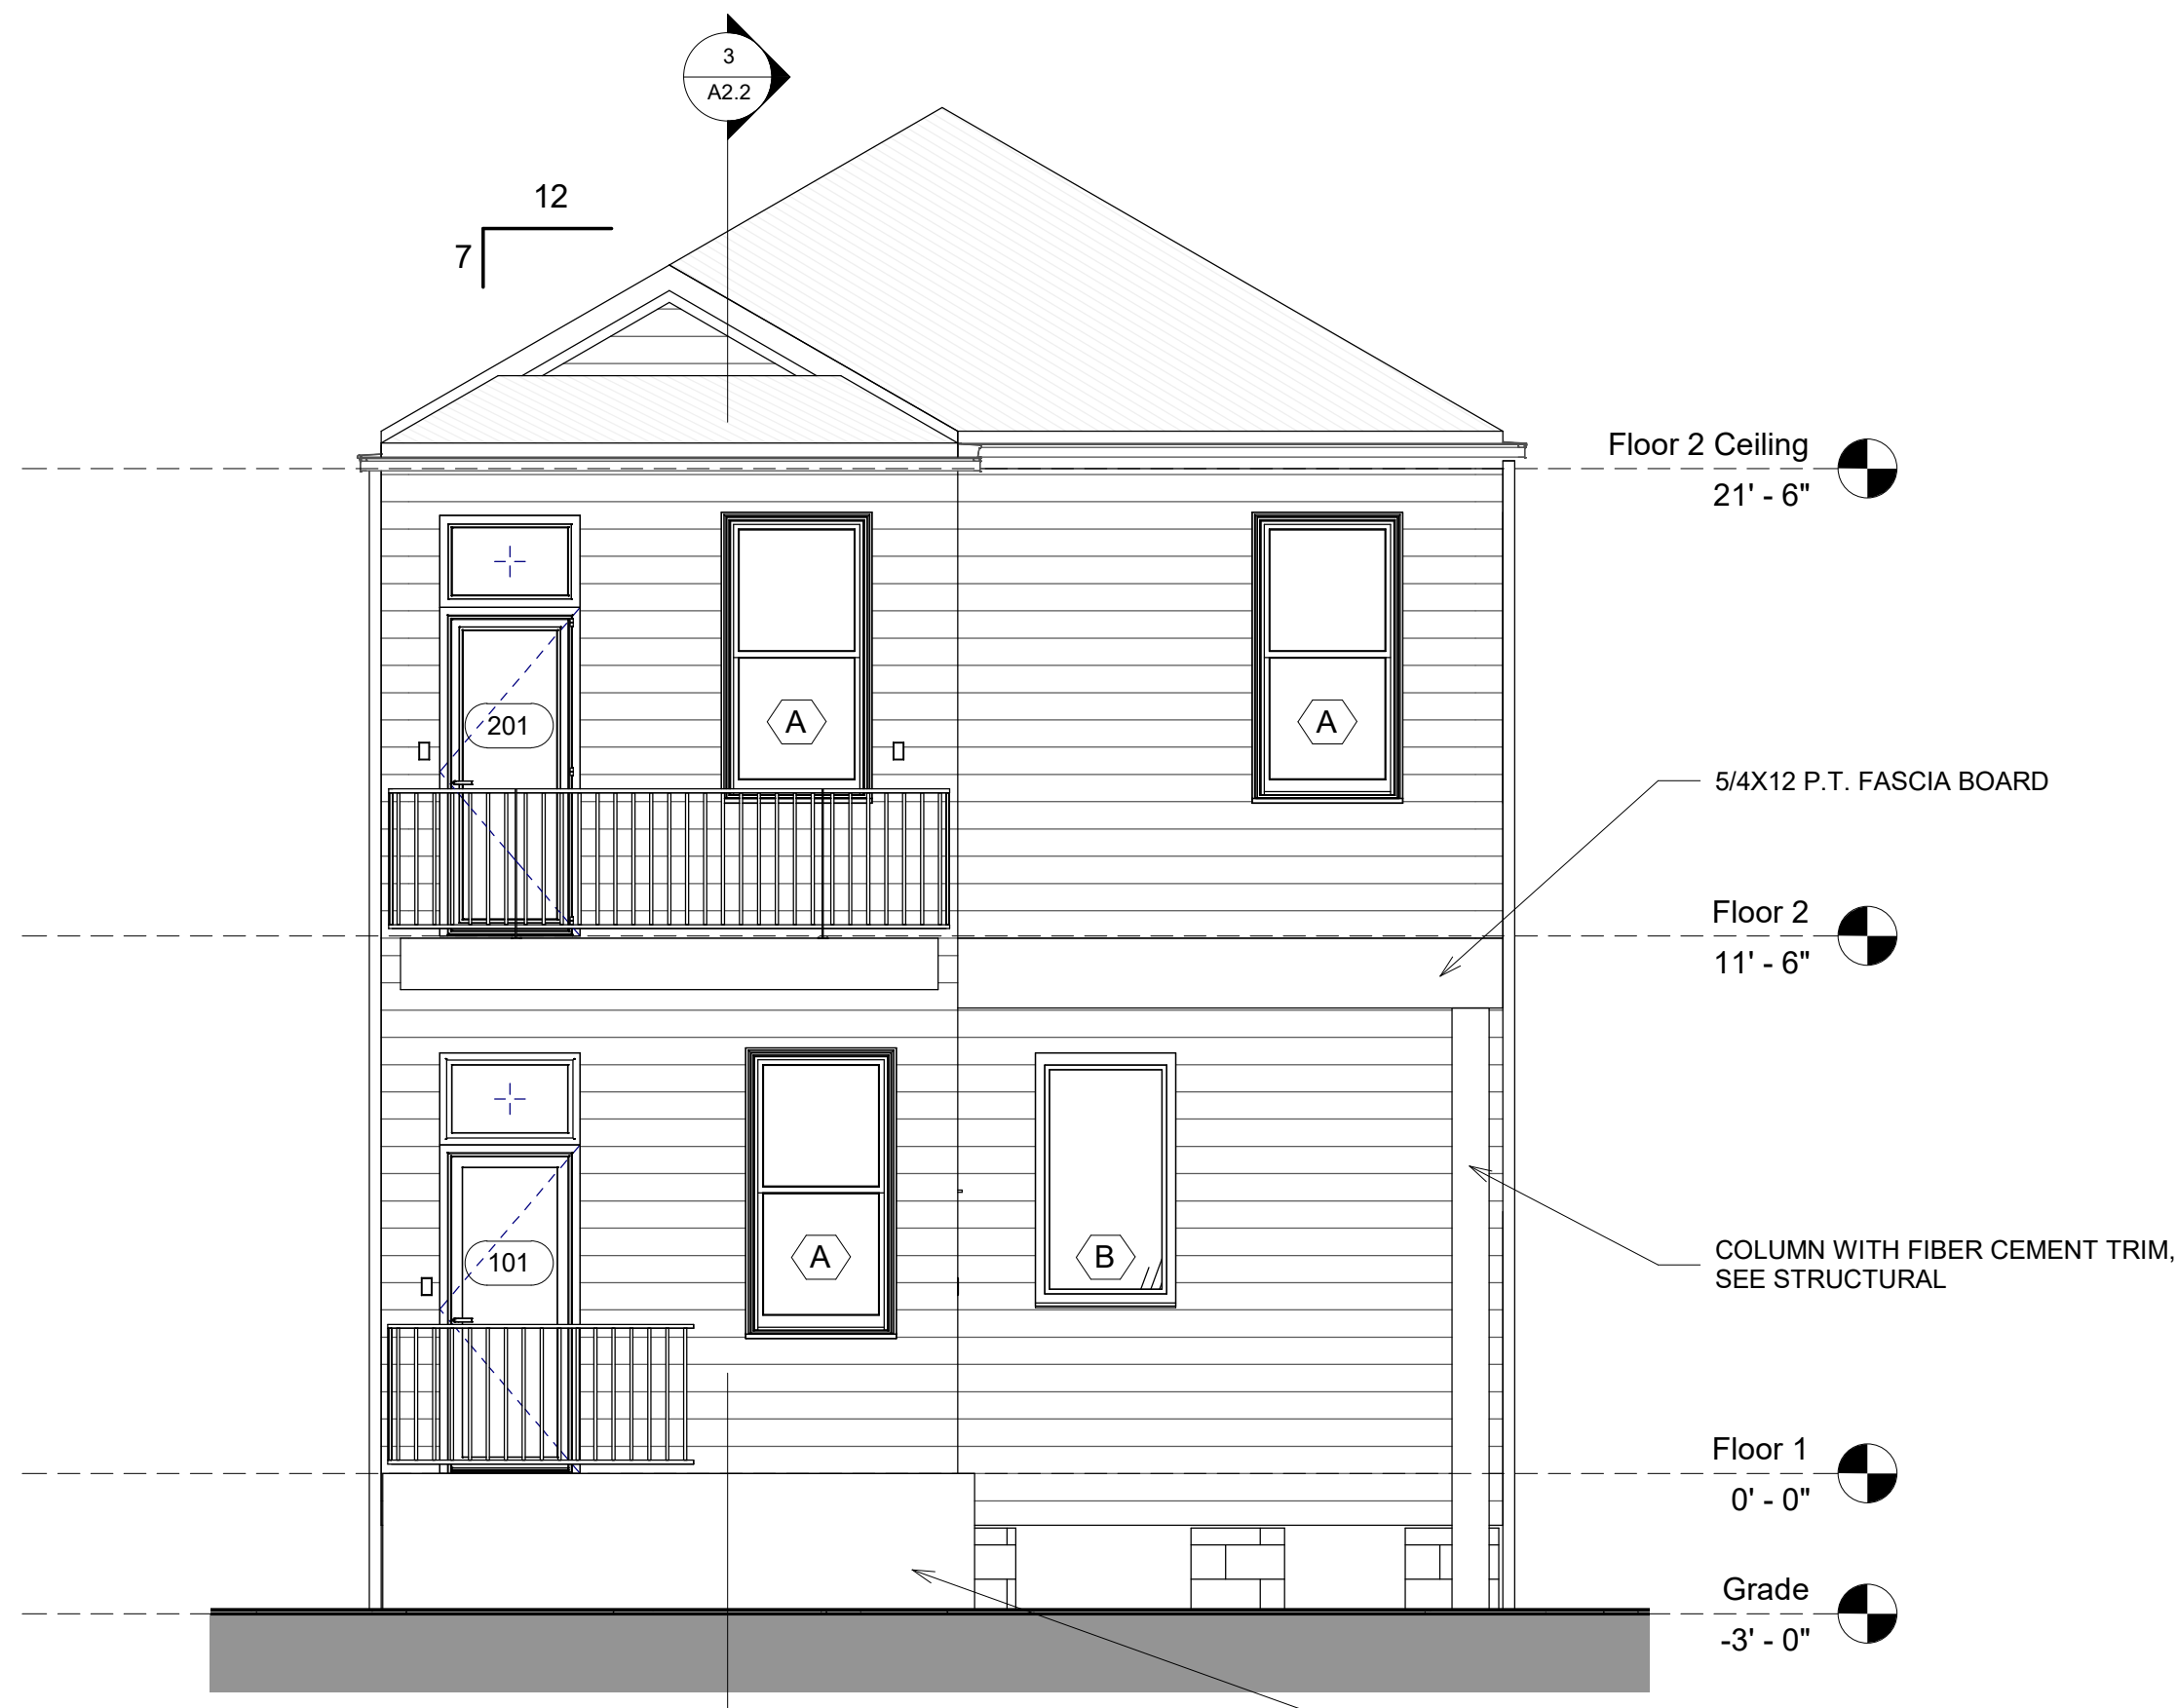

5 Elevation Front
1/4" = 1'-0"

NOTES:
ALL STRUCTURE SIZES OF MATERIAL ARE TO BE VERIFIED WITH STRUCTURAL DRAWINGS.
DETAILS ARE TO BE FOLLOWED NOT ASSUMED PER THE ELEVATIONS.
ALL EXTERIOR TRIM, FASCIA, CORNER BOARDS, WINDOW TRIM, ETC. TO BE WOOD UNLESS CORRECTLY SIZED (SMOOTH) CEMENT BOARD IS INDICATED TO BE USED. RIPPED FIBER CEMENT BOARD SHALL NOT BE USED.




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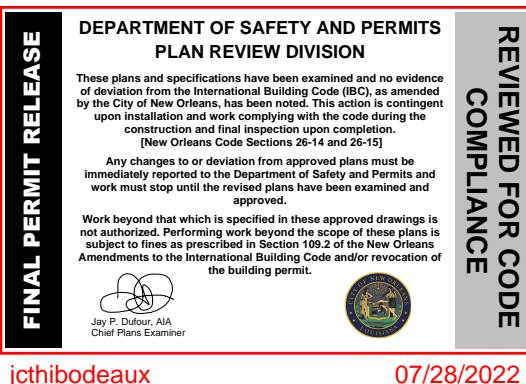
marais architects llc

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MARAIS ARCHITECTS, LLC
jared@maraisdesignbuild.com



Revision Schedule		
Revision Number	Revision Description	Revision Date
2	ISSUE FOR PERMIT	22.06.28

ISSUANCE:

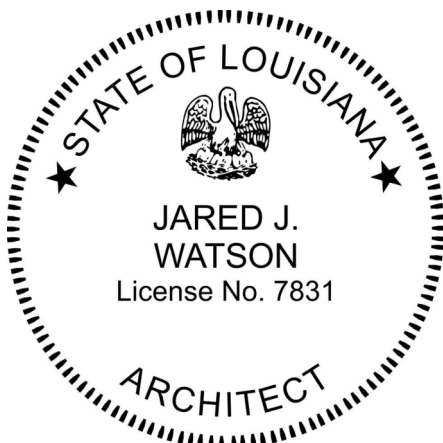


SHEET TITLE:
Building
Sections

SHEET NUMBER:


A2.2

DATE: FOR PERMIT


SCALE: 1/4" = 1'-0"

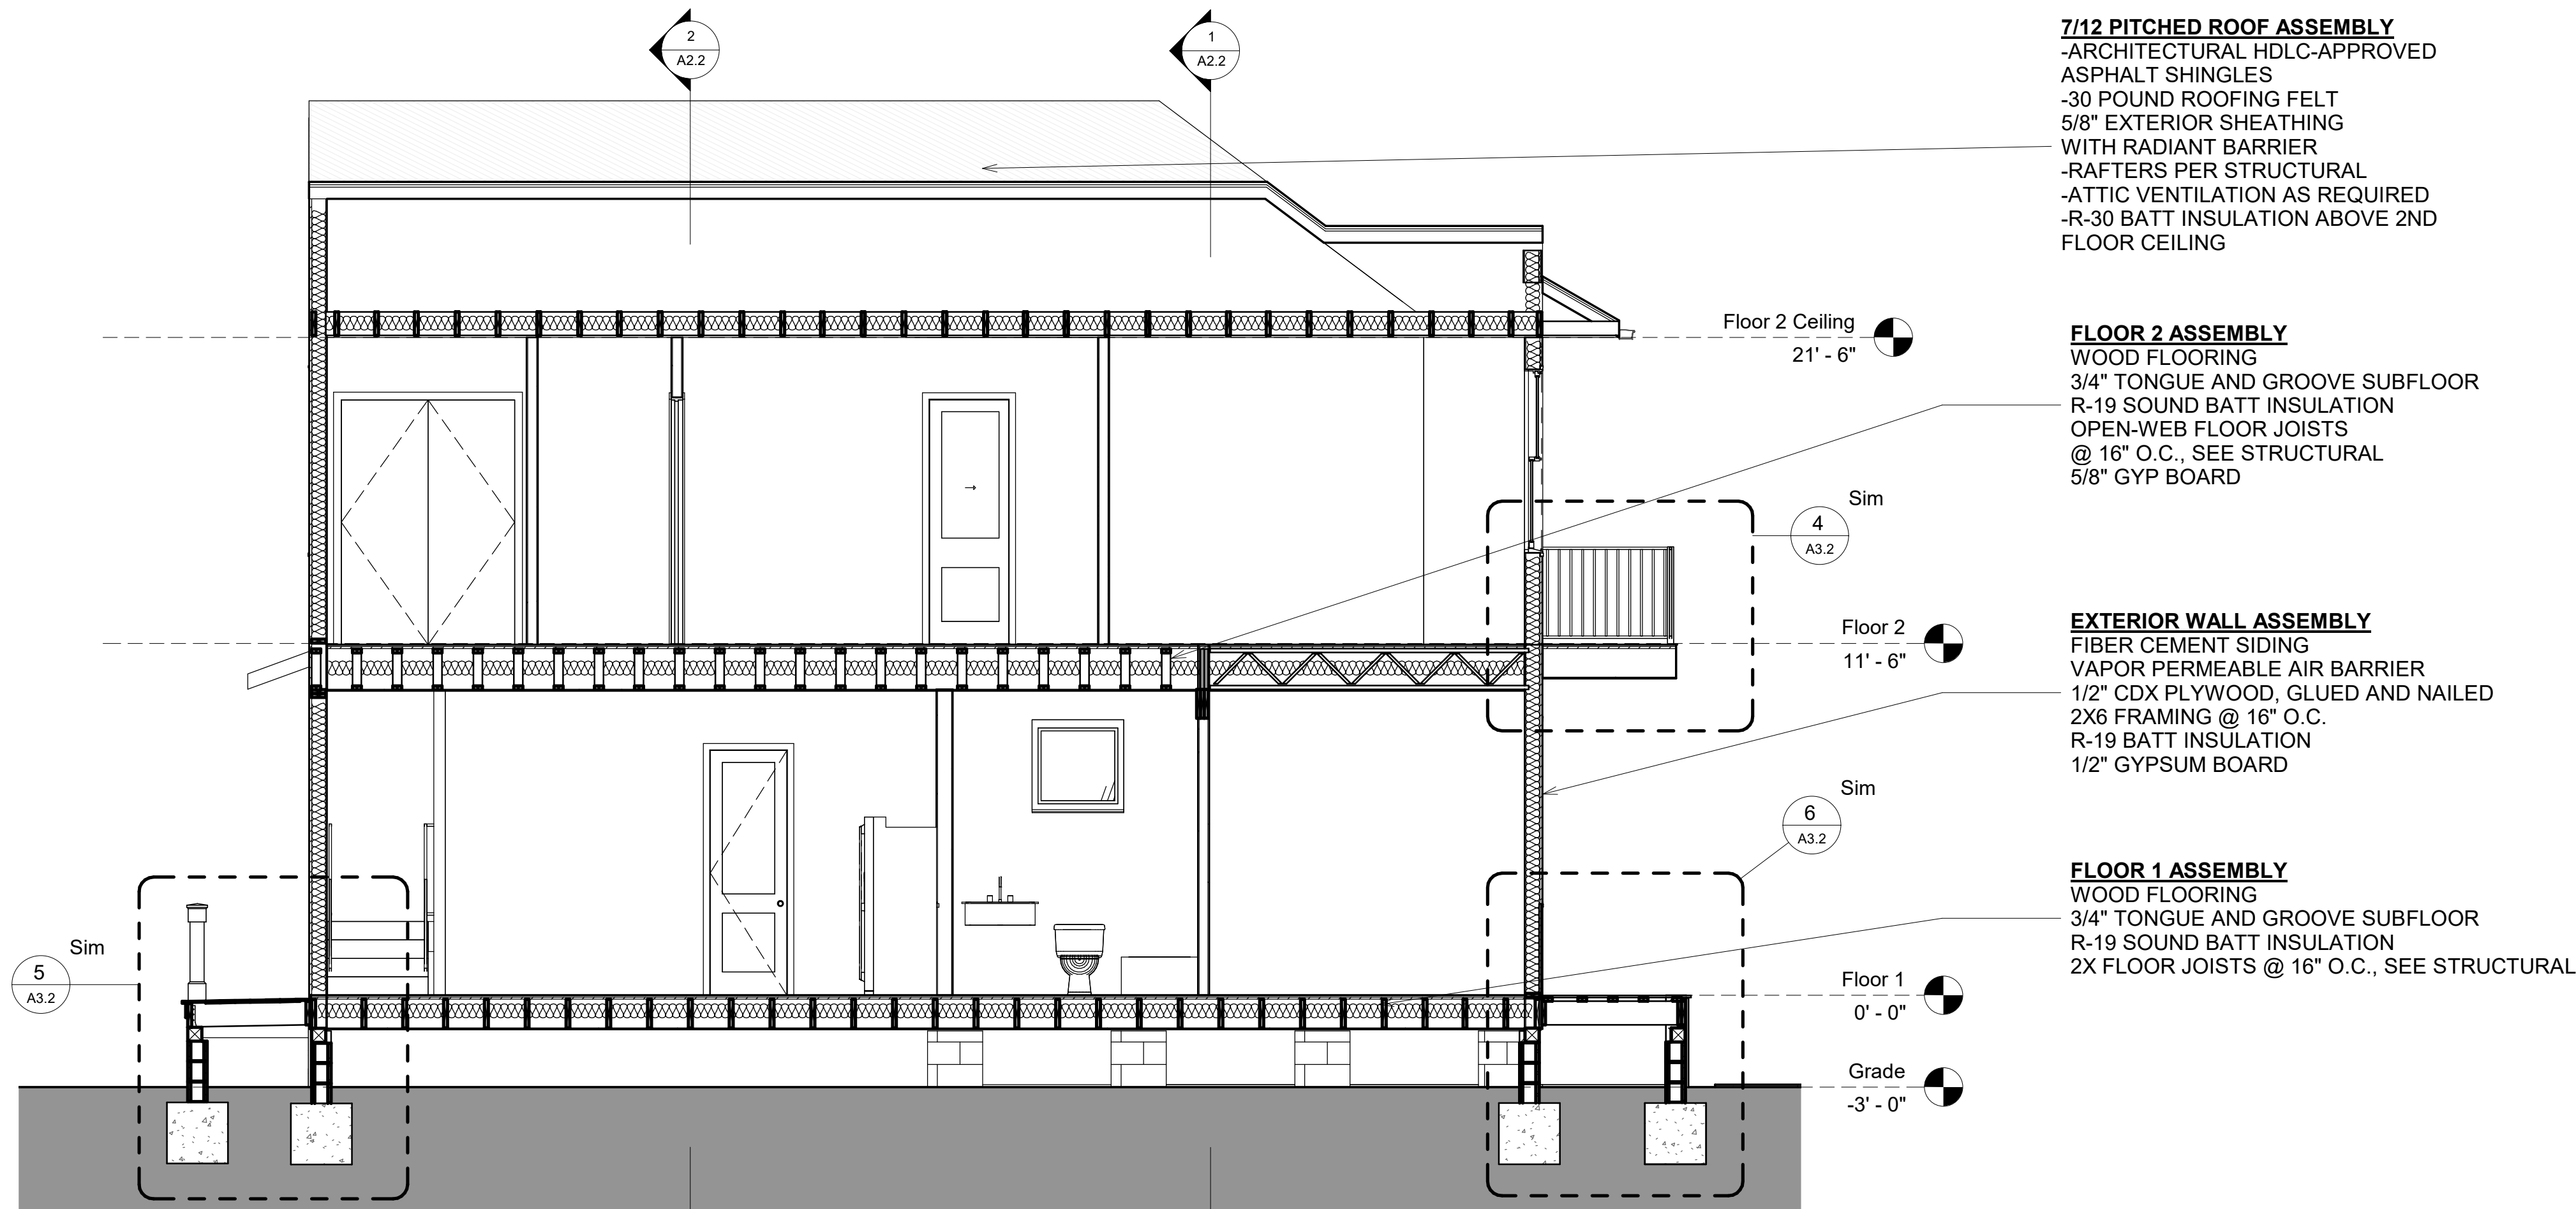

3 Section - Longitudinal
1/4" = 1'-0"

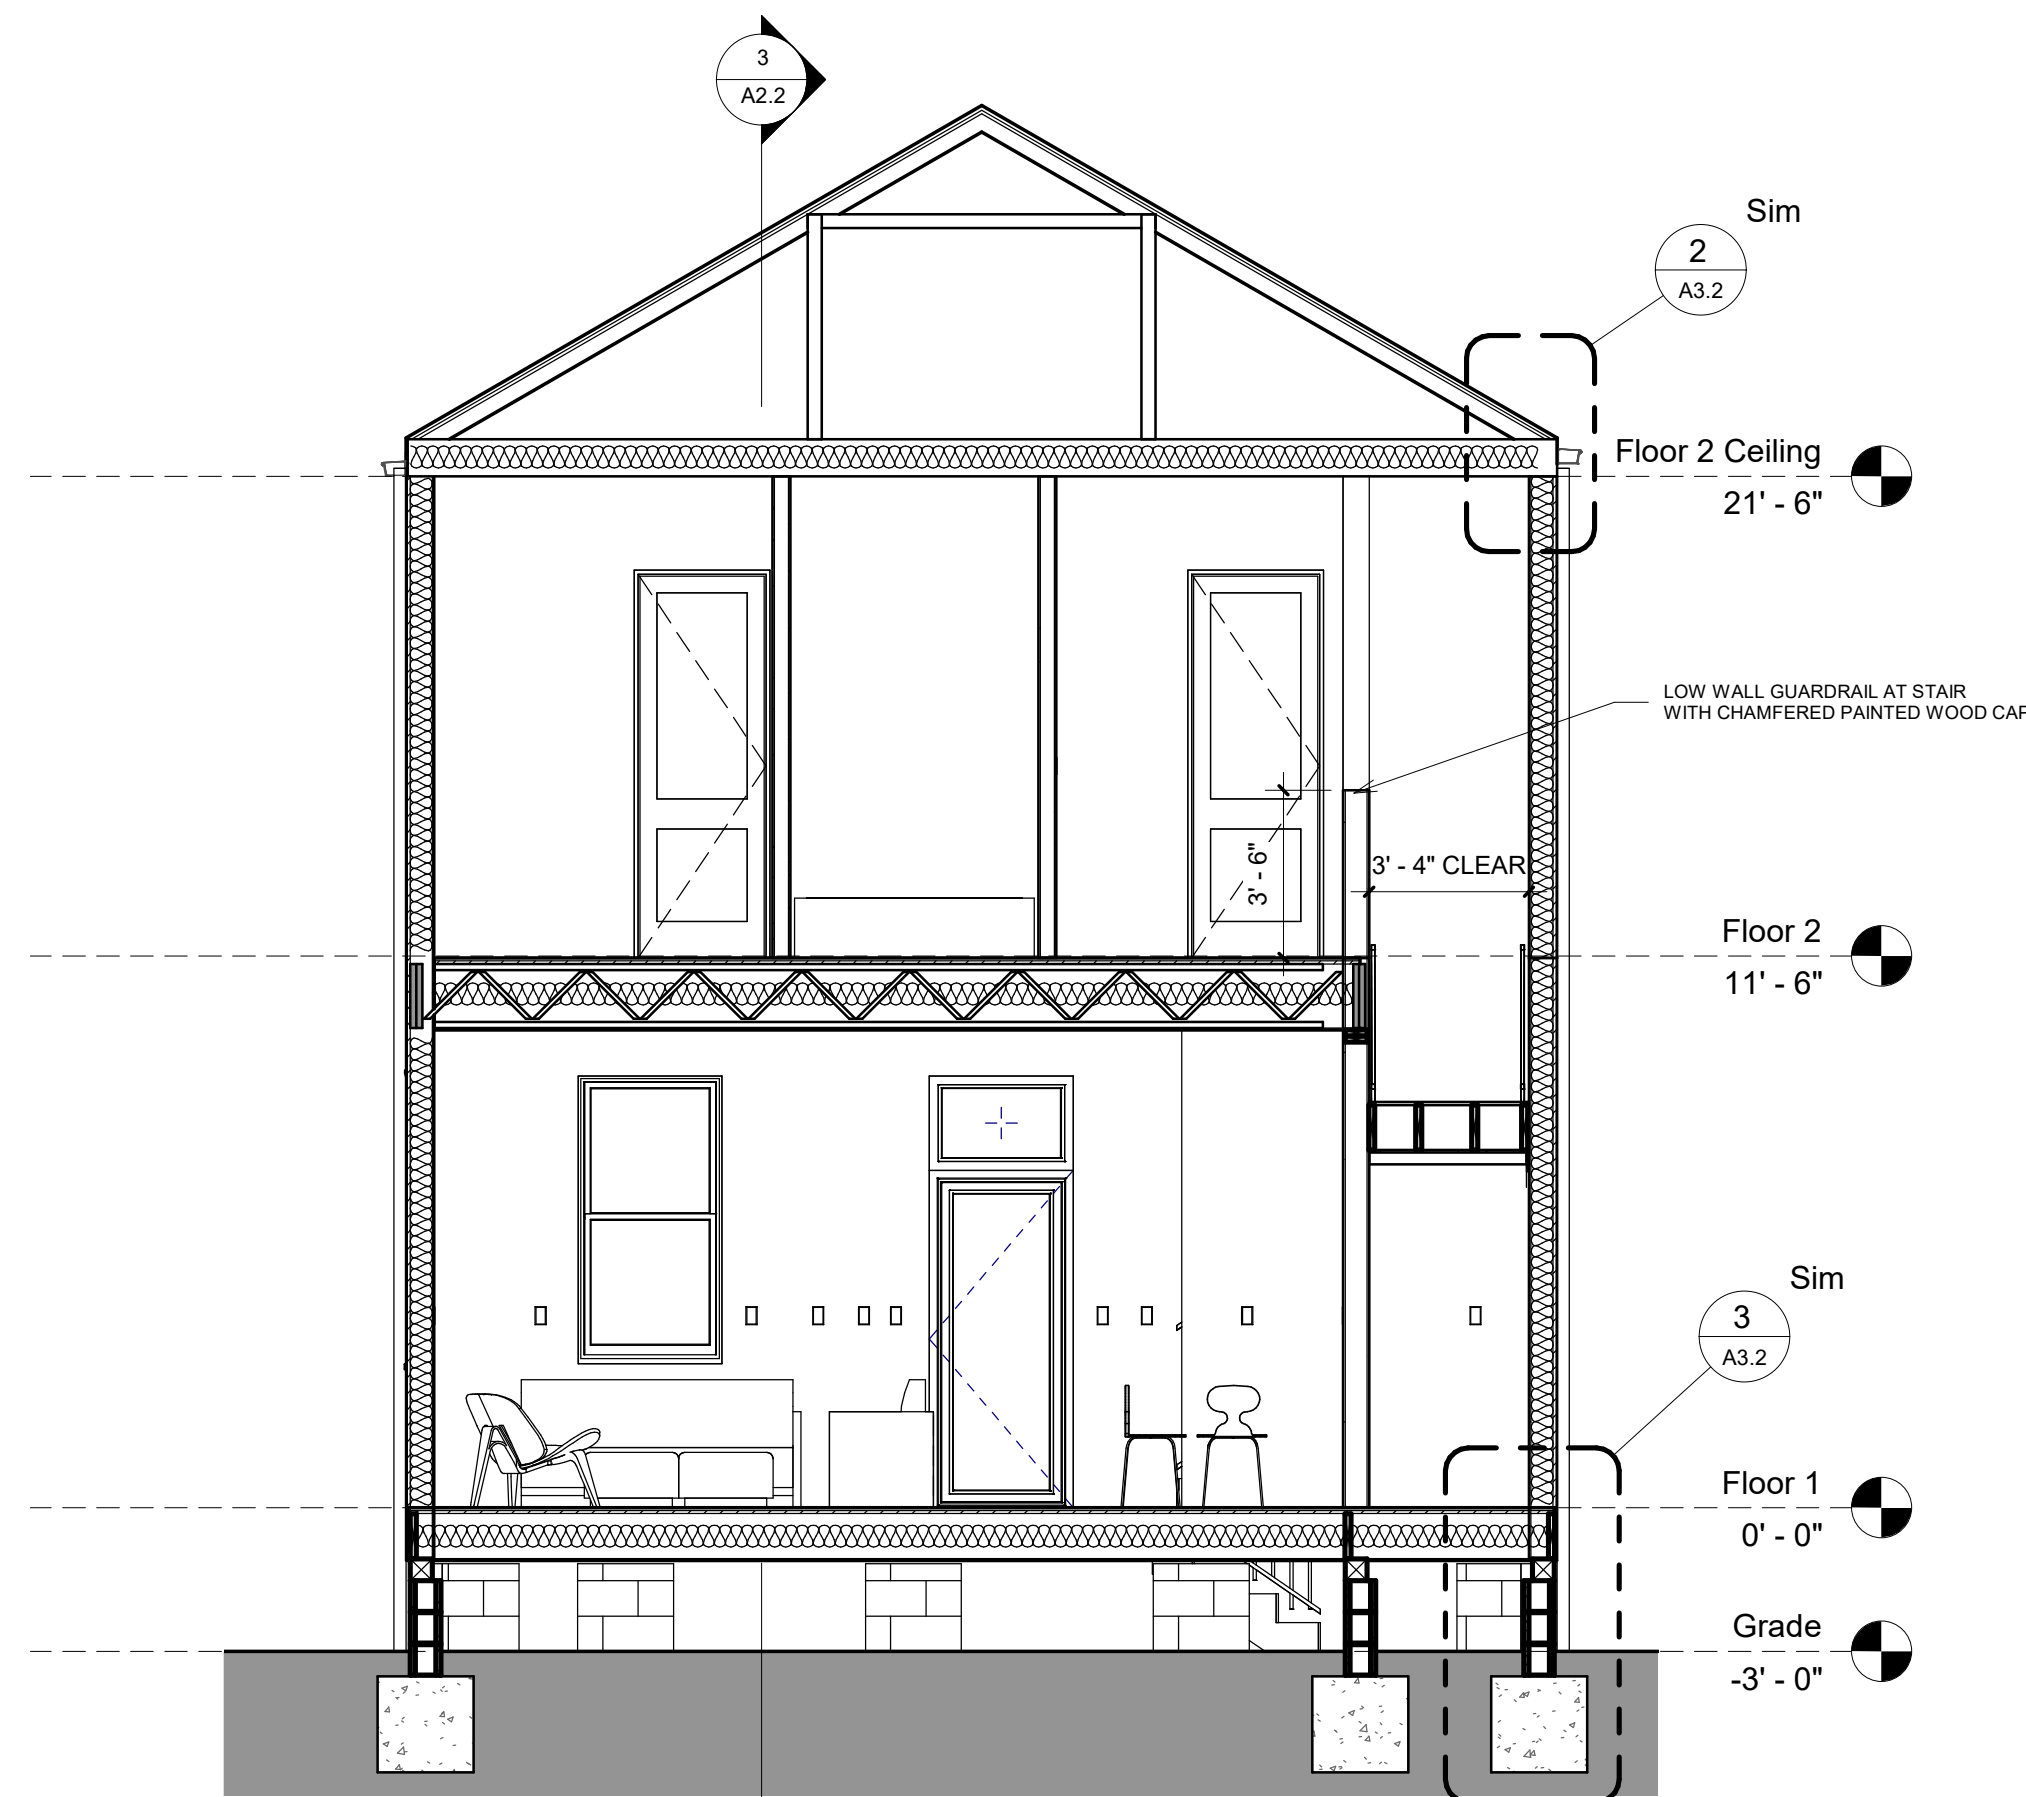


2 Section - Transverse 2
1/4" = 1'-0"

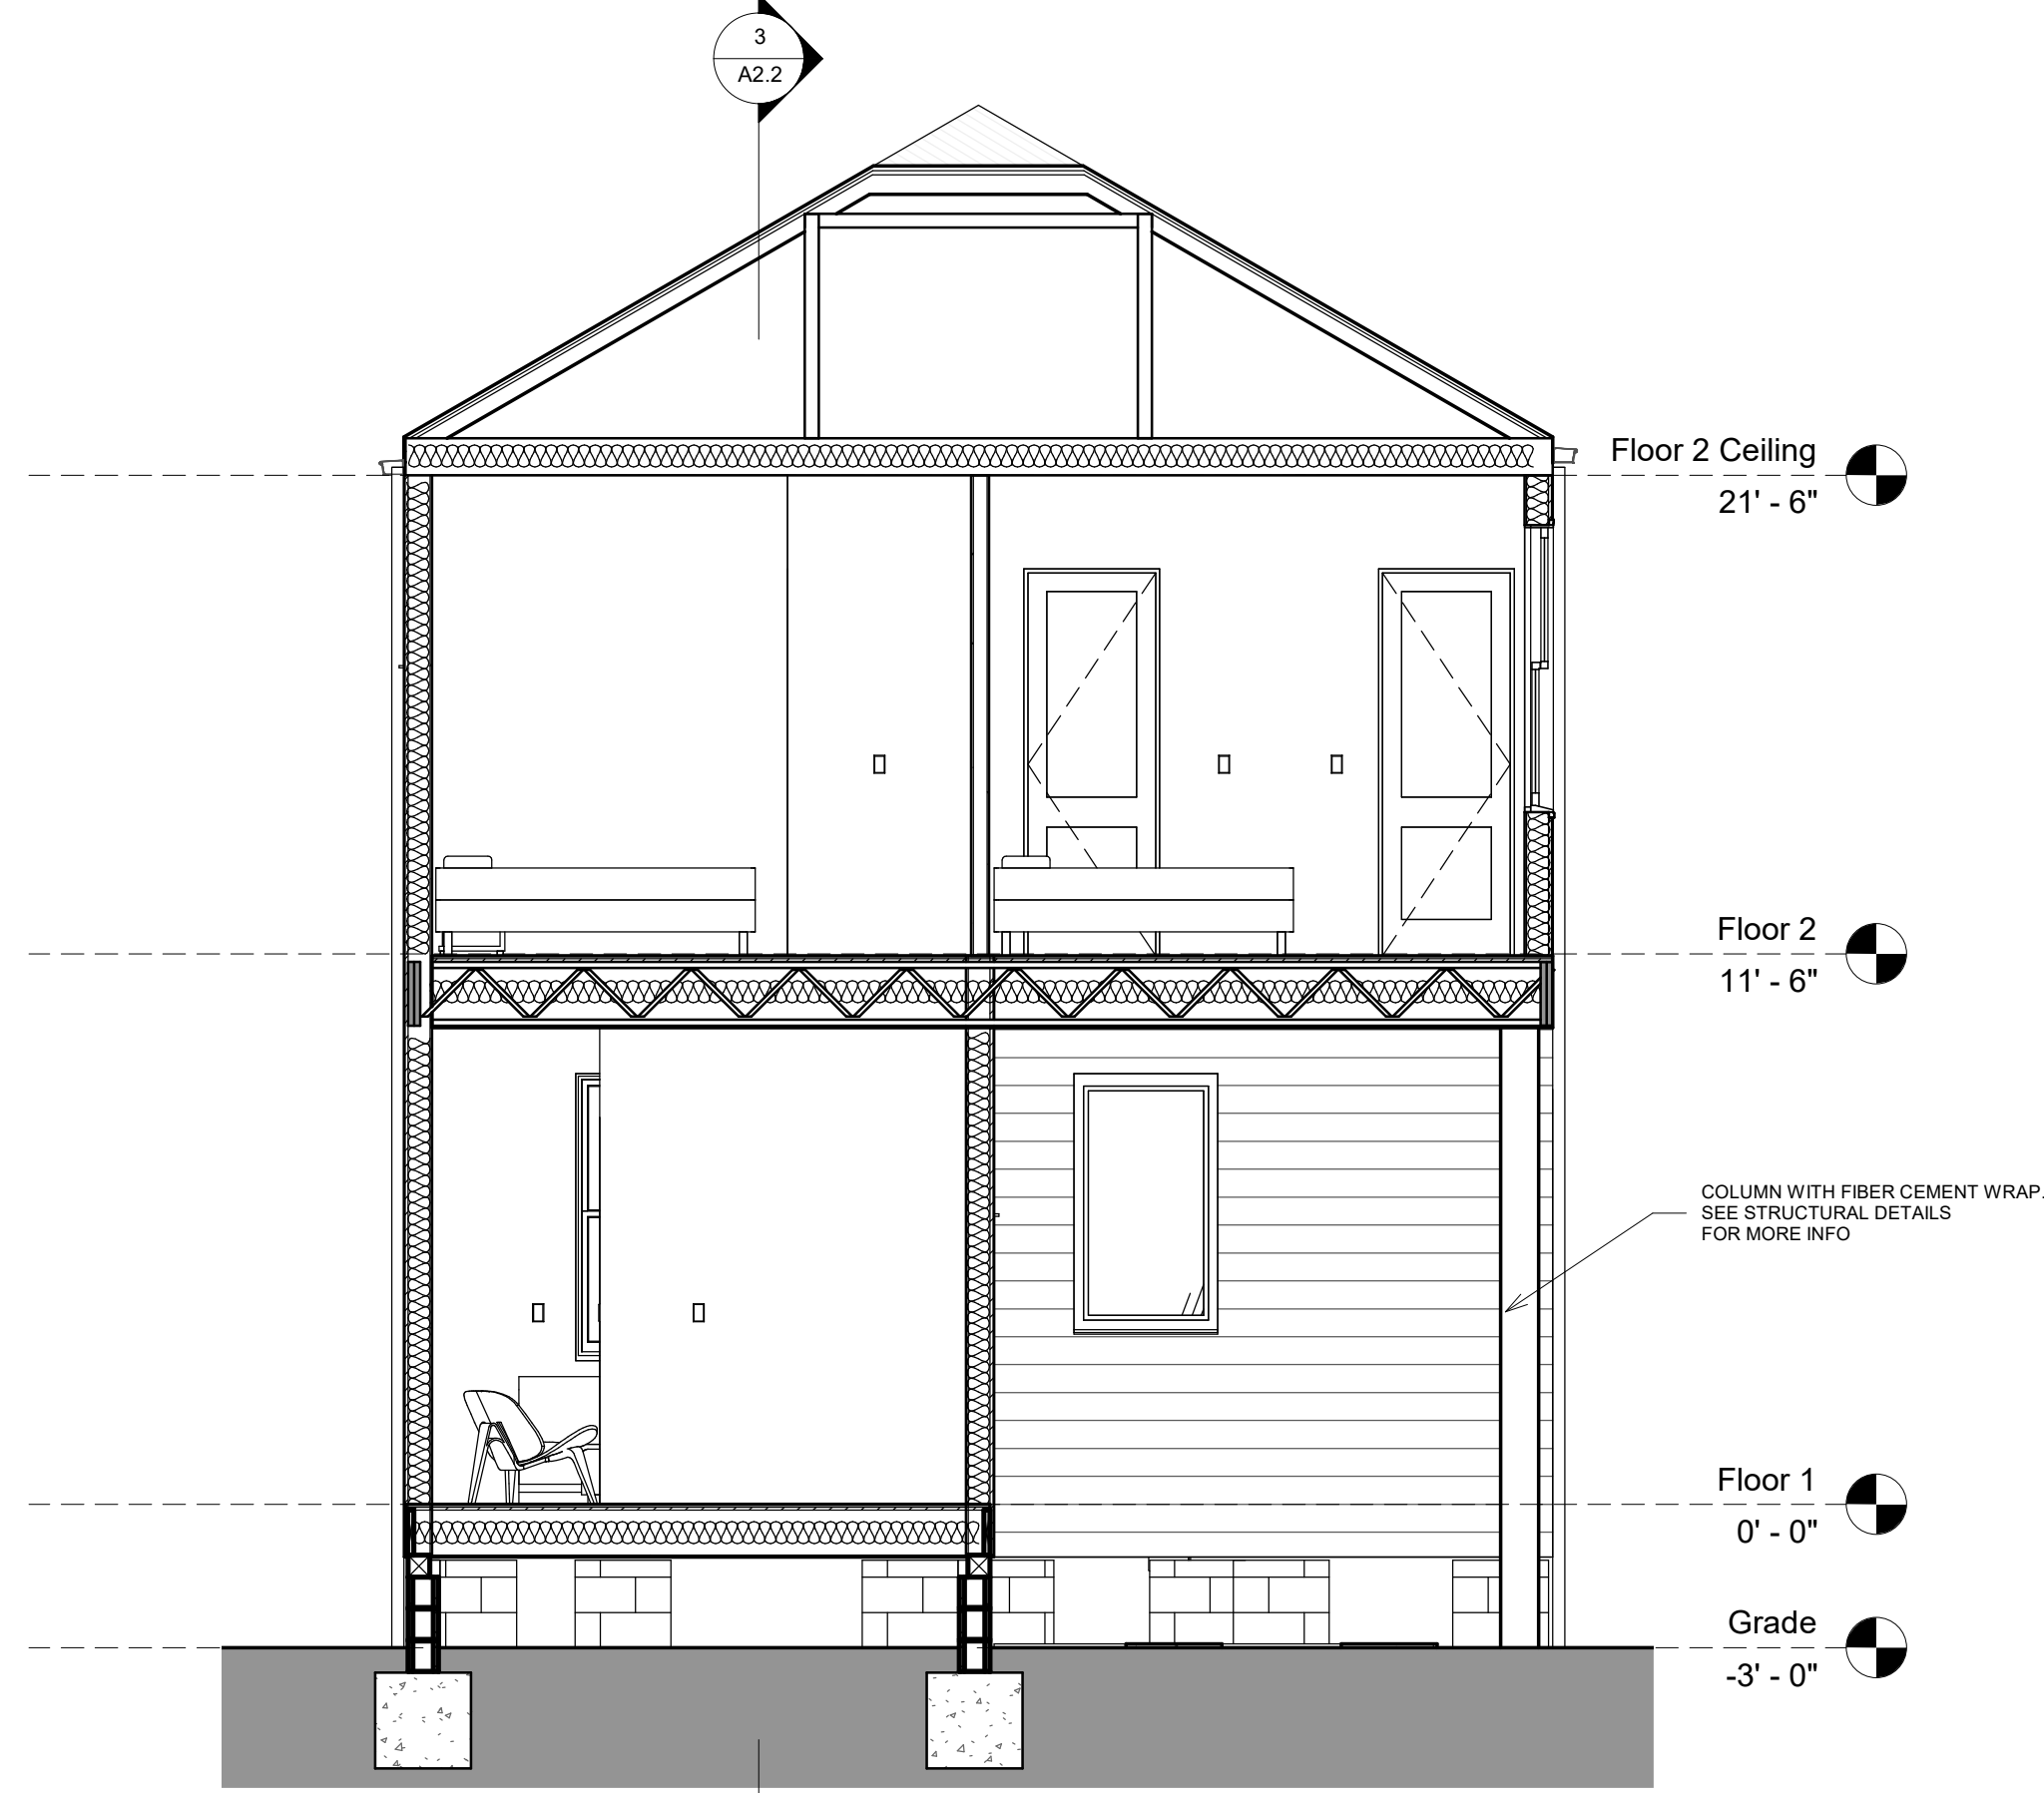


1 Section - Transverse 1
1/4" = 1'-0"




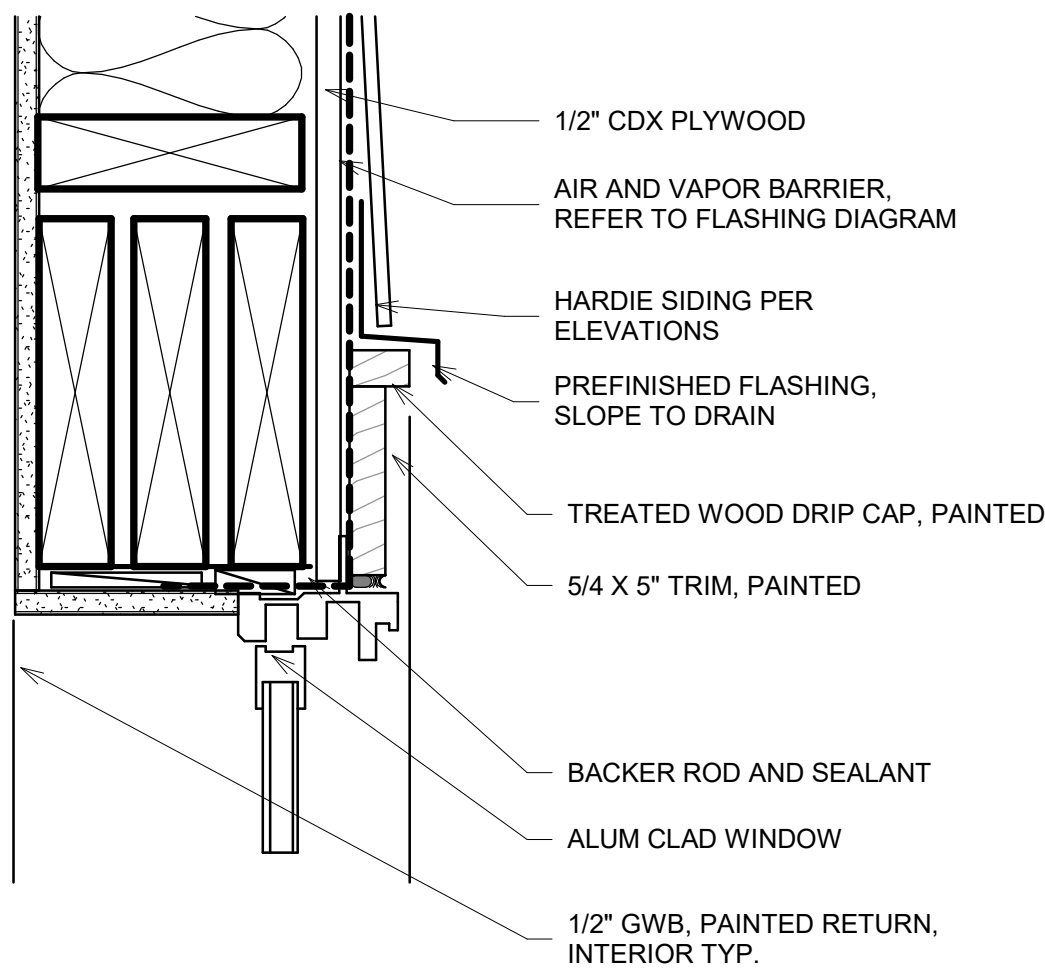

2 WINDOW DETAIL - HEAD
3" = 1'-0"

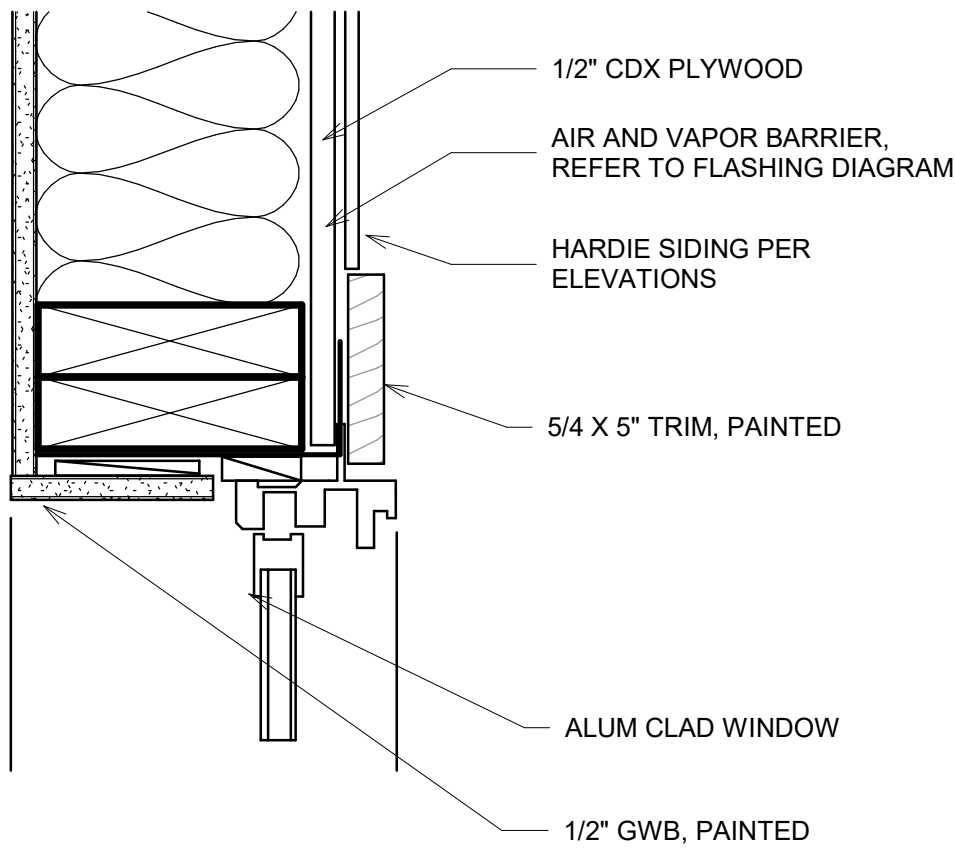

3 WINDOW DETAIL - JAMB
3" = 1'-0"

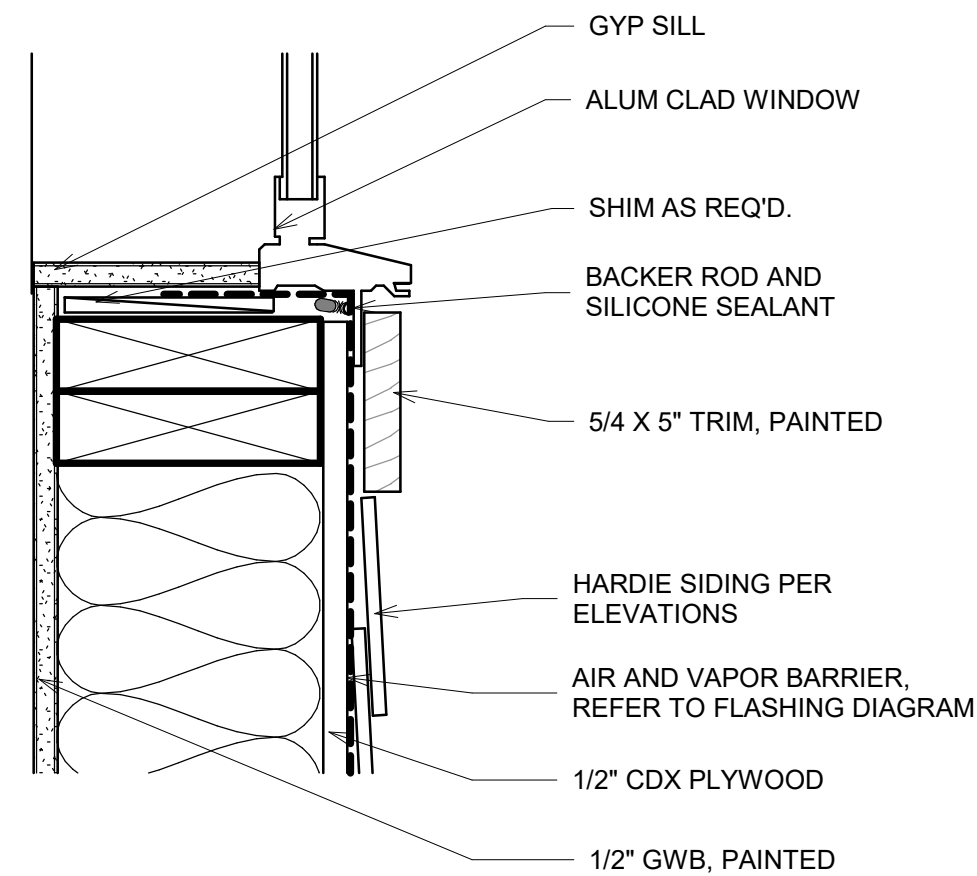

4 WINDOW DETAIL - SILL
3" = 1'-0"




82 Interior
Interior Panel Doors

BASIS OF DESIGN FOR
INTERIOR DOOR



7037 Thermal French &
Sash Doors

BASIS OF DESIGN FOR
EXTERIOR DOOR

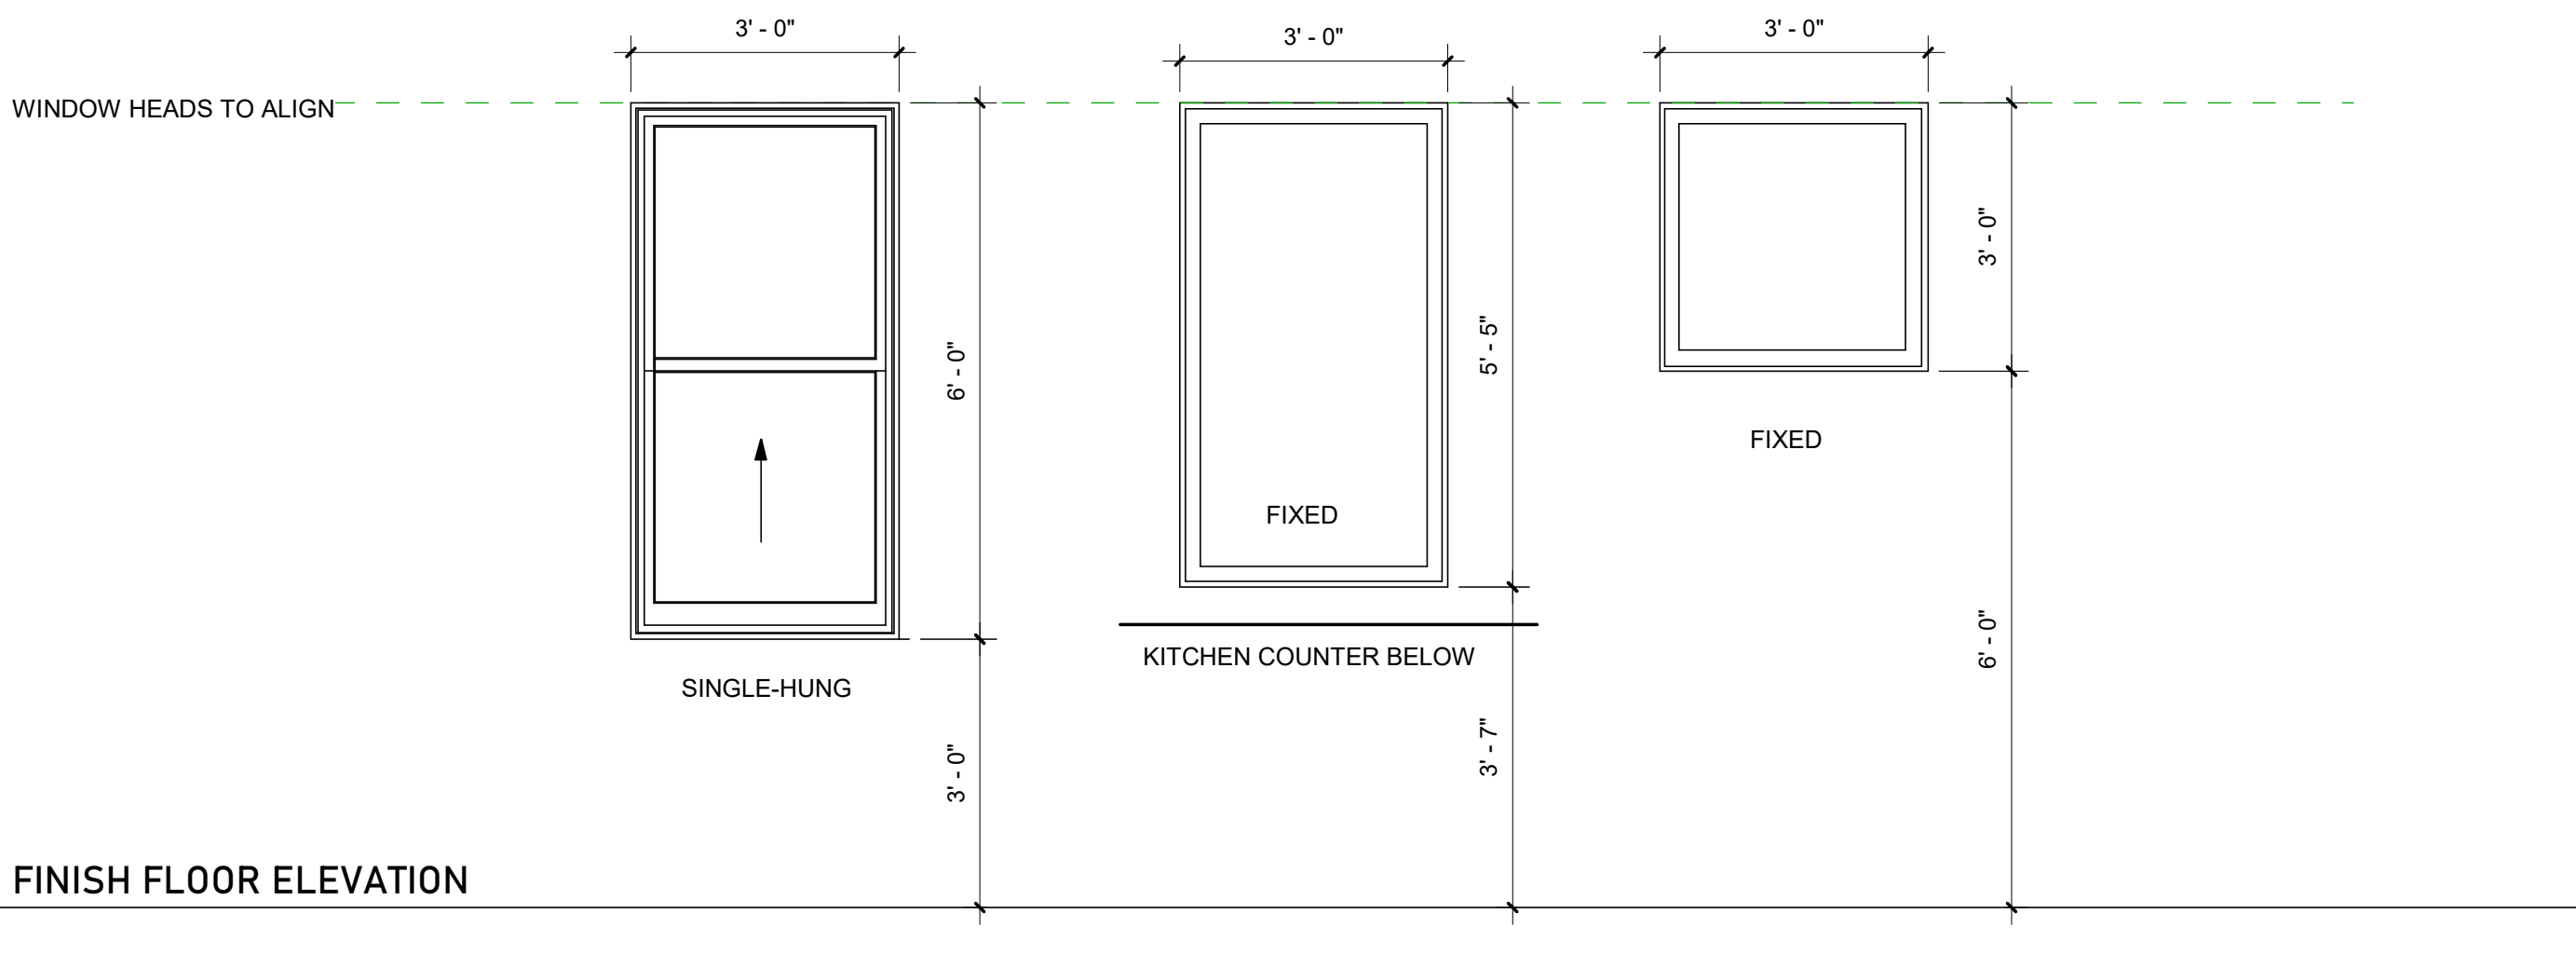

TYPE A
QUANTITY : 11

TYPE B
QUANTITY : 1

TYPE C
QUANTITY : 2

Window Elevations - Urquhart

1/2" = 1'-0" QUANTITIES TO BE VERIFIED BY GC

WINDOW NOTES

BASIS OF DESIGN: PLY-GEM ALUMINUM WINDOWS IN BRONZE FINISH
WINDOWS TO BE SUBMITTED TO HDLC FOR APPROVAL PRIOR TO
PURCHASE

INTERIOR DRYWALL WINDOW RETURNS, TYP.

ALL WINDOW HEADERS TO BE (2) 2X10'S UNLESS NOTED OTHERWISE.
SEE STRUCTURAL.

DOOR NOTES

ALL EXTERIOR DOORS TO BE SUBMITTED FOR HDLC APPROVAL PRIOR
TO PURCHASE.

ALL DOOR HEADERS TO BE (2) 2X10'S UNLESS NOTED OTHERWISE.
SEE STRUCTURAL.

ALL INTERIOR DOOR TRIM TO BE SQUARE EDGE 1X4, U.N.O.

ALL INTERIOR DOORS TO BE FLAT SLAB DOORS , U.N.O.

INTERIOR DOOR HARDWARE : SCHLAGE LATITUDE, MATTE BLACK

INTERIOR DOOR BATHROOMS AND BEDROOMS TO HAVE PRIVACY
HARDWARE. ALL CLOSET DOORS TO HAVE PASSAGE HARDWARE.

INTERIOR HINGES TO BE MATTE BLACK


ALL INTERIOR DOOR TRIM TO BE 1X4, NO MITERED EDGES.

TREME
HOUSE 2

1900 Dumaine St.
New Orleans, LA, 70116


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SHEET TITLE:

Openings

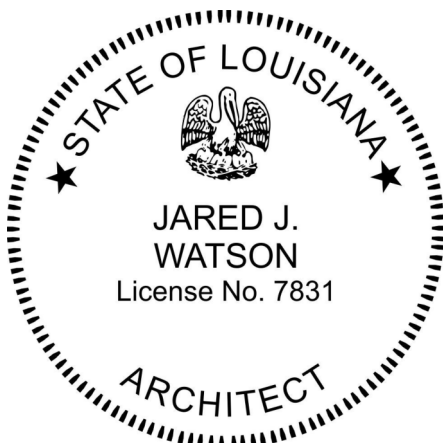
SHEET NUMBER:

A3.1


DATE: FOR PERMIT

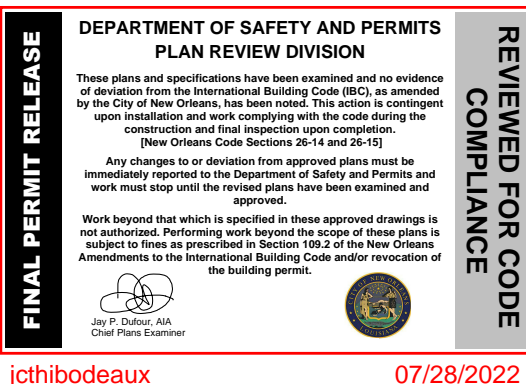SCALE: As indicated




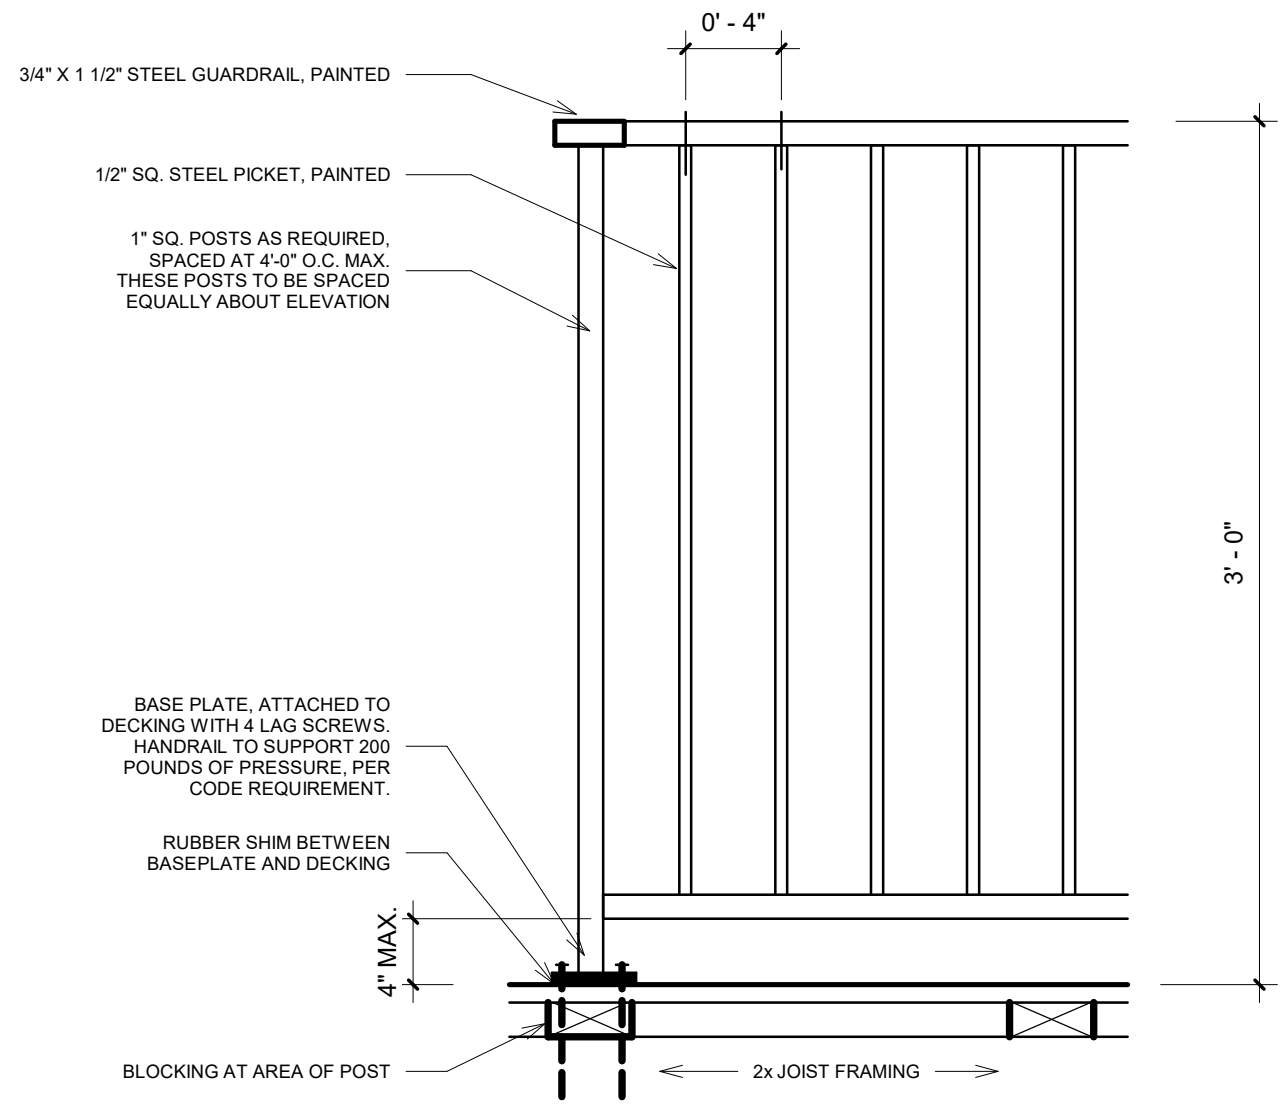


1 TYP. METAL RAILING
1 1/2" = 1'-0"

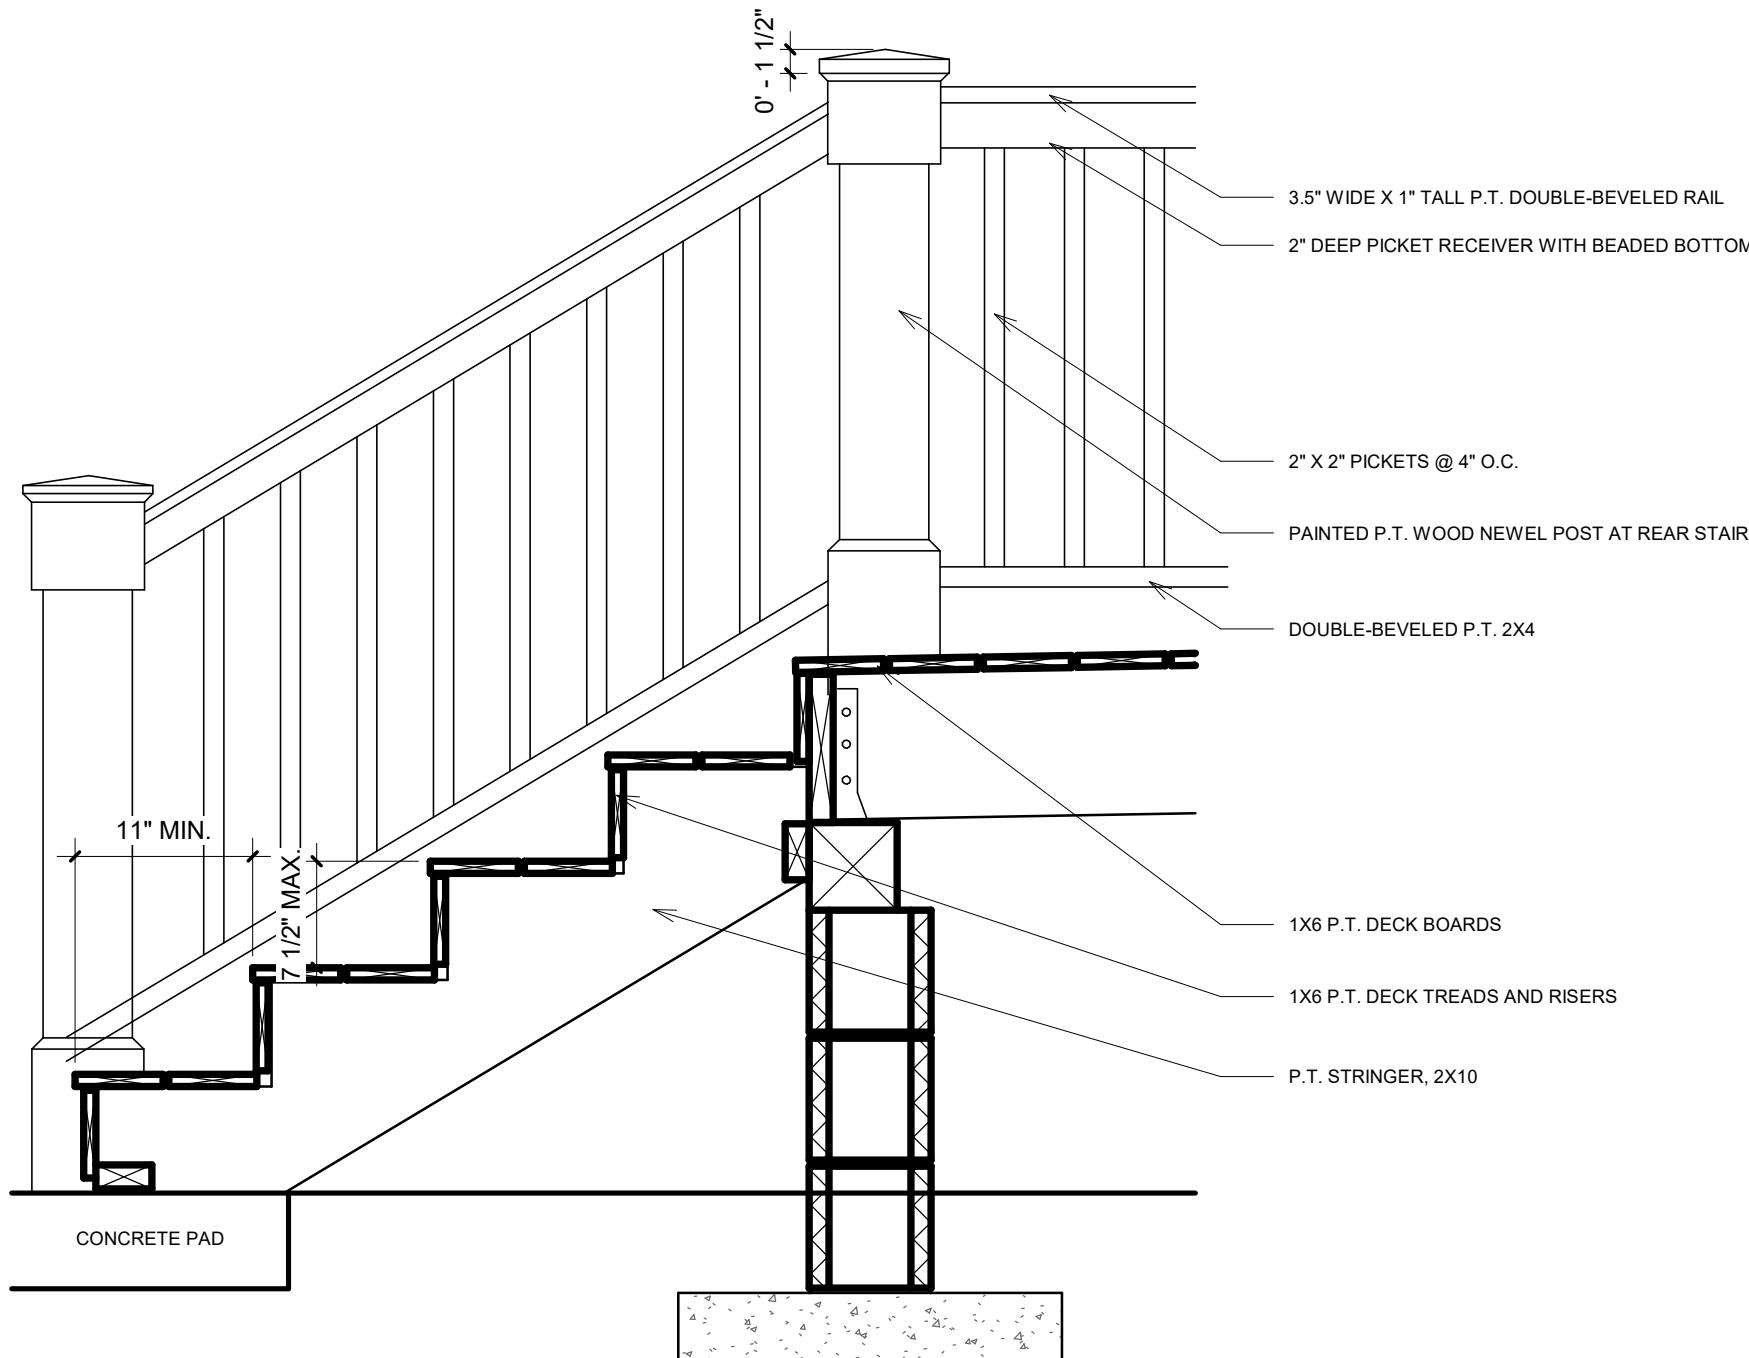


5 REAR DECK WITH RAIL
1" = 1'-0"

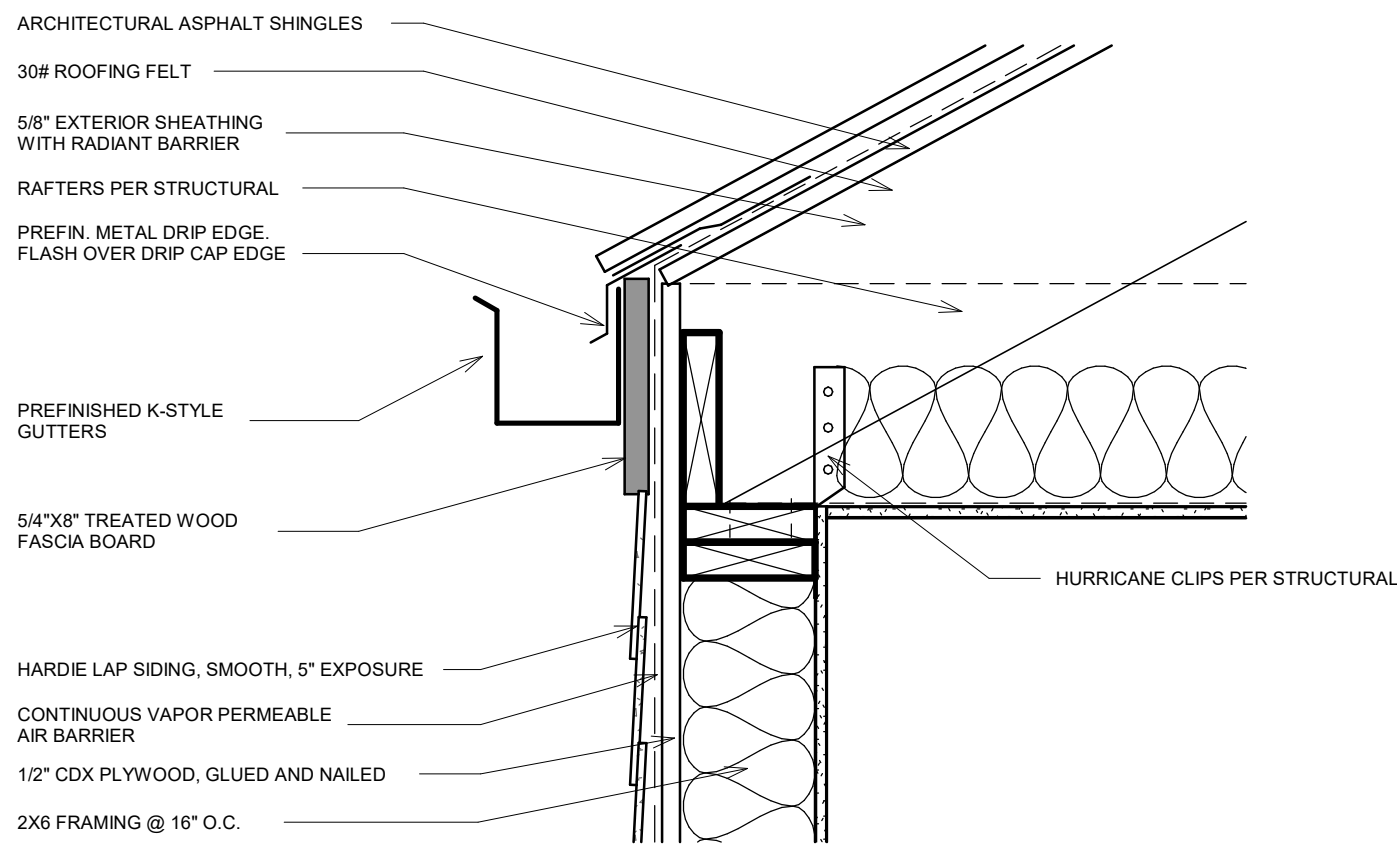


2 ROOF DETAIL
1 1/2" = 1'-0"

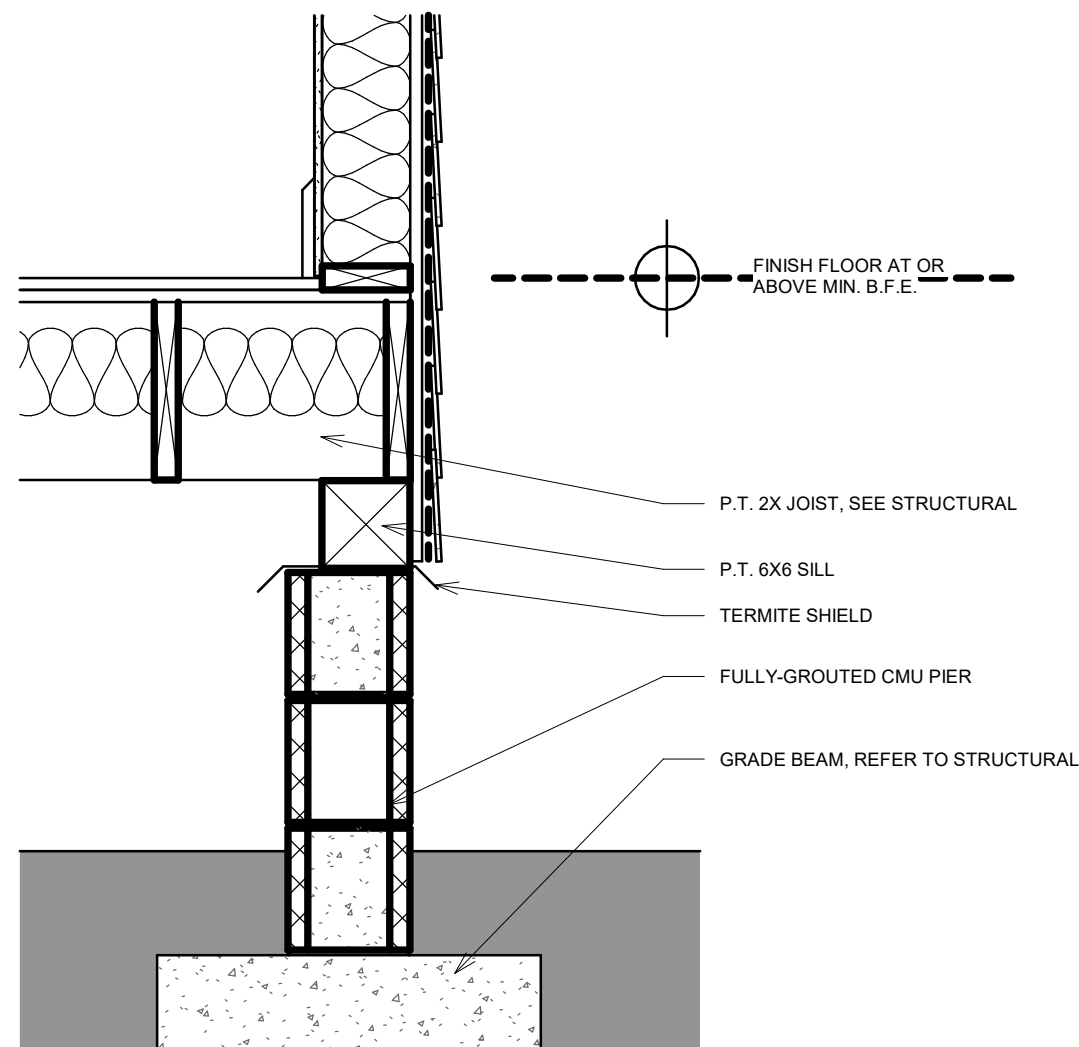

3 TYPICAL SILL
1" = 1'-0"

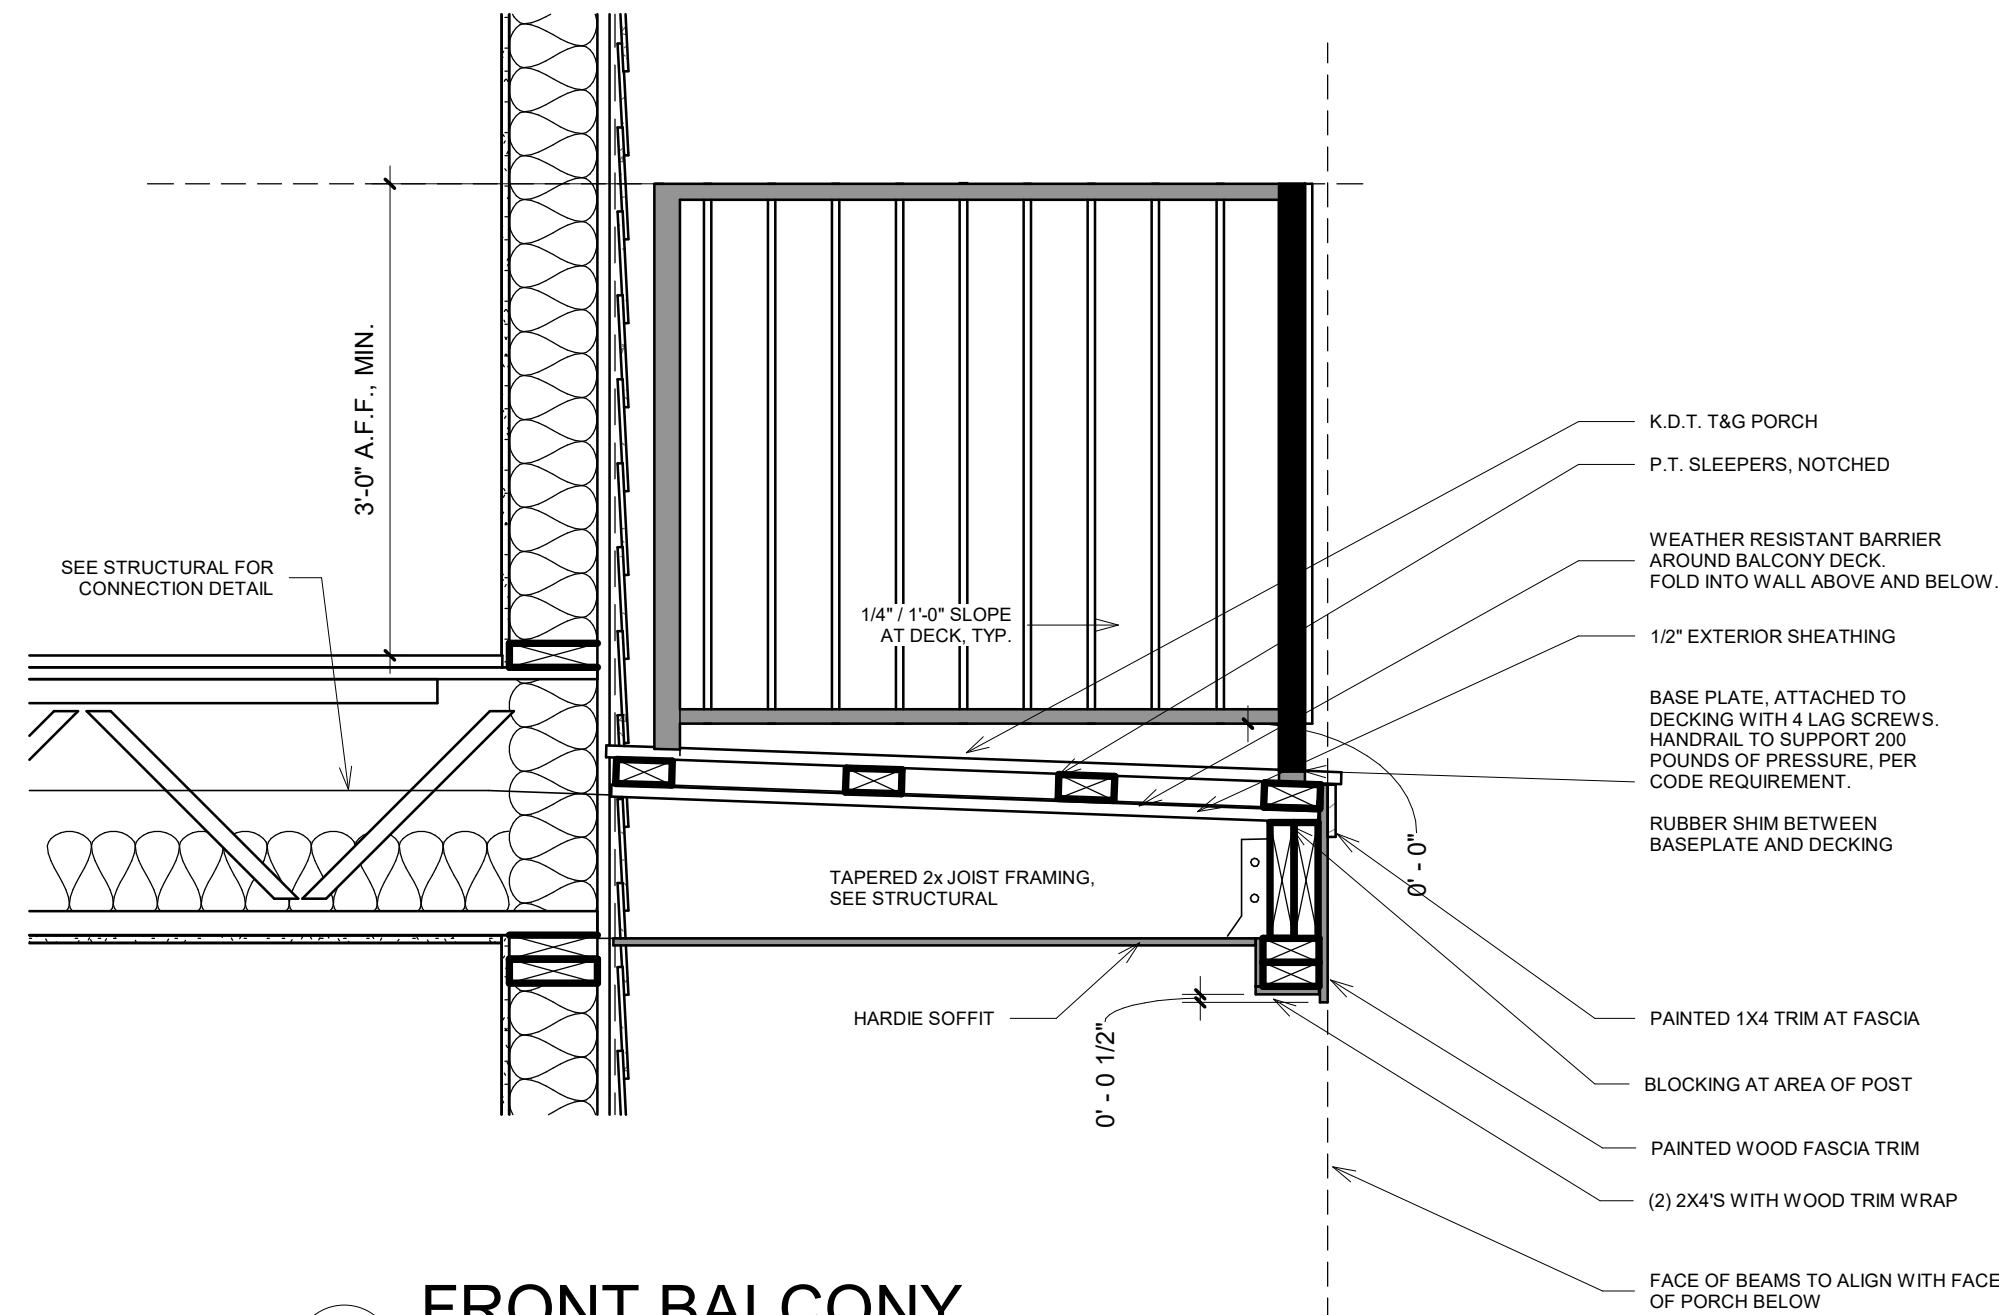

4 FRONT BALCONY
1" = 1'-0"

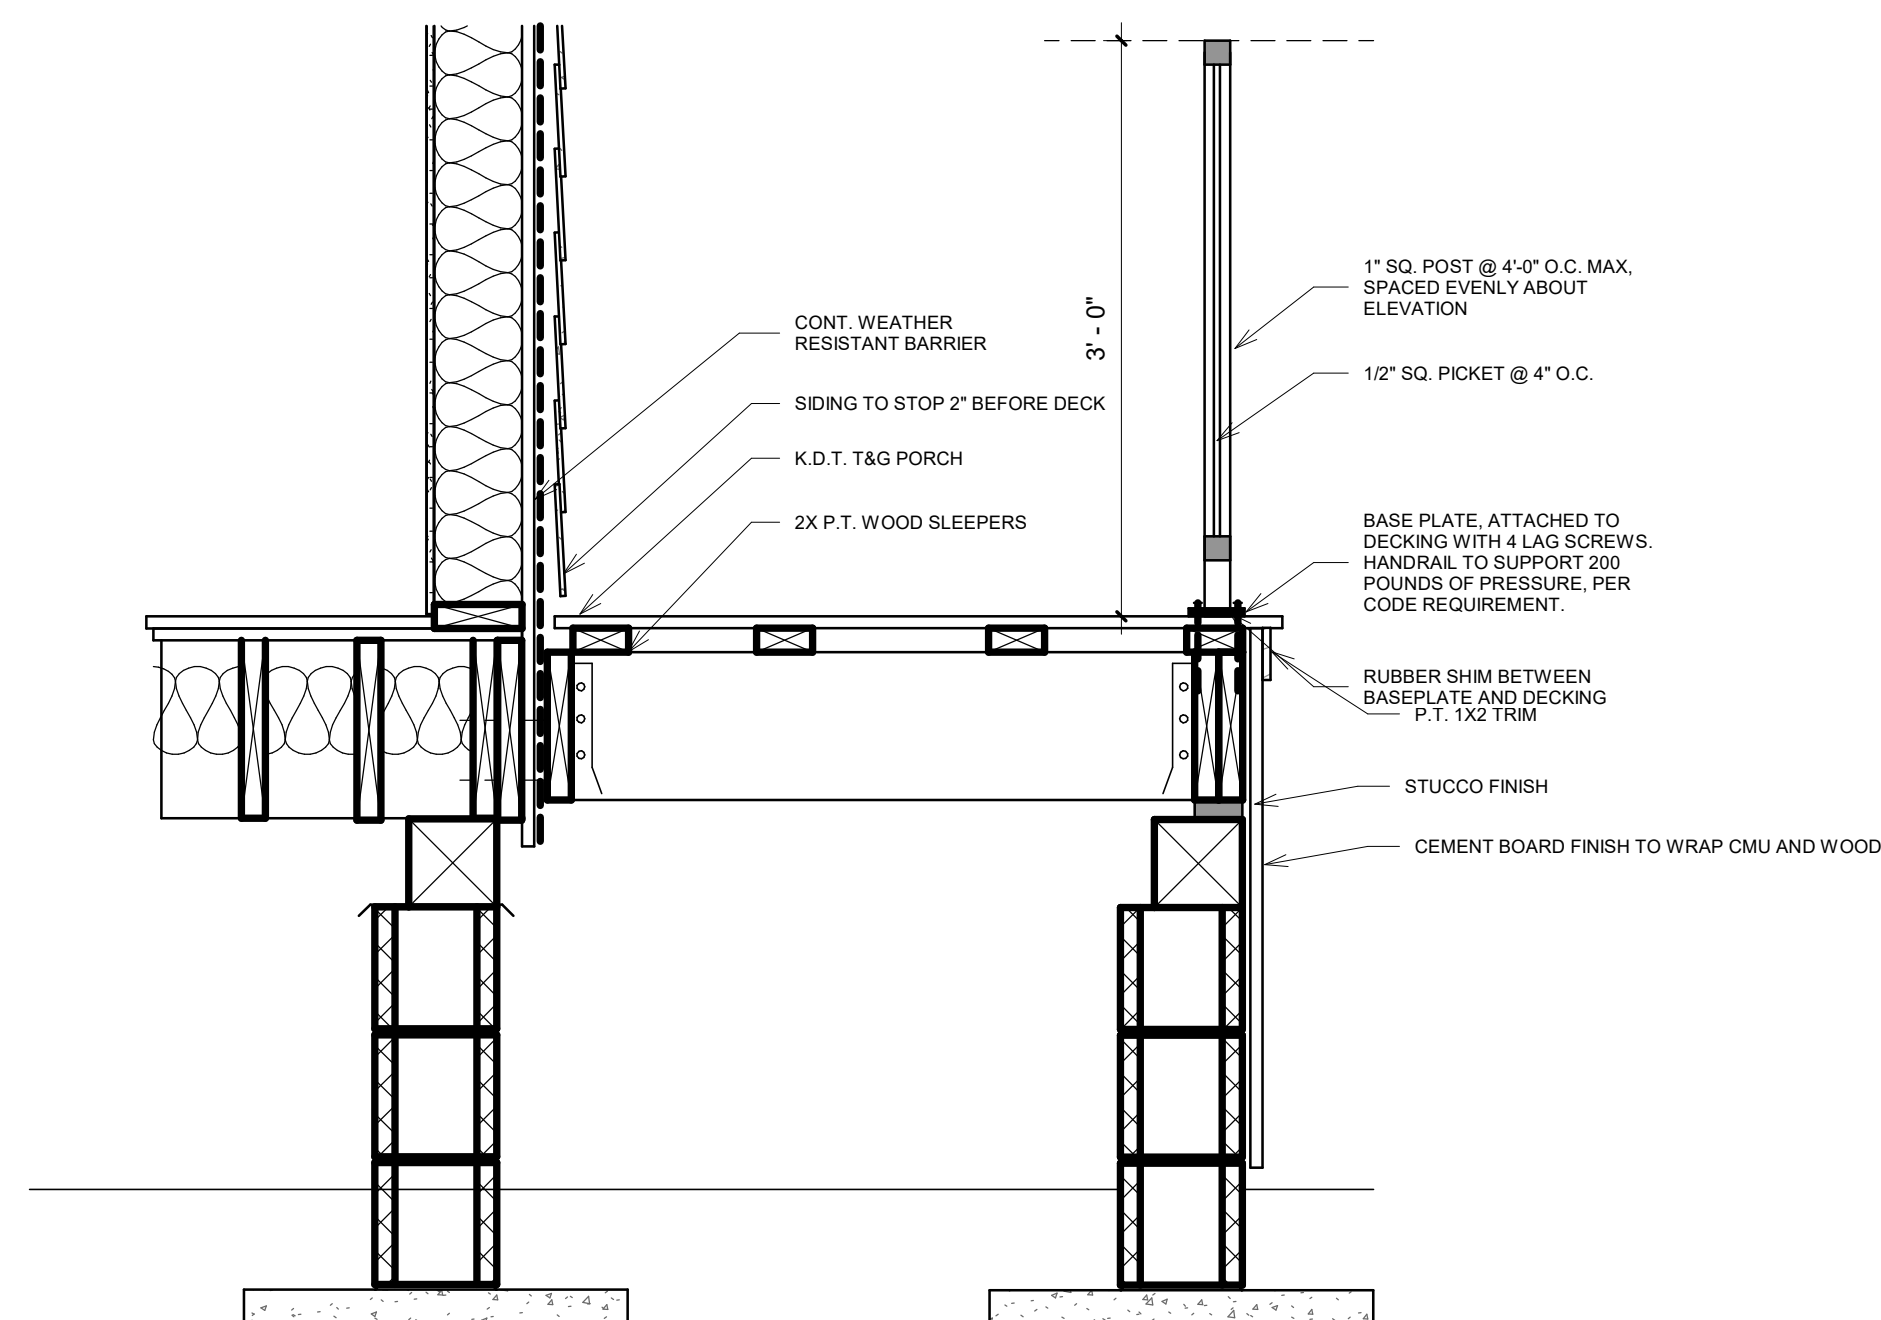


6 DETAIL AT FRONT PORCH
1" = 1'-0"

TREME HOUSE 2

1900 Dumaine St.
New Orleans, LA, 70116


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ISSUANCE:

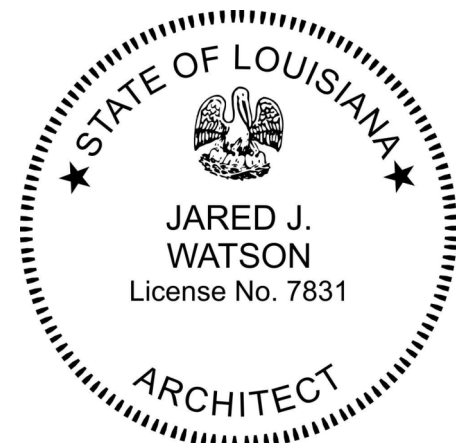

SHEET TITLE:

Details

SHEET NUMBER:

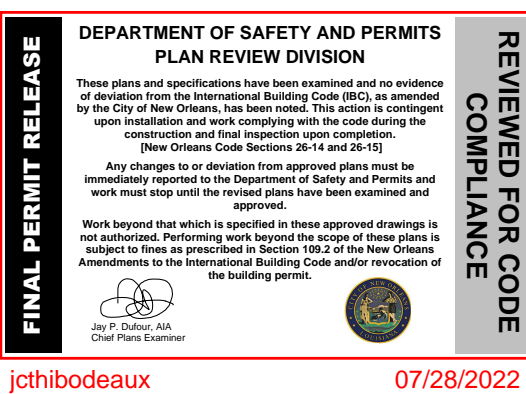A3.2

DATE: FOR PERMIT

SCALE: As indicated




TREME
HOUSE 2

1900 Dumaine St.
New Orleans, LA, 70116


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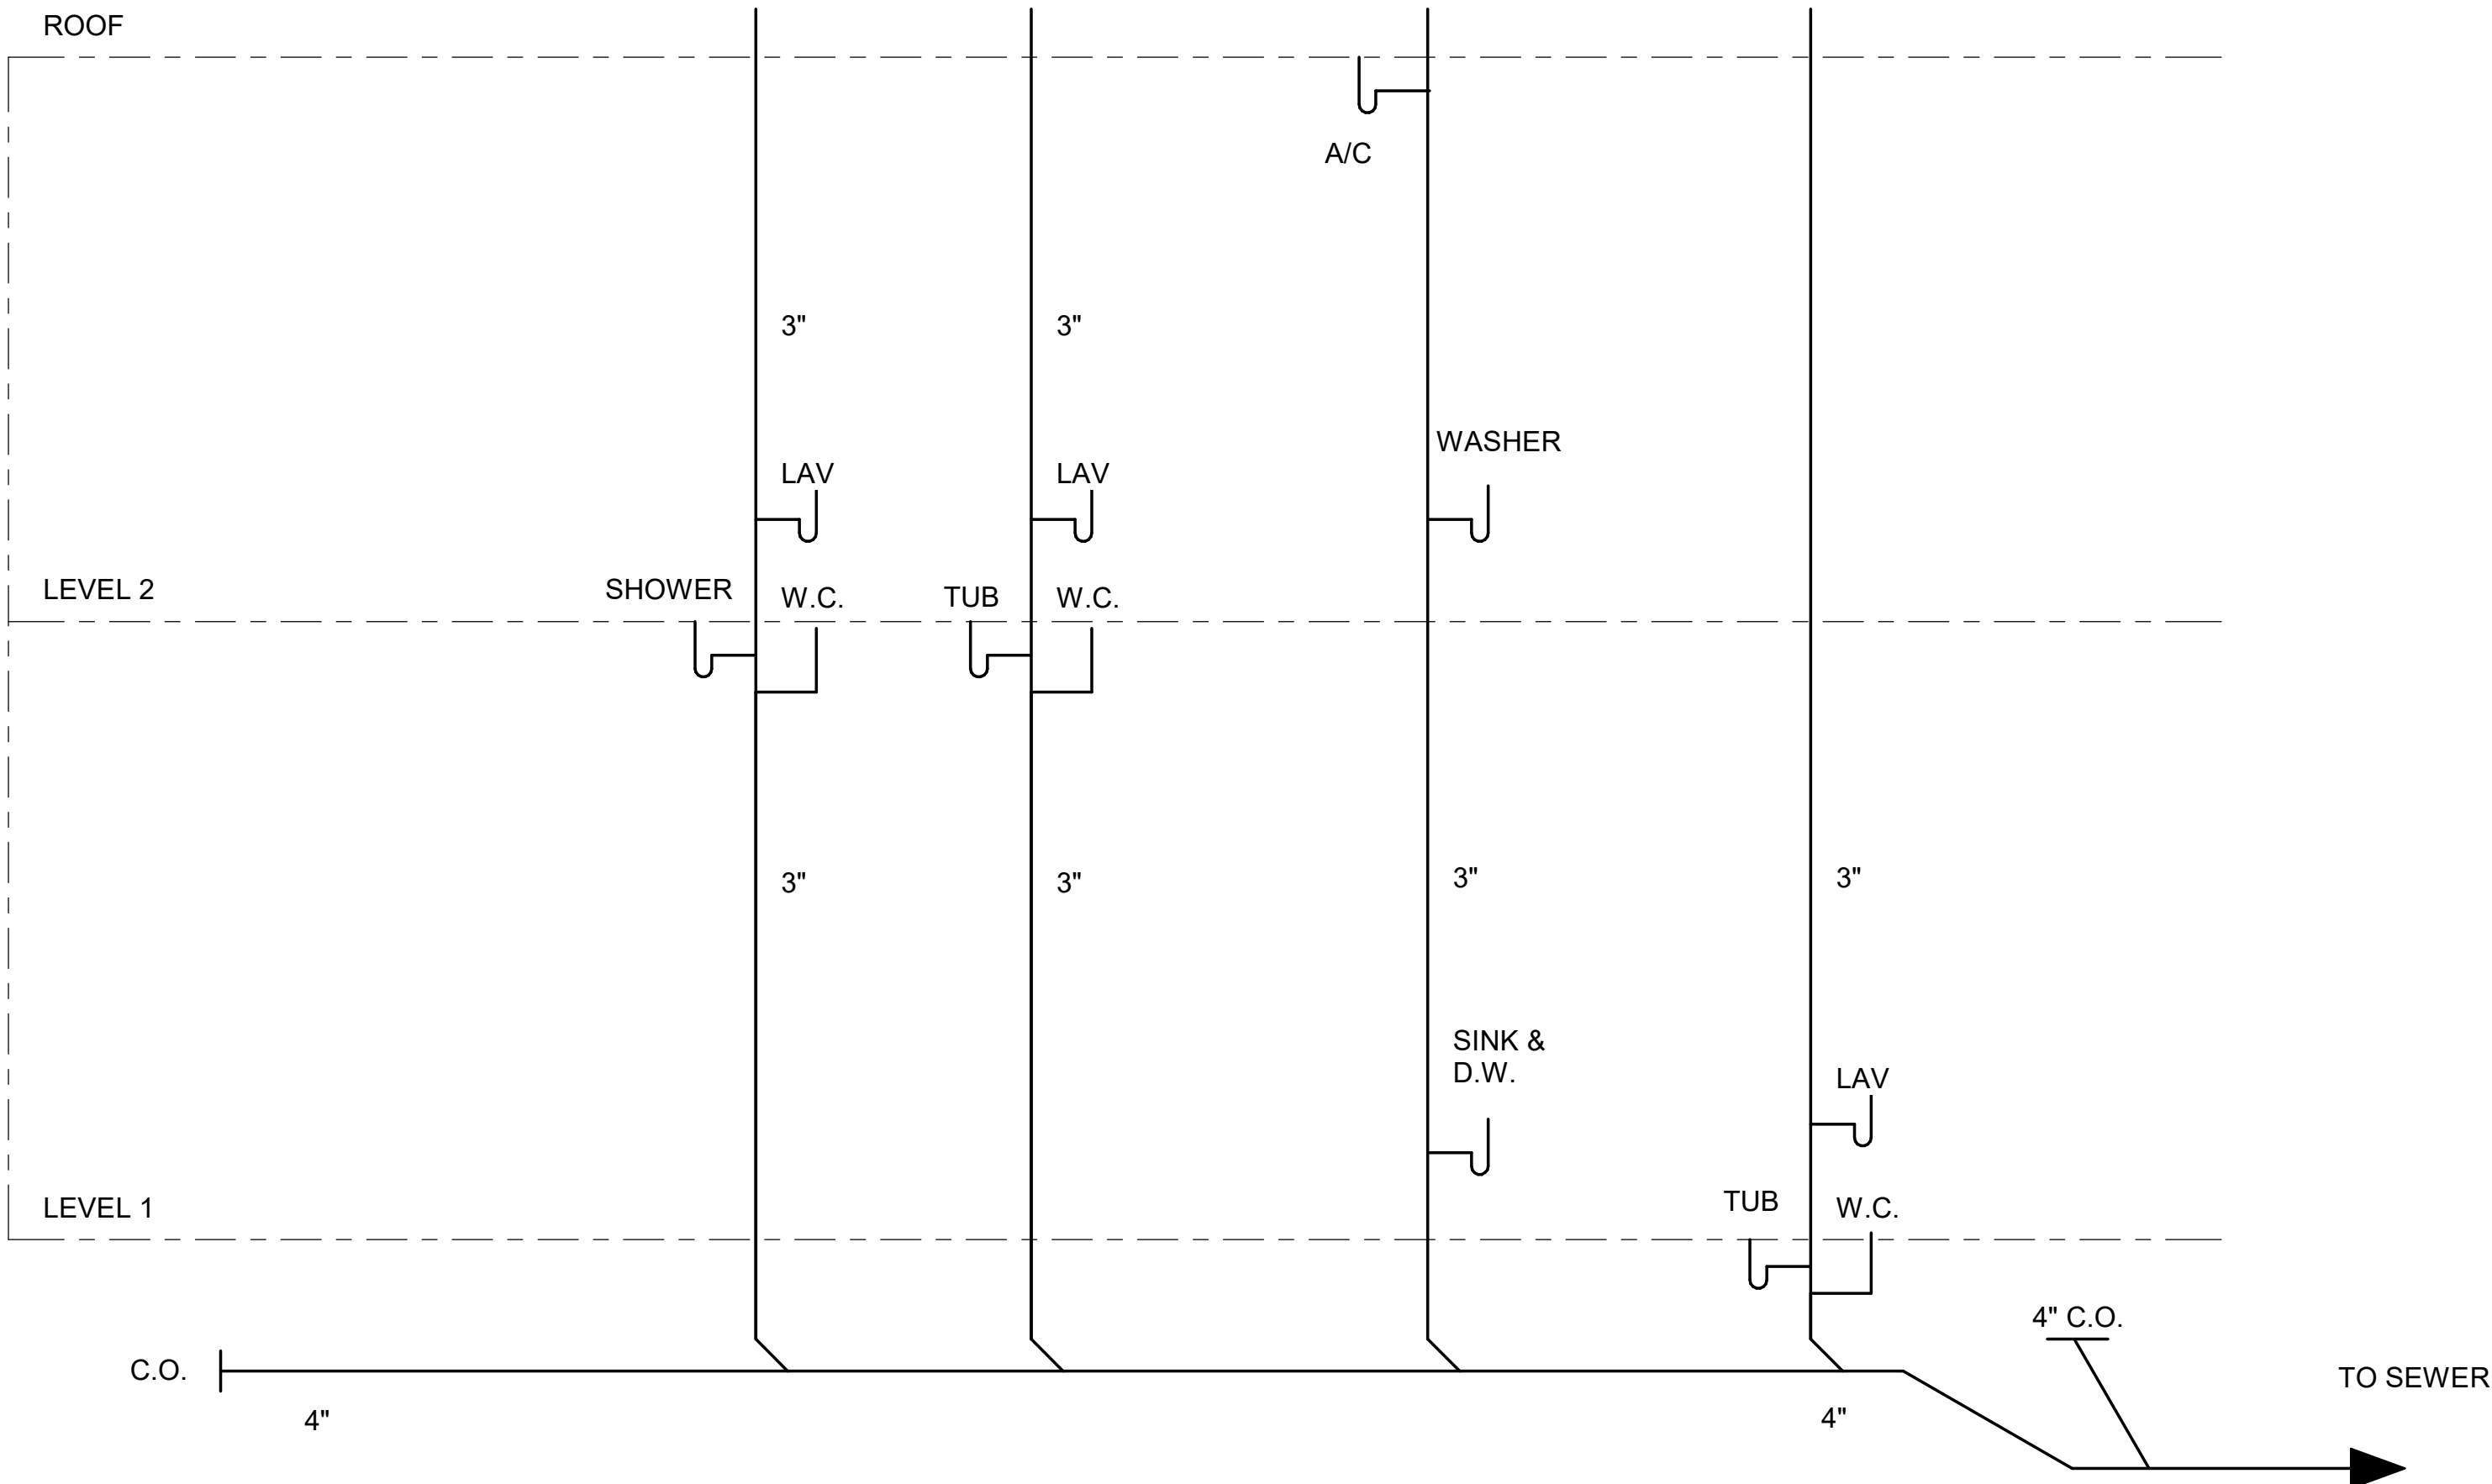
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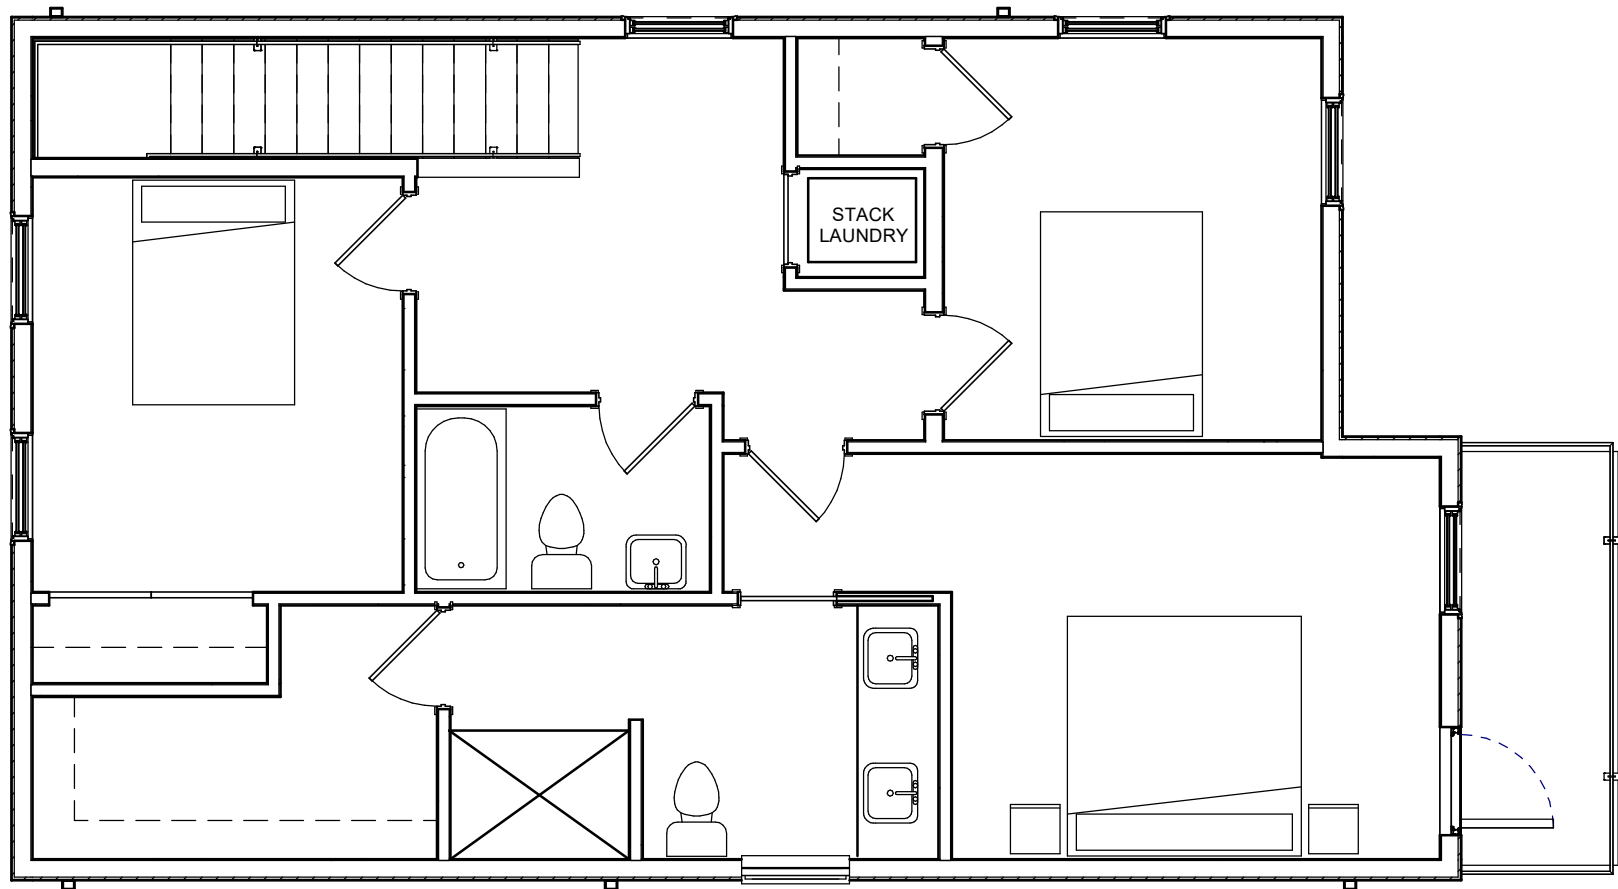
Plumbing
Riser
Diagram
A4.1

DATE: FOR PERMIT

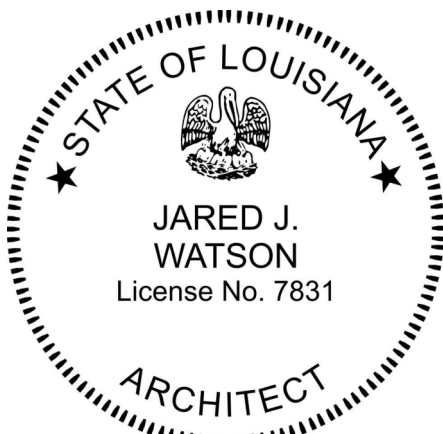
SCALE: As indicated



1 Plumbing Riser Diagram
1/2" = 1'-0"

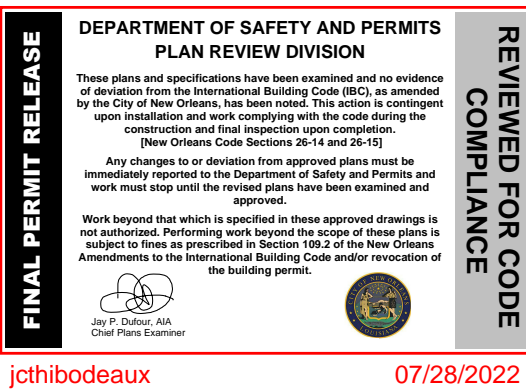

3 Level 2
3/16" = 1'-0"

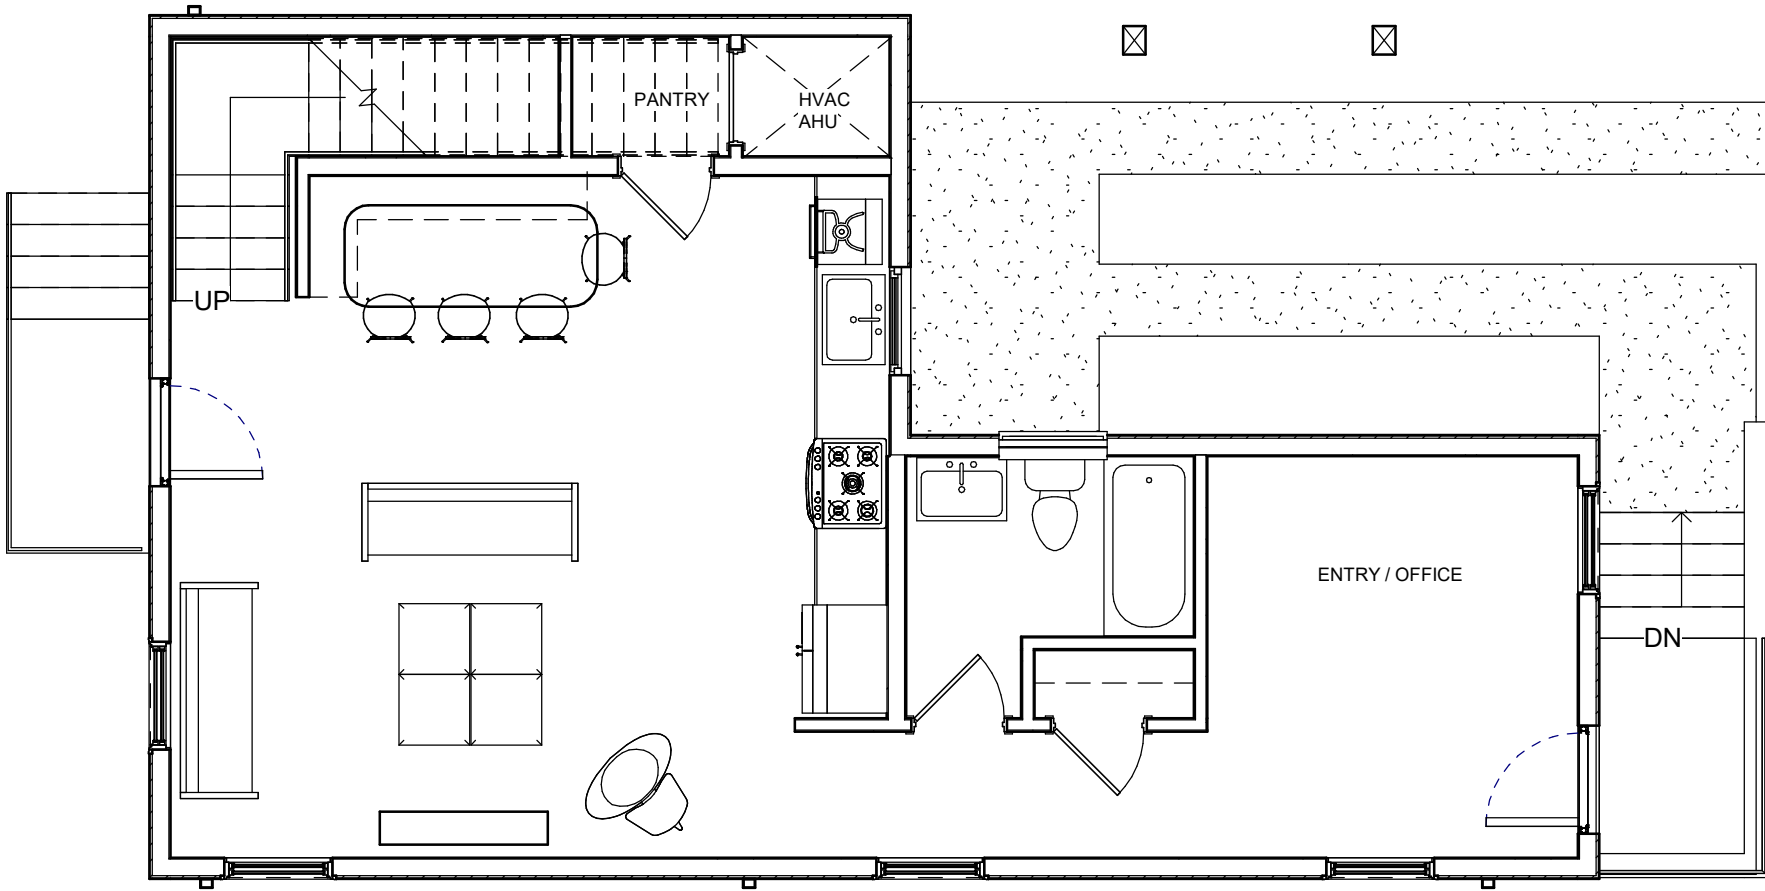

2 Level 1
3/16" = 1'-0"

