


WIND BORNE DEBRIS PROTECTION

WINDOWS IN BUILDING LOCATED IN WIND BORNE DEBRIS REGIONS SHALL HAVE GLAZED OPENINGS PROTECTED FROM WIND BORNE DEBRIS. WOOD STRUCTURAL PANELS WITH A MIN. THICKNESS OF 1/2" AND A MAX. SPAN OF 8 FEET SHALL BE PERMITTED FOR OPENING PROTECTION IN ONE AND TWO STORY BUILDINGS. PANELS SHALL BE PRECUT TO COVER THE GLAZED OPENINGS WITH ATTACHMENT HARDWARE PROVIDED.

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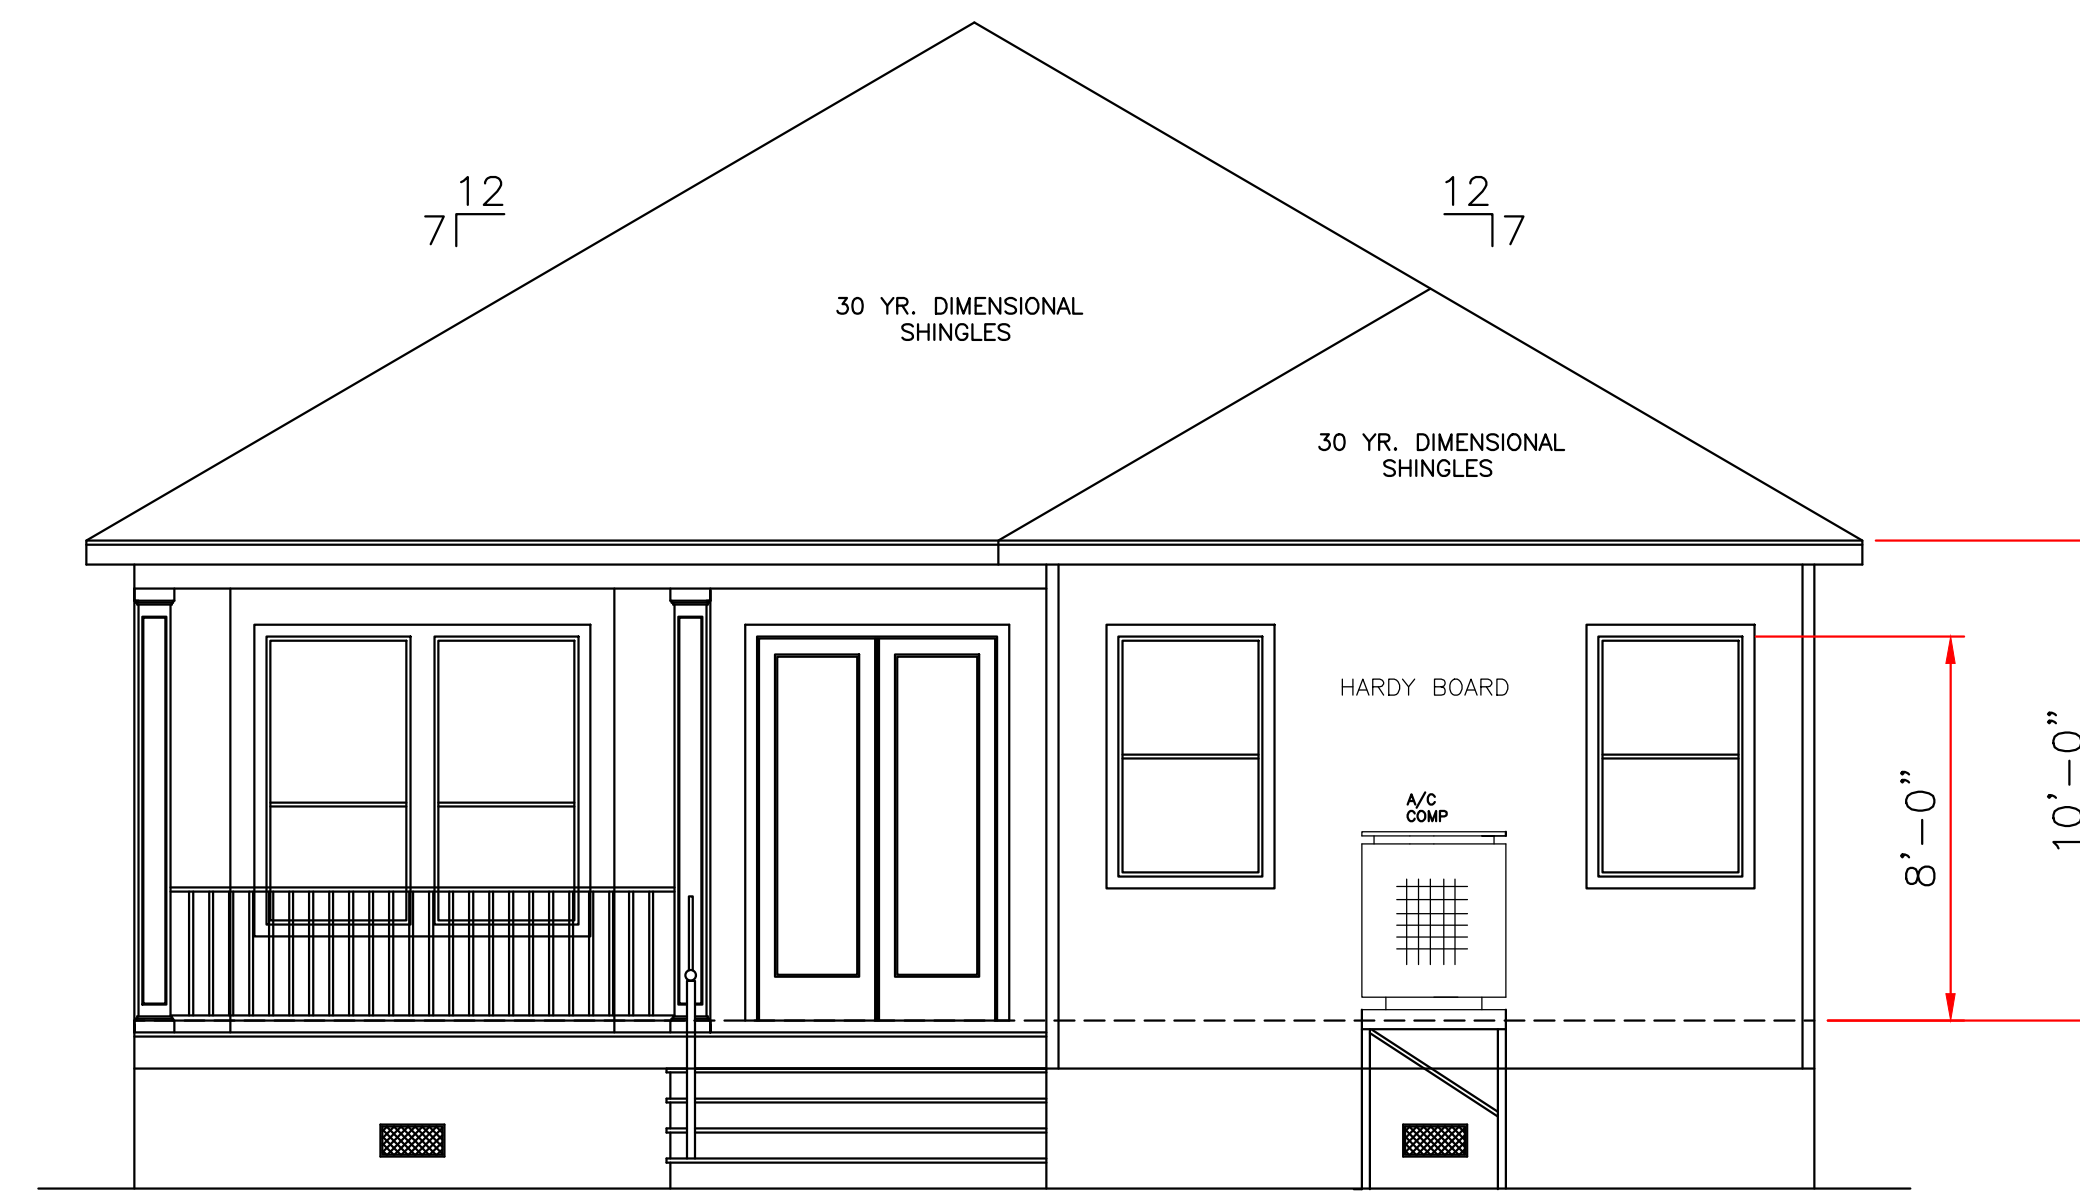
WIND SPEED 130 MPH.

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2. WOOD FRAME CONSTRUCTION MANUAL FOR ONE AND TWO FAMILY DWELLINGS. (WFCM).
3. INTERNATIONAL CODE COUNCIL (ICC) STANDARD FOR RESIDENTIAL CONSTRUCTION IN HIGH WIND REGIONS (ICC600).

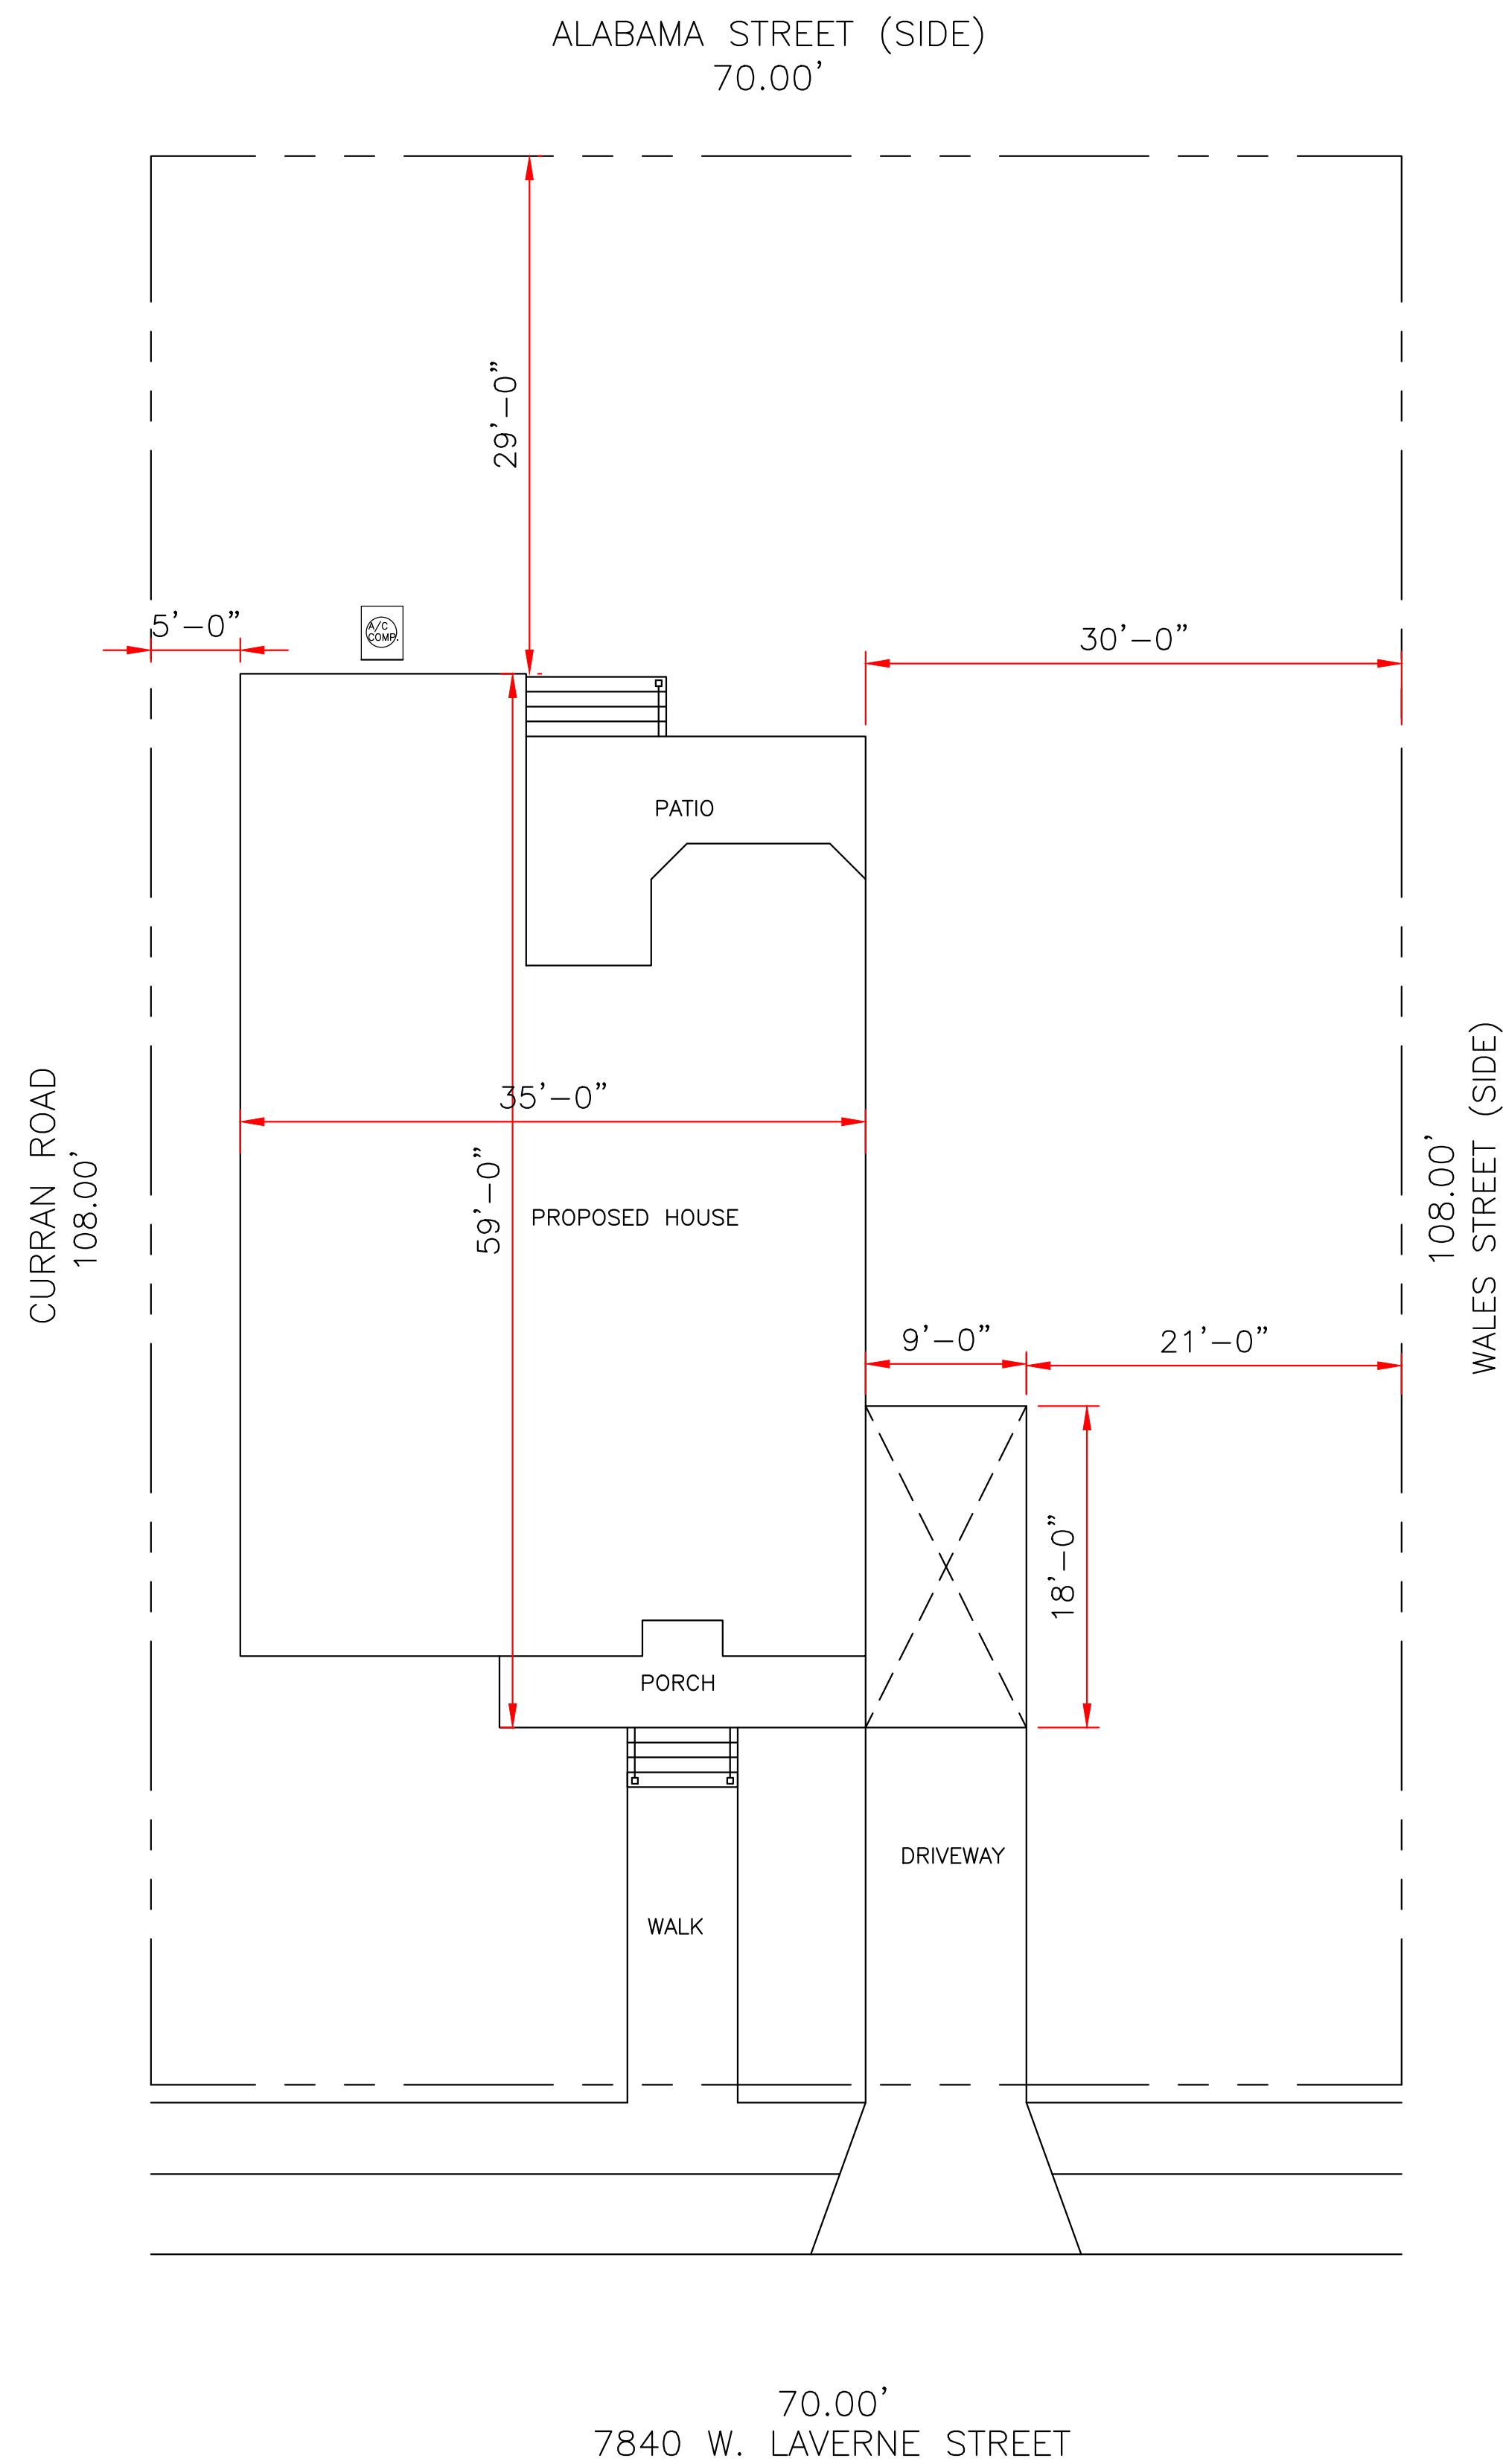


SITE PLAN  
SCALE: 1/8" = 1'-0"

LOT# 25 SQ# 7  
THIRD DISTRICT  
PONCHATRIN PARK SEC. 1  
ORLEANS PARISH, LA



REAR ELEVATION  
SCALE: 1/4" = 1'-0"

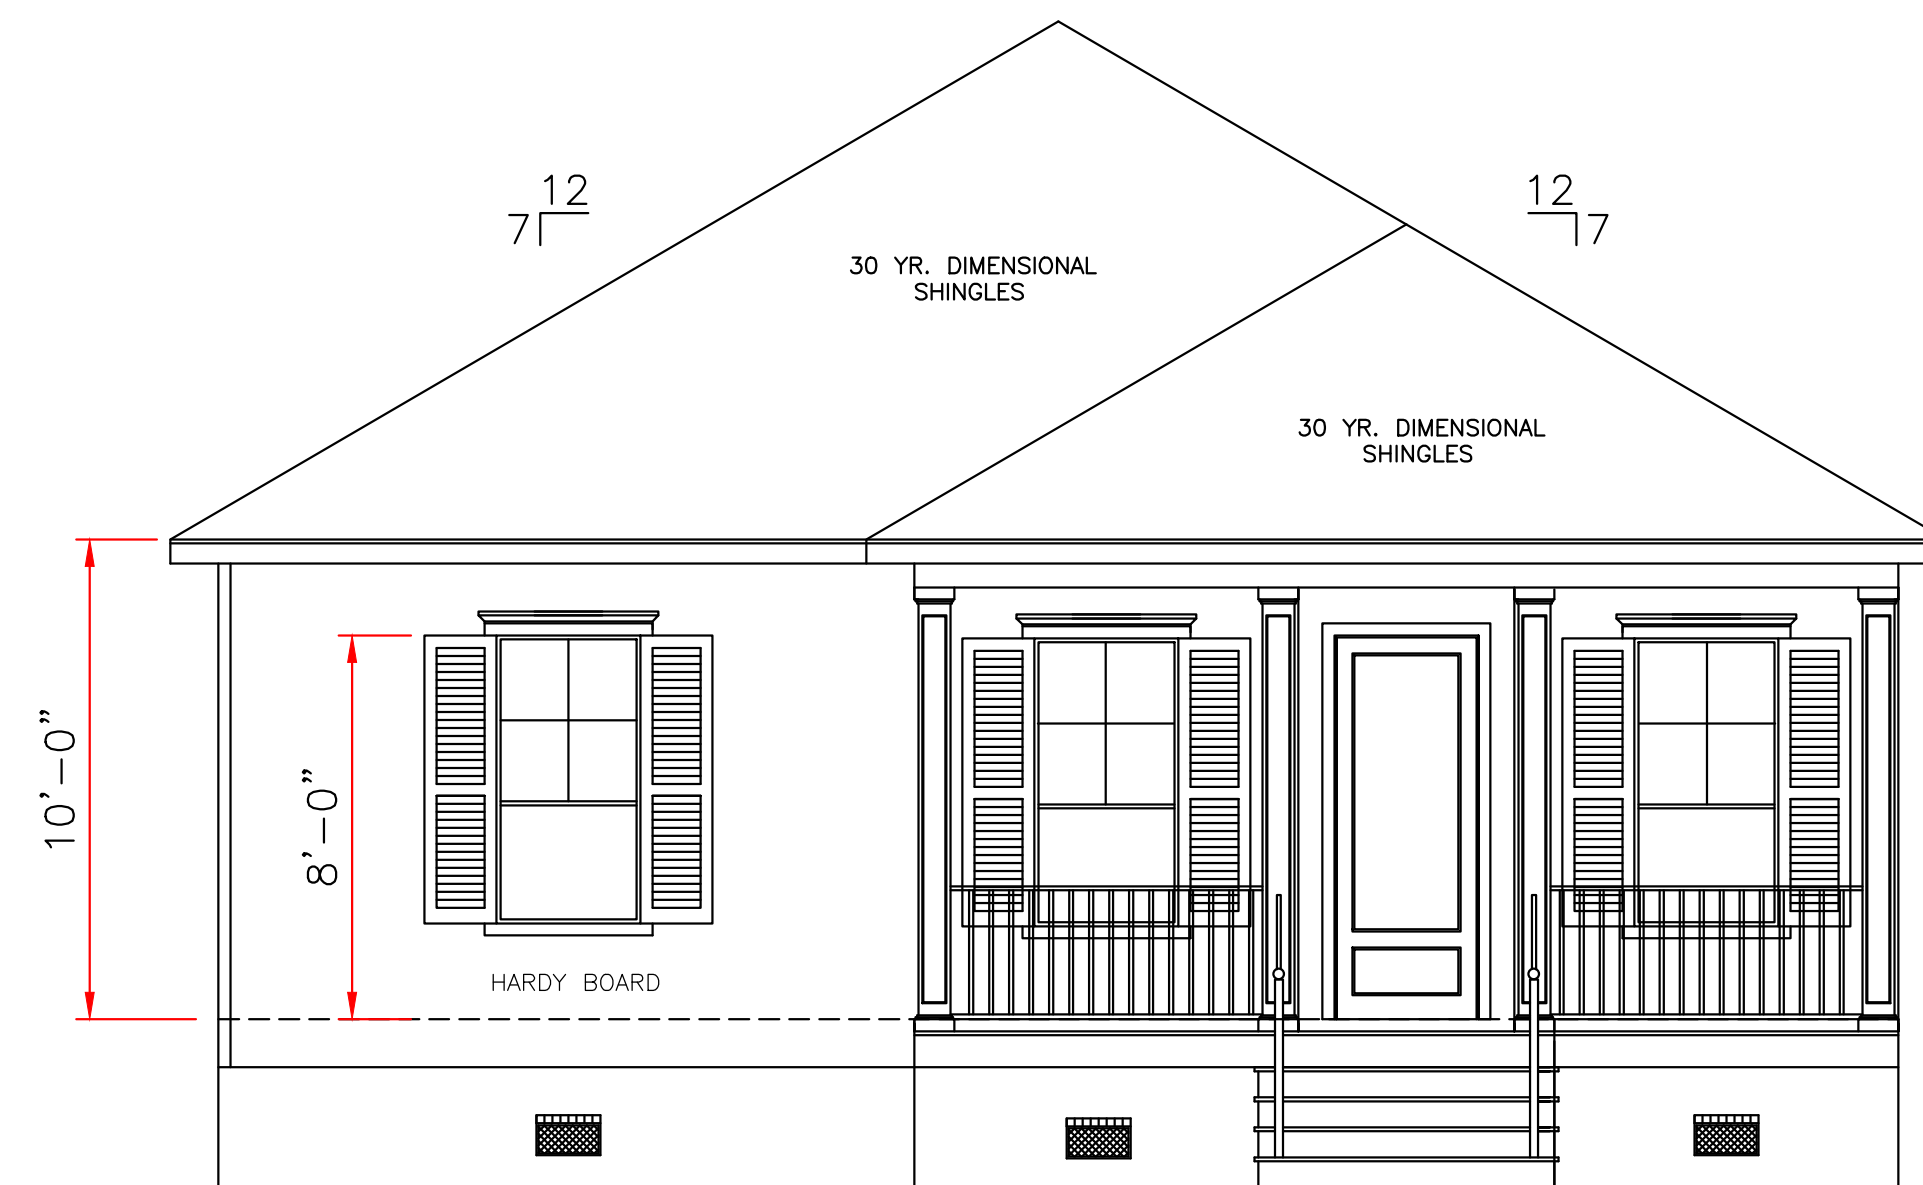

FRONT ELEVATION  
SCALE: 1/4" = 1'-0"

TOP OF FINISH FLOOR AT  
OR ABOVE MINIMUM BASE FLOOD.

ALL MATERIALS BELOW  
BASE FLOOD MUST  
BE WATER RESISTANT

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	<b>LARRY TRUMBATURU</b>		AMYRICK RUSSELL 7840 W. LAVERNE STREET ORLEANS PARISH, LA.	
	8307 LAFITTE CT. CHALMETTE, LA 70043 504-279-3508	DATE 02/22/22	SHEET NO. 1 OF 6	

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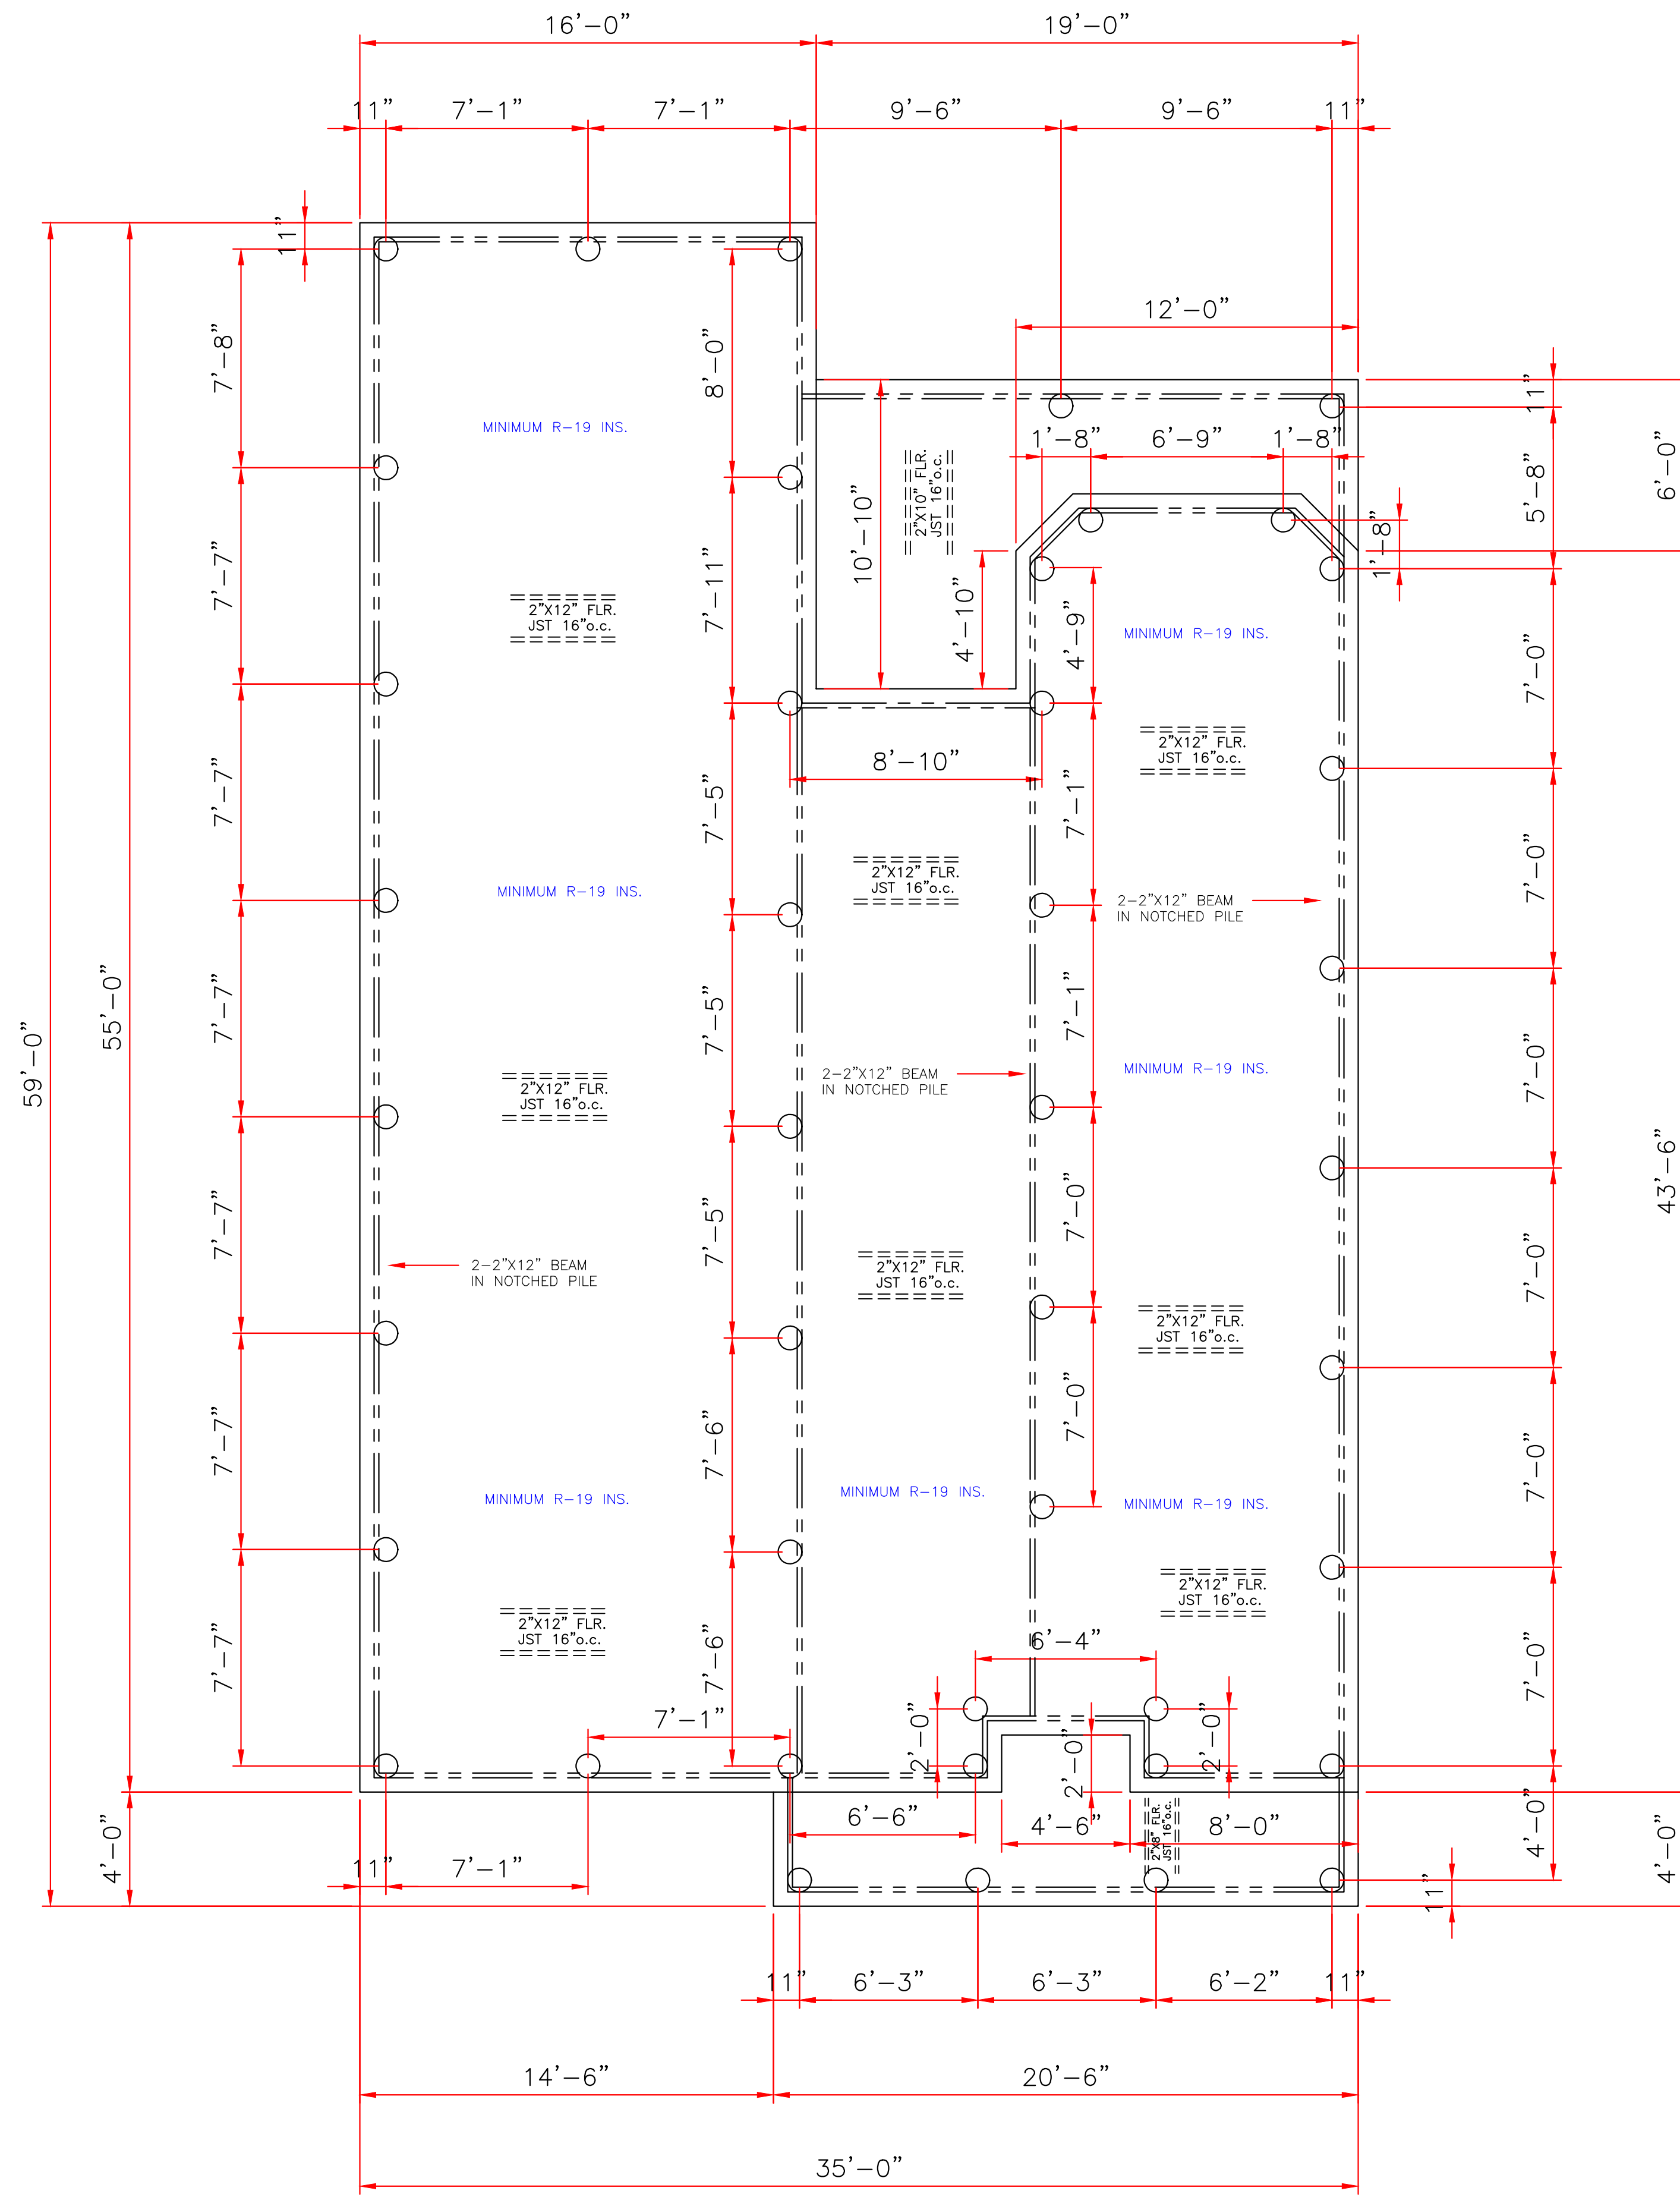
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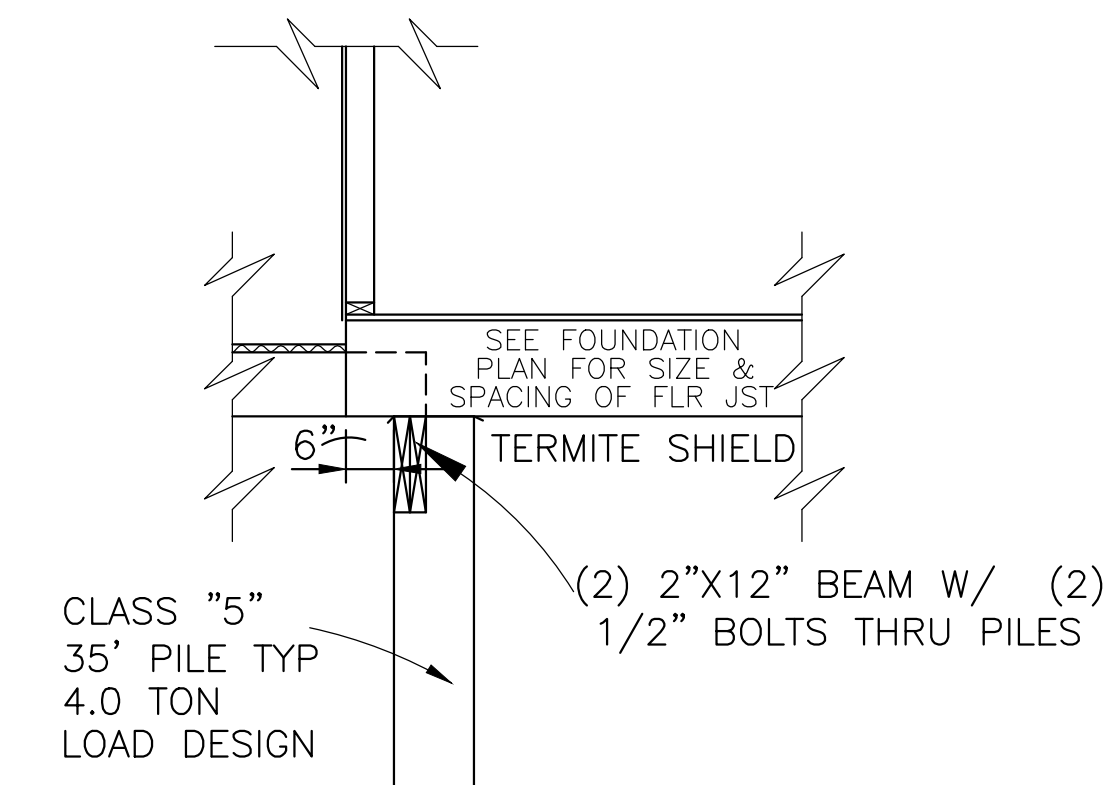
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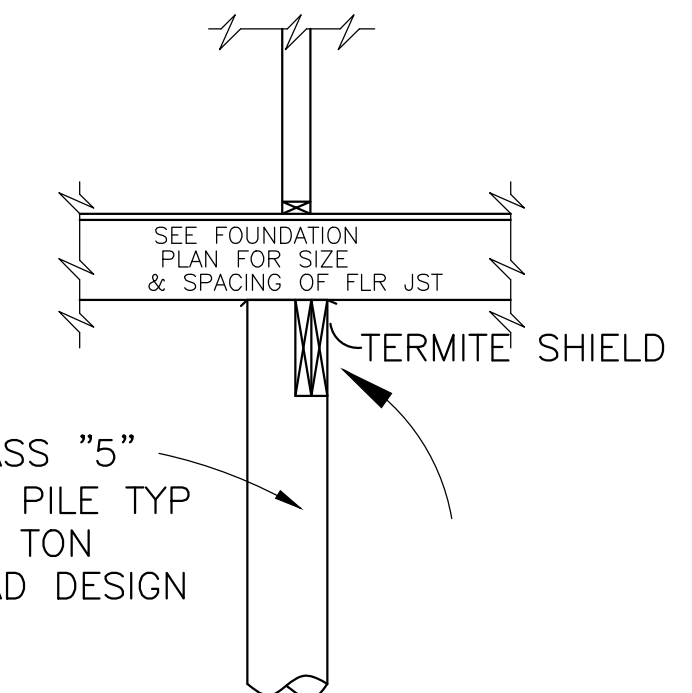
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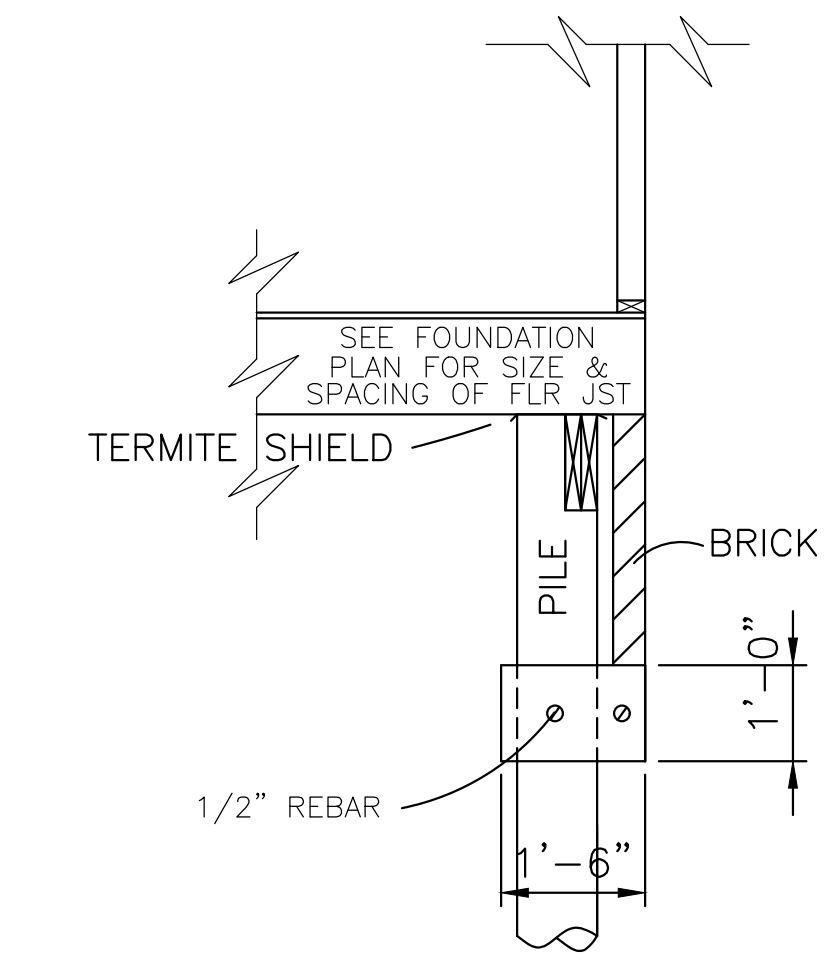
FOUNDATION PLAN  
SCALE: 1/4" = 1'-0"



SECTION @ PORCH  
SCALE: 1/2" = 1'-0"




INTERIOR FOOTING DETAIL  
SCALE: 1/2" = 1'



EXTERIOR BRICK DETAIL  
SCALE: 1/2" = 1'-0"

OPTION

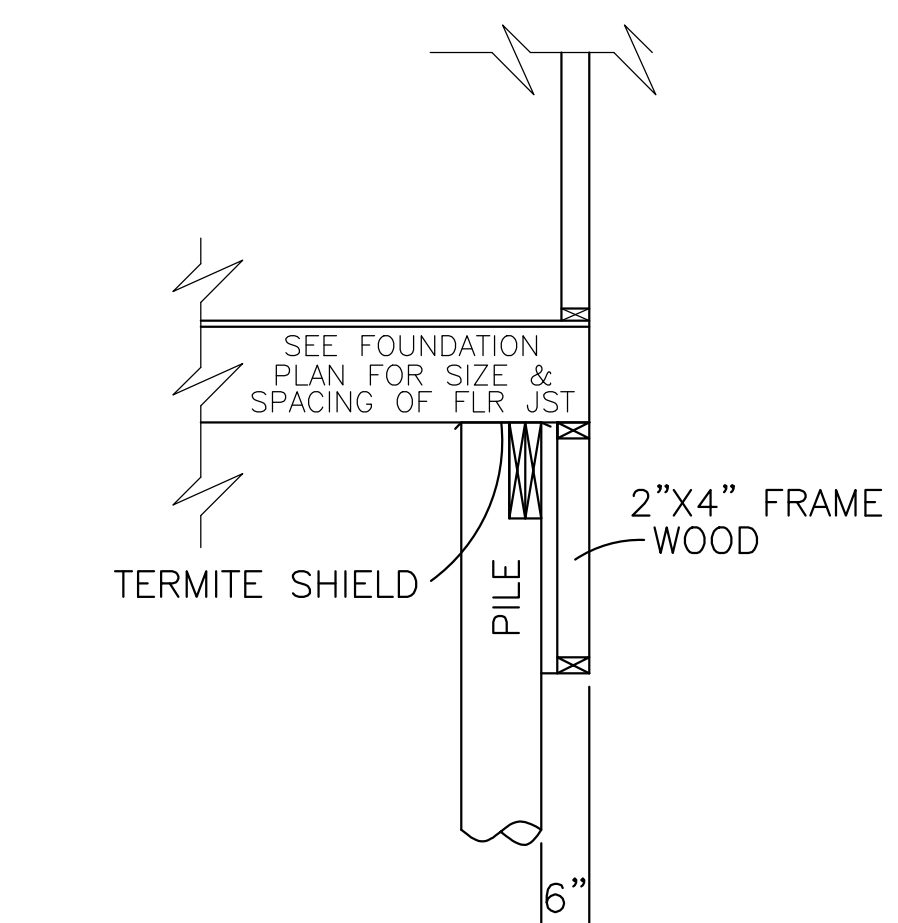

EXTERIOR WOOD DETAIL  
SCALE: 1/2" = 1'-0"

OPTION

CLASS 5 35' PILE WITH 4.0 TON LOAD DESIGN DRIVEN WITH STEEL DROP HAMMER OR RAPID IMPACT HAMMER METHOD, TO REFUSAL

SOIL TREATMENT, CHEMICAL TERMITICIDE OR TEMITE SHIELDS WILL BE USED FOR TERMITIC PROTECTION, BUILDER VERIFY

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	<p>LARRY TRUMBATURI</p>		<p>AMYRICK RUSSELL 7840 W. LAVERNE STREET ORLEANS PARISH, LA.</p>	
	<p>8307 LAFITTE CT. CHALMETTE, LA 70043</p>	<p>DATE 02/22/22</p>	<p>SHEET NO. 2 OF 6</p>	<p>JOB NO 8940</p>

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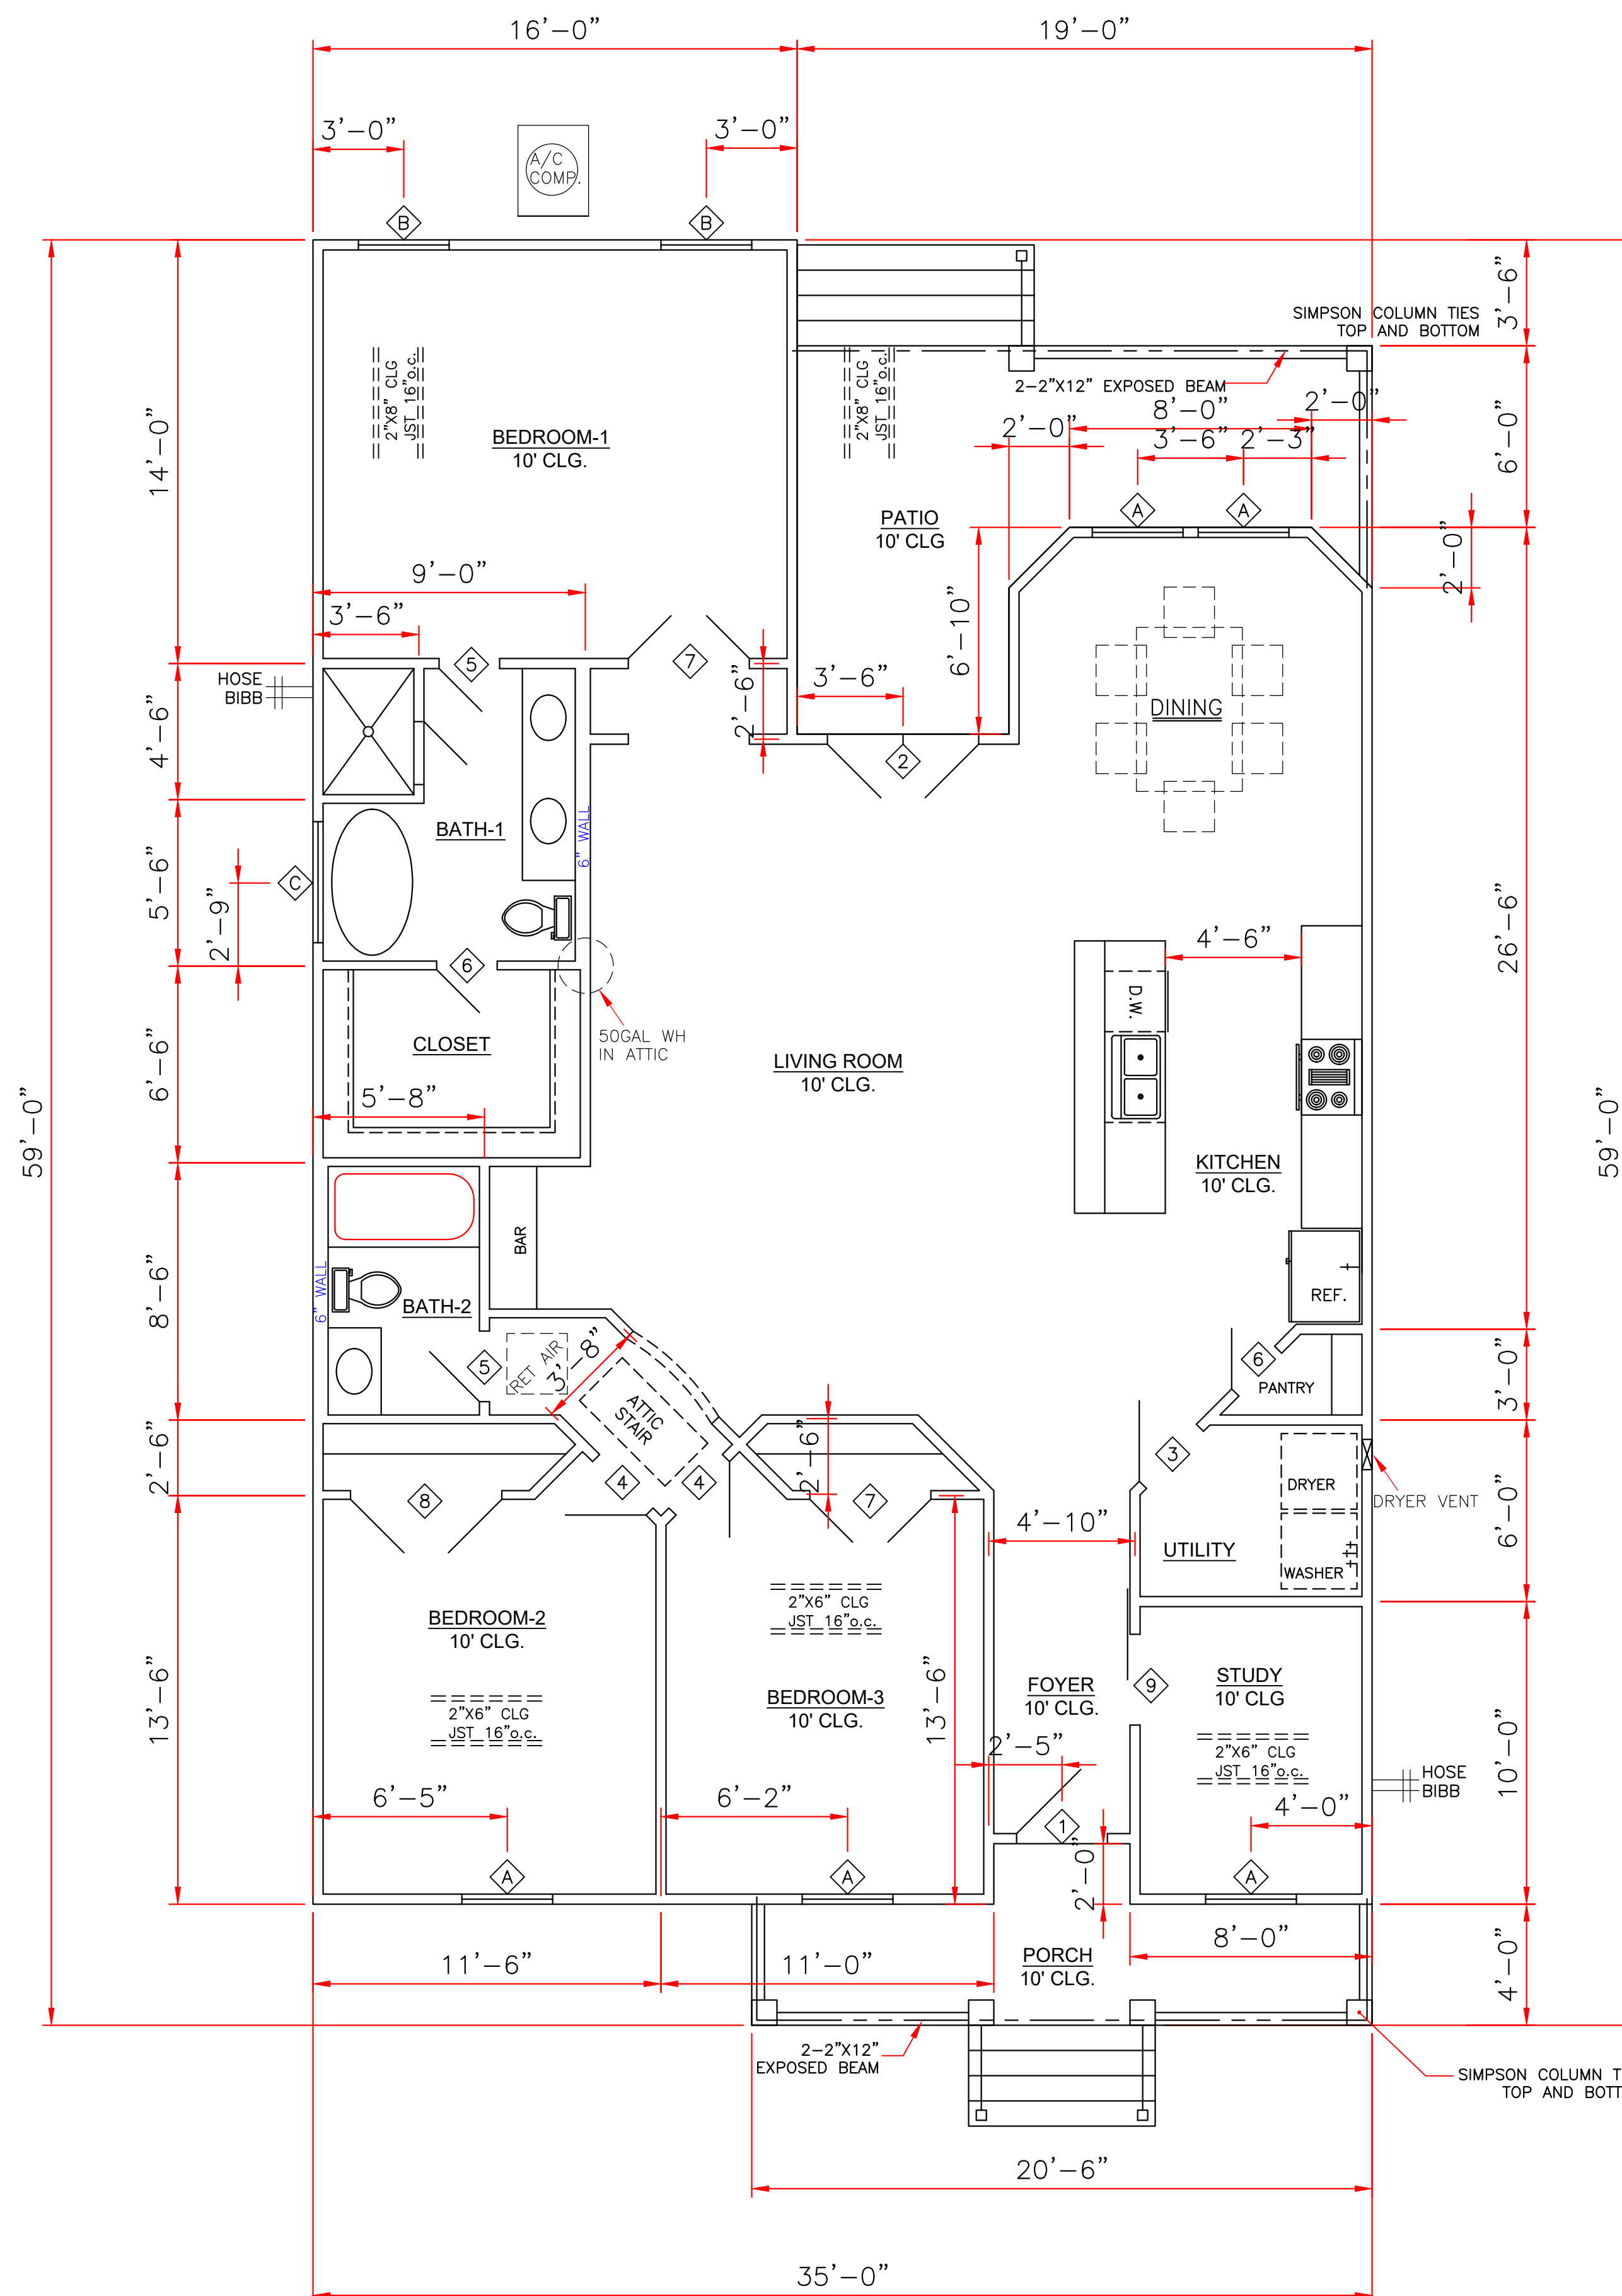
DOORS		
1	3'0"x8'0"x1 3/4"	EXT. INSUL.
2	2-2'8"x8'0"x1 3/4"	EXT. INSUL. PAIR
3	2'8"x8'0"x1 3/8"	INTERIOR RAISED PANEL
4	2'6"x8'0"x1 3/8"	INTERIOR RAISED PANEL
5	2'4"x8'0"x1 3/8"	INTERIOR RAISED PANEL
6	2'0"x8'0"x1 3/8"	INTERIOR RAISED PANEL
7	2-2'0"x8'0"x1 3/8"	INTERIOR RAISED PANEL PAIR
8	2-2'6"x8'0"x1 3/8"	INTERIOR RAISED PANEL PAIR
9	3'0"x8'0"x1 3/8"	BARN DOOR

WINDOWS		
A	3'0"x6'0"	VINYL S.H. 4/1 LTS
B	3'0"x5'2"	VINYL S.H. 1/1 LTS
C	4'0"x1'0"	FIXED W/ SAFETY GLAZING (SECT. R308 IRC)

ENERGY PERFORMANCE RATING: U-FACTOR=.55; SOLAR HEAT GAIN COEFFICIENT=.35

GENERAL NOTES:

- ATTIC VENTILATION WILL BE CONTINUOUS RIDGE VENTS AND PERFORATED SOFFITS. OR EQUAL
- TERMITE SHIELDS WILL BE 26 GA GALVANIZED AT EACH PIER UNDER SILLS
- #2 PINE LUMBER WILL BE USED FOR FRAMING LUMBER
- CONTRACTOR TO REMOVE DEBRIS FROM PROPERTY
- ENCLOSED AREAS BELOW FLOOD GRADE SHALL HAVE A MINIMUM OF 1 SQ. IN. PER 1 SQ. FT. OF WATER FLOW VENTING.
- MINIMUM INSULATION REQUIRED  
FLOORS- R-19  
WALL- R-13  
CEILING- R-38
- BUILDING MATERIAL USED BELOW DESIGN FLOOD ELEVATION MUST BE WATER RESISTANT
- WINDOWS INSTALLED IN BATHTUB ENCLOSURES LESS THAN 60" F.F.F. REQUIRE SAFETY GLAZING AND WINDOWS WITHIN 2' OF DOORS AND WITHIN 5' OF STAIRS
- FLOOD VENTS WHERE APPLICABLE SHALL BE 1'-0" OR LESS ABOVE GRADE.
- WINDOWS WHERE BOTTOM EDGE IS LESS THAN 18" REQUIRES SAFETY



FLOOR PLAN

SCALE: 1/4" = 1'-0"

SQUARE FOOTAGE	
LIVING	1684
PORCH	69
PATIO	166
TOTAL	1919

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	<b>LARRY TRUMBATURI</b> 8307 LAFITTE CT. CHALMETTE, LA 70043 504-279-3508   JOB NO 8940		AMYRICK RUSSELL 7840 W. LAVERNE STREET ORLEANS PARISH, LA. DATE 02/22/22 SHEET NO 3 OF 6	
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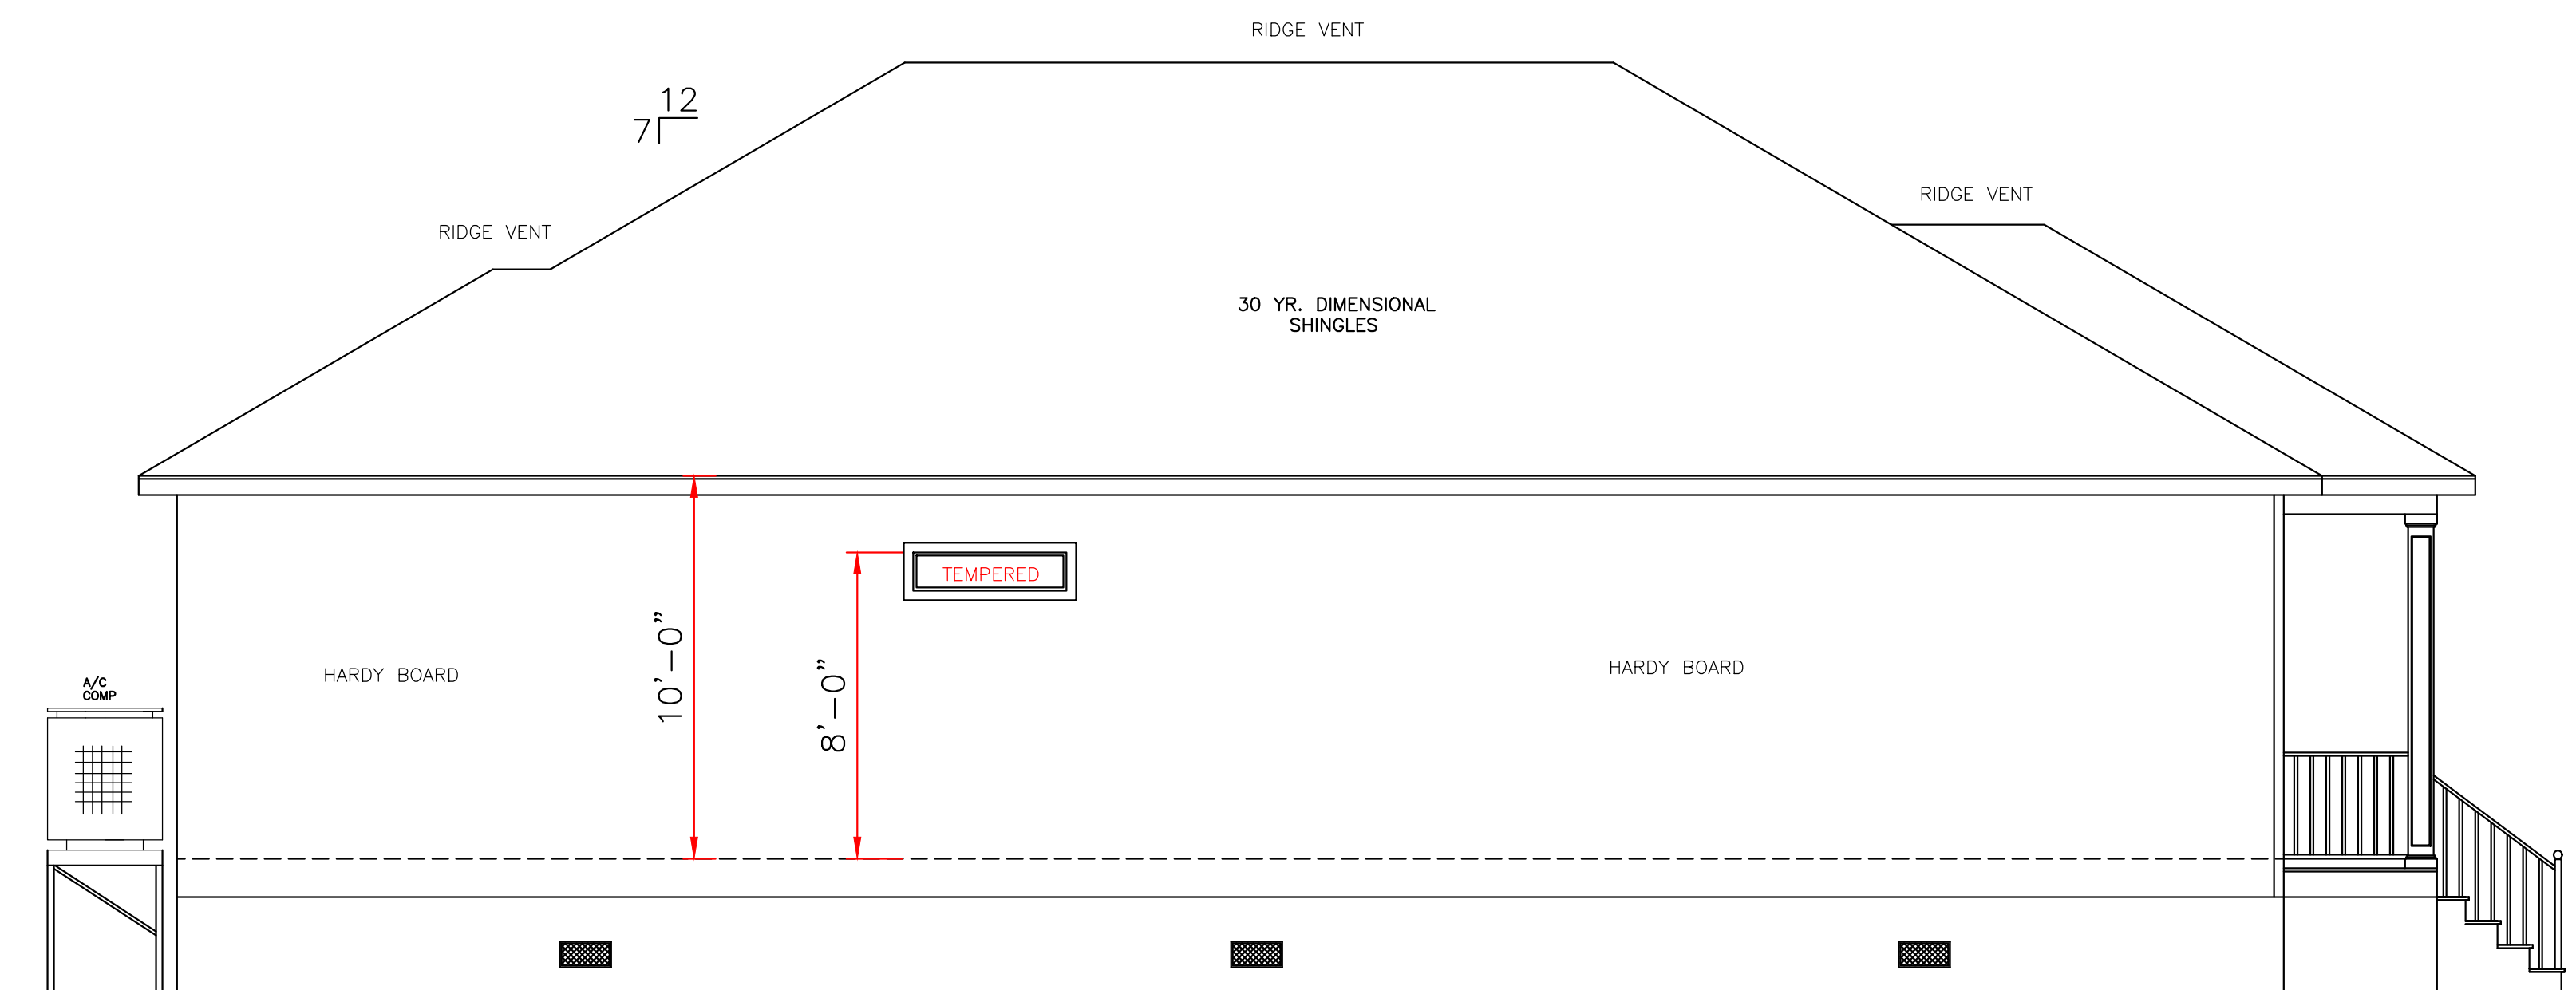
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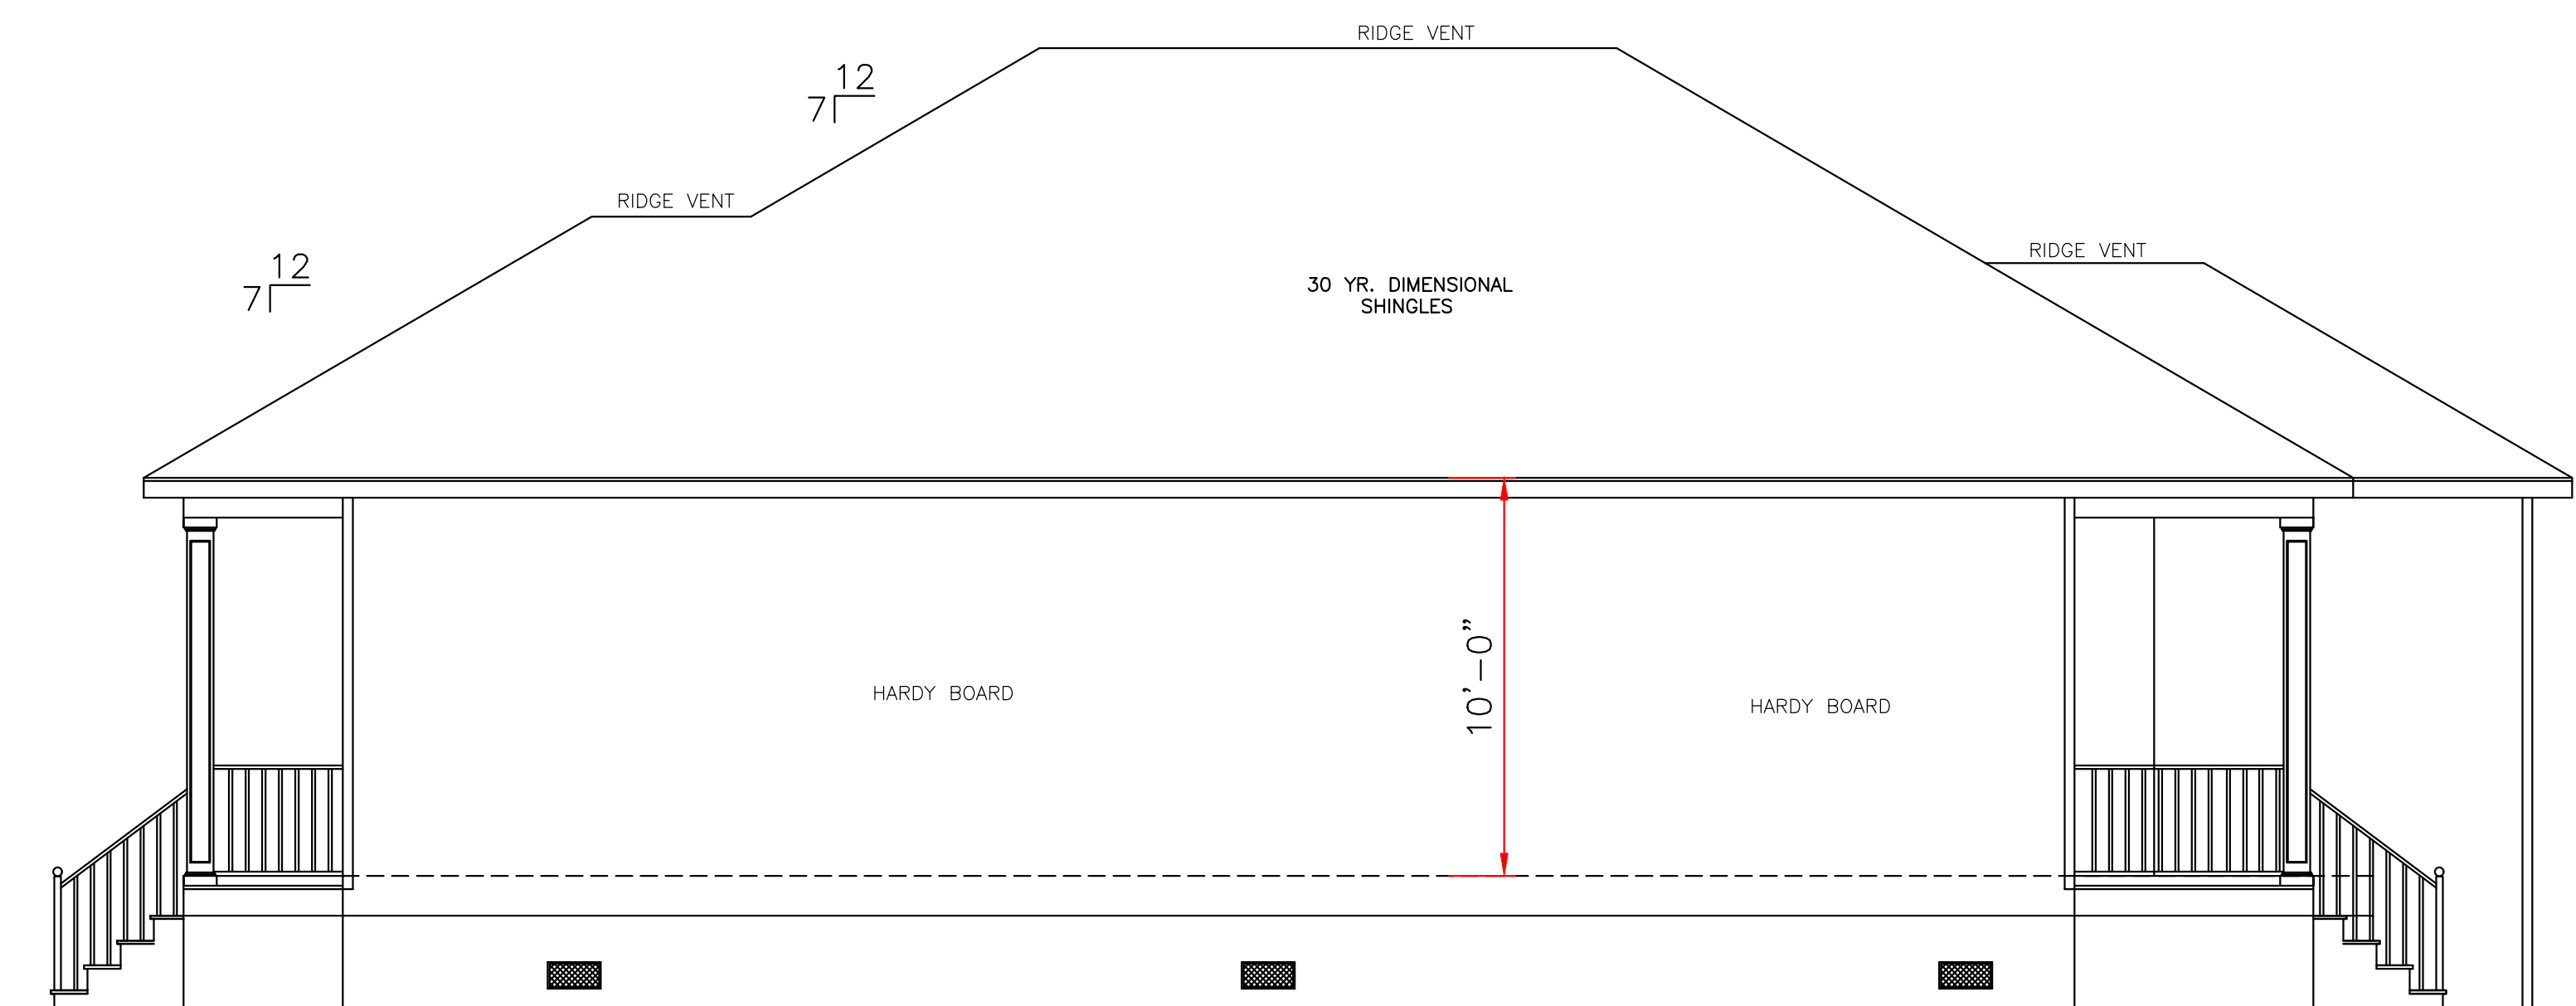
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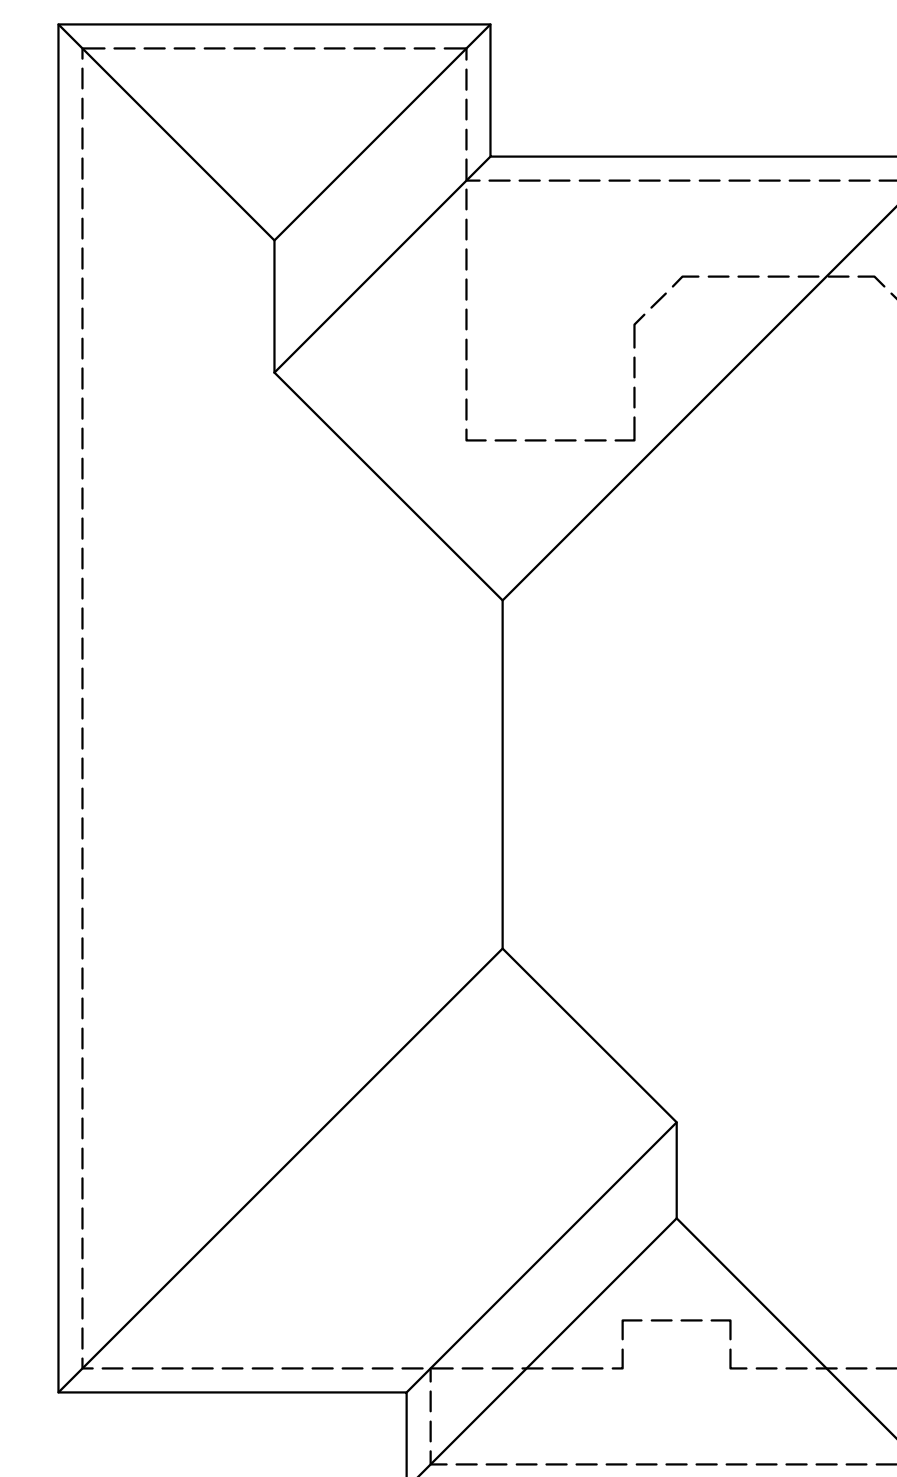
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LEFT ELEVATION  
SCALE: 1/4" = 1'-0"



RIGHT ELEVATION  
SCALE: 1/4" = 1'-0"



ROOF PLAN  
SCALE: 1/8" = 1'-0"

ALL MATERIALS BELOW  
BASE FLOOD MUST  
BE WATER RESISTANT

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	8307 LAFITTE CT. CHALMETTE, LA 70043 504-279-3508	JOB NO 8940	DATE 02/22/22	SHEET NO 4 OF 6	


ELECTRICAL NOTES

1. AFCI PROTECTION SHALL BE PROVIDED FOR DINING ROOMS, FAMILY ROOMS, LIVING ROOMS, HALLWAYS, CLOSETS, BEDROOMS, ETC.
2. SMOKE DETECTORS: (A) SHALL BE INSTALLED IN EACH SLEEPING ROOM. (B) SHALL BE INSTALLED OUTSIDE, IN THE VICINITY OF EACH SLEEPING ROOM. (C) SHALL BE 120 VOLT, HARDWIRED, INTERCONNECTED, WITH A BATTERY BACKUP. (D) SHALL NOT BE INSTALLED WITHIN 36 INCHES OF A RETURN AIR GRILLE OR ANY PADDLE FAN BLADE.
3. KITCHEN: (A) ALL RECEPTACLES OVER COUNTERTOP SHALL BE GFI PROTECTED REGARDLESS OF DISTANCE FROM THE SINK. (B) THE DISHWASHER SHALL BE CONNECTED BY MEANS OF AN APPLIANCE CORD TO A RECEPTACLE UNDER THE SINK. THE RECEPTACLE WILL NOT BE GFI PROTECTED.
4. BATHROOMS: (A) ALL RECEPTACLES SHALL BE GFI PROTECTED. (B) LIGHTS OVER BATHTUBS SHALL HAVE COVERS THAT ARE LISTED FOR "DAMP LOCATION" (C) LIGHTS OVER SHOWERS SHALL HAVE COVERS LISTED FOR "WET LOCATION."
5. EXTERIOR RECEPTACLES SHALL ALL BE GFI PROTECTED AND SHALL HAVE WEATHERPROOF COVERS.
6. A RECEPTACLE (NOT SHOWN ON THE PLAN) WILL BE INSTALLED ON THE EXTERIOR WALL WITHIN 25 FEET OF THE AIR CONDITIONING EQUIPMENT.

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LEGEND	
	CEILING FAN
	RECESSED LIGHTS
	WALL SWITCH 15A., 120V., SINGLE POLE SINGLE THROW, MOUNT AT 60" AFF
	3 WAY WALL SWITCH 15A., 120V. MOUNT AT 60" AFF
	CEILING LIGHT INCANDESCENT, 2-60 WATT
	VENT/LIGHT FIXTURE
	CARBON MONOXIDE DETECTOR
	110 VOLT WATER PROOF OUTLET
	FLOOD LIGHTS
	110 VOLT SMOKE DETECTOR
	110 VOLT OUTLET
	HANGING LIGHT FIXTURE
	WALL LIGHT FIXTURE
	DIMMER LIGHT FIXTURE



ELECTRICAL PLAN  
SCALE: 1/4" = 1'-0"
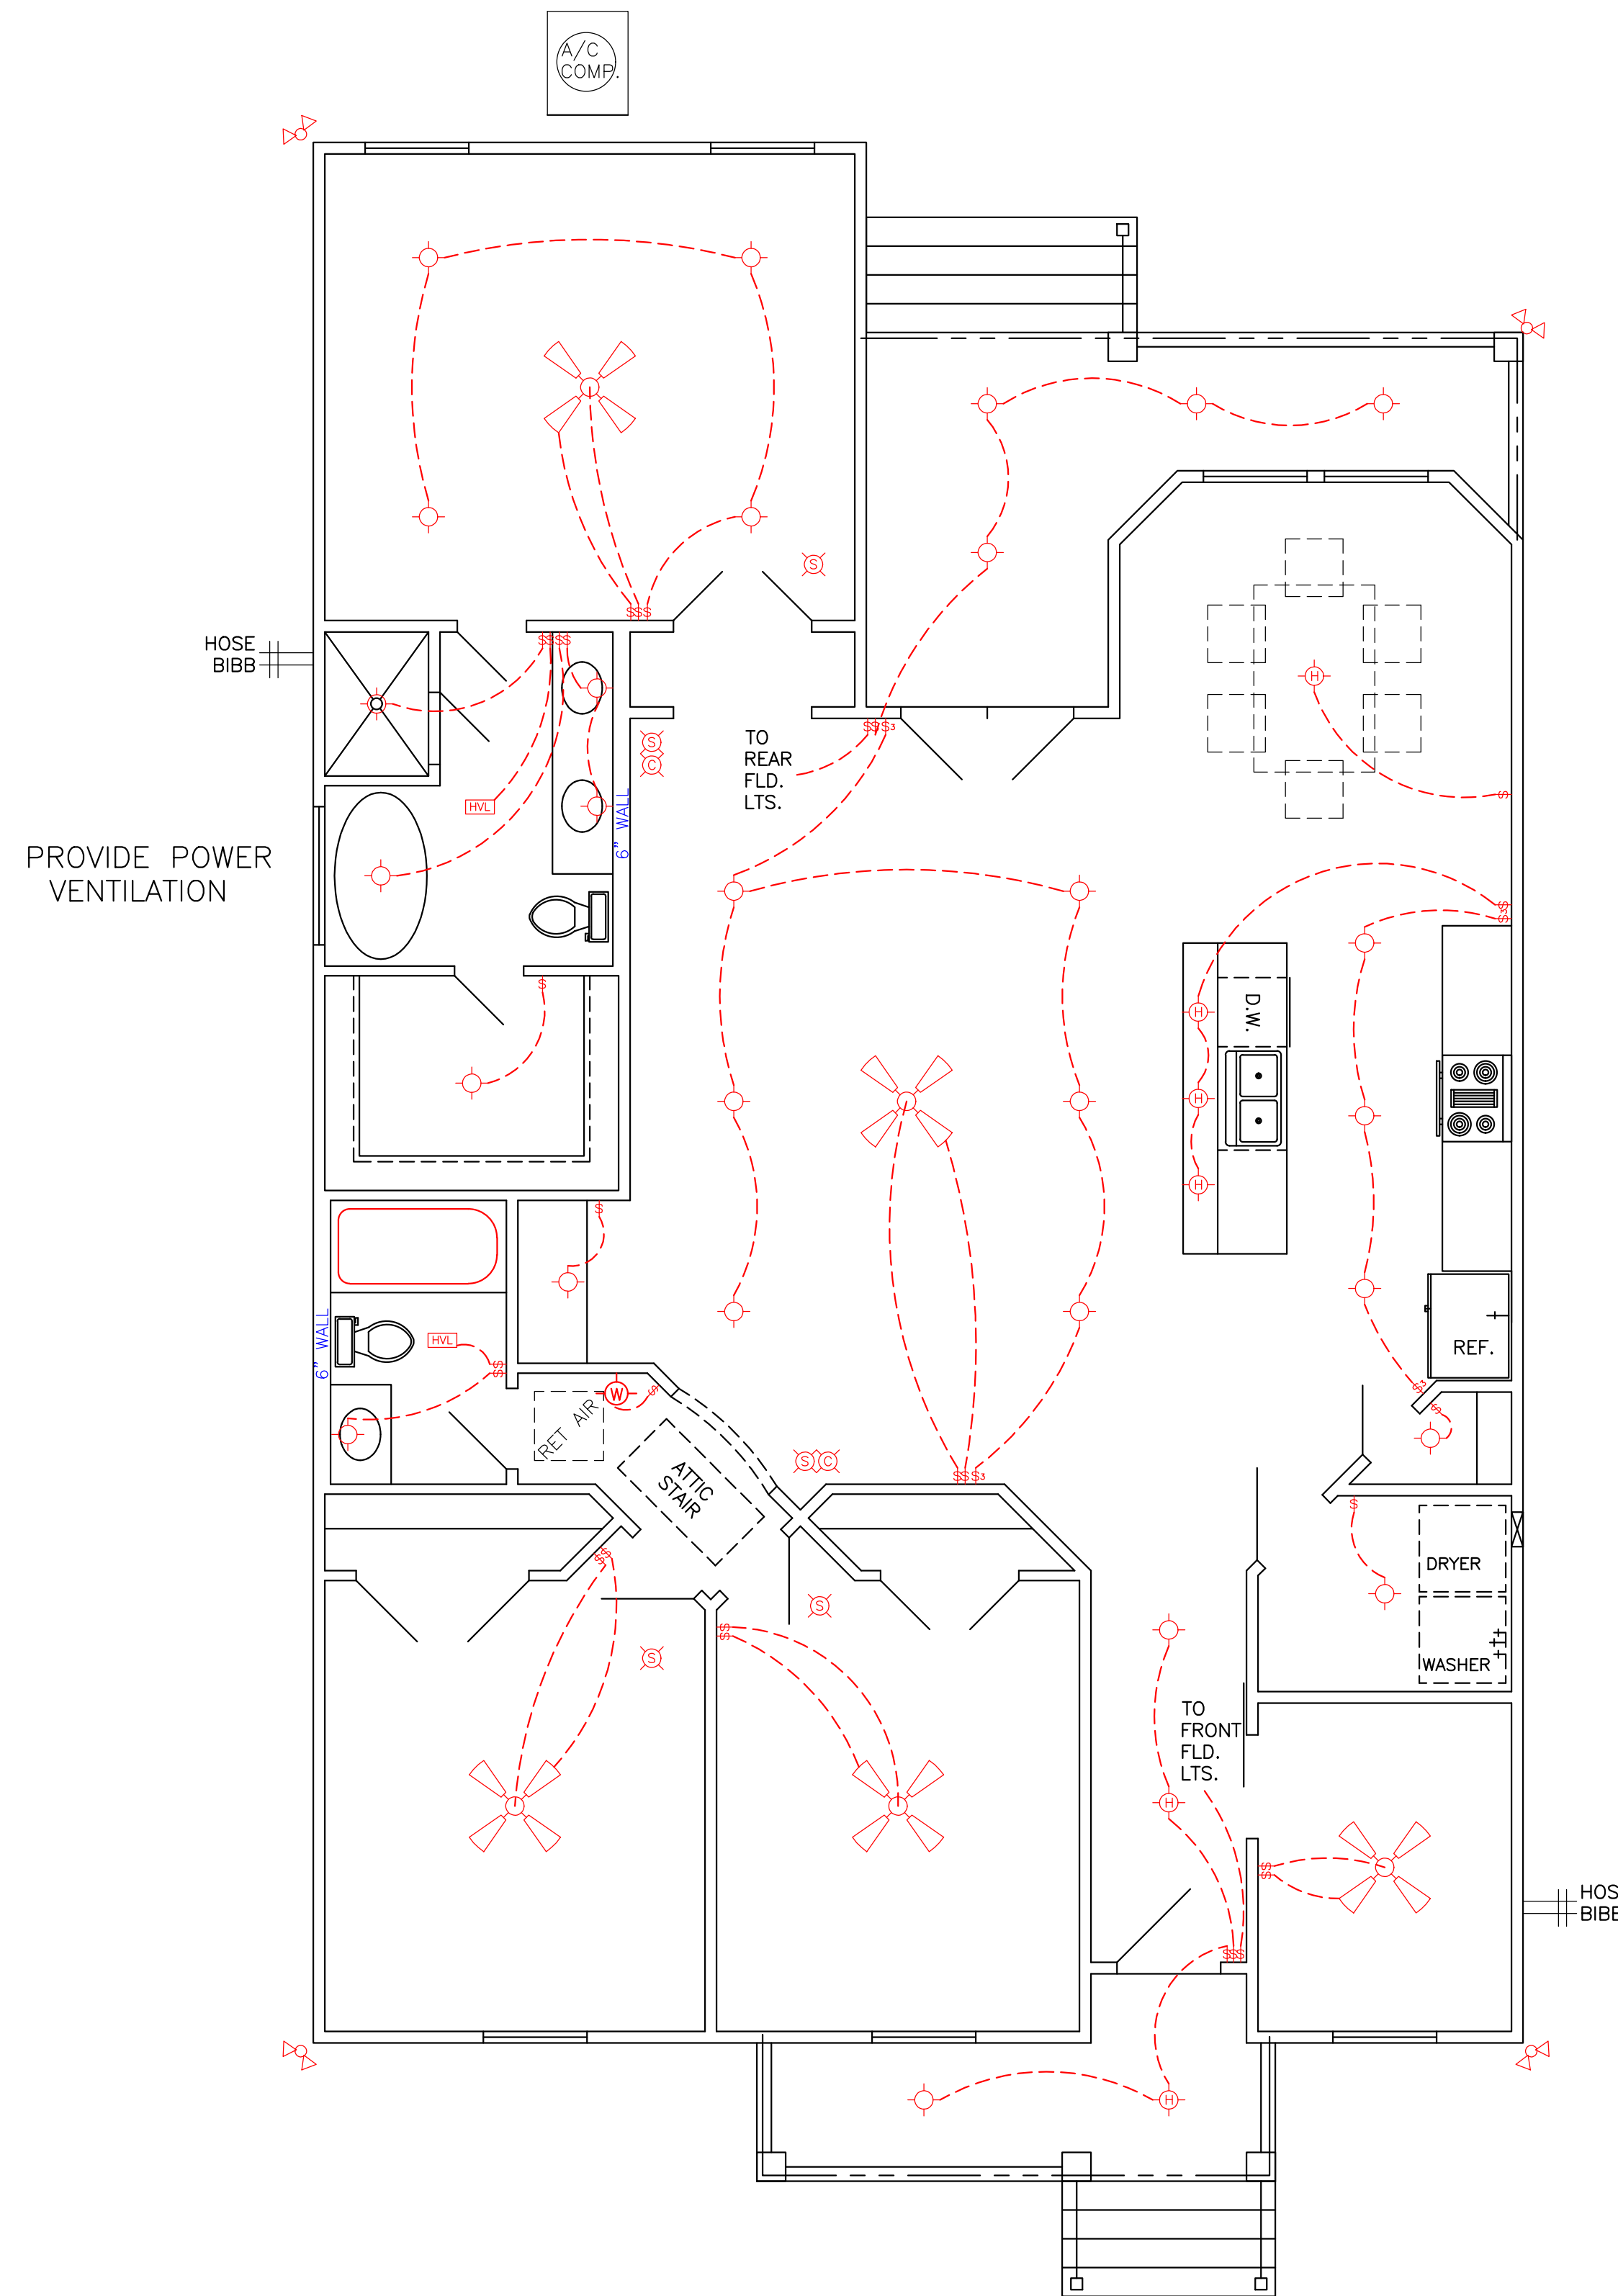
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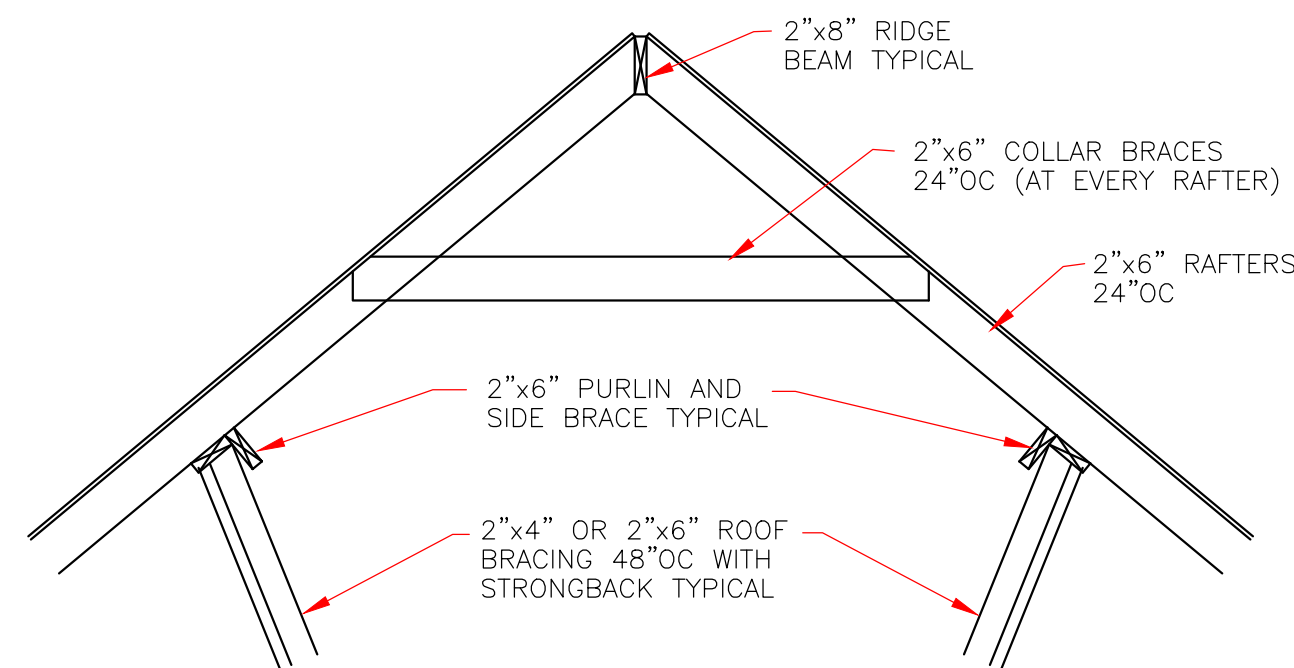
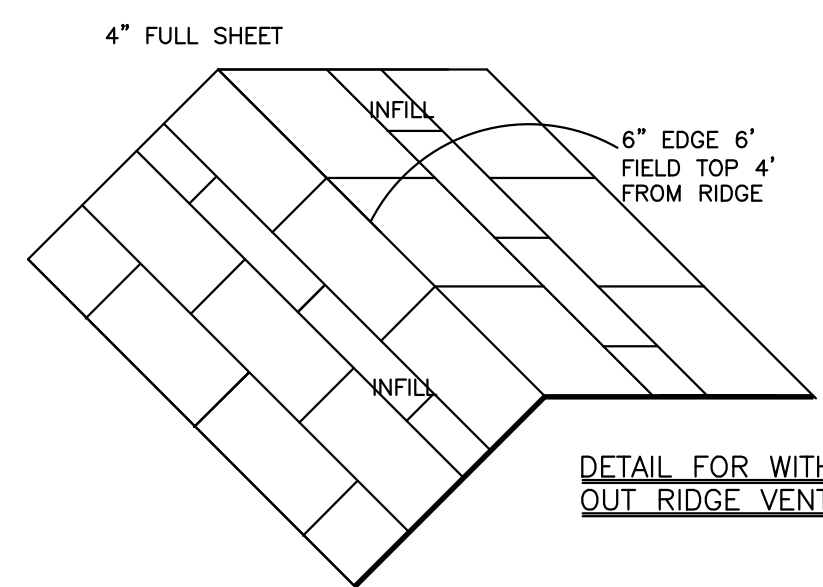
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	8307 LAFITTE CT. CHALMETTE, LA 70043	DATE	02/22/22	SHEET NO
504-279-3508	JOB NO	8940	5 OF 6	




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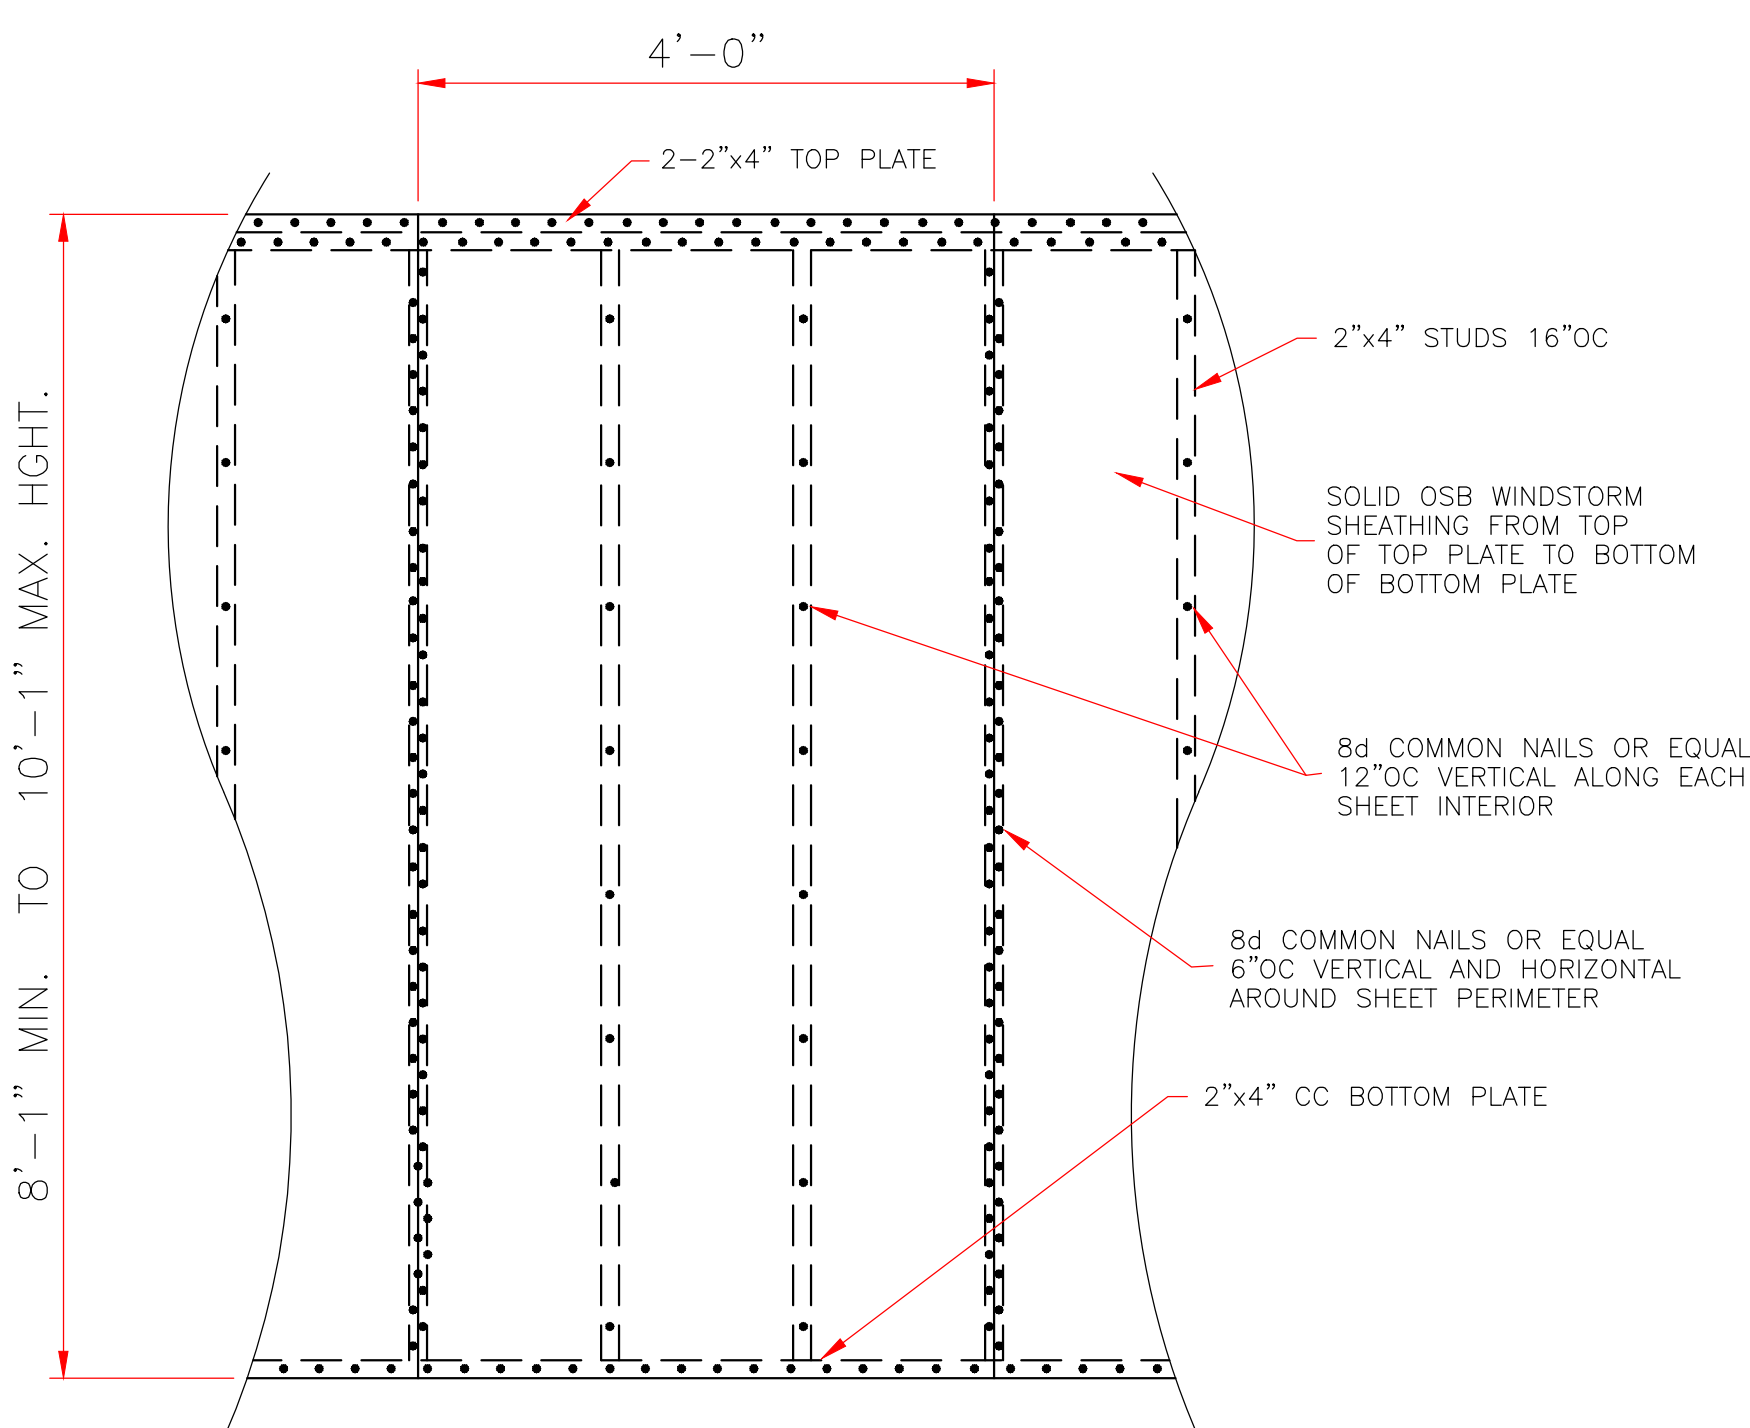
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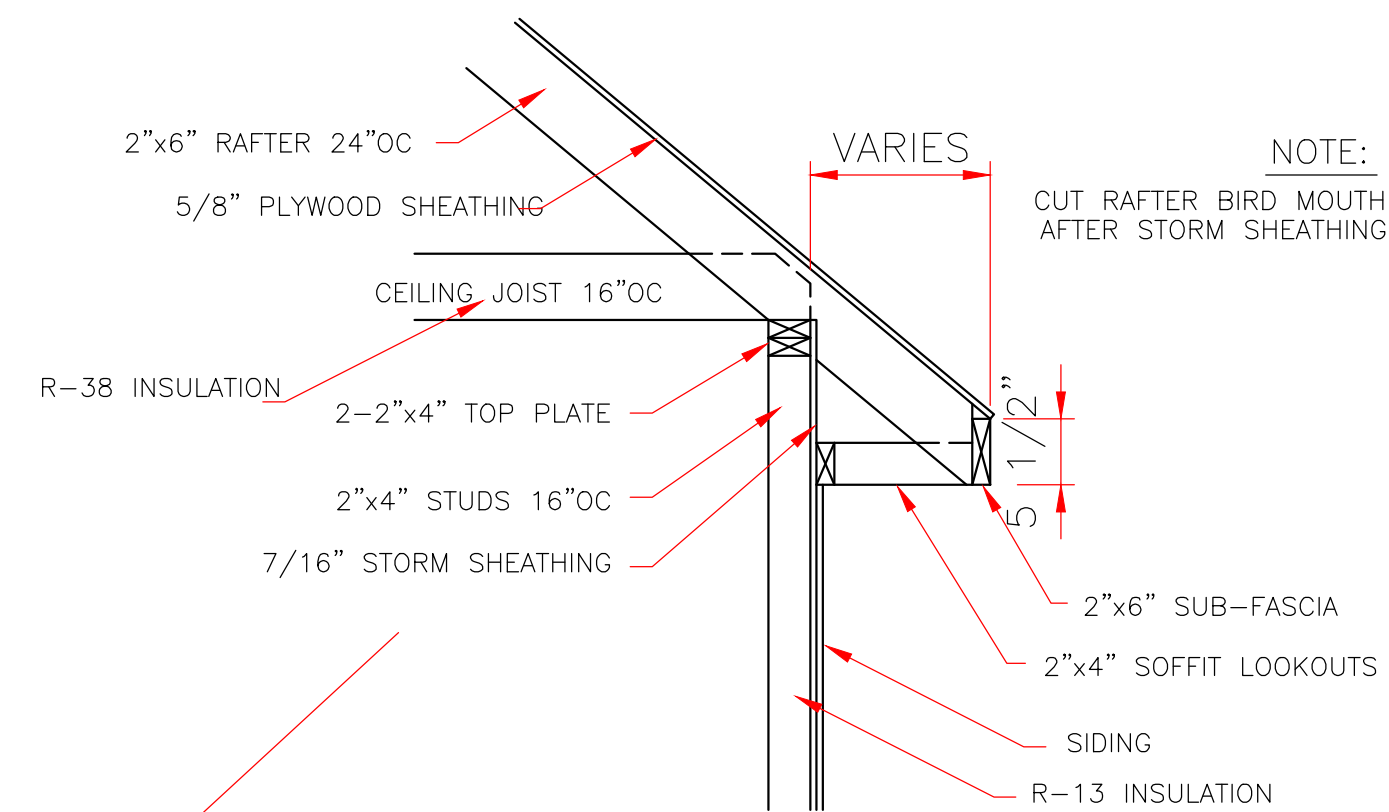
**TYPICAL ROOF BRACING DETAIL**  
NOT TO SCALE




**RAFTER TO TOP PLATES**  
NOT TO SCALE

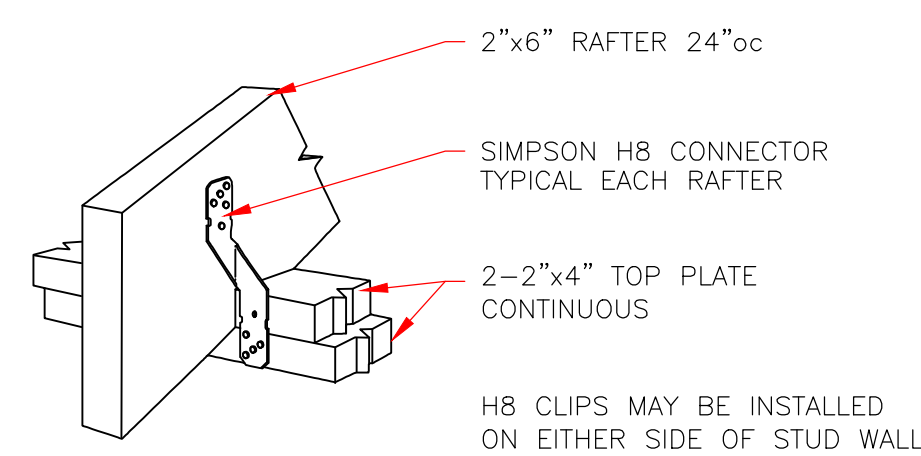


**7/16" STORM SHEATHING**  
TYPICAL ALL EXTERIOR WALLS  
SCALE: 3/4" = 1'-0"



**ROOF SOFFIT DETAIL**  
SCALE: 3/4" = 1'-0"  
WITH FRAME CONSTRUCTION

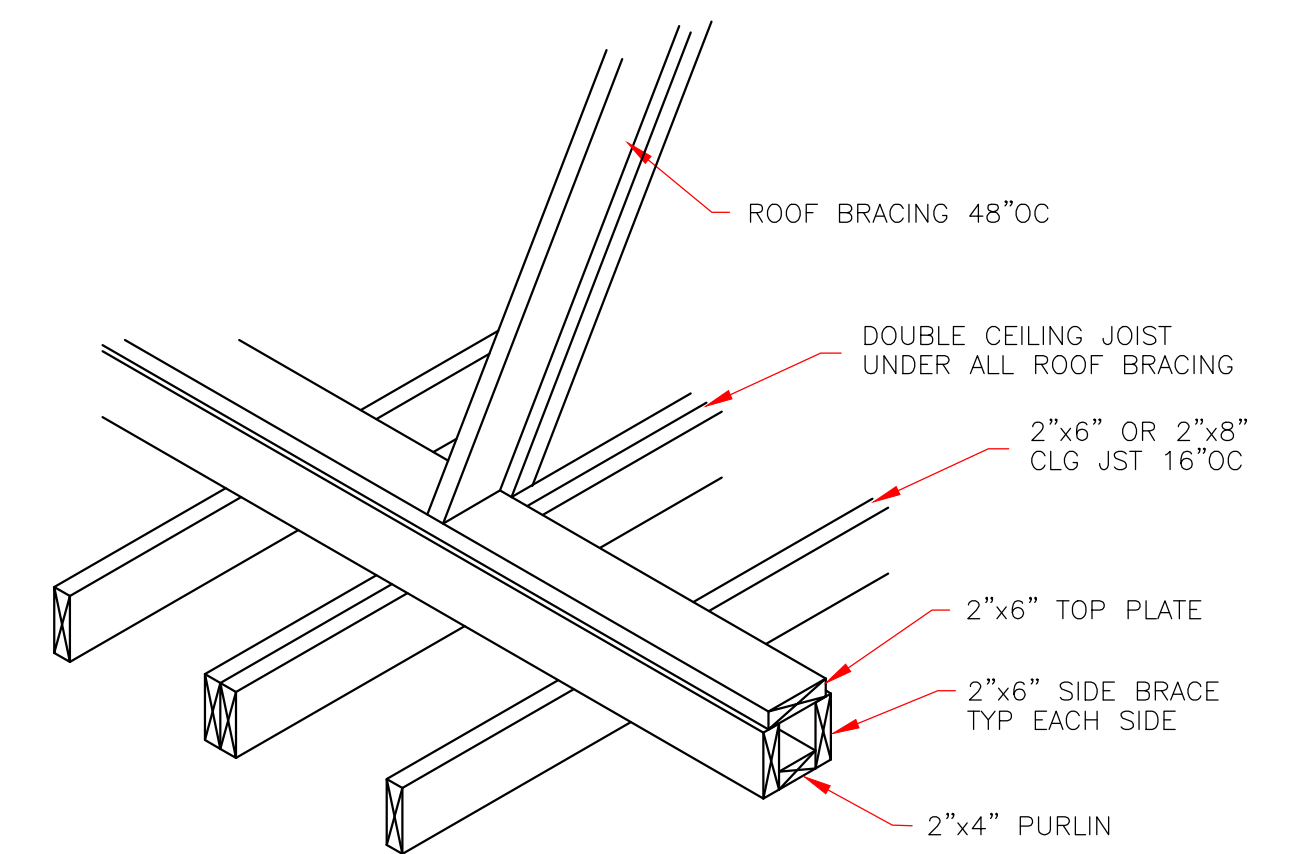

**STRONGBACK DETAIL**  
FOR 2"x6" OR 2"x8" JOIST  
NOT TO SCALE

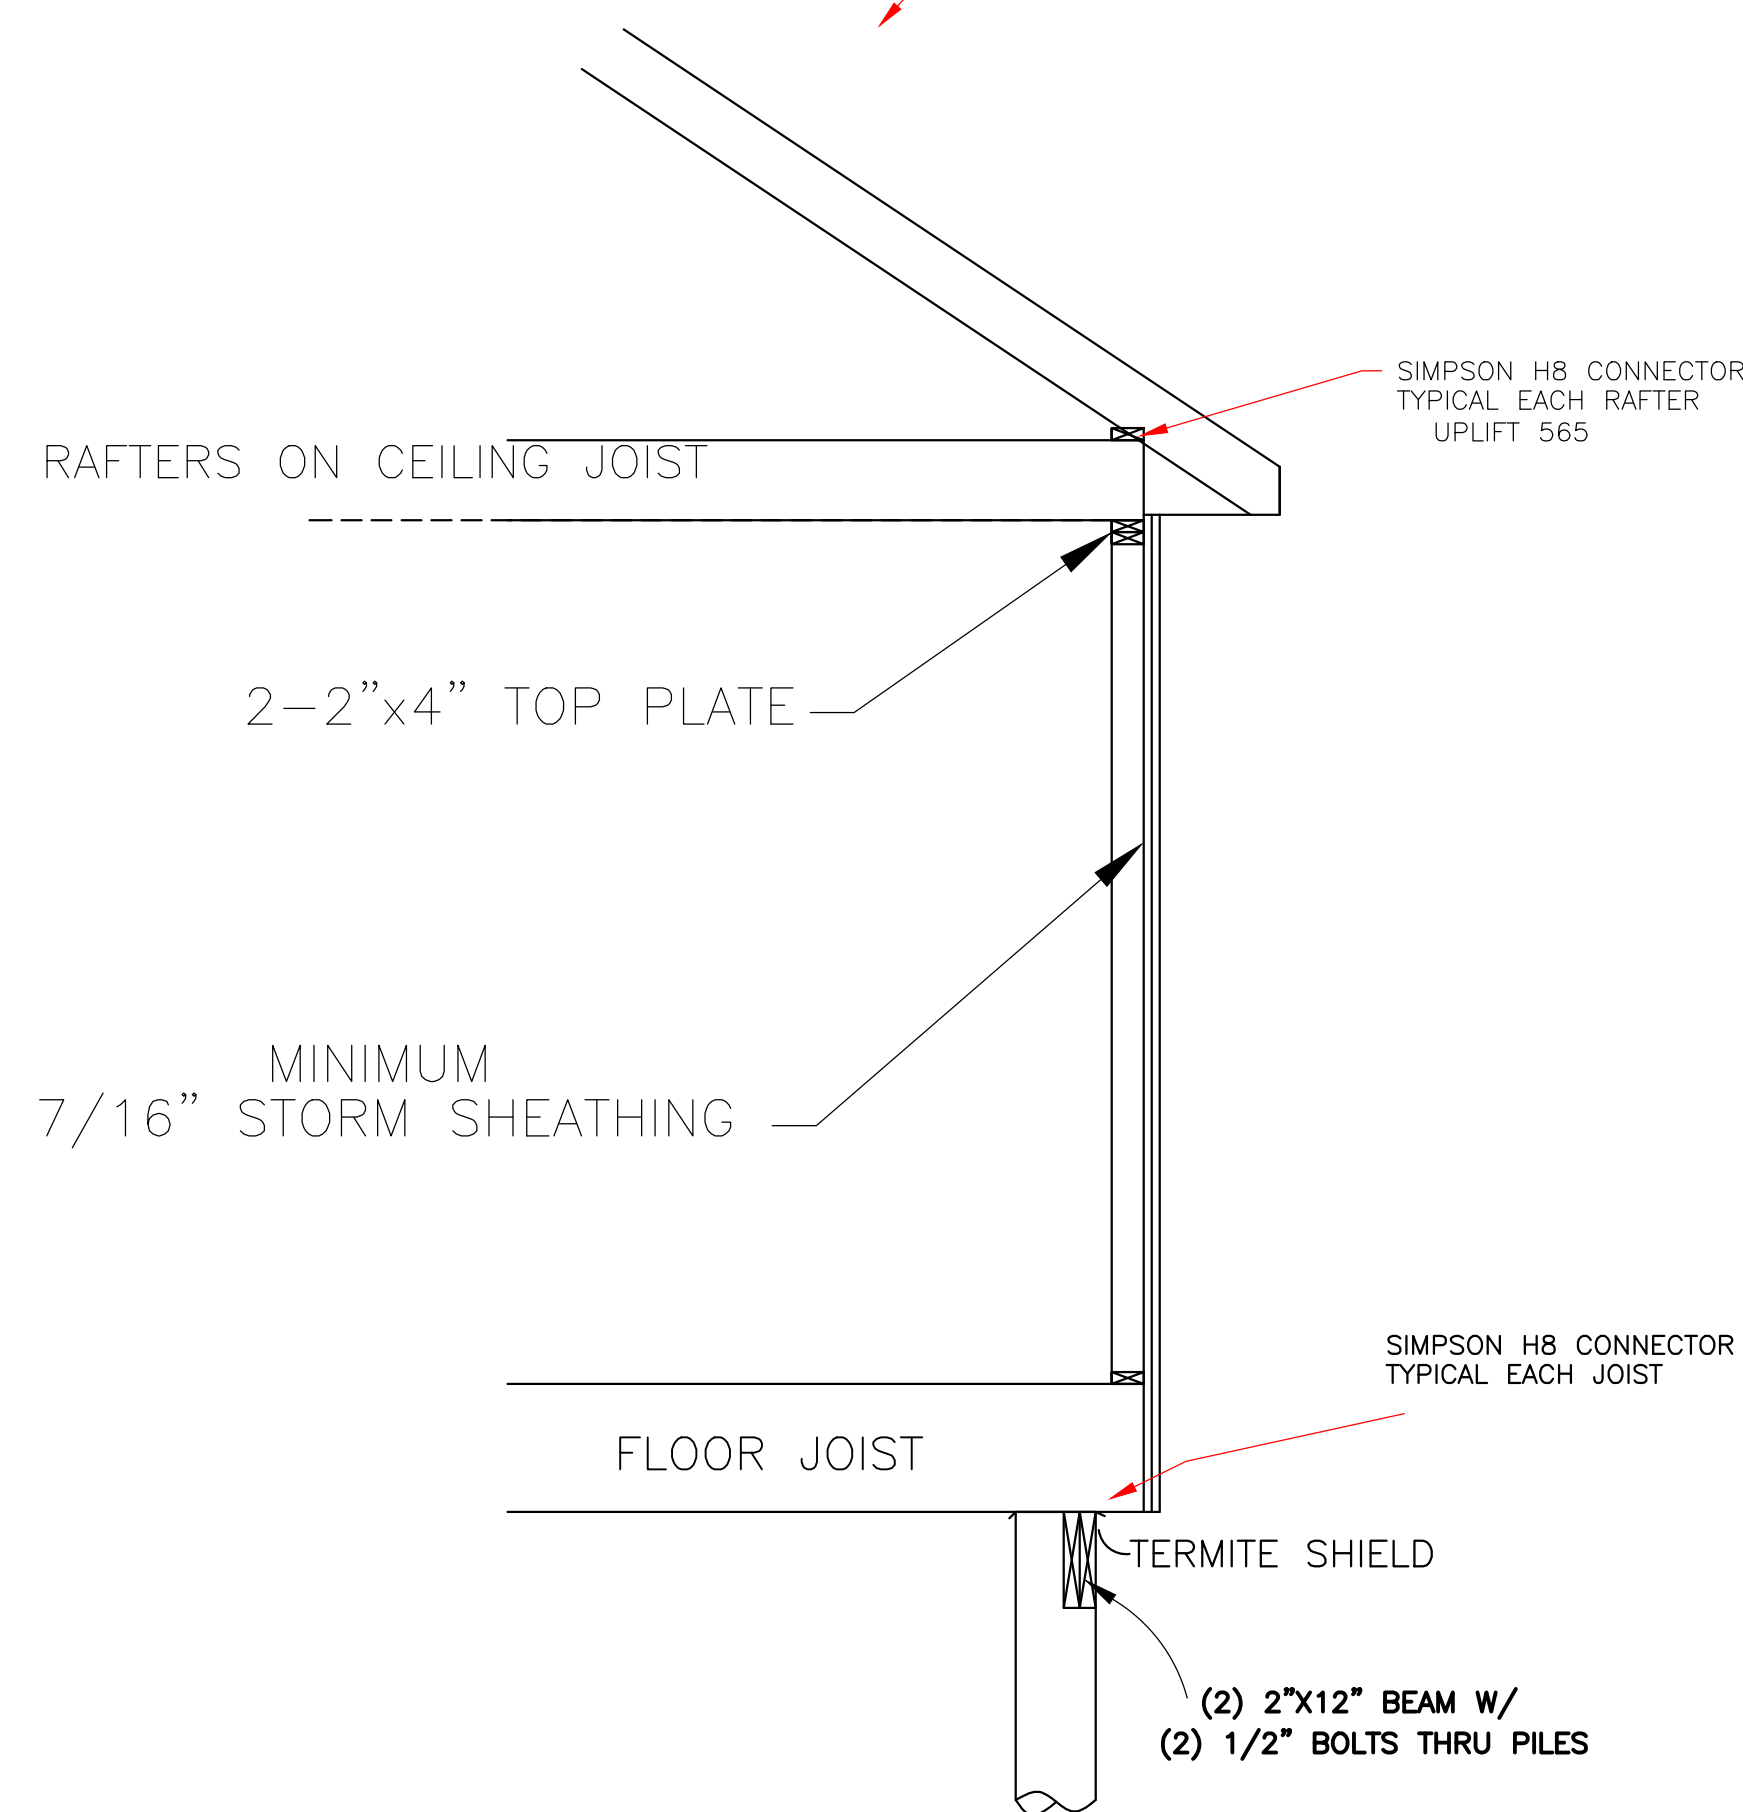


**CONTINUOUS LOAD PATH**  
1/2" SCALE


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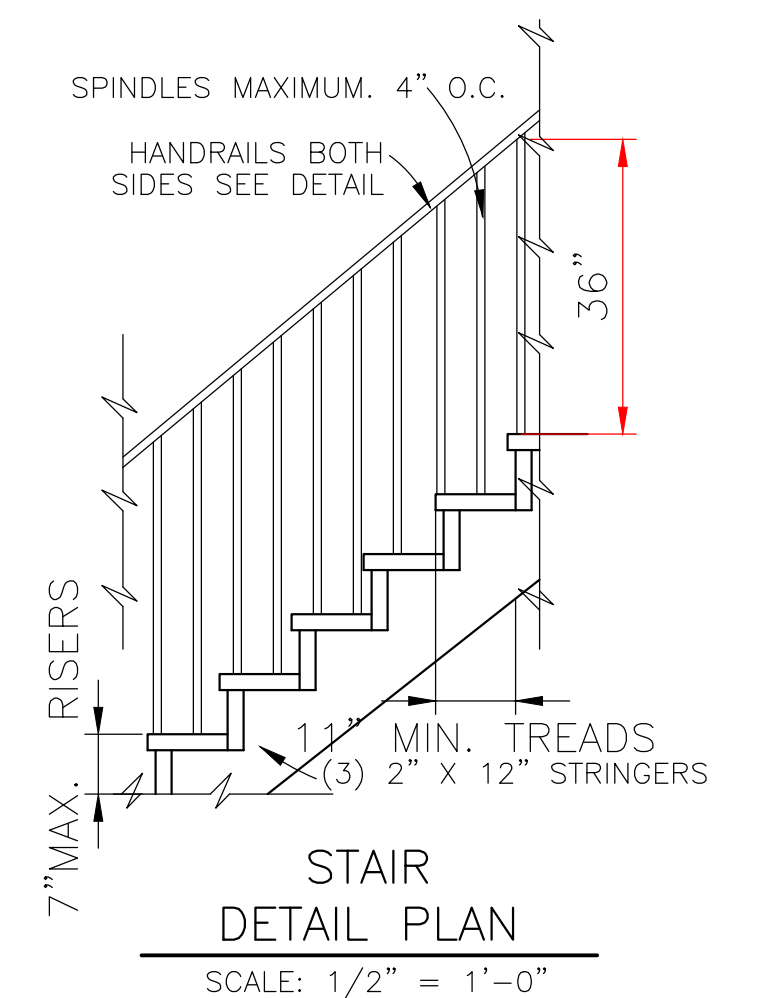
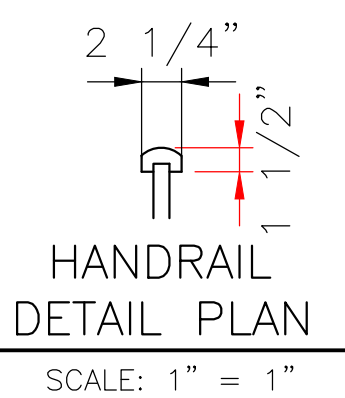
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**COLUMN SECTION**  
NOT TO SCALE



**TYPICAL EXTERIOR DOOR OR WINDOW HEADER**  
SCALE: 3/4" = 1'-0"

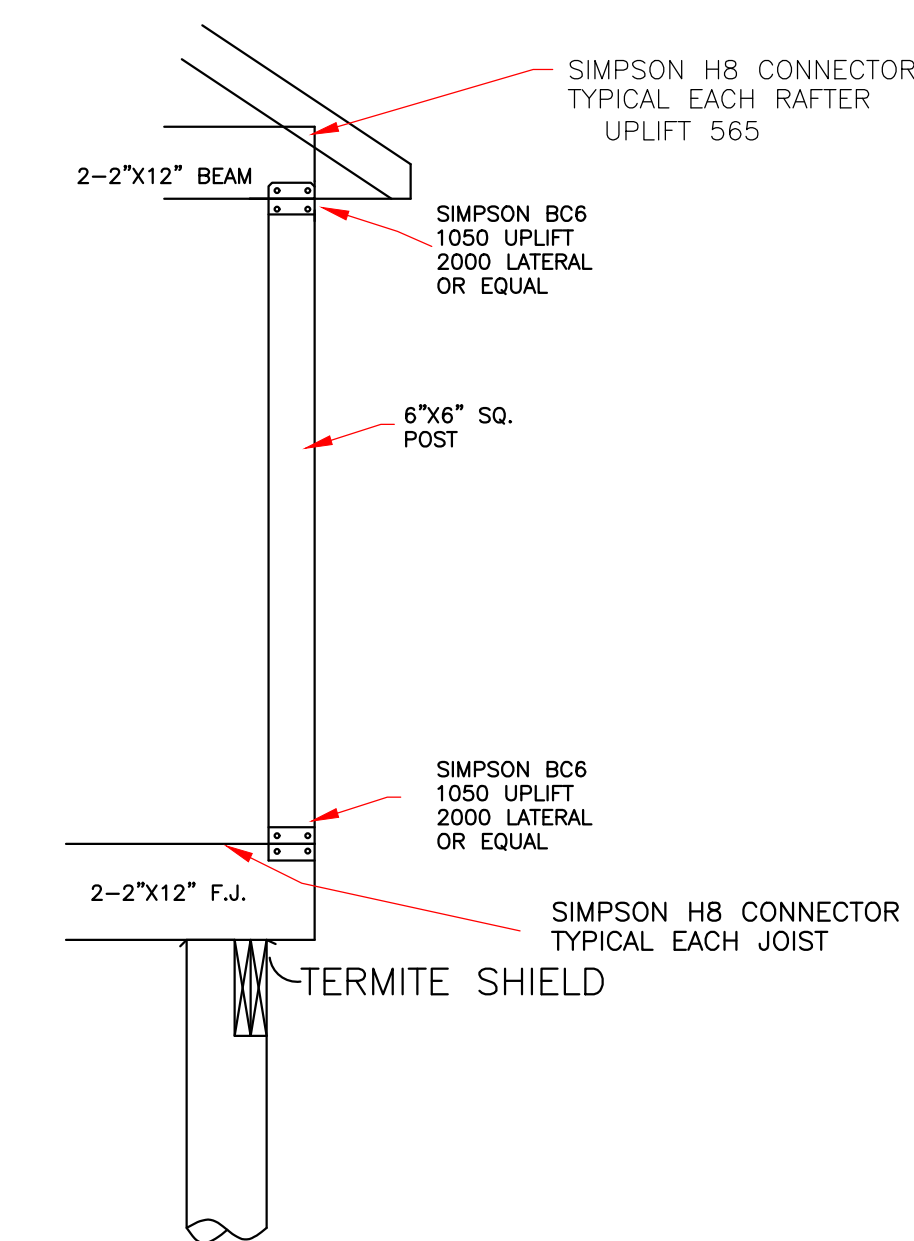

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		DATE 02/22/22	SHEET NO 6 OF 6
8307 LAFITTE CT. CHALMETTE, LA 70043 504-279-3508		JOB NO 8940	
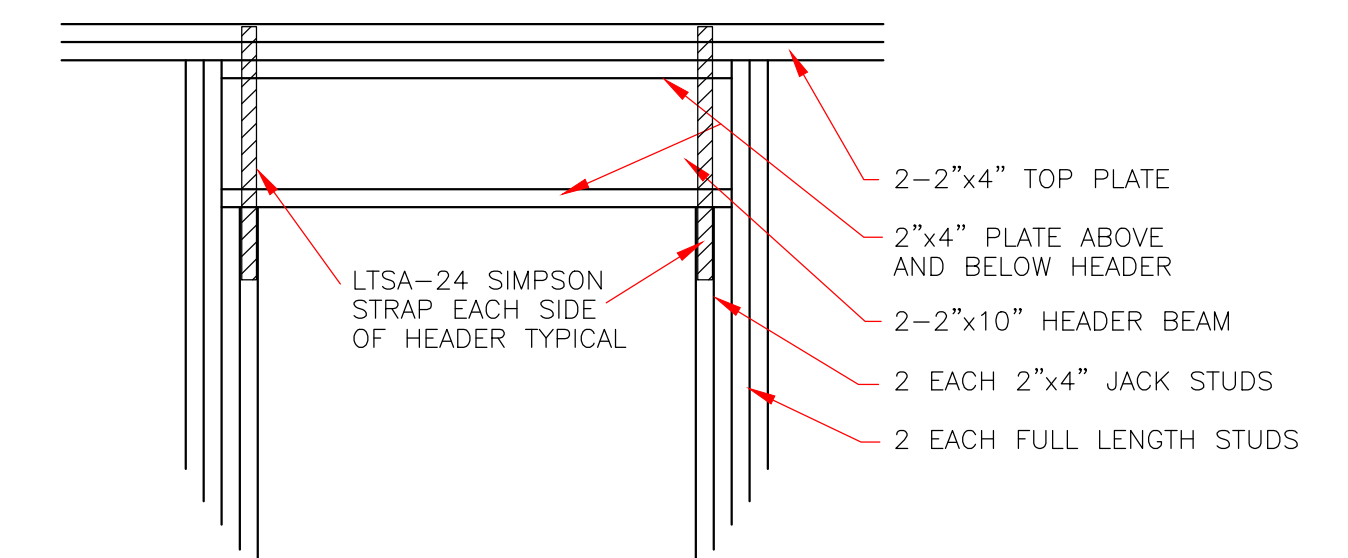
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