ROOM MATRIX - 12TH FLR           ROOM NUMBER         ROOM TYPE         ENLARGED SHE           1200         2BKK         2/P1.22           1201         2BKK         2/P1.22           1202         K1         1/P1.20           1203         K3         2/P1.23           1204         QQ1         4/P1.20           1205         K4         3/P1.23           1206         K1         1/P1.20	
1200 2BKK 2/P1.22 1201 2BKK 2/P1.22 1202 K1 1/P1.20 1203 K3 2/P1.23 1204 QQ1 4/P1.20 1205 K4 3/P1.23 1206 K1 1/P1.20	
1201 2BKK 2/P1.22 1202 K1 1/P1.20 1203 K3 2/P1.23 1204 QQ1 4/P1.20 1205 K4 3/P1.23 1206 K1 1/P1.20	ET#
1202     K1     1/P1.20       1203     K3     2/P1.23       1204     QQ1     4/P1.20       1205     K4     3/P1.23       1206     K1     1/P1.20	
1203 K3 2/P1.23 1204 QQ1 4/P1.20 1205 K4 3/P1.23 1206 K1 1/P1.20	
1204 QQ1 4/P1.20 1205 K4 3/P1.23 1206 K1 1/P1.20	
1205 K4 3/P1.23 1206 K1 1/P1.20	
1206 K1 1/P1.20	
1007	
1207 K4 3/P1.23	
1208 K1 1/P1.20	
1210 K1 1/P1.20	
1211 2BKQ1 2/P1.21	
1212 K1 1/P1.20	
1213 K1 1/P1.20	
1214 K1 1/P1.20	
1215 K4 3/P1.23	
1216 K2 2/P1.23	

REFER TO ENLARGE PLANS FOR SCOPE IF WORK INDICATED IN ROOMS AND ROOM TYPES INDICATED ABOVE.

# GENERAL SCOPE NOTES

PRIOR TO START OF WORK, CONTRACTOR SHALL COORDINATE SUPPLY SHUTDOWN WITH OWNER, INCLUDING ALL ROOMS TO BE AFFECTED.

2. THE EXISTING CONDITIONS ARE BASED ON
"AS-BUILT" DRAWINGS AND / OR LIMITED FIELD
VERIFICATIONS. THE CONTRACTOR SHALL
ADJUST TO ACTUAL FIELD CONDITIONS, ANY
DISCREPANCIES SHALL BE IMMEDIATELY
REPORTED TO THE ENGINEER FOR RESOLUTION.

HOMEWOOD SUITES by Hilton 901 Poydras Street New Orleans, LA






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No.	Description	Date
1	CONSTRUCTION	03/07
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Drawn By:	SE	
Checked By:	KD	
Project No.		
	1335	

Drawing Title


MECHANICAL 12TH FLOOR OVERALL PLAN

Drawing Scale:

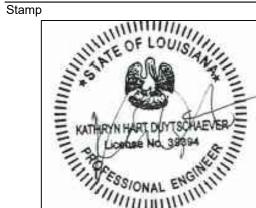


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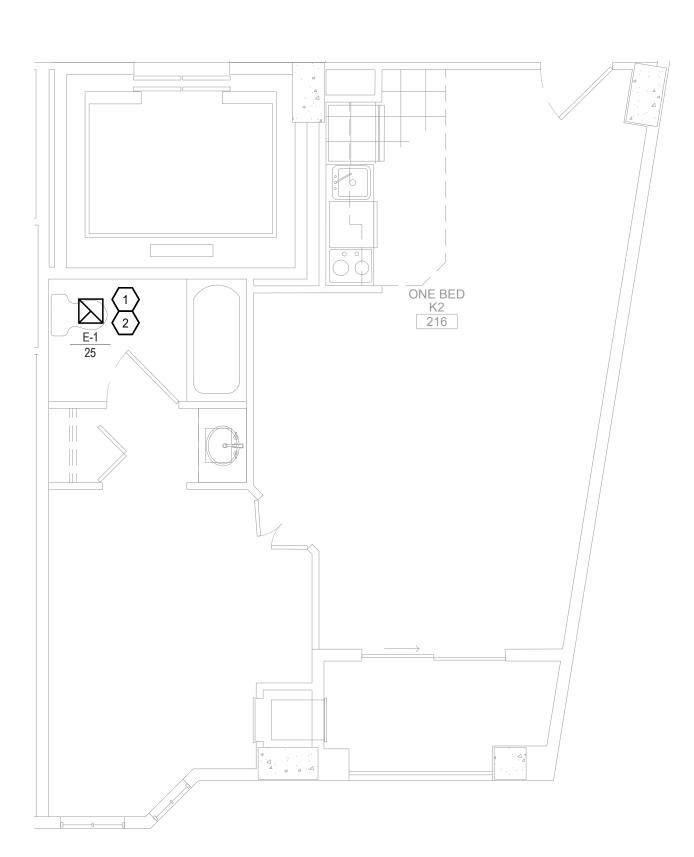
		4	8 9	11 12 15 16	18 19	21	24 25 28	29	32	lssu
A	S	STOR. 1222			ME ELI	CH EC				
			ONE BED  K3  1203  ONE BED  K4  1205		ONE BED K4 LOBBY 1217	ELEV	O BED ONE B SKQ1 211 121		ONE BED K4 1215	
A.7	CORR. 1221	STAIR X1							STAIR X2	
B						CORRIDOR 1215			ELEV	Drav Che
C3	TWO BED 2BKK 1200	ONE BED K1 1202	ONE BED QQ1 1204	ONE BED K1 1206	ONE BED K1 1208	ONE BED K1 1210	ONE BED K1 1212	ONE BED  K1  1214	ONE BED K2 1216	Proje
	LINEN 1220									
			/ //							
1	2 3	5 6	7 10	13 14	17 20	22 23	26 27	30 31	33 35	Star 36
					ANICAL OVERALL PLAN - 12TH FL					

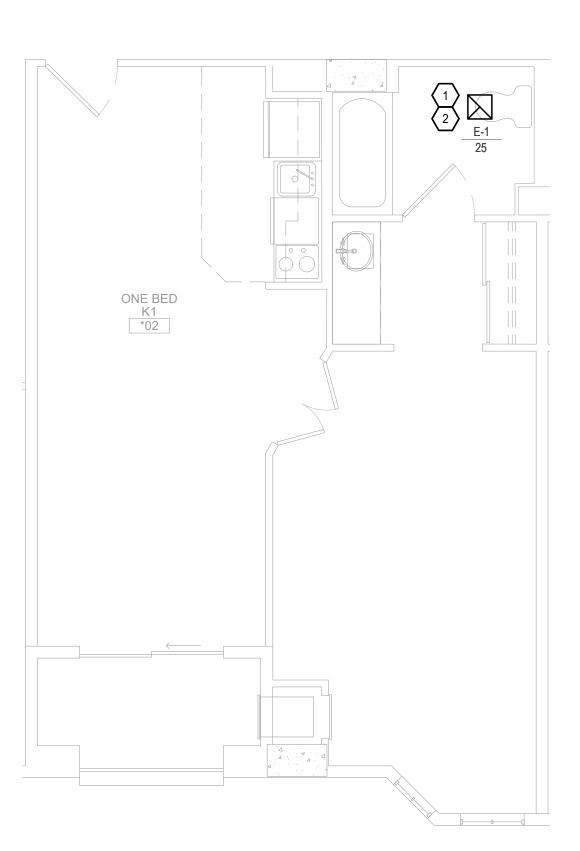

1 K1 - TYPICAL KING (RIGHT SHOWN) QTY: 24
SCALE: 1/4" = 1" RM 702 SHOWN LEFT QTY: 23

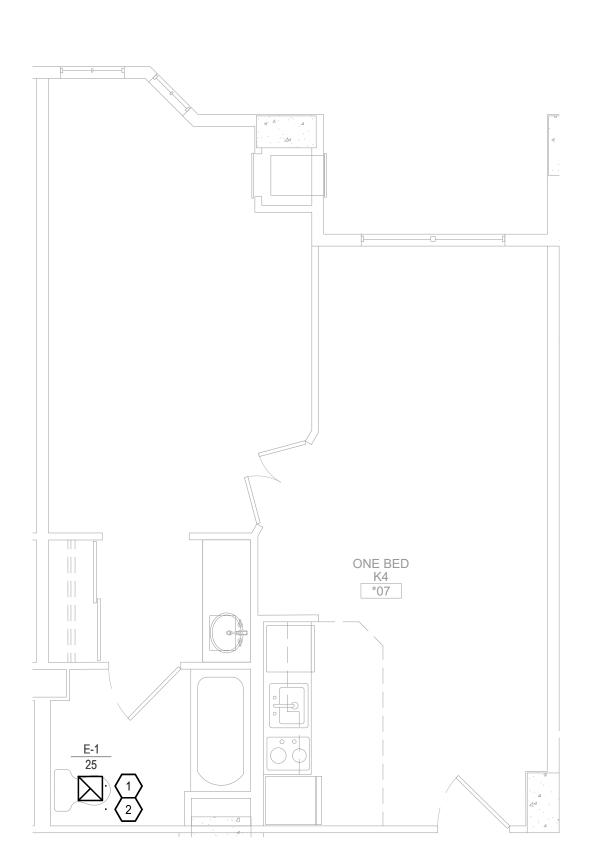


K4 - KING SCONCE AT SIDE WALL (RIGHT SHOWN) QTY: 12



2 K2 - KING W/ SLANTED WALL

SCALE: 1/4" = 1"

RM 216 SHOWN

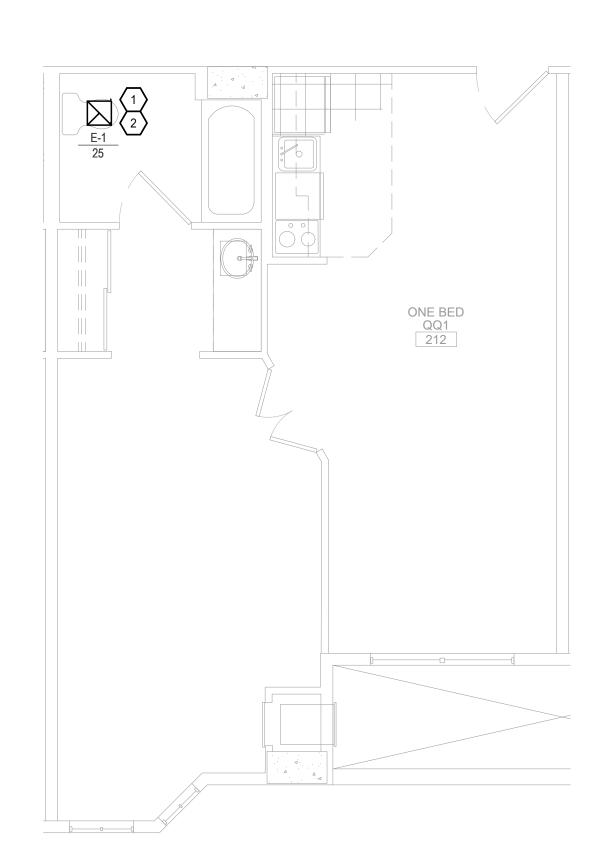

QQ1 - TYPICAL QUEEN/QUEEN (LEFT SHOWN) QTY: 19

# GENERAL SCOPE NOTES

- PRIOR TO START OF WORK, CONTRACTOR SHALL COORDINATE SUPPLY SHUTDOWN WITH OWNER, INCLUDING ALL ROOMS TO BE AFFECTED.
- 2. THE EXISTING CONDITIONS ARE BASED ON
  "AS-BUILT" DRAWINGS AND / OR LIMITED FIELD
  VERIFICATIONS. THE CONTRACTOR SHALL
  ADJUST TO ACTUAL FIELD CONDITIONS, ANY
  DISCREPANCIES SHALL BE IMMEDIATELY
  REPORTED TO THE ENGINEER FOR RESOLUTION.

# KEY NOTES

- REMOVE EXISTING EXHAUST FAN LOCATED IN GUEST ROOM, INCLUDING ALL ELECTRICAL WIRE BACK TO SOURCE. PROVIDE NEW BLANK OFF PLATE AT WALL. PREPARE AREA FOR INSTALLATION OF NEW E-1 (AMERICAN ALDES) ASSEMBLY.
- INSTALL NEW E-1 AUTOMATIC AIR BALANCING DIFFUSER IN PLACE OF EXISTING EXHAUST FAN. CONTRACTOR SHALL FIELD VERIFY EXISTING OPENING SIZE, CONSTRUCTION, AND CONNECTION SIZE PRIOR TO ORDER. COORDINATE FINAL E-1 ASSEMBLY WITH MANUFACTURER PRIOR TO ORDER. IT IS THE RESPONSIBILITY OF THE CONTRACTOR TO MAINTAIN ALL FIRE RATINGS AND PROVIDE A BALANCED FUNCTIONING SYSTEM.

Group One
PARTNERS
21 W 3rd St, Boston, MA 02127

HOMEWOOD SUITES by Hilton

901 Poydras Street New Orleans, LA



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	DOCUMENTS	2022
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Checked By: KD


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Drawing Title

MECHANICAL GUEST ROOM ENLARGED PLANS


1335

Drawing Scale

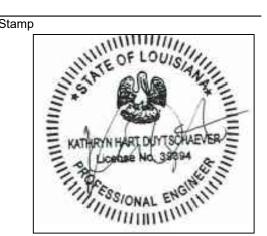

M1.20


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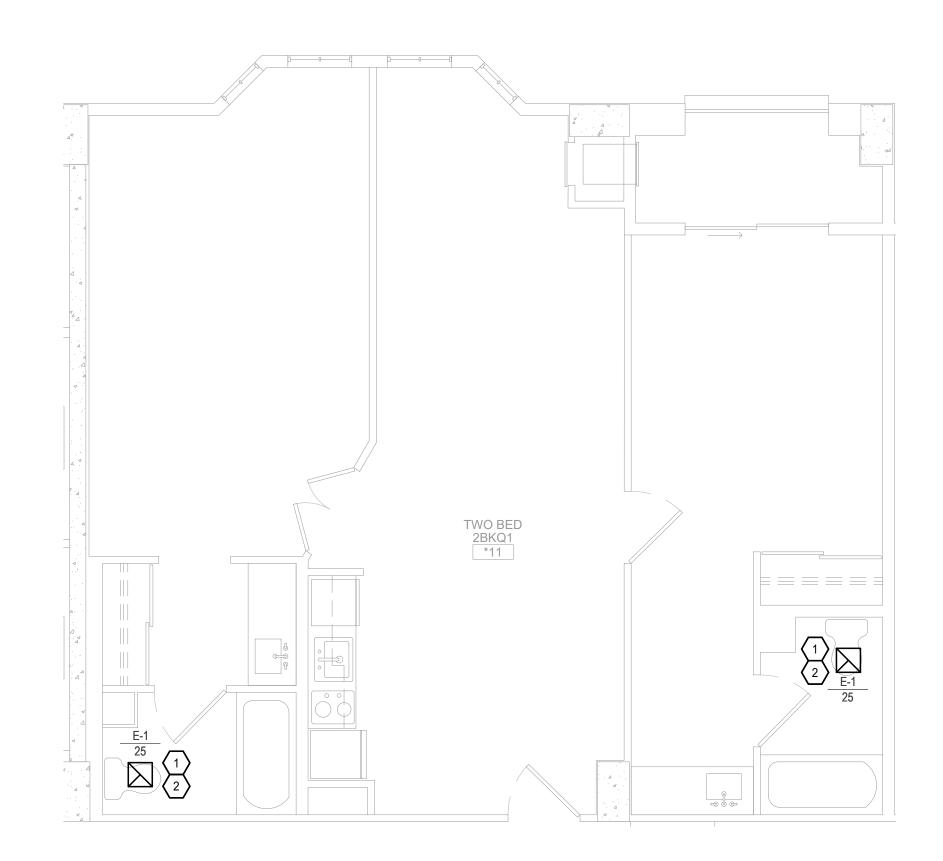


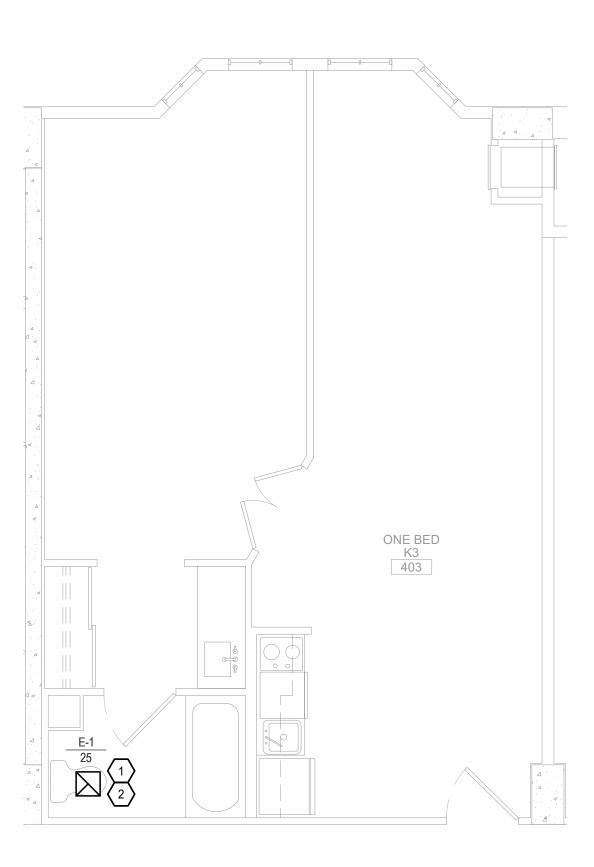1 K3 - KING LONG LIVING ROOM BAY


SCALE: 1/4" = 1"

RN



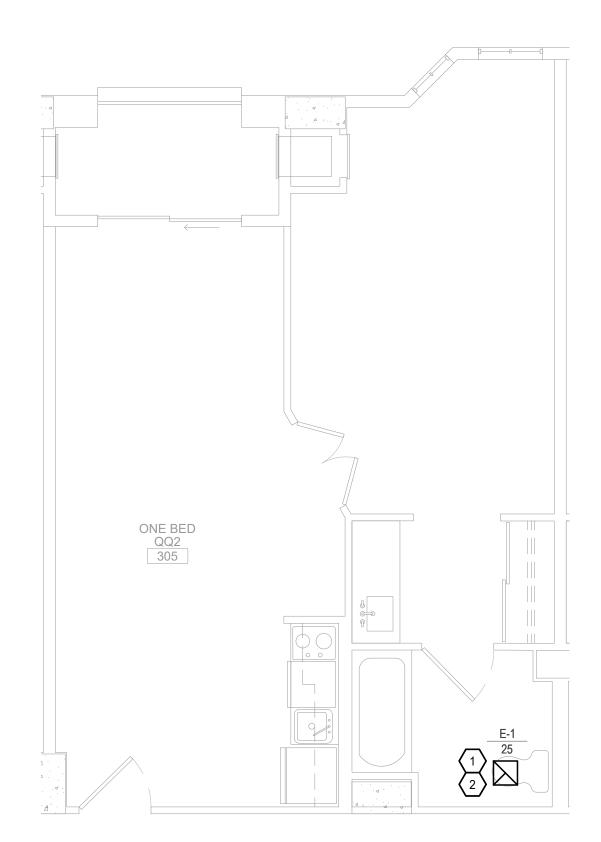

2 2BKQ1 - 2 BEDROOM KING/QUEEN
SCALE: 1/4" = 1"
RN

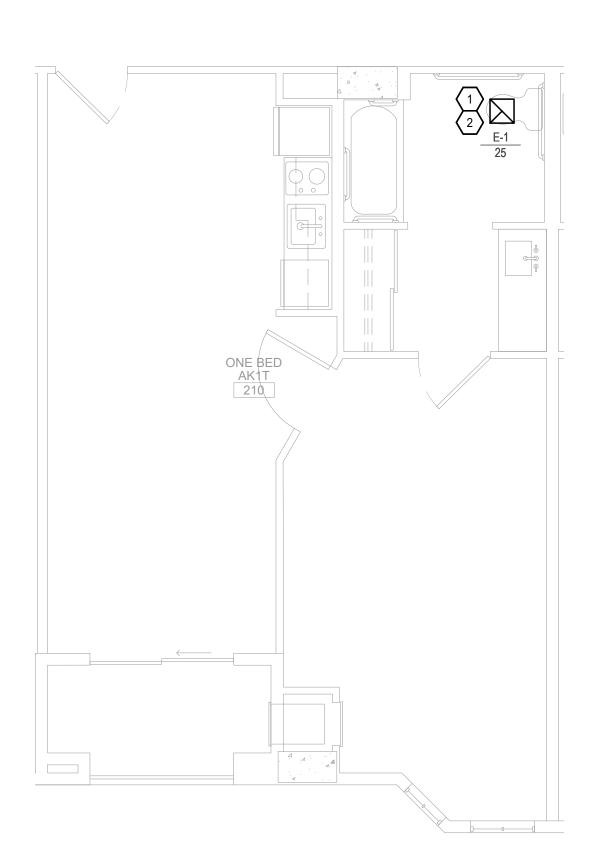

GENERAL SCOPE NOTES

PRIOR TO START OF WORK, CONTRACTOR SHALL COORDINATE SUPPLY SHUTDOWN WITH OWNER, INCLUDING ALL ROOMS TO BE AFFECTED.

THE EXISTING CONDITIONS ARE BASED ON "AS-BUILT" DRAWINGS AND / OR LIMITED FIELD VERIFICATIONS. THE CONTRACTOR SHALL ADJUST TO ACTUAL FIELD CONDITIONS, ANY DISCREPANCIES SHALL BE IMMEDIATELY REPORTED TO THE ENGINEER FOR RESOLUTION.

## **KEY NOTES**

REMOVE EXISTING EXHAUST FAN LOCATED IN GUEST ROOM, INCLUDING ALL ELECTRICAL WIRE BACK TO SOURCE. PROVIDE NEW BLANK OFF PLATE AT WALL. PREPARE AREA FOR INSTALLATION OF NEW E-1 (AMERICAN ALDES) ASSEMBLY.

INSTALL NEW E-1 AUTOMATIC AIR BALANCING DIFFUSER IN PLACE OF EXISTING EXHAUST FAN. CONTRACTOR SHALL FIELD VERIFY EXISTING OPENING SIZE, CONSTRUCTION, AND CONNECTION SIZE PRIOR TO ORDER. COORDINATE FINAL E-1 ASSEMBLY WITH MANUFACTURER PRIOR TO ORDER. IT IS THE RESPONSIBILITY OF THE CONTRACTOR TO MAINTAIN ALL FIRE RATINGS AND PROVIDE A BALANCED FUNCTIONING SYSTEM.

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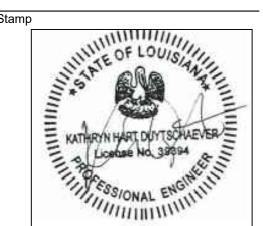
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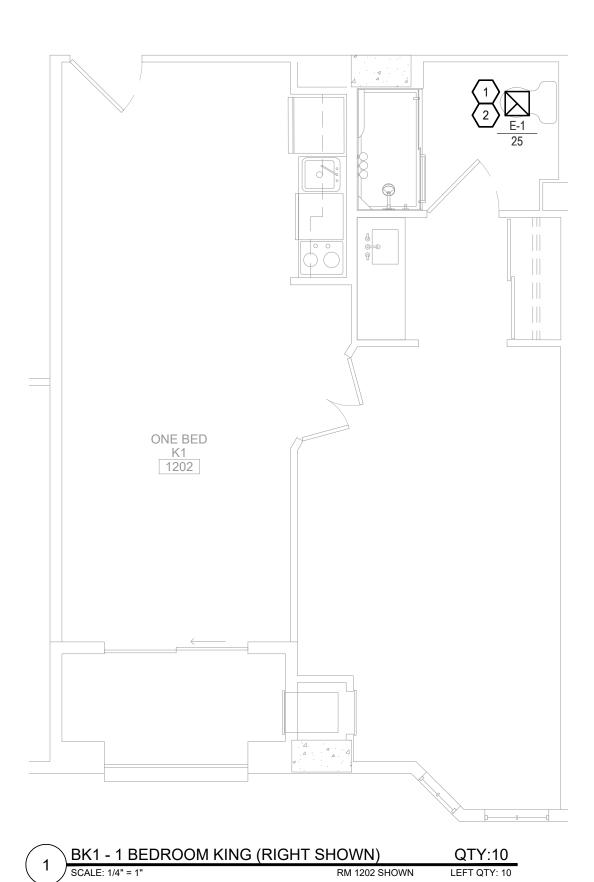
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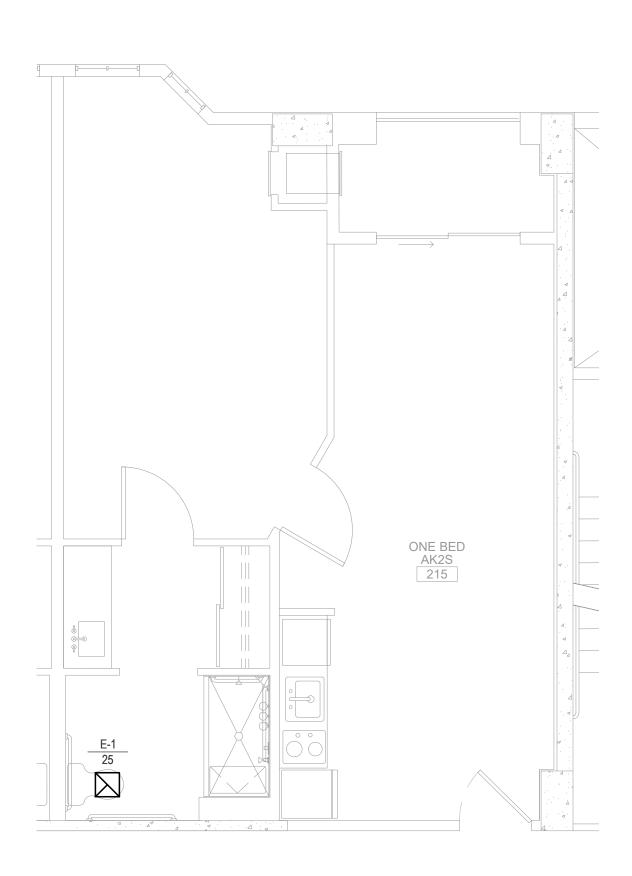
MECHANICAL **GUEST ROOM ENLARGED PLANS** 


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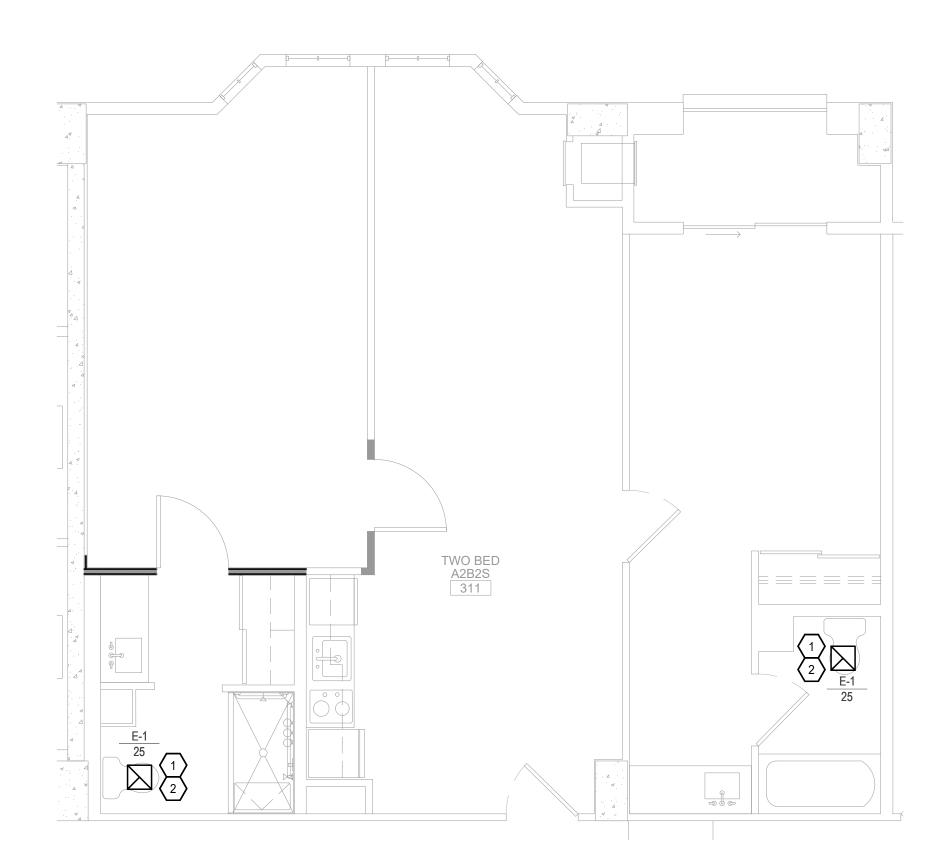
M1.21







2 2BKK - 2 BEDROOM KING/KING (RIGHT SHOWN) QTY:10
SCALE: 1/4" = 1" RM 1100 SHOWN LEFT QTY: 10

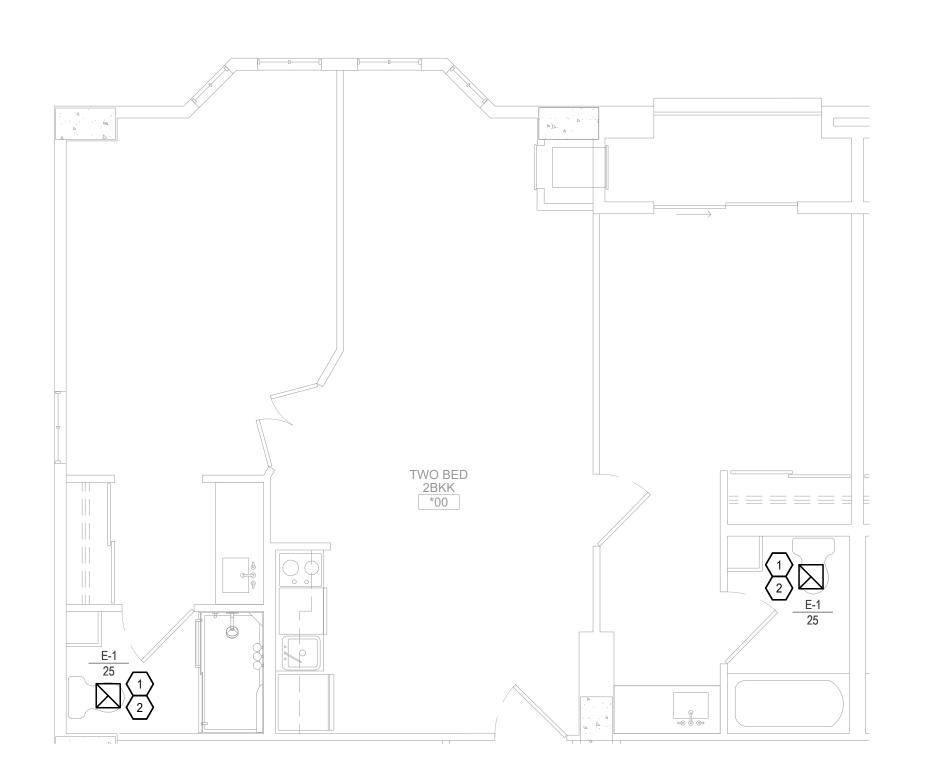

4 A2B2S - ACCESSIBLE 2 BEDROOM W/ SHOWER QTY: 1

SCALE: 1/4" = 1" RM 311 SHOWN A2B1T - SIMILAR - QTY: 1

GENERAL SCOPE NOTES

PRIOR TO START OF WORK, CONTRACTOR SHALL COORDINATE SUPPLY SHUTDOWN WITH OWNER, INCLUDING ALL ROOMS TO BE AFFECTED.

2. THE EXISTING CONDITIONS ARE BASED ON "AS-BUILT" DRAWINGS AND / OR LIMITED FIELD VERIFICATIONS. THE CONTRACTOR SHALL ADJUST TO ACTUAL FIELD CONDITIONS, ANY DISCREPANCIES SHALL BE IMMEDIATELY REPORTED TO THE ENGINEER FOR RESOLUTION.

## KEY NOTES

- 1. REMOVE EXISTING EXHAUST FAN LOCATED IN GUEST ROOM, INCLUDING ALL ELECTRICAL WIRE BACK TO SOURCE. PROVIDE NEW BLANK OFF PLATE AT WALL. PREPARE AREA FOR INSTALLATION OF NEW E-1 (AMERICAN ALDES) ASSEMBLY.
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HOMEWOOD SUITES by Hilton

901 Poydras Street New Orleans, LA





Issuance

No. Description

1	CONSTRUCTION	03/07
	DOCUMENTS	2022

Date


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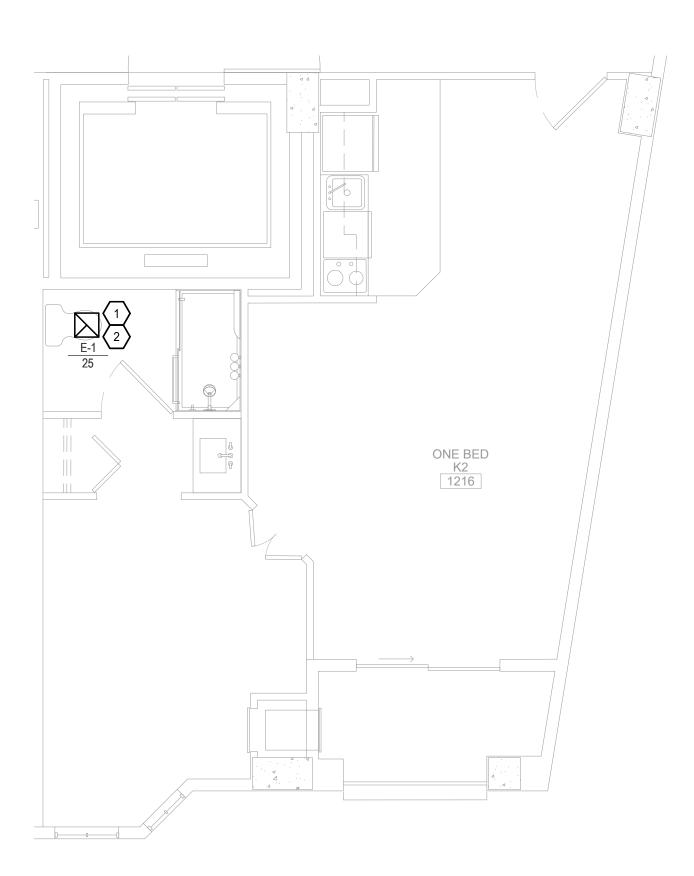
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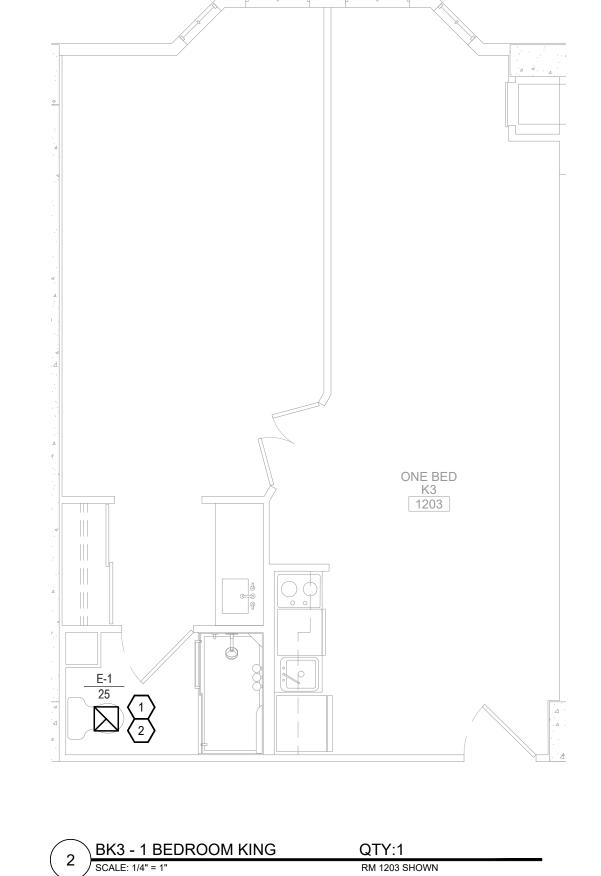
MECHANICAL GUEST ROOM ENLARGED PLANS


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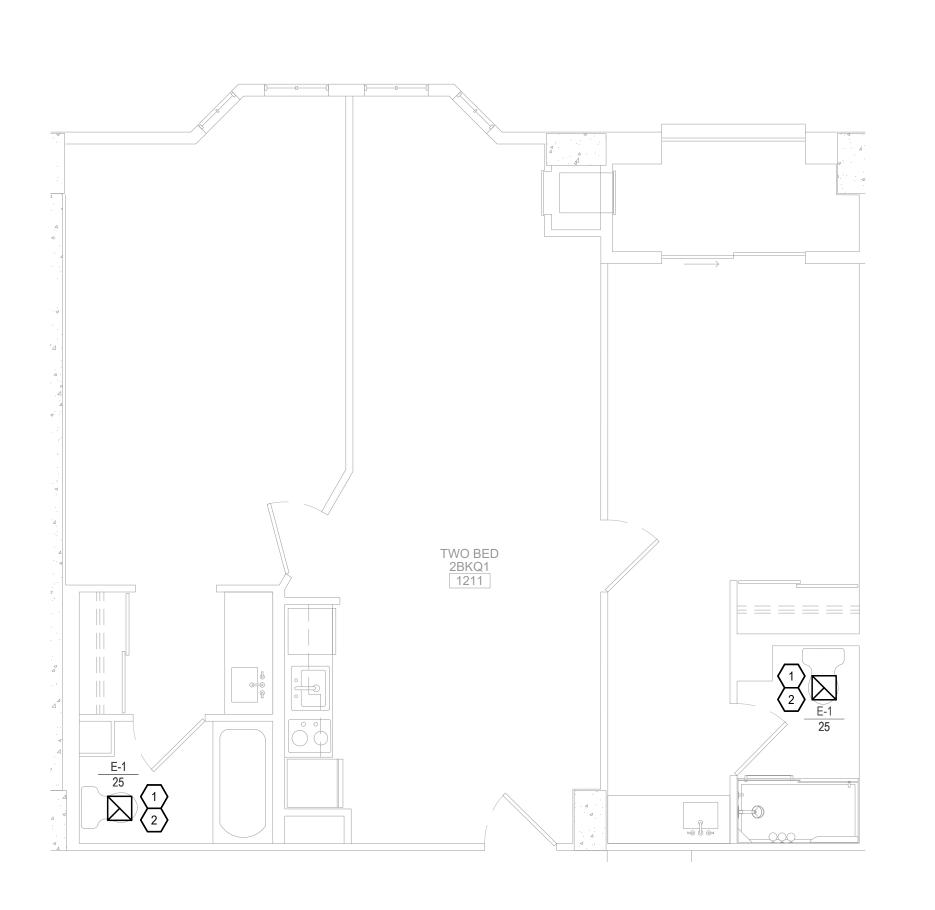


M1.22





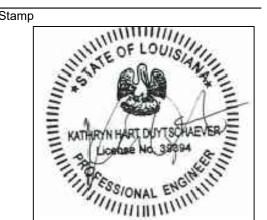

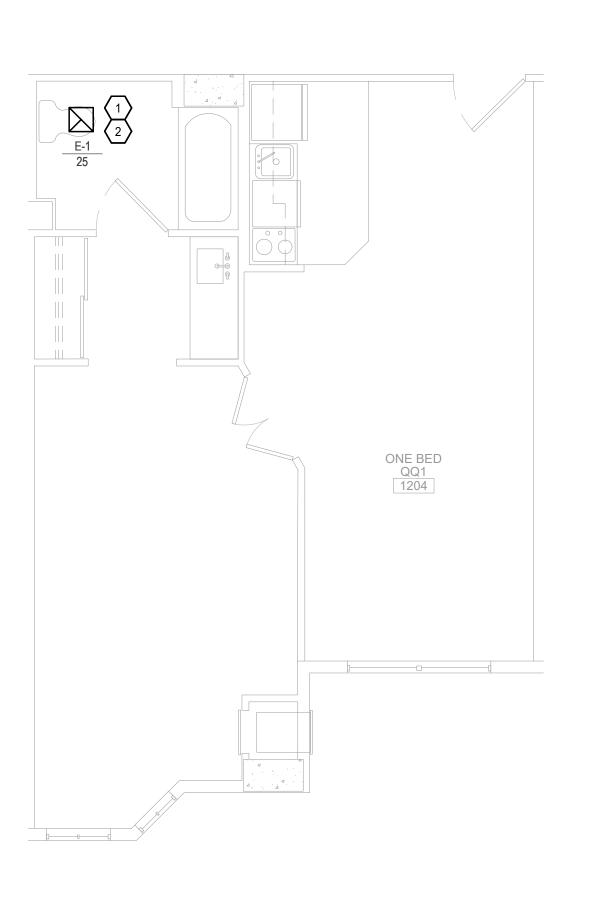

5 2BKQ1 - TWO BEDRROM KING / QUEEN

SCALE: 1/4" = 1"

# GENERAL SCOPE NOTES

- PRIOR TO START OF WORK, CONTRACTOR SHALL
- COORDINATE SUPPLY SHUTDOWN WITH OWNER, INCLUDING ALL ROOMS TO BE AFFECTED. THE EXISTING CONDITIONS ARE BASED ON

### "AS-BUILT" DRAWINGS AND / OR LIMITED FIELD VERIFICATIONS. THE CONTRACTOR SHALL ADJUST TO ACTUAL FIELD CONDITIONS, ANY DISCREPANCIES SHALL BE IMMEDIATELY REPORTED TO THE ENGINEER FOR RESOLUTION.

# **KEY NOTES**

- REMOVE EXISTING EXHAUST FAN LOCATED IN GUEST ROOM, INCLUDING ALL ELECTRICAL WIRE BACK TO SOURCE. PROVIDE NEW BLANK OFF PLATE AT WALL. PREPARE AREA FOR INSTALLATION OF NEW E-1 (AMERICAN ALDES) ASSEMBLY.
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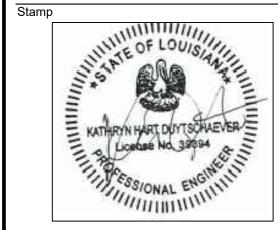


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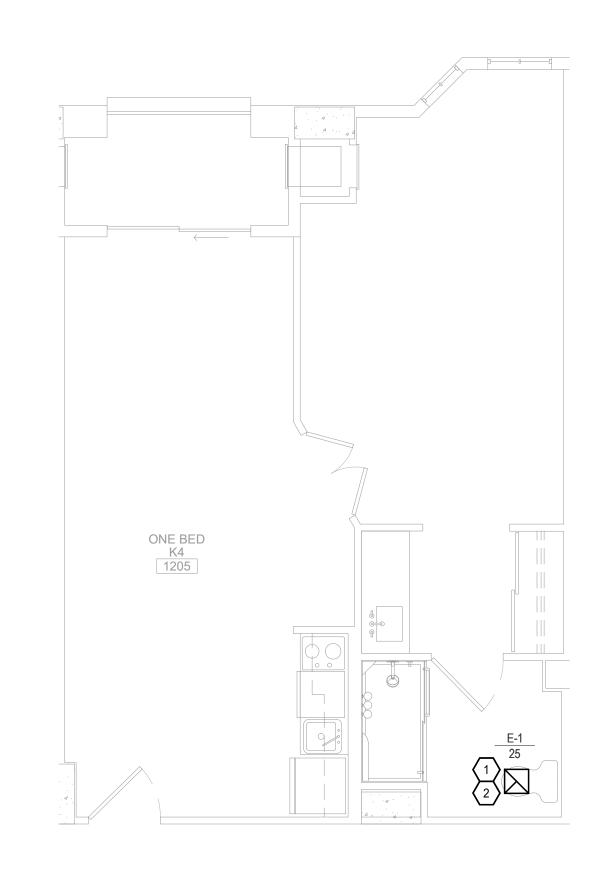
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Checked By:	KD	
Project No.	1335	

Drawing Title

MECHANICAL **GUEST ROOM ENLARGED PLANS** 



M1.23




3 BK4 - KING W/ SHOWER QTY:3

SCALE: 1/4" = 1" RM 1205 SHOWN

BK2 - 1 BEDROOM KING SCALE: 1/4" = 1"

QQ1 - QUEEN/QUEEN QTY: 1

SCALE: 1/4" = 1" RM 311 SHOWN

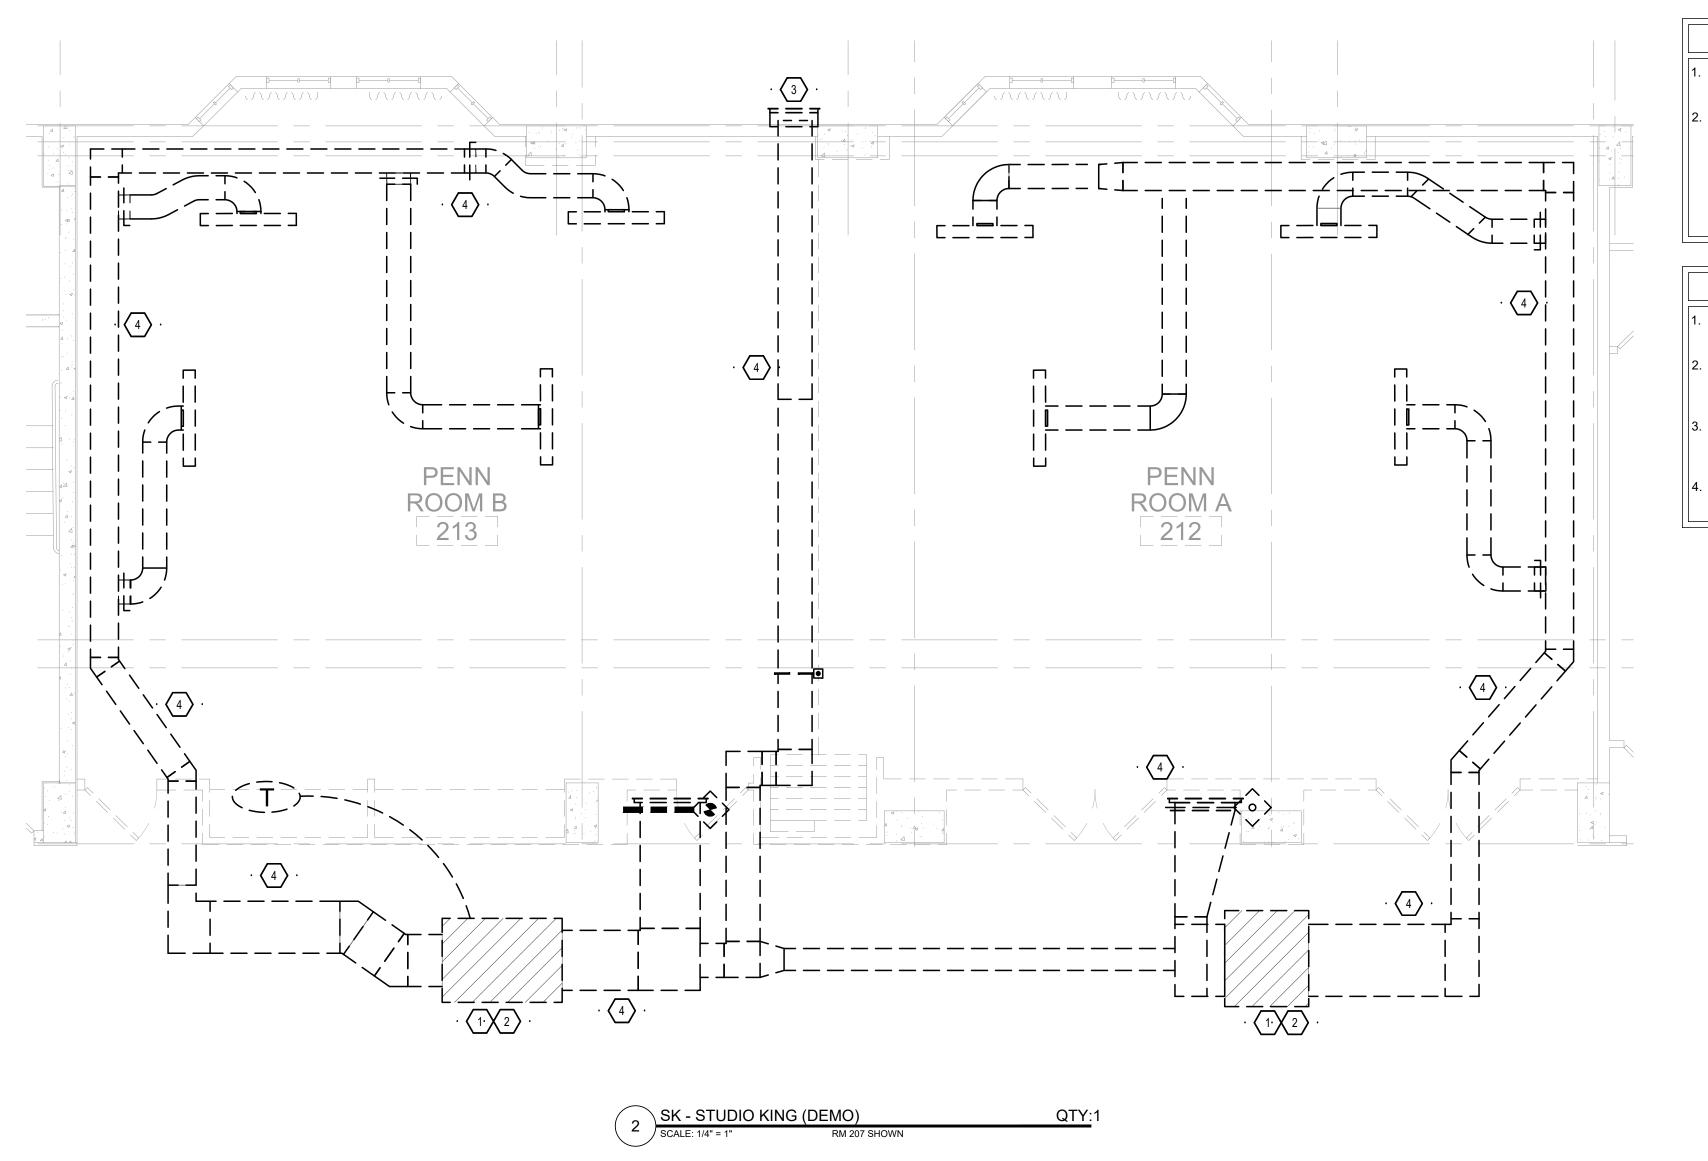

CONTRACTOR SHALL REPAIR EXISTING ENVELOPING TO MATCH EXISTING.

THE EXISTING CONDITIONS ARE BASED ON "AS-BUILT" DRAWINGS AND / OR LIMITED FIELD VERIFICATIONS. THE CONTRACTOR SHALL ADJUST TO ACTUAL FIELD CONDITIONS, ANY DISCREPANCIES SHALL BE IMMEDIATELY REPORTED TO THE ENGINEER FOR RESOLUTION.

# DEMO PLAN KEY NOTES

REMOVE EXISTING FAN COIL AND EXISTING DUCT AS SHOWN.

- CONTRACTOR SHALL LOCATE AND PREPARE EXISTING CHILLED WATER SUPPLY AND RETURN PIPING FOR NEW CONNECTION.
- EXISTING LOUVER TO BE REMOVED AND EXISTING WALL OPENING TO BE REPAIRED TO LIKE NEW CONDITION.
- REMOVE AND DISCARD EXISTING DUCT AND DUCT ACCESSORIES SHOWN ON PLANS.+

GENERAL SCOPE NOTES

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Issuance


1 CONSTRUCTION 03/07 DOCUMENTS 2022	No.	Description	Date
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		DOCUMENTS	2022


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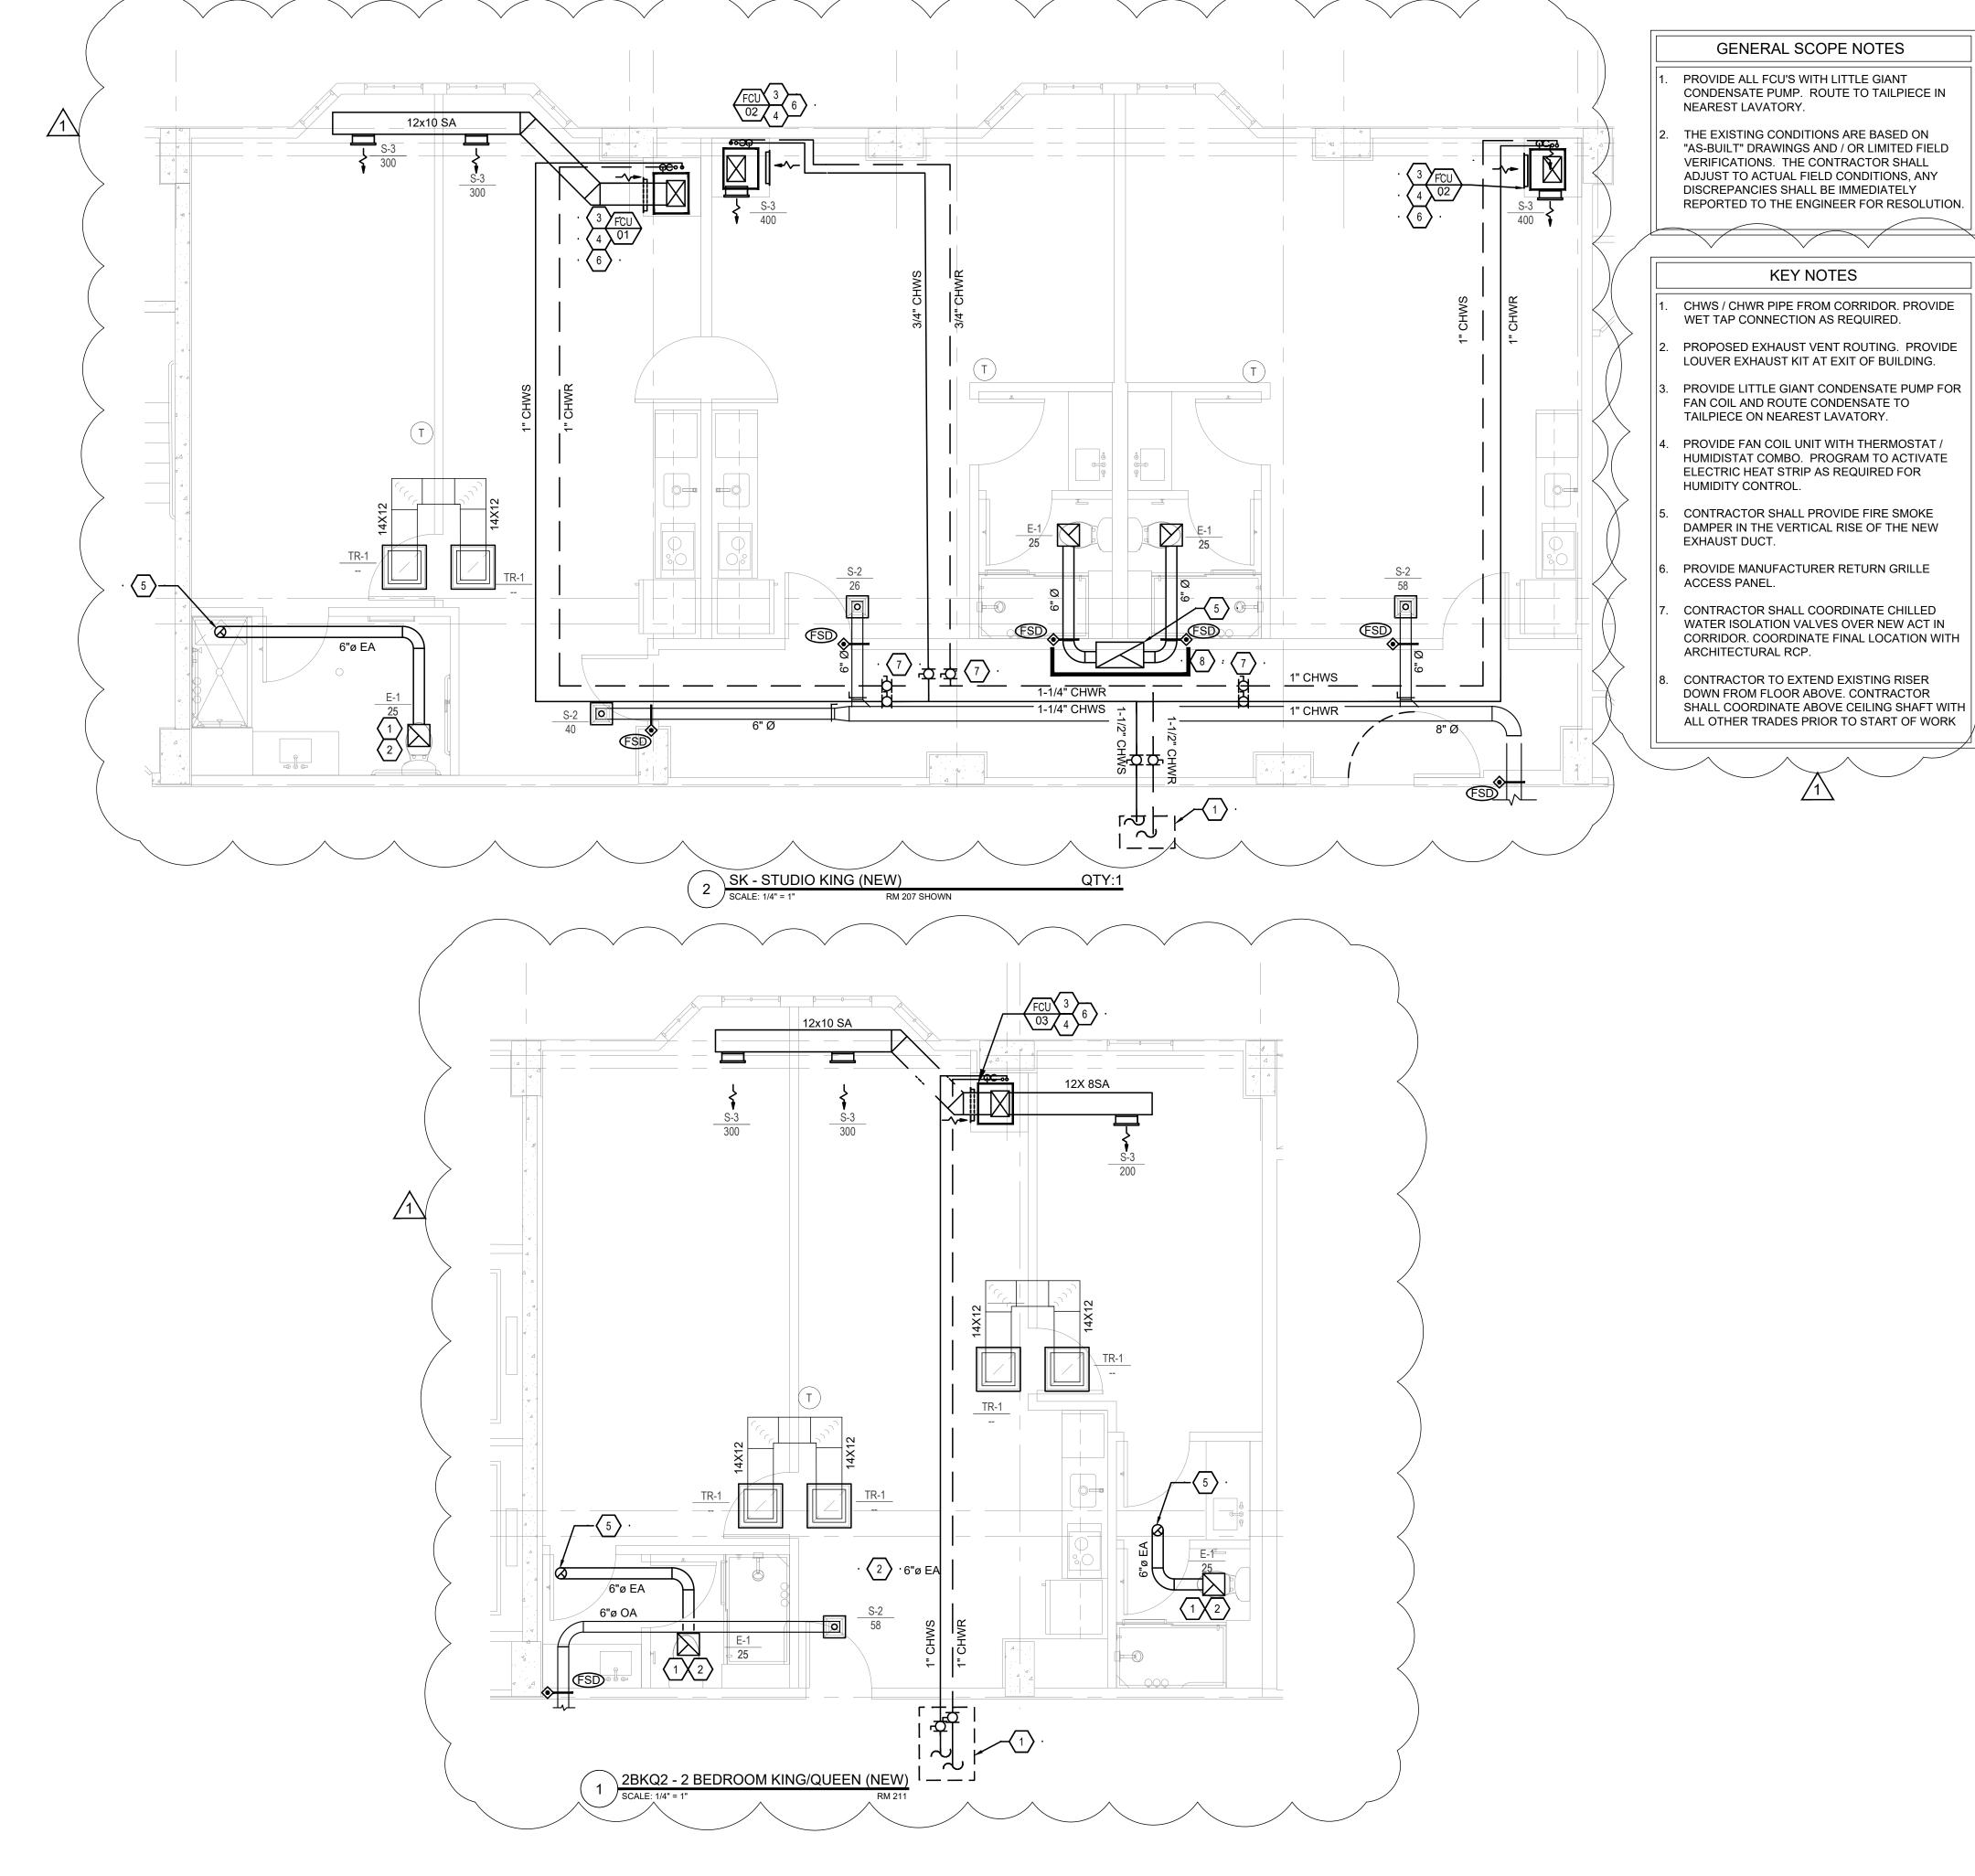
Drawing Title

MECHANICAL GUEST ROOM DEMO **ENLARGED PLANS** 

1335



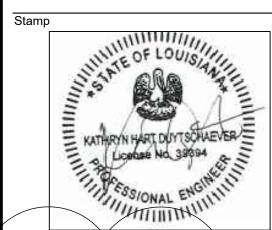

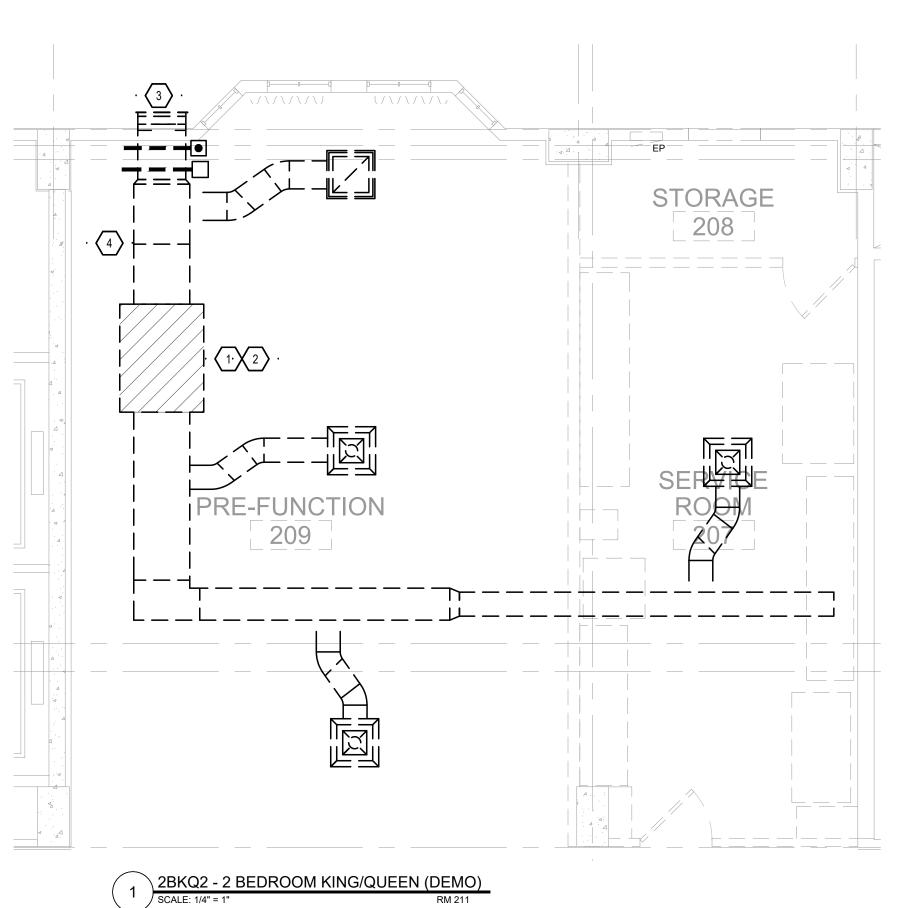

HOMEWOOD SUITES by Hilton CONDENSATE PUMP. ROUTE TO TAILPIECE IN

901 Poydras Street New Orleans, LA

21 W 3rd St, Boston, MA 02127



2420 Lakemont Ave | Suite 320 | Orlando, FL 32814 T: 407.678.2055 : www.rtmec.com


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	DOCUMENTS	2022


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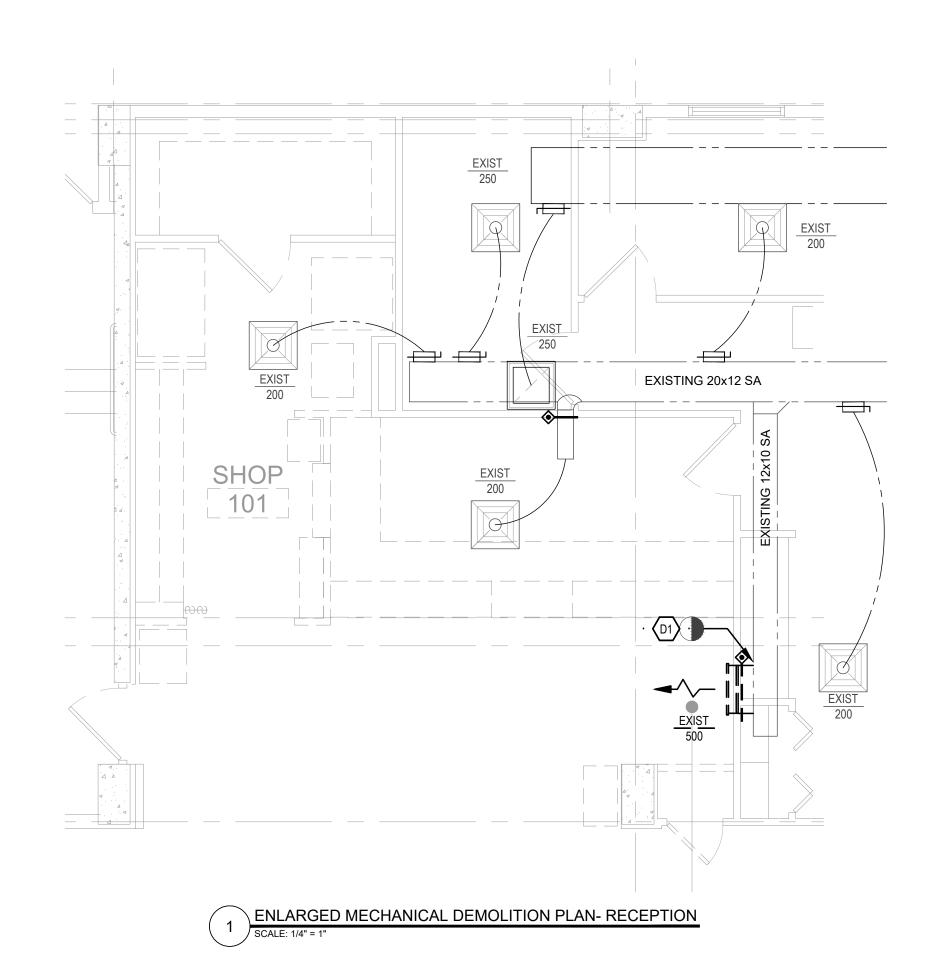
Drawing Title

MECHANICAL **GUEST ROOM ENLARGED PLANS** 

1335



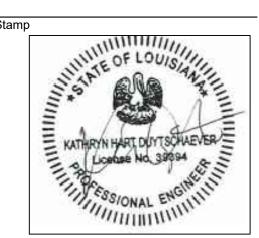

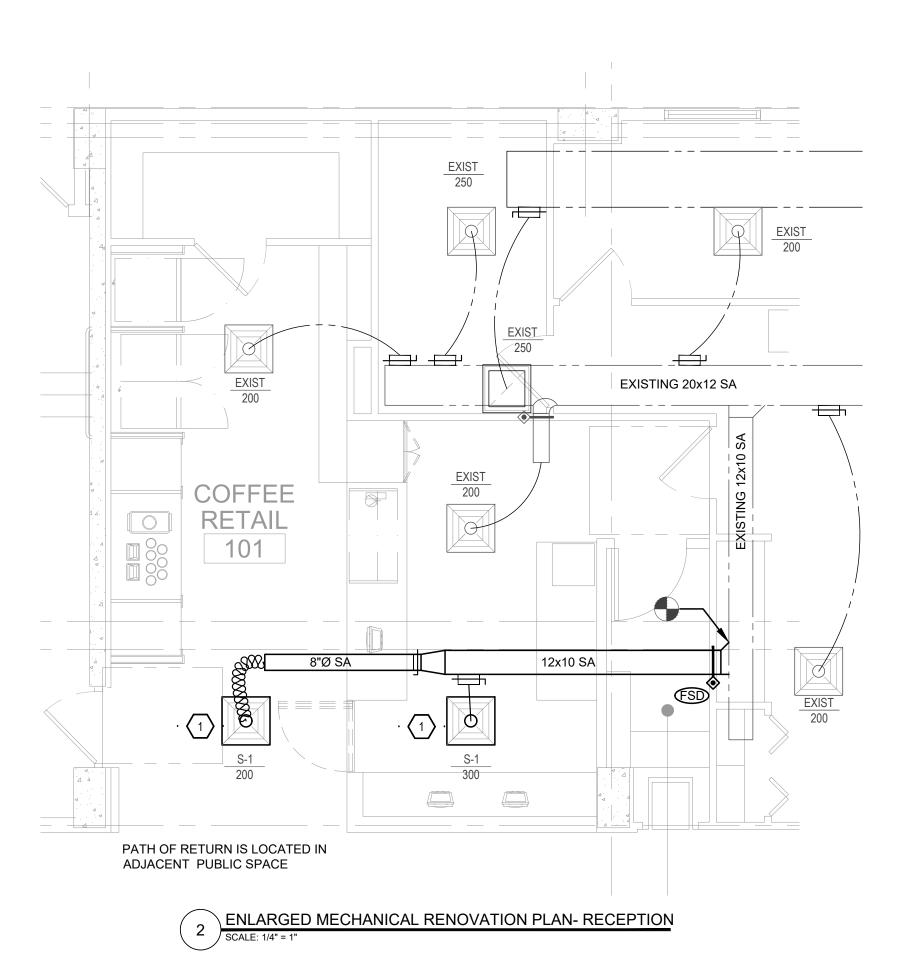

# GENERAL SCOPE NOTES

1. THE EXISTING CONDITIONS ARE BASED ON
"AS-BUILT" DRAWINGS AND / OR LIMITED FIELD
VERIFICATIONS. THE CONTRACTOR SHALL
ADJUST TO ACTUAL FIELD CONDITIONS, ANY
DISCREPANCIES SHALL BE IMMEDIATELY
REPORTED TO THE ENGINEER FOR RESOLUTION.

# KEY NOTES

1. PROVIDE NEW 24X24 DIFFUSERS. COORDINATE EXACT LOCATION WITH NEW ARCHITECTURAL RCP.

# DEMOLITION KEY NOTES

CONTRACTOR SHALL REMOVE SIDE WALL GRILLE AND EXISTING FIRE SMOKE DAMPER. PREPARE AND REPAIR EXISTING DUCT FOR NEW CONNECTION.

Proje

HOMEWOOD SUITES by Hilton<sup>\*</sup> 901 Poydras Street New Orleans, LA





No. Description Date
1 CONSTRUCTION 03/07
DOCUMENTS 2022

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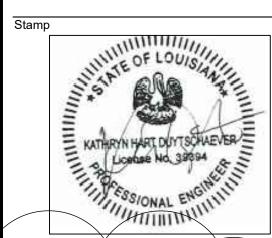
Project No.

Drawing Title

MECHANICAL 1ST FLOOR RECEPTION PLAN

1335

Drawing Scale:




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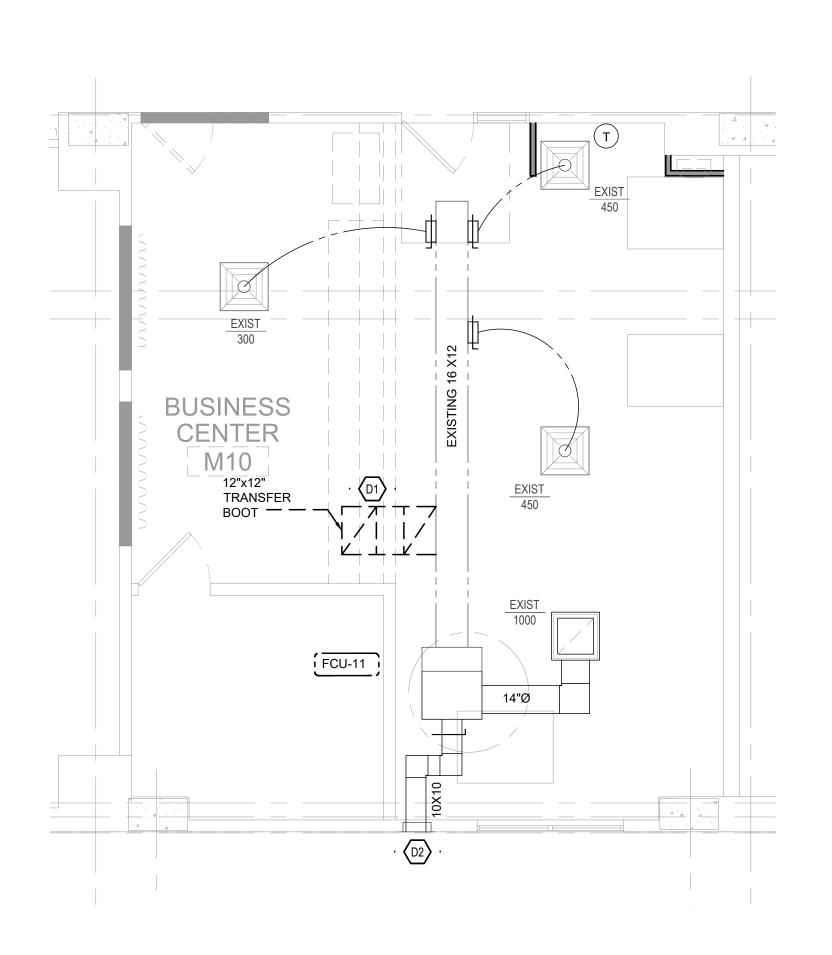
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r 2013 GROUP ONE PARTNERS, INC.

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1 ENLARGED MECHANICAL DEMOLITION PLAN- FINTESS CENTER
SCALE: 1/4" = 1"

# GENERAL SCOPE NOTES

- PROVIDE ALL FCU'S WITH LITTLE GIANT
   CONDENSATE PUMP. ROUTE TO TAILPIECE IN
   NEAREST LAVATORY.
- 2. THE EXISTING CONDITIONS ARE BASED ON
  "AS-BUILT" DRAWINGS AND / OR LIMITED FIELD
  VERIFICATIONS. THE CONTRACTOR SHALL
  ADJUST TO ACTUAL FIELD CONDITIONS, ANY
  DISCREPANCIES SHALL BE IMMEDIATELY
  REPORTED TO THE ENGINEER FOR RESOLUTION.

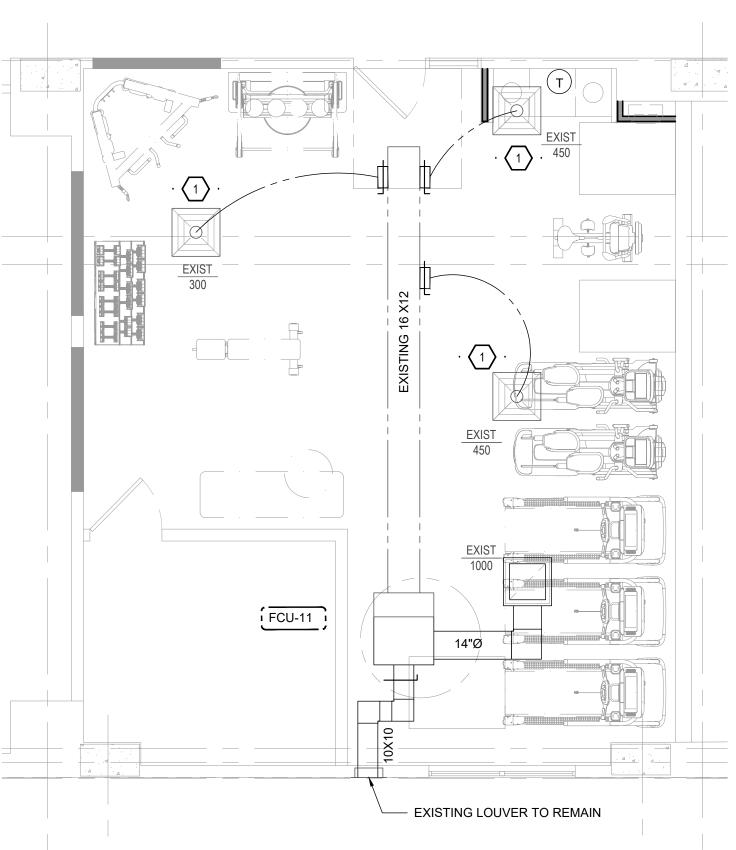

**KEY NOTES** 

CONTRACTOR SHALL RELOCATE EXISTING DIFFUSERS TO MATCH NEW ARCHITECTURAL RCP.





Issuance

No.	Description	Date
1	CONSTRUCTION	03/07
	DOCUMENTS	2022
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SE

Checked By:

KD


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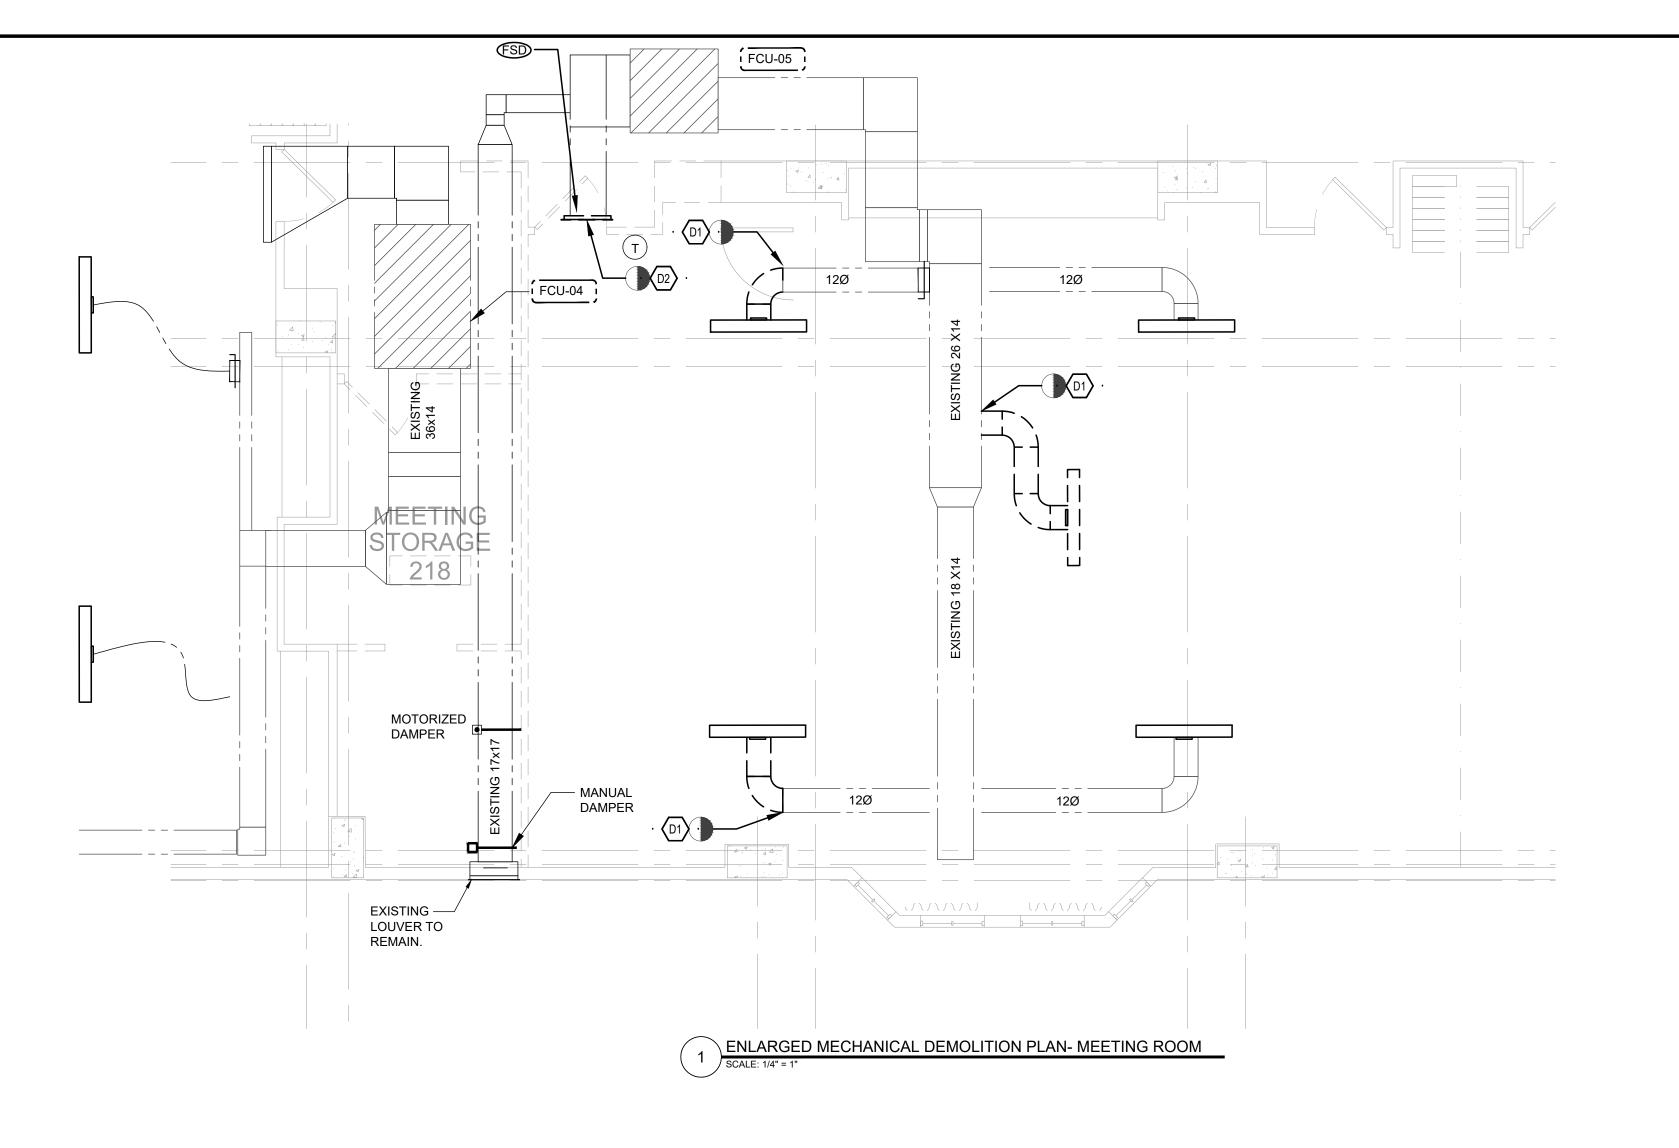
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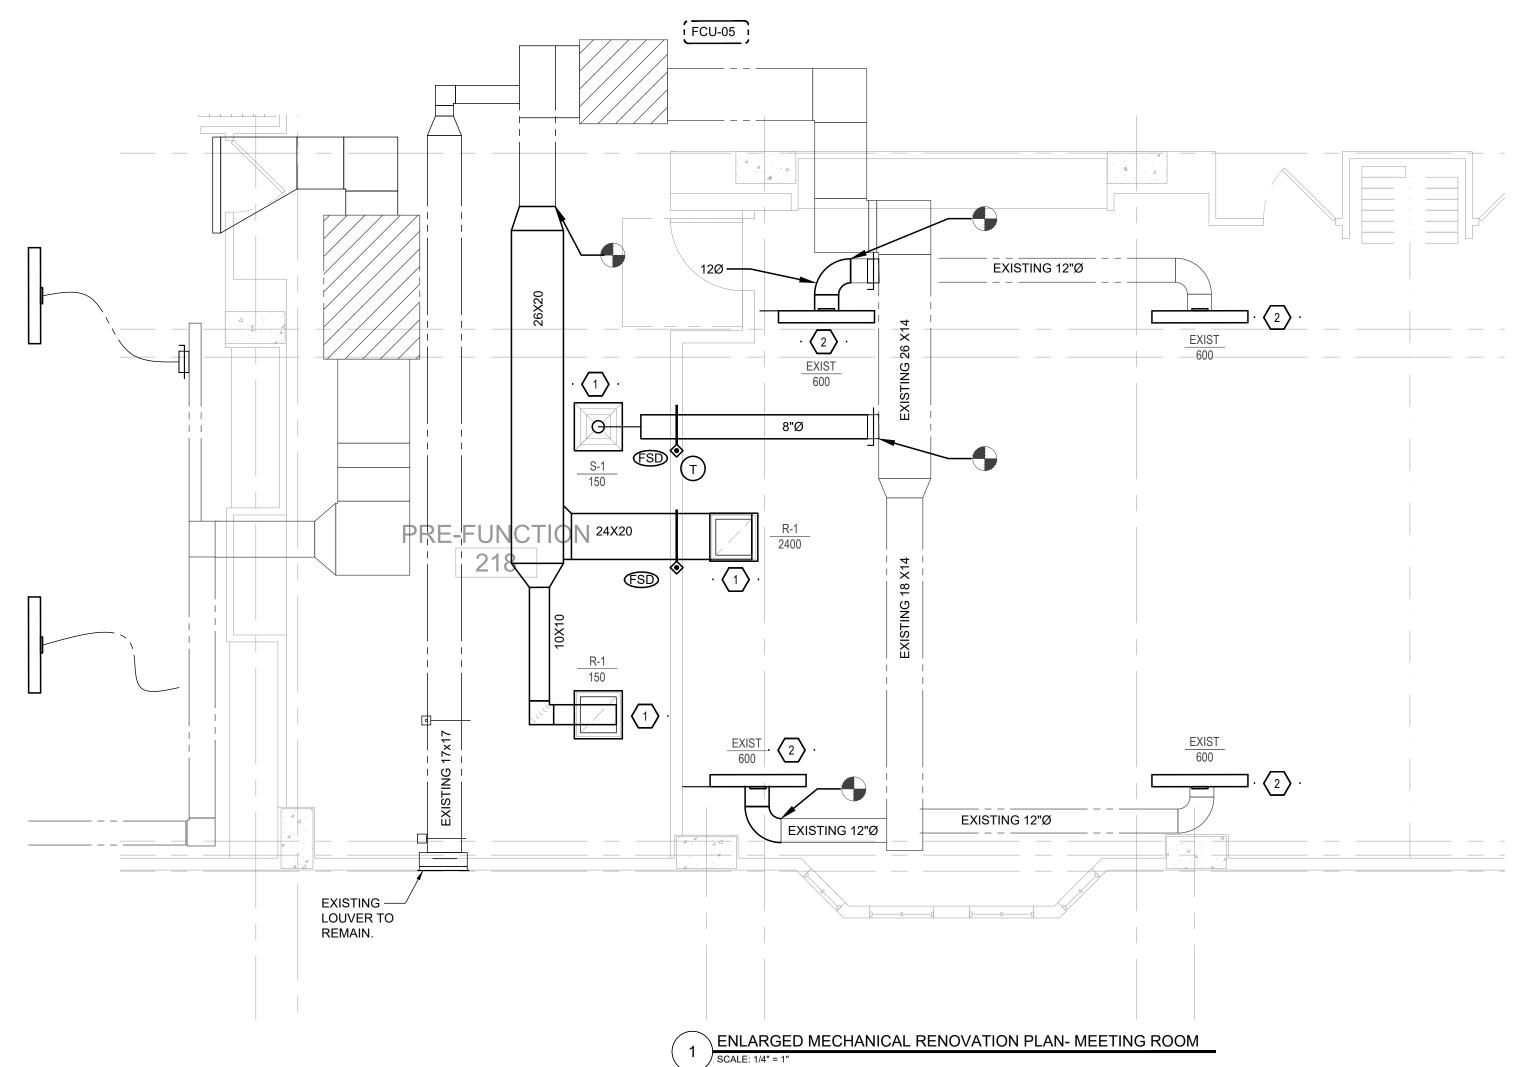
MECHANICAL FITNESS CENTER PLAN

Drawing Scale:



M1.26



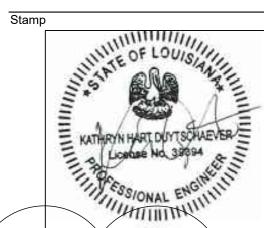

# GENERAL SCOPE NOTES

1. THE EXISTING CONDITIONS ARE BASED ON
"AS-BUILT" DRAWINGS AND / OR LIMITED FIELD
VERIFICATIONS. THE CONTRACTOR SHALL
ADJUST TO ACTUAL FIELD CONDITIONS, ANY
DISCREPANCIES SHALL BE IMMEDIATELY
REPORTED TO THE ENGINEER FOR RESOLUTION.

# **KEY NOTES**

- PROVIDE NEW 24X24 DIFFUSERS. COORDINATE EXACT LOCATION WITH NEW ARCHITECTURAL
- 2. RELOCATE EXISTING LINIER DIFFUSER TO MATCH NEW ARCHITECTURAL RCP.

# DEMOLITION KEY NOTES

- CONTRACTOR SHALL REMOVE REQUIRED DUCT
   WORK TO RELOCATE EXISTING LINIER DIFFUSER.
- CONTRACTOR TO REMOVE EXISTING SIDEWALL RETURN GRILLE AND FIRE SMOKE DAMPER AND PREPARE DUCT FOR NEW CONNECTION.

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Issuance

No.	Description	Date
1	CONSTRUCTION	03/07
	DOCUMENTS	2022
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Checked By: KD


Project No.

Drawing Title

MECHANICAL 2ND FLOOR MEETING ROOM PLAN

1335

Drawing Scale:

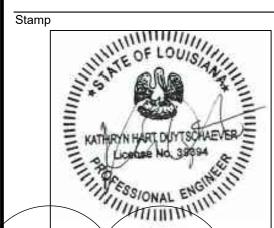

M1.27



Project







Description

1 CONSTRUCTION

DOCUMENTS

KD


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**MECHANICAL** 

**DETAILS** 

03/07

Issuance

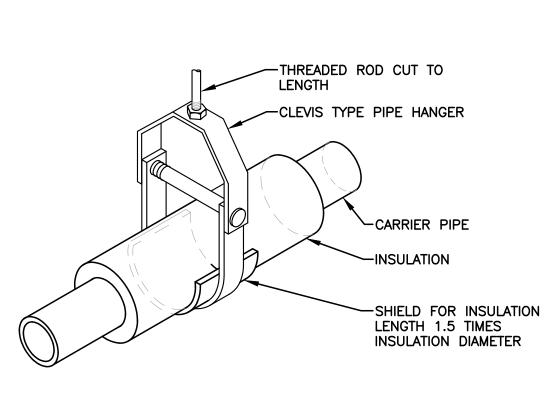

-SHIELD FOR INSULATION **CLEVIS TYPE PIPE HANGER** 

SPIN-IN FITTING

WITH SCOOP AND

VOLUME DAMPER

FLEXIBLE DUCT-FLEX DUCT CLAMF

INSULATE SPIN-IN WITH

1 1/2" THICK INSULATION


DAMPER OPERATOR ACCESSIBLE

INSULATE AND SEAL ALL DIFFUSER SURFACES EXPOSED ABOVE CEILING

DUCT TAKEOFF DETAIL

WITH VAPOR BARRIER LEAVING BENDS.

NOT TO SCALE

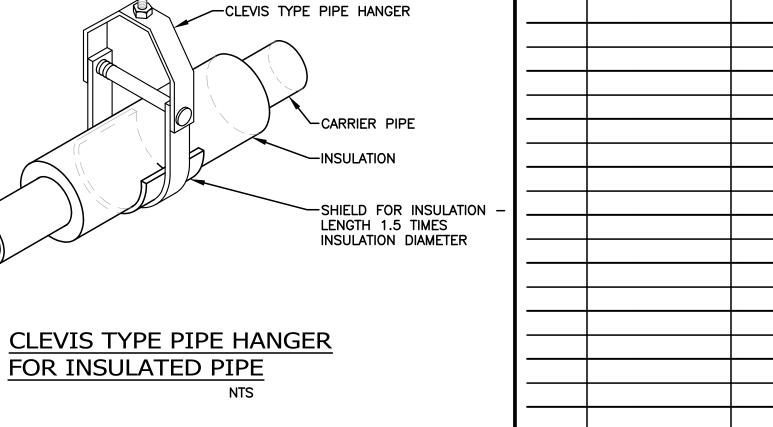


— CONNECT TO

STRUCTURE PER

PROVIDE SUPPORT PER FLEX DUCT MANUFACTURERS RECOMMENDATIONS. MINIMUM 1-1/2" THICK AIR FLOW AND 5'-0" ON CENTER & 1/2 FEET OF

INTERMEDIATE FITTINGS AND

MANUFACTURER INSTRUCTIONS.

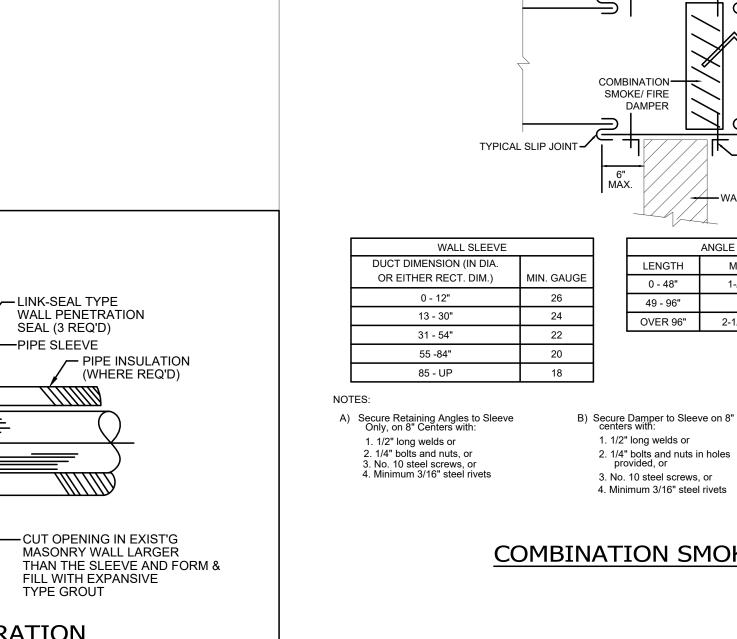

- LINK-SEAL TYPE

SEAL (3 REQ'D)

TYPE GROUT

NOT TO SCALE

TYPICAL PIPE PENETRATION

-PIPE SLEEVE

TYPICAL MOUNTING

COMBINATION SMOKE FIRE DAMPER

OPERATOR MOUNTED ON OUTSIDE OF DUCT

FASTENER LOCATION

8" ON CENTER

6" ON CENTER

6" ON CENTER

Locate damper assembly in sleeve area

Underside mounting angle on horizontal

installation may be omitted if access

Both vertical and horizontal damper installations are typified by these

between mounting angles and fasten damper

MOUNTING FASTENERS

WITH BLADE ROTATION

ANGLE IRON AND FASTENER DIMENSIONS

to sleeve.

MUST NOT INTERFER


WALL OR FLOOR

MIN. ANGLE SIZE

1-/2" x 1-1/2" x 1/8"

2" x 2" x 1/8"

2-1/2" x 2-1/2" x 3/16"

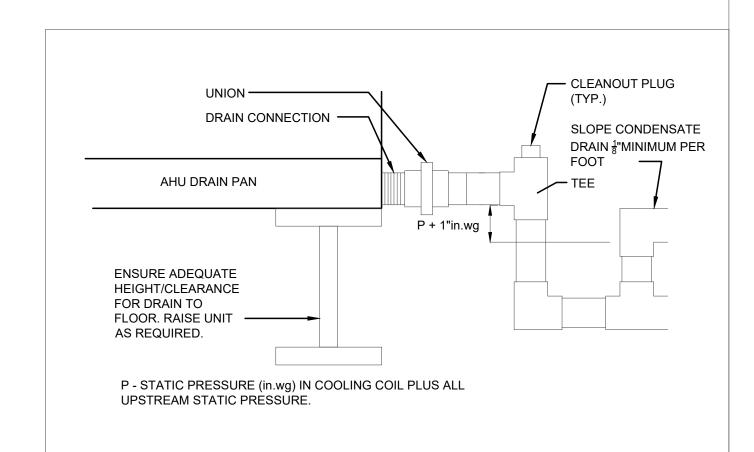

POURED CONCRETE

PROVIDE REMOVABLE FIBROUS . . . .

OR C.M.U. WALL

GLASS INSULATION AT GAPS

AROUND ELASTOMATIC SEAL

AND FIXED PIPE INSULATION.

2" LONG WATER STOP AND ANCHOR COLLAR OF

**EQUAL GAUGE AS SLEEVE** 


AT WALL CONSTRUCTION —

TYP. BOTH SIDES. ——


# **GENERAL NOTES:**

- 1. PRIOR TO ORDERING AHU, CONTRACTOR SHALL COORDINATE ALL BASE RAIL OR EQUIPMENT HEIGHTS TO OBTAIN PROPER CONDENSATE TRAP HEIGHTS AS ILLUSTRATED.
- 2. FILL CONDENSATE DRAIN TRAP PRIOR TO UNIT START-UP.
- 3. SIZE CONDENSATE DRAIN PIPING ACCORDING TO DRAWINGS. PIPE SIZE SHALL BE NO LESS THAN MANUFACTURER'S RECOMMENDED PIPE SIZE.
- 4. COORIDINATE TRAP LOCTION TO AVOID ANY EQUIPMENT ACCESS

# CONDENSATE TRAP DETAIL

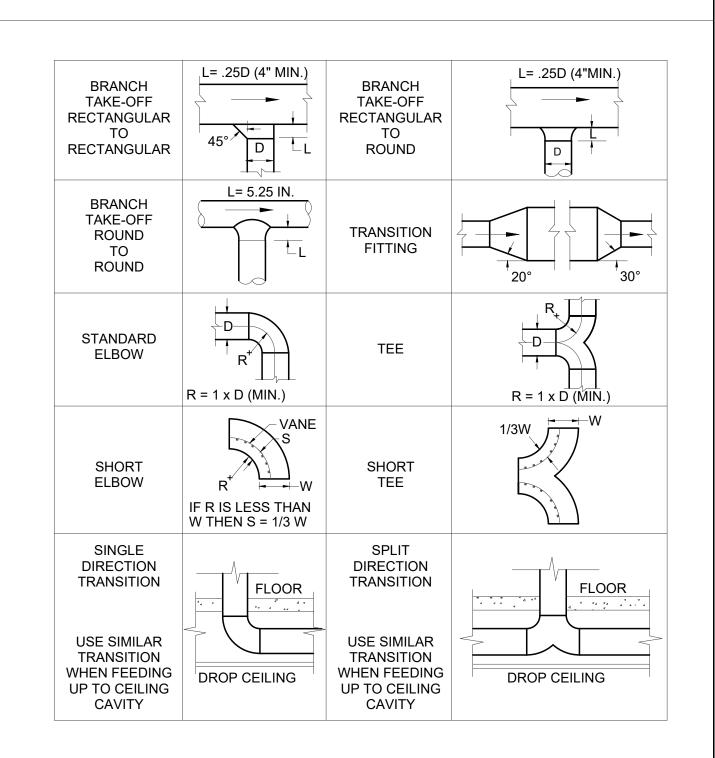

TYPICAL DUCT TAKE OFFS

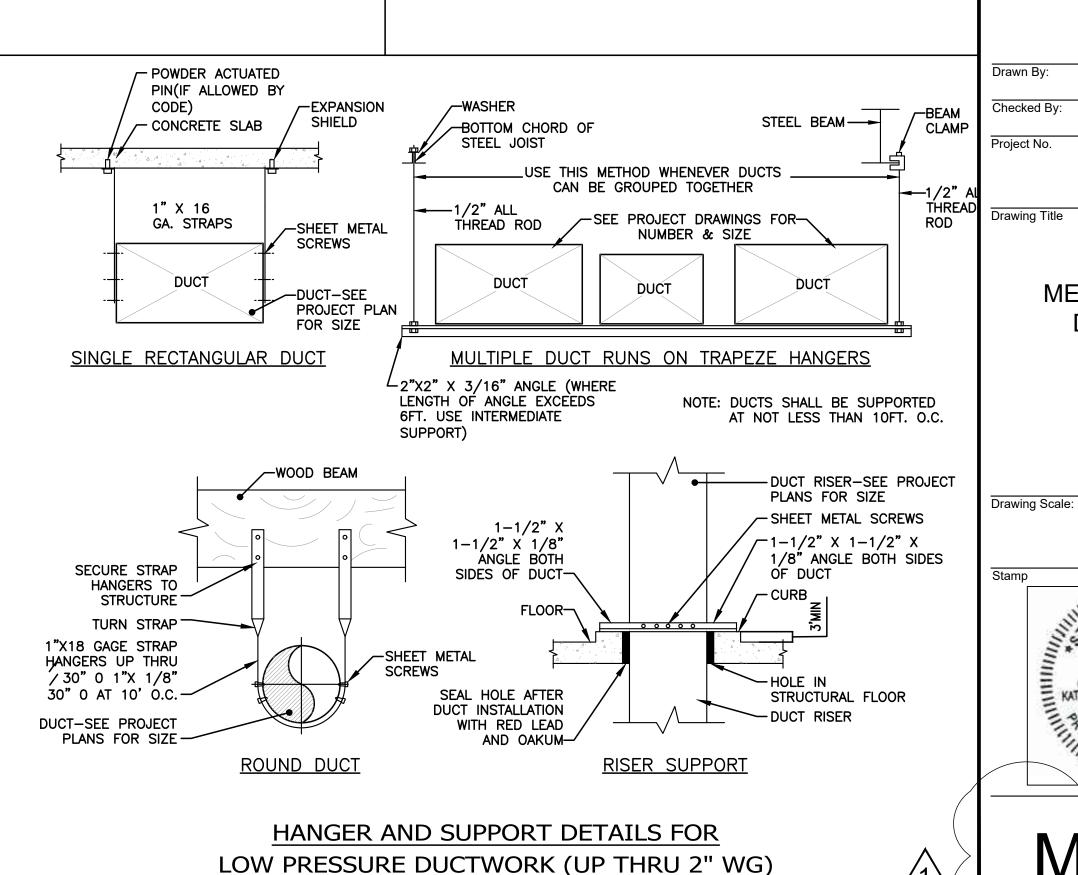

(VARIOUS METHODS OF ATTACHMENT) NOT TO SCALE

Project

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Issuance


No.	Description	Date
1	CONSTRUCTION	03/07
	DOCUMENTS	2022
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Drawn By:	SE	
Checked By:	KD	
Project No.		
	1335	

Drawing Title

MECHANICAL RISER DIAGRAIM

Drawing Scale:

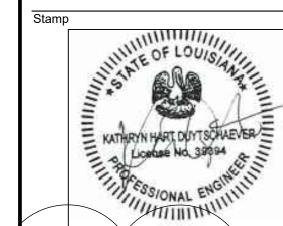

M3.02

# **ELECTRICAL SYMBOLS LIST**

ABRE	VIATIONS
4S/DP	4" SQUARE BY 2 1/8" DEEP BOX
ADA	AMERICAN WITH DISABILITIES ACT
A.F.F. A.F.G.	ABOVE FINISH FLOOR
A.F.G. AWG	ABOVE FINISH GRADE AMERICAN WIRE GAUGE
AMP, A	AMPERE
A.I.C.	AMPERES INTERRUPTING CAPACITY (SYMMETRICAL)
AS/AF	AMP FRAME, AMP TRIP  AMP SWITCH, AMP FUSE
AS/AF CIRC.,CKT.	
CB C	CIRCUIT BREAKER CONDUIT
c.o.	CONDUIT ONLY, COMPLETE WITH PULLSTRING
CONN	CONNECTED
CPT CLCB	CONTROL POWER TRANSFORMER CURRENT LIMITING CIRCUIT BREAKER
CLF	CURRENT LIMITING FUSE
CT DIA	CURRENT TRANSFORMER
E.C.	DIAMETER ELECTRICAL CONTRACTOR
EMS	ENERGY MANAGEMENT CONTROL SYSTEM
EMT ENT	ELECTRICAL METALLIC TUBING ELECTRICAL NON-METALLIC TUBING
EWC	ELECTRICAL NON-METALLIC TOBING ELECTRIC WATER COOLER
E-0-L	END-OF-LINE CIRCUIT TERMINATOR.
EF E/G	EXHAUST FAN EQUIPMENT GROUND (GREEN)
E	EXISTING EQUIPMENT
EP ,	EXPLOSION PROOF
FT or ' FA	FEET FIRE ALARM
FLA	
GFCI	GROUND FAULT CIRCUIT INTERRUPTER.
GRD HOA	GROUND HAND-OFF-AUTO
HVAC	HEATING, VENTILATING AND AIR CONDITIONING
H.,W.,D.,L.	HEIGHT, WIDTH, DEPTH, LENGTH
HID HP	HIGH INTENSITY DISCHARGE HORSEPOWER
HPS	HIGH PRESSURE SODIUM
IN. or " I/G	INCHES ISOLATED GROUND
JBOX	JUNCTION BOX
K	DEGREE KELVIN
KVA KW	KILOVOLT AMPERES KILOWATT
LCL	LONG CONTINUOUS LOAD
L.F.	LINEAR FEET
LTG, LTS LPS	LIGHTING LOW PRESSURE SODIUM
MAX.	MAXIMUM
MCB	MAIN CIRCUIT BREAKER
MIN. MLO	MINIMUM MAIN LUGS ONLY
MV	MERCURY VAPOR
MH MCC	METAL HALIDE MOTOR CONTROL CENTER
MCM	THOUSAND CIRCULAR MILS
MCP	MOTOR CIRCUIT PROTECTOR
MFR. MTD	MANUFACTURER MOUNTED
MW	MICROWAVE
NEC NC	NATIONAL ELECTRICAL CODE
NO NO	NORMALLY CLOSED NORMALLY OPENED
NF	NON-FUSED
NIC NL	NOT IN CONTRACT NIGHT LIGHT
NO. or #	NUMBER
OFCI "	OWNER FURNISHED, CONTRACTOR INSTALLED.
P PC	POLE PHOTOCELL
PRIMARY	OVER 600 VOLTS
PH. or $\Phi$	PHASE
PROVIDE PT	FURNISH, INSTALL AND CONNECT. POTENTIAL TRANSFORMER
PA	PUBLIC ADDRESS

# **ELECTRICAL SHEET INDEX**

PUBLIC ADDRESS

RIGID GALVANIZED STEEL

600 VOLTS AND LESS

TELEPHONE AND DATA

UNLESS OTHERWISE NOTED

RECEPTACLE

SQUARE

TIMECLOCK

TELEVISION

**VOLT AMPERES** 

**WEATHERPROOF** 

TYPICAL

VOLTS

REFRIGERATOR

REC, RECEPT

REF

RGS

**SECONDARY** 

TYP

U.O.N.

E001 Electrical General Information E1.00 Electrical First Level Power Plan E1.01 Electrical Mezzanine Level Power Plan E1.02 Electrical Second Level Power Plan E2.00 Electrical First Level Lighting Plan E2.01 Electrical Mezzanine Level Lighting Plan E2.02 Electrical Second Level Lighting Plan E3.00 Enlarged Electrical Plans E3.01 Enlarged Electrical Plans E3.02 Enlarged Electrical Plans E4.00 Electrical First Level Demo Plan

E4.01 Electrical Mezzanine Level Demo Plan E4.02 Electrical Second Level Demo Plan E5.00 Electrical Schedules E5.01 Electrical Riser Diagram - Floors 1 - 7 E5.02 Electrical Panel Schedules

TELEPHONE OUTLET BOX, WALL MOUNTED AT +18" A.F.F. (MIN). STUB A 3/4" C.O. UP 6" ABOVE THE ACCESSIBLE CEILING AND PROVIDE A BUSHING. 4S/DP MINIMUM WITH SINGLE GANG RING. "W" = WALL MOUNTED PHONE AT +48" A.F.F. (MAX) "P" = PUBLIC (PAY) PHONE. VERIFY ALL REQUIREMENTS WITH THE TELEPHONE UTILITY COMPANY. PROVIDE 1"C.O. (MIN) TO THE MAIN TELEPHONE BACKBOARD. MOUNTING HEIGHT AS REQUIRED.

DATA OUTLET BOX MOUNTED AT +18" A.F.F. MINIMUM OR AS NOTED. STUB A 3/4" C.O. UP 6" ABOVE THE ACCESSIBLE CEILING AND PROVIDE A BUSHING. 4S/DP MINIMUM WITH SINGLE GANG RING. CLG INDICATED CEILING MOUNTED.

COMBINATION TELEPHONE AND DATA OUTLET BOX WALL MOUNTED AT +18" A.F.F. (MIN). STUB A 1" C.O. UP 6" ABOVE THE ACCESSIBLE CEILING AND PROVIDE A BUSHING. 4S/DP MINIMUM WITH SINGLE GANG RING.

TELEVISION BOX. INCLUDE DATA JACK & COAX CONNECTIONS.

OPEN BOX, MOUNTED AT +18" A.F.F OR AS NOTED. STUB A 3/4" CONDUIT TO 6" ABOVE ACCESSIBLE CEILING AND PROVIDE BUSHING. "S" = DESIGNATES SINGLE GANG. "D" = DESIGNATES DOUBLE GANG. "T" = DESIGNATES TRIPLE GANG.

"SF" = DESIGNATES SINGLE GANG FLOORBOX PROVIDE AS S1PT4X4 VERIFY FINISH WITH ARCH. WIRELESS ACCESS POINT. PROVIDE A 4-11/16" SQUARE BY 2-1/8" DEEP BACK BOX WITH A SINGLE GANG REDUCTION. STUB A 3/4" CONDUIT TO 6" ABOVE ACCESSIBLE

CEILING AND PROVIDE BUSHING. DATA OUTLET BOX, WALL MOUNTED 6" ABOVE COUNTER OR SPLASH. STUB A 3/4"C.O. UP 6" ABOVE THE ACCESSIBLE CEILING AND PROVIDE A BUSHING.

4S/DP MINIMUM WITH SINGLE GANG RING. COMBINATION TELEPHONE AND DATA OUTLET BOX, WALL MOUNTED 6" ABOVE COUNTER OR SPLASH. STUB A 1" C.O. UP 6" ABOVE THE ACCESSIBLE CEILING AND PROVIDE A BUSHING. 4S/DP MINIMUM WITH SINGLE GANG RING.

COMBINATION TELEPHONE AND DATA OUTLET BOX MOUNTED IN ACCESSIBLE CEILING SPACE WITH FLEXIBLE CONNECTION TO FURNITURE SYSTEM. VERIFY CONNECTION REQUIREMENTS WITH MANUFACTURER PRIOR TO ROUGH-IN.

COMBINATION TELEPHONE AND DATA OUTLET BOX, WALL MOUNTED AT +18" A.F.F. WITH FLEXIBLE CONNECTION TO FURNITURE SYSTEM. STUB A 1 1/4" C.O. UP 6" ABOVE THE ACCESSIBLE CEILING AND PROVIDE A BUSHING. VERIFY CONNECTION REQUIREMENTS WITH MANUFACTURER PRIOR TO ROUGH-IN.

COMBINATION TELEPHONE AND DATA OUTLET BOX, MOUNTED FLUSH IN FLOOR WITH FLEXIBLE CONNECTION TO FURNITURE SYSTEM. VERIFY CONNECTION REQUIREMENT WITH MANUFACTURER PRIOR TO ROUGH-IN.

TELEPHONE AND DATA, FLOOR POKE THROUGH WITH FLEXIBLE CONNECTION TO FURNITURE SYSTEM. VERIFY CONNECTION REQUIREMENT WITH MANUFACTURER. PRIOR TO ROUGH-IN.

— T — CONCEALED TELEPHONE/DATA CONDUIT RUN, 3/4" CONDUIT ONLY (MIN). ---T1 --- 1" C.O. --T2 --- 1 1/4" C.O.

FLUSH MOUNTED, LOCKABLE TERMINAL CABINET WITH TERMINAL STRIPS

SURFACE MOUNTED, LOCKABLE TERMINAL CABINET WITH TERMINAL STRIPS AS REQUIRED.

TELEPHONE TERMINAL BACKBOARD SIZED AS NOTED, REFER TO SYSTEM GROUND DETAIL.

SURFACE MOUNTED MULTI-OUTLET ASSEMBLY. REFER TO GENERAL PRODUCT SPECIFICATIONS. PROVIDE ALL COMPONENTS NECESSARY FOR A COMPLETE

FACP FIRE ALARM CONTROL PANEL - SEE SPECIFICATIONS.

FAAP FIRE ALARM ANNUNCIATOR PANEL - SEE SPECIFICATIONS.

FIRE ALARM MANUAL PULL STATION, WALL MOUNTED AT +48" A.F.F. - SEE SPECIFICATIONS.

FIRE ALARM HORN, WALL MOUNTED AT +92" A.F.F. CENTER OF DEVICE - SEE SPECIFICATIONS.

FIRE ALARM FLASHING LIGHT (ADA APPROVED), WALL MOUNTED AT +92" A.F.F. CENTER OF DEVICE - SEE SPÈCIFICATIONS. CANDELA RATING AS REQUIRED TO MEET ADA COVERAGE REQUIREMENTS.

FIRE ALARM HORN/FLASHING LIGHT (ADA APPROVED), WALL MOUNTED AT +92" A.F.F. CENTER OF DEVICE - SEE SPECIFICATIONS. CANDELA RATING AS REQUIRED TO MEET ADA COVERAGE REQUIREMENTS.

FIRE ALARM SPEAKER, CEILING MOUNTED - SEE SPECIFICATIONS.

FIRE ALARM SPEAKER, WALL MOUNTED +92" A.F.F. CENTER OF DEVICE — SEE SPECIFICATIONS.

FIRE ALARM SPEAKER/FLASHING LIGHT, WALL MOUNTED AT +92" A.F.F. CENTER OF DEVICE

FIRE ALARM SMOKE DETECTOR, PHOTOELECTRIC TYPE, CEILING MOUNTED -SEE SPECIFICATIONS.

FIRE ALARM SMOKE DETECTOR, IONIZATION TYPE, CEILING MOUNTED -SEE SPECIFICATIONS.

FIRE ALARM DUCT DETECTOR PHOTOELECTRIC TYPE - SEE SPECIFICATIONS.

FIRE ALARM DUCT DETECTOR, IONIZATION TYPE - SEE SPECIFICATIONS.

FIRE ALARM REMOTE L.E.D. INDICATOR.

FIRE ALARM HEAT DETECTOR, CEILING MOUNTED - SEE SPECIFICATIONS.

FIRE ALARM MAGNETIC HOLD OPEN DEVICE — SEE SPECIFICATIONS.

FA---- FIRE ALARM BRANCH CIRCUIT PER FIRE ALARM WIRING DIAGRAMS & SPECIFICATIONS

^^ FIRE ALARM END-OF-LINE RESISTOR - SEE SPECIFICATIONS.

SINGLE RECEPTACLE, WALL MOUNTED AT +18" A.F.F. OR AS NOTED.

DUPLEX RECEPTACLE, WALL MOUNTED AT +18" A.F.F. OR AS NOTED.

DOUBLE DUPLEX RECEPTACLE, WALL MOUNTED AT +18" A.F.F. OR AS NOTED.

DUPLEX RECEPTACLE, WALL MOUNTED AT +42" A.F.F. OR AS NOTED.

DOUBLE DUPLEX RECEPTACLE, WALL MOUNTED AT +42" A.F.F. OR AS NOTED.

DUPLEX RECEPTACLE, BOTTOM HALF SWITCHED, WALL MOUNTED AT +18" A.F.F. OR AS NOTED.

CONTROLLED RECEPTACLE PER CALIFORNIA ENERGY CODE, WALL MOUNTED AT +18" A.F.F.

OR AS NOTED. SHALL BE IDENTIFIED AS REQUIRED BY 130.5(d)(3). DUPLEX RECEPTACLE FLUSH IN CEILING.

DOUBLE DUPLEX RECEPTACLE FLUSH IN FLOOR BOX WITH SERVICE FITTING. FIRE RATED POKE THROUGH FLOORBOX.

SPECIAL RECEPTACLE, WALL MOUNTED AT +18" A.F.F. OR AS NOTED. REFER TO PLAN NOTES.

PROVIDE AS HUBBLE SYSTEM ONE, VERIFY FINISH COLOR WITH ARCHITECT.

DUPLEX RECEPTACLE, GFI, WALL MOUNTED AT +18"

DOUBLE DUPLEX RECEPTACLE, GFI, WALL MOUNTED AT +18"

DUPLEX, GFI, WALL MOUNTED AT +42"

DOUBLE DUPLEX, GFI, WALL MOUNTED AT +42"

JUNCTION BOX, WALL MOUNTED AT +18" A.F.F. OR AS NOTED. 4S/DP MINIMUM OR AS REQUIRED BY N.E.C..

JUNCTION BOX, MOUNTED IN ACCESSIBLE CEILING FOR APPLICATION DENOTED ON PLAN. 4S/DP MINIMUM OR AS REQUIRED BY N.E.C..

JUNCTION BOX, FLUSH IN FLOOR WITH SERVICE FITTING. SIZE AS REQUIRED BY N.E.C.

JUNCTION BOX, WALL MOUNTED AT 6" ABOVE COUNTER OR SPLASH. 4S/DP MINIMUM OR AS REQUIRED BY N.E.C..

JUNCTION BOX MOUNTED IN ACCESSIBLE CEILING SPACE WITH FLEXIBLE CON-NECTION TO PREWIRED FURNITURE SYSTEM. VERIFY CONNECTION REQUIREMENTS WITH MANUFACTURER PRIOR TO ROUGH-IN.

JUNCTION BOX, WALL MOUNTED AT +18" A.F.F. WITH FLEXIBLE CONNECTION TO PRE-WIRED FURNITURE SYSTEM. VERIFY CONNECTION REQUIREMENTS WITH MANUFACTURER PRIOR TO ROUGH-IN.

FLUSH IN FLOOR JUNCTION BOX WITH FLEXIBLE CONNECTION TO PRE-WIRED FURNITURE SYSTEM. VERIFY CONNECTION REQUIREMENTS WITH MANUFACTURER PRIOR TO ROUGH-IN.

"P" = DESIGNATES PEDESTAL TYPE DEVICE. "F" = DESIGNATES FIRE RATED POKE THROUGH.

FLOOR POKE THROUGH WITH FLEXIBLE CONNECTION TO PRE-WIRED FURNITURE

SYSTEM. VERIFY CONNECTION REQUIREMENTS WITH MANUFACTURER PRIOR TO ROUGH—IN. SURFACE MOUNTED MULTI-OUTLET ASSEMBLY. REFER TO GENERAL PRODUCT SPECIFICATIONS. PROVIDE ALL COMPONENTS NECESSARY FOR A COMPLETE

THERMOSTAT OUTLET BOX, PROVIDE 1/2"C.O. TO ACC. CLG. SPACE, BUSH ENDS.

EXHAUST FAN, OR MOTOR LOAD. REFER TO MECHANICAL, PLUMBING OR KITCHEN

DRAWINGS FOR SPECIFIC LOAD REQUIREMENTS OR AS NOTED. FLUSH MOUNTED ELECTRICAL PANELBOARD OR LOAD CENTER. REFER

TO PANEL SCHEDULE. \_\_\_\_\_ SURFACE MOUNTED ELECTRICAL PANELBOARD OR LOAD CENTER. REFER

TO PANEL SCHEDULE.

DISTRIBUTION SWITCHBOARD. REFER TO SINGLE LINE DIAGRAM.

TRANSFORMER, REFER TO SINGLE LINE DIAGRAM.

FUSED DISCONNECT SWITCH, HP RATED WITH FUSES PER EQUIPMENT MANUFACTURER AND WEATHERPROOF AS REQUIRED. PROVIDE FINAL CONNECTION TO UNIT EQUIPMENT.

NON-FUSED DISCONNECT SWITCH, HP RATED AND WEATHERPROOF AS REQUIRED. PROVIDE FINAL CONNECTION TO UNIT EQUIPMENT

UTILITY COMPANY METER. PROVIDE "CT's" AND "PT's" AS REQUIRED, REFER TO SINGLE LINE DIAGRAM.

CIRCUIT BREAKER

INSTALLATION.

FUSIBLE SWITCH

GROUND CONNECTION, SIZE AS INDICATED OR AS REQUIRED.

PULLBOX, SIZED PER N.E.C. OR AS NOTED.

SINGLE POLE SWITCHES, WALL MOUNTED AT +48" A.F.F. (MAX). SUBSCRIPTS AT SYMBOL INDICATE THE FOLLOWING:

2 - DOUBLE POLE 3 - THREE WAY K - KEY OPERATED

OS - OCCUPANCY SENSOR M - MOTOR STARTING QS - seeTOUCH QS BUTTON P - WIRELESS PICO KEYPAD

a, b, c, ETC. - DESIGNATES SWITCH LEG SEE SHEET E4.1 FOR LIGHTING CONTROL DETAILS

OCCUPANCY SENSOR. SEE SHEET E6.2 FOR LIGHTING CONTROL DETAILS

DAYLIGHT SENSOR. SEE SHEET E6.2 FOR LIGHTING CONTROL DETAILS

POWER PACK. SEE SHEET E6.2 FOR LIGHTING CONTROL DETAILS

RECESSED FIXTURE IN ACCESSIBLE CEILING. REFER TO LIGHTING FIXTURE SCHEDULE.

RECESSED EMERGENCY FIXTURE IN ACCESSIBLE CEILING. REFER TO LIGHTING FIXTURE SCHEDULE.

SURFACE MOUNTED FIXTURE AND OUTLET BOX. REFER TO LIGHTING FIXTURE

SURFACE MOUNTED EMERGENCY FIXTURE AND OUTLET BOX. REFER TO LIGHTING FIXTURE SCHEDULE.

RECESSED FIXTURE IN HARD LID CEILING AND OUTLET BOX. REFER TO LIGHTING FIXTURE SCHEDULE. RECESSED EMERGENCY FIXTURE IN HARD LID CEILING AND OUTLET BOX. REFER

TO LIGHTING FIXTURE SCHEDULE.  $\circ$ RECESSED DOWNLIGHTING FIXTURE. REFER TO LIGHTING FIXTURE SCHEDULE.

RECESSED DOWNLIGHTING EMERGENCY FIXTURE. REFER TO LIGHTING FIXTURE SCHEDULE.

RECESSED WALL WASHING LIGHTING FIXTURE. REFER TO LIGHTING FIXTURE SCHEDULE.

SURFACE MOUNTED LIGHTING FIXTURE. REFER TO LIGHTING FIXTURE SCHEDULE. SURFACE MOUNTED EMERGENCY LIGHTING FIXTURE. REFER TO LIGHTING FIXTURE

SCHEDULE. WALL MOUNTED LIGHTING FIXTURE AND OUTLET BOX. REFER TO LIGHTING FIXTURE

SCHEDULE AND PLANS FOR MOUNTING HEIGHT.

STRIP LIGHTING FIXTURE AND OUTLET BOX. REFER TO LIGHTING FIXTURE SCHEDULE.

TRACK LIGHTING FIXTURE AND OUTLET BOX. REFER TO LIGHTING FIXTURE SCHEDULE. PROVIDE ALL COMPONENTS NECESSARY FOR A COMPLETE INSTALLATION.

STRIP LIGHTING EMERGENCY FIXTURE AND OUTLET BOX. REFER TO LIGHTING

EXIT SIGN AND OUTLET BOX, CEILING MOUNTED, SHADING INDICATES DIRECTION AND NUMBER OF FACES, ARROWS AS REQUIRED. REFER TO LIGHTING FIXTURE SCHEDULE

EXIT SIGN AND OUTLET BOX, WALL MOUNTED, SHADING INDICATES DIRECTION AND NUMBER OF FACES, ARROWS AS REQUIRED. REFER TO LIGHTING FIXTURE SCHEDULE. LOW-LEVEL EXIT SIGN AND OUTLET BOX, WALL MOUNTED. REFER TO LIGHTING FIXTURE

SURFACE MOUNTED EMERGENCY LIGHTING UNIT WITH 90 MIN. EMERGENCY BATTERY PACK. REFER TO LIGHTING FIXTURE SCHEDULE.

POLE MOUNTED LIGHTING FIXTURE. REFER TO LIGHTING FIXTURE SCHEDULE.

0 POST MOUNTED OR BOLLARD LIGHTING FIXTURE. REFER TO LIGHTING FIXTURE

WALL MOUNTED DIMMER AT +48" A.F.F. (MAX). SEE SWITCHES FOR SUBSCRIPTS.

SHOWN, SURFACE MOUNTED.

OCCUPANCY SENSOR WITH SWITCHPACK AND OUTLET BOX, 1-WAY DIRECTIONAL AS SHOWN. SURFACE MOUNTED.

OCCUPANCY SENSOR WITH SWITCHPACK AND QUTLET BOX, 2-WAY DIRECTIONAL AS OCCUPANCY SENSOR, WALL MOUNTED AT +48" A.F.F. MAXIMUM.

**O** 

HOME RUN TO PANEL. LETTER DESIGNATES PANEL, NUMBERS INDICATE CIRCUITS. INDICATES FINAL CONNECTION TO A LIGHTING FIXTURE, NUMBER OF CONDUCTORS AS UNLESS OTHERWISE NOTED.

HASH MARKS INDICATE NUMBER OF CONDUCTORS IN CONDUIT RUN, #12 AWG MINIMUM

A-1+3+	5 HOME	RUN	TO	PANEL.	LETTER	<b>DESIGNAT</b>	ES PANEL,	NUMBERS	INDICATE	<b>CIRCUITS</b>
1 11 11 11 -	"+" I	<b>NDICA</b>	TES	SEPARA	ATE #10	NEUTRAL	THROUGHO	OUT BRANC	H CIRCUIT	

HASH MARK ! " INDICATES AN ISOLATED GROUND CONDUCTOR. CONCEALED BRANCH CIRCUIT UNLESS OTHERWISE NOTED.

\_\_\_\_\_ CONDUIT RUN CONCEALED BELOW GRADE, 3/4"C MINIMUM WITH CODE SIZED EQUIPMENT GROUND.

———— TANDEM WIRING CONNECTION. REFER TO TANDEM WIRING DETAIL.

CONDUIT STUB OUT, CAP, MARK AND RECORD.

 $\rightarrow$  CONDUIT CONTINUATION. INDICATES FLEXIBLE CONNECTION TO EQUIPMENT. NUMBER OF CONDUCTORS

LIGHTING FIXTURE CALL OUT, "3" INDICATES FIXTURE TYPE (REFER TO LIGHTING

FOR BRANCH CIRCUIT PURPOSES ONLY, NOT FOR MATERIAL TAKE-OFF). FIXTURE SCHEDULE), NUMBER ADJACENT INDICATES QUANTITIES (NUMBER IS SHOWN PANEL CALLOUT, "A" INDICATES PANELBOARD OR EQUIPMENT DESIGNATION.

MECHANICAL EQUIPMENT CALLOUT, "AC" INDICATES UNIT TYPE AND "2" INDICATES UNIT NUMBER. REFER TO MECHANICAL DRAWINGS FOR EXACT LOCATION AND ELECTRICAL REQUIREMENTS.

PLAN NOTE REFERENCE, REFER TO NOTES ON SHEET, OR AS DIRECTED.

REVISION REFERENCE.

WYE CONFIGURATION ⚠ DELTA CONFIGURATION

GROUND

UP 6" ABOVE THE ACCESSIBLE CEILING AND PROVIDE A BUSHING

CARD READER OUTLET WALL MOUNTED AT +42" A.F.F. (MINIMUM), STUB A 3/4"C.O. SURFACE CEILING MTD. DUAL IONIZATION SMOKE DETECTOR, 120V., WITH BATTERY BACKUP. ELECTRONICS # 9120B OR EQUAL.

BACK UP, DUAL IONIZATION SMOKE DETECTOR AND ELECTROCHEMICAL CARBON MONOXIDE DETECTOR. BRK ELECTRONICS # SC9120B OR EQUAL. COMBINATION SMOKE ALARM / CARBON MONOXIDE DETECTOR 120V., WITH BATTERY

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03/07

2022

No. Description

1 CONSTRUCTION

DOCUMENTS

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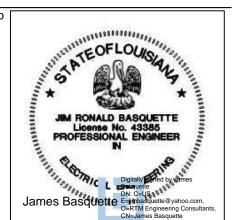
> **ELECTRICAL** GENERAL **INFORMATION**

1335

Drawing Scale:

Project No.

Drawing Title



# **GENERAL NOTES**

- 1. RECEPTACLES AND DATA OUTLETS TO BE MOUNTED AT +18" AFF UNLESS NOTED OTHERWISE. VERIFY FINAL DEVICE MOUNTING HEIGHT AND RELATIVE PLACEMENT WITH OWNER/ARCHITECT PRIOR TO
- 2. TIE BACK ALL LOOSE WIRING (INCLUDING LOW VOLTAGE) IN AN ORDERLY FASHION.
- 3. ALL LOW VOLTAGE DEVICES AND WIRING SHALL BE INSTALLED BY A LOW VOLTAGE CONTRACTOR. ELECTRICAL CONTRACTOR SHALL ONLY PROVIDE DEVICE ROUGH—IN BOX AND 1-3/4" EMPTY CONDUIT FROM DEVICE BOX UP TO ACCESSIBLE CEILING SPACE.
- 4. IN AREAS WHERE THERE WILL BE NO CEILING, CONDUIT SHALL BE CONTINUOUS.
- 5. POWER OUTLETS MUST BE PROPERLY ALIGNED BETWEEN STUDS USING CADDY BRACKET WITH SPACING FOR (3) 4X4 JBOXES.
- 6. ALL DEVICES SHOWN ARE NEW UNLESS OTHERWISE NOTED.
- 7. CONDUCTOR INSULATION TYPE SHALL BE THW/THWN.
- 8. WIRE OF #8 AND LARGER SHALL BE STRANDED. WIRE OF #10 AND SMALLER SHALL BE SOLID.
- CONTRACTOR SHALL COORDINATE FINAL ATTACHMENT REQUIREMENTS FOR ALL ELECTRICAL AND LOW VOLTAGE DEVICES LOCATED WITHIN FURNITURE.

10. ALL RECEPTACLES SHALL BE TAMPER RESISTANT PER 2014 NEC.

# **KEY NOTES**

RELOCATE KEGERATOR TO BEHIND NEW SELF SERVE TAP WALL. EXISTING FIRE SMOKE DAMPER TO BE REPLACED. RECONNECT TO EXISTING CIRCUIT.

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Project





Issuance


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No.	Description	Date
1	CONSTRUCTION	03/07
	DOCUMENTS	2022
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Drawn By: Checked By: Project No. 1335


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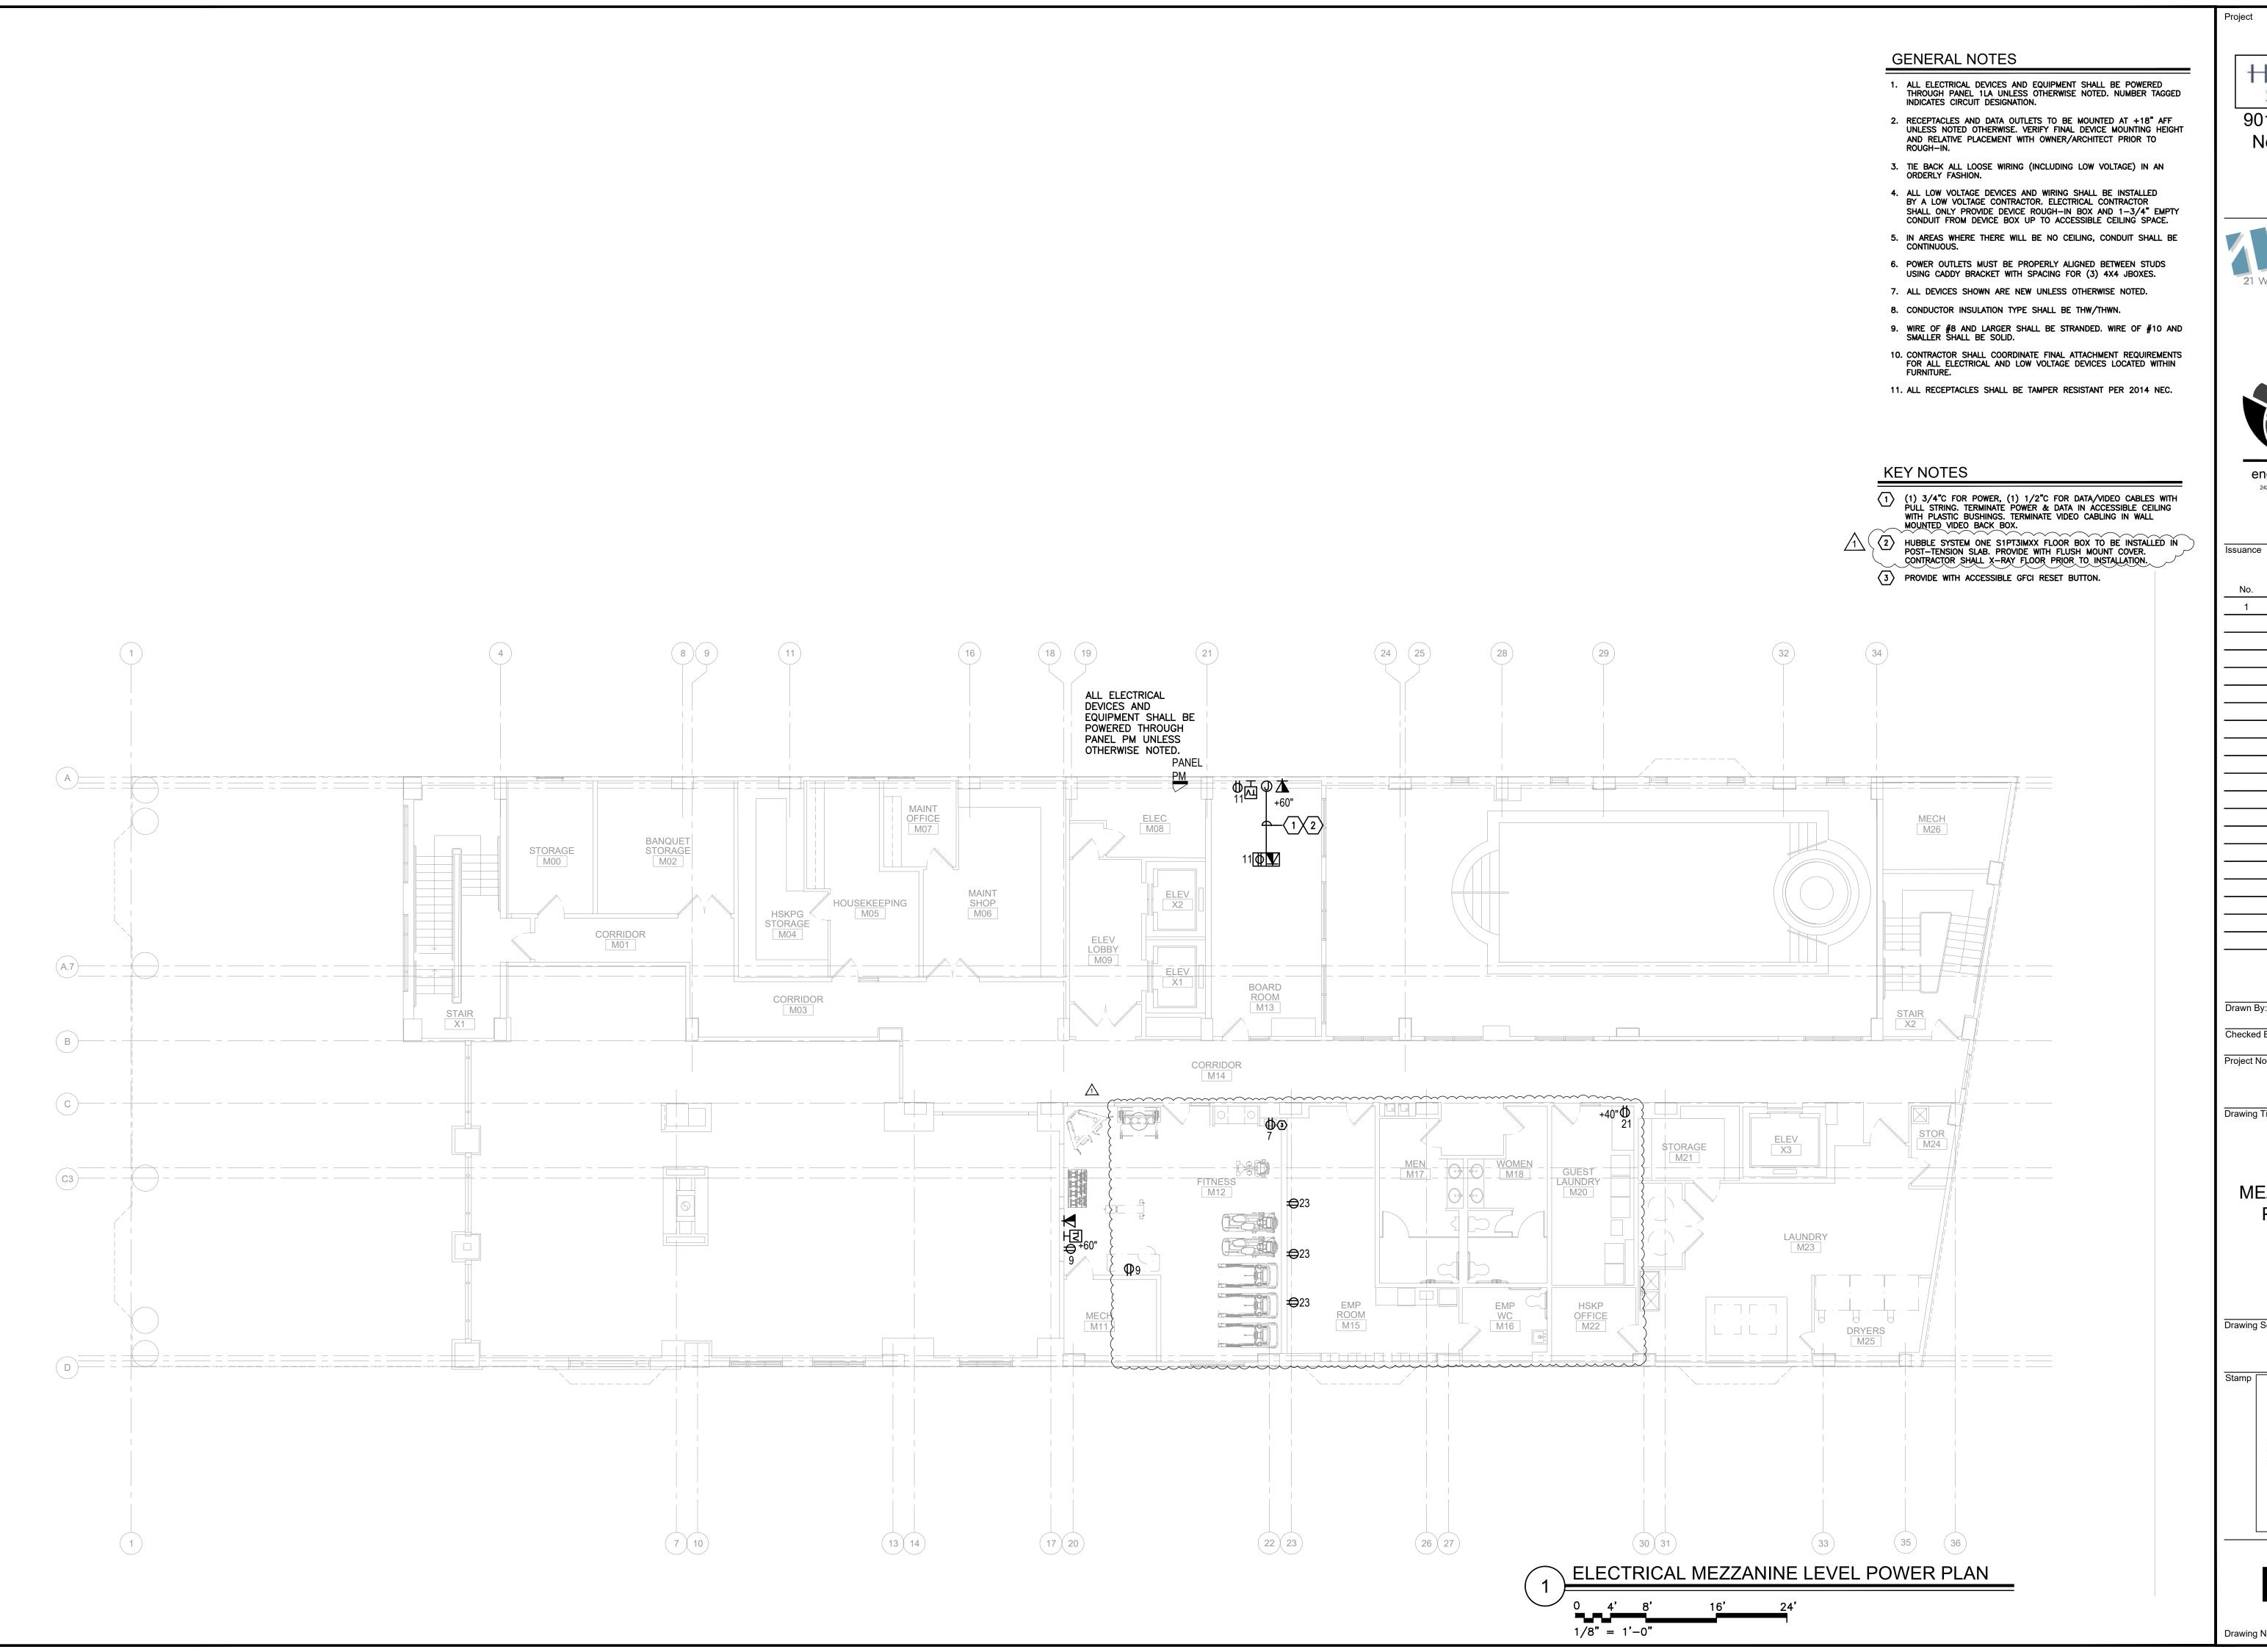
ELECTRICAL FIRST LEVEL POWER PLAN

Drawing Scale:



E1.00

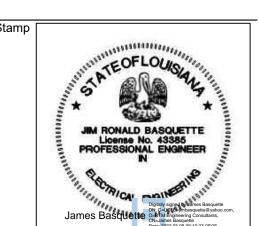

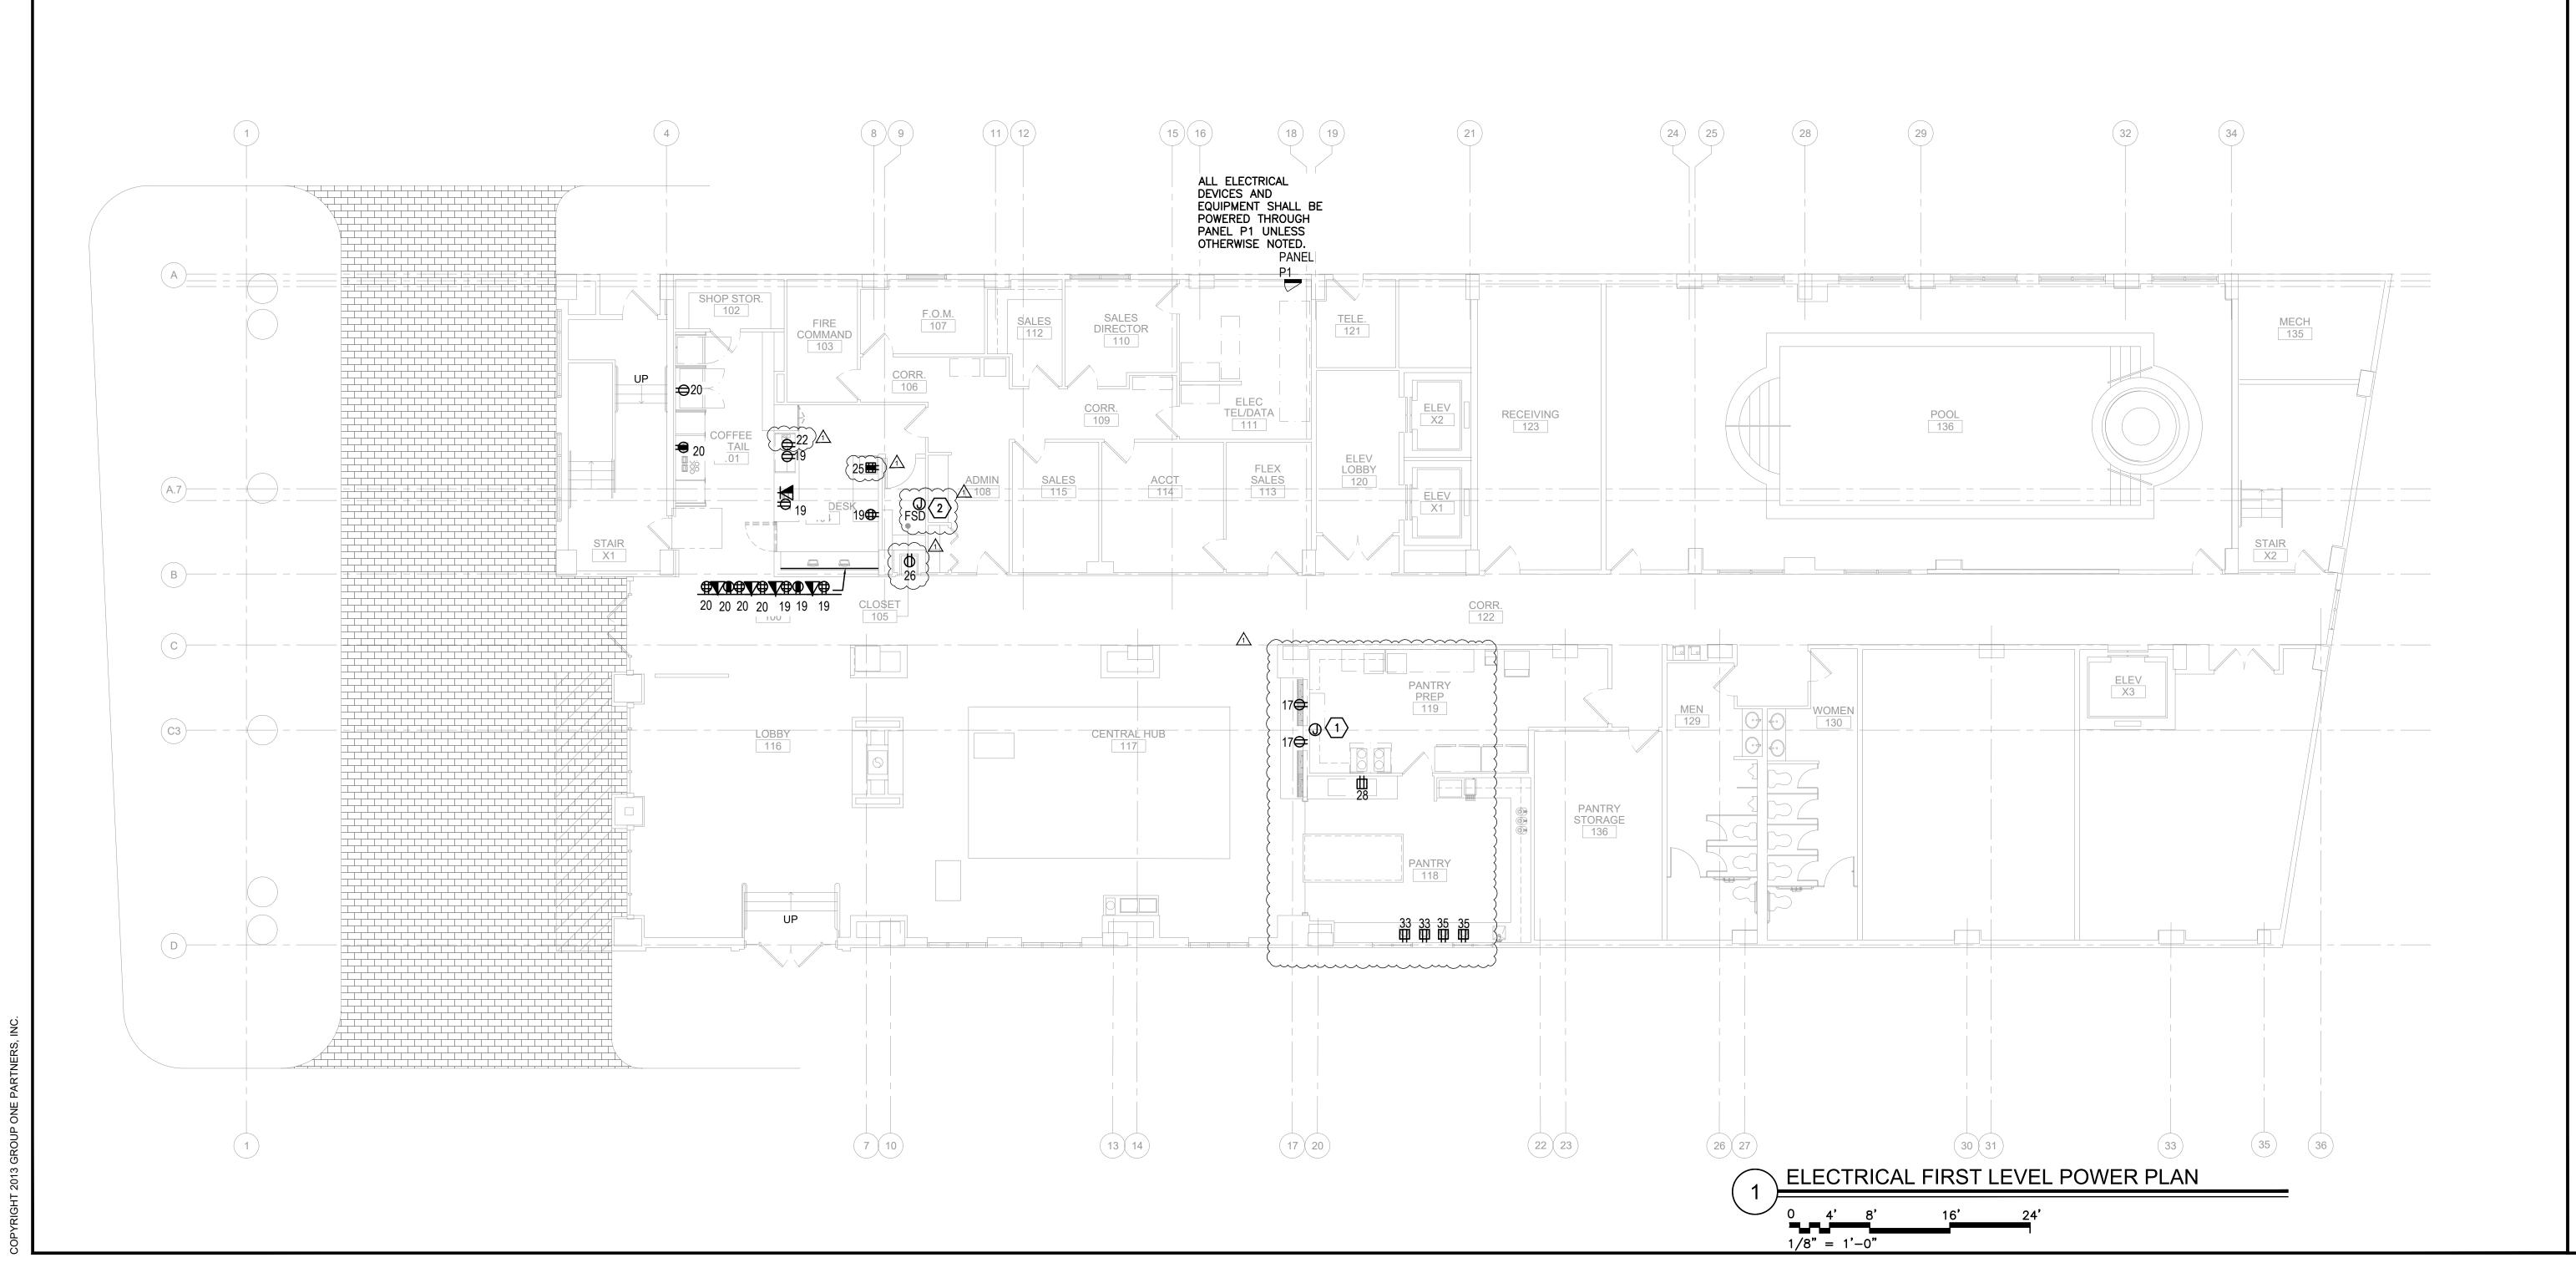

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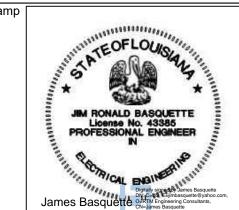
Description Date 03/07 CONSTRUCTION DOCUMENTS 2022

Drawn By: Checked By: Project No. 1335

Drawing Title

**ELECTRICAL** MEZZANINE LEVEL POWER PLAN

Drawing Scale:




E1.01

# GENERAL NOTES

- ALL ELECTRICAL DEVICES AND EQUIPMENT SHALL BE POWERED THROUGH PANEL 1LA UNLESS OTHERWISE NOTED. NUMBER TAGGED INDICATES CIRCUIT DESIGNATION.
- 2. RECEPTACLES AND DATA OUTLETS TO BE MOUNTED AT +18" AFF UNLESS NOTED OTHERWISE. VERIFY FINAL DEVICE MOUNTING HEIGHT AND RELATIVE PLACEMENT WITH OWNER/ARCHITECT PRIOR TO
- 3. TIE BACK ALL LOOSE WIRING (INCLUDING LOW VOLTAGE) IN AN ORDERLY FASHION.
- 4. ALL LOW VOLTAGE DEVICES AND WIRING SHALL BE INSTALLED BY A LOW VOLTAGE CONTRACTOR. ELECTRICAL CONTRACTOR SHALL ONLY PROVIDE DEVICE ROUGH—IN BOX AND 1-3/4" EMPTY CONDUIT FROM DEVICE BOX UP TO ACCESSIBLE CEILING SPACE.
- 5. IN AREAS WHERE THERE WILL BE NO CEILING, CONDUIT SHALL BE CONTINUOUS.
- 6. POWER OUTLETS MUST BE PROPERLY ALIGNED BETWEEN STUDS USING CADDY BRACKET WITH SPACING FOR (3) 4X4 JBOXES.
- 7. ALL DEVICES SHOWN ARE NEW UNLESS OTHERWISE NOTED.
- 8. CONDUCTOR INSULATION TYPE SHALL BE THW/THWN.
- 9. WIRE OF #8 AND LARGER SHALL BE STRANDED. WIRE OF #10 AND SMALLER SHALL BE SOLID.
- CONTRACTOR SHALL COORDINATE FINAL ATTACHMENT REQUIREMENTS FOR ALL ELECTRICAL AND LOW VOLTAGE DEVICES LOCATED WITHIN FURNITURE.
- 11. ALL RECEPTACLES SHALL BE TAMPER RESISTANT PER 2014 NEC.

# **KEY NOTES**

- CONNECT TO EXISTING RECEPTACLE CIRCUIT SERVING ROOM.
- 120V CONNECTION FOR FIRE SMOKE DAMPER. PROVIDE CIRCUIT BREAKER LOCK. TYPICAL OF 13.

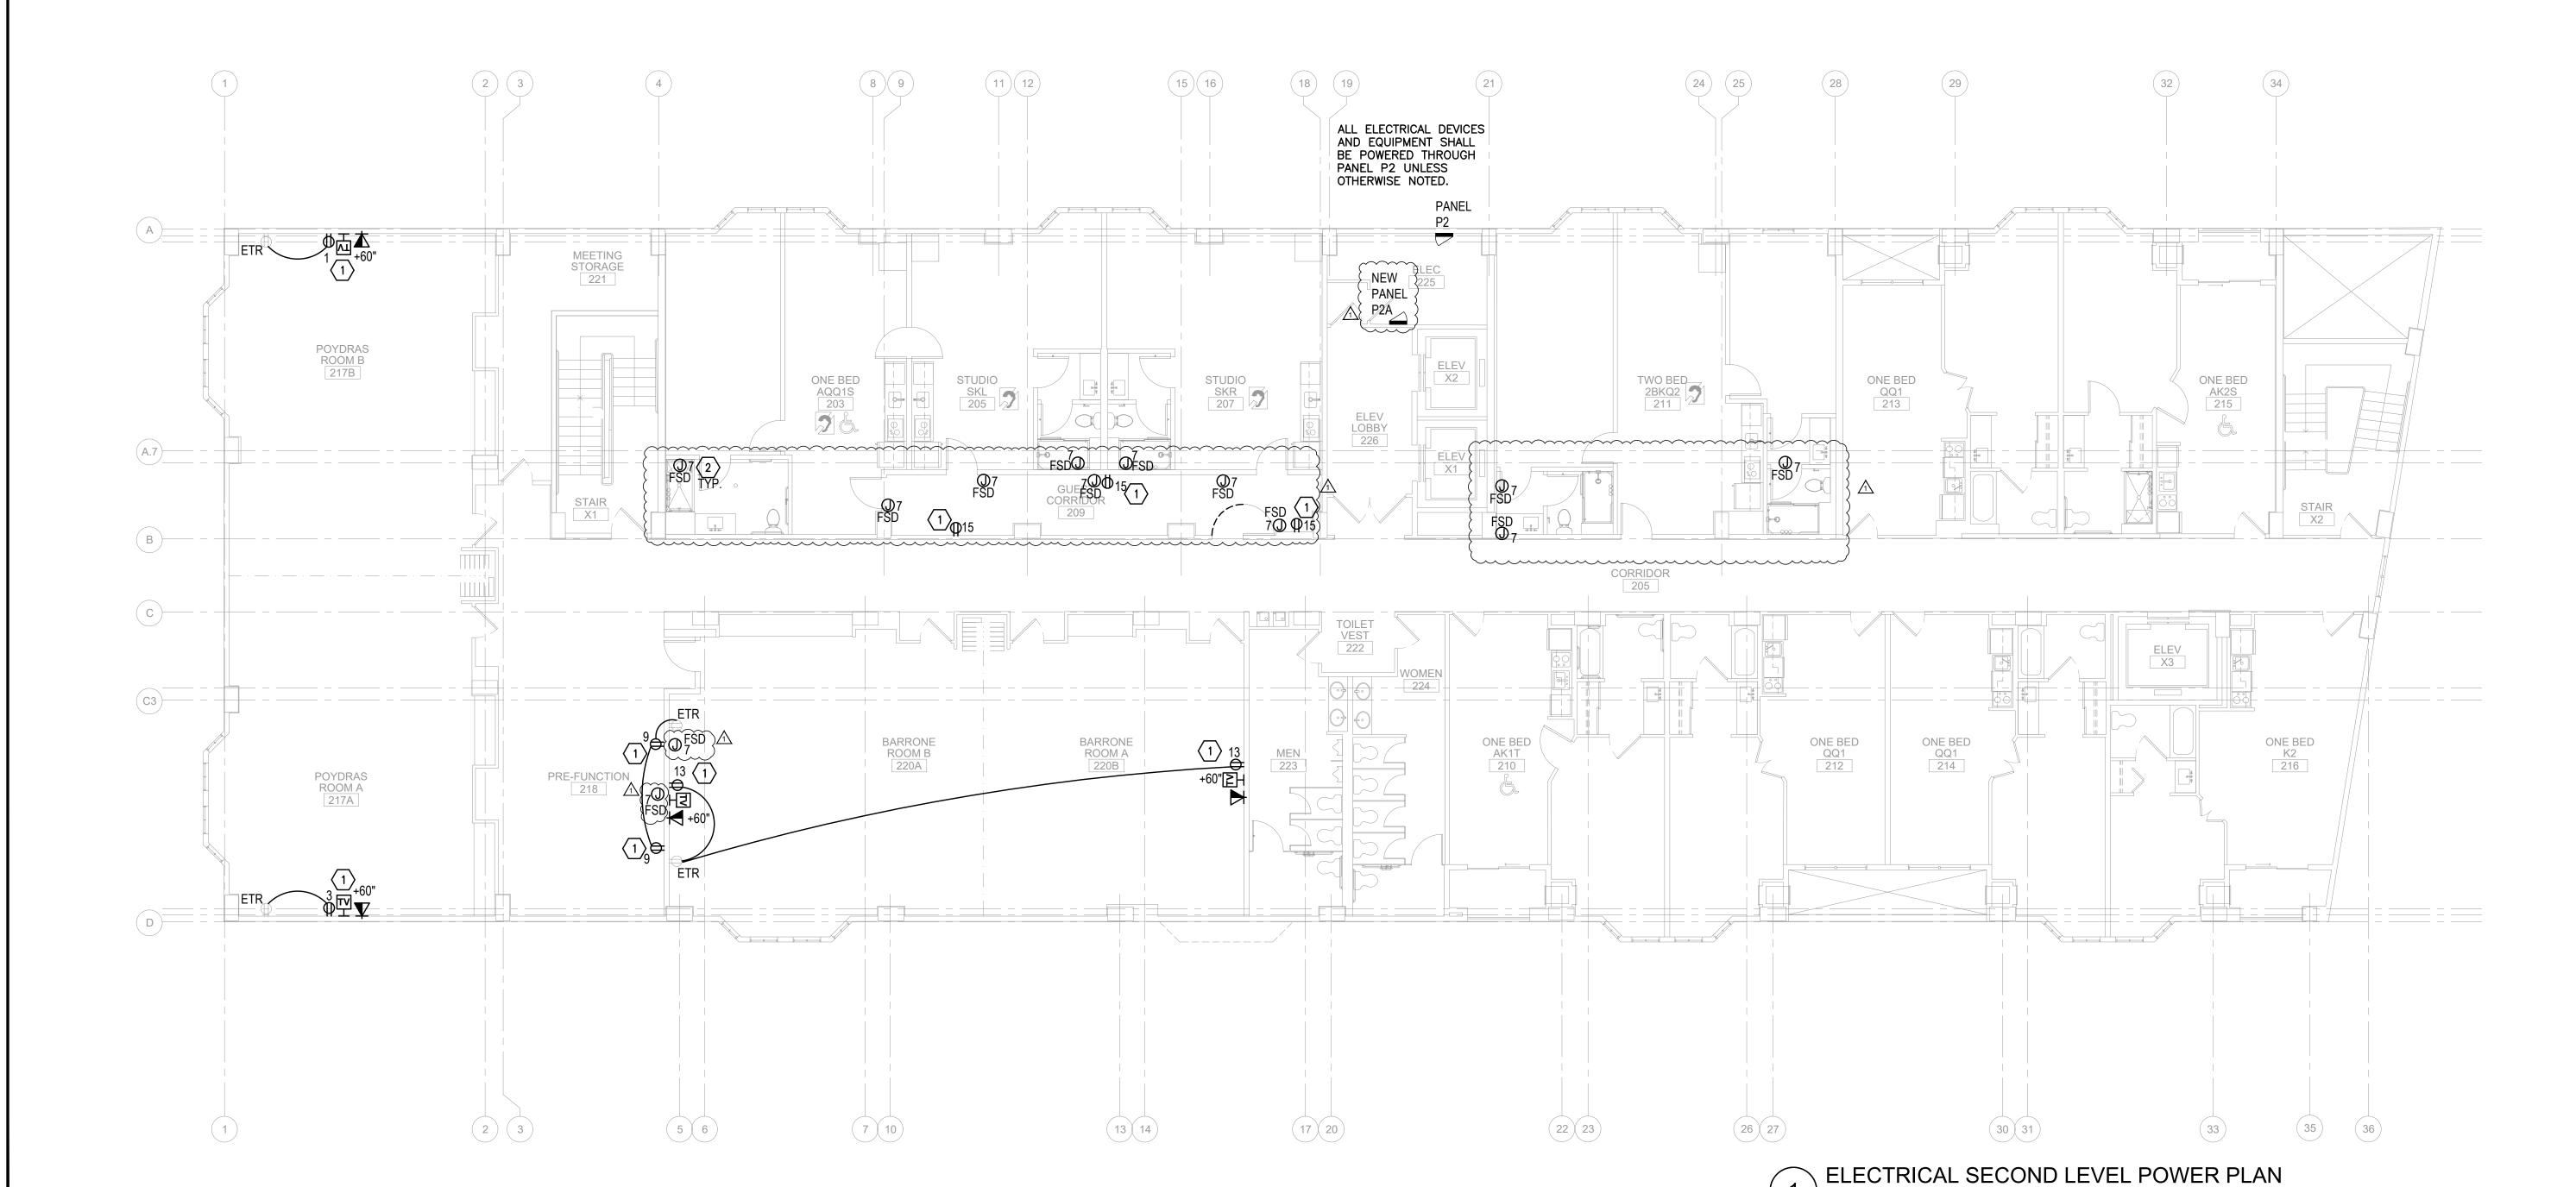

Project

HOMEWOOD SUITES by Hilton 901 Poydras Street New Orleans, LA





Issuance

No. Description Date

1 CONSTRUCTION 03/07

DOCUMENTS 2022

Drawn By:

KS

Checked By:

JB


Project No.

1335


Drawing Title

ELECTRICAL SECOND LEVEL POWER PLAN

Drawing Scale:

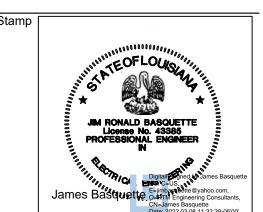

E1.02

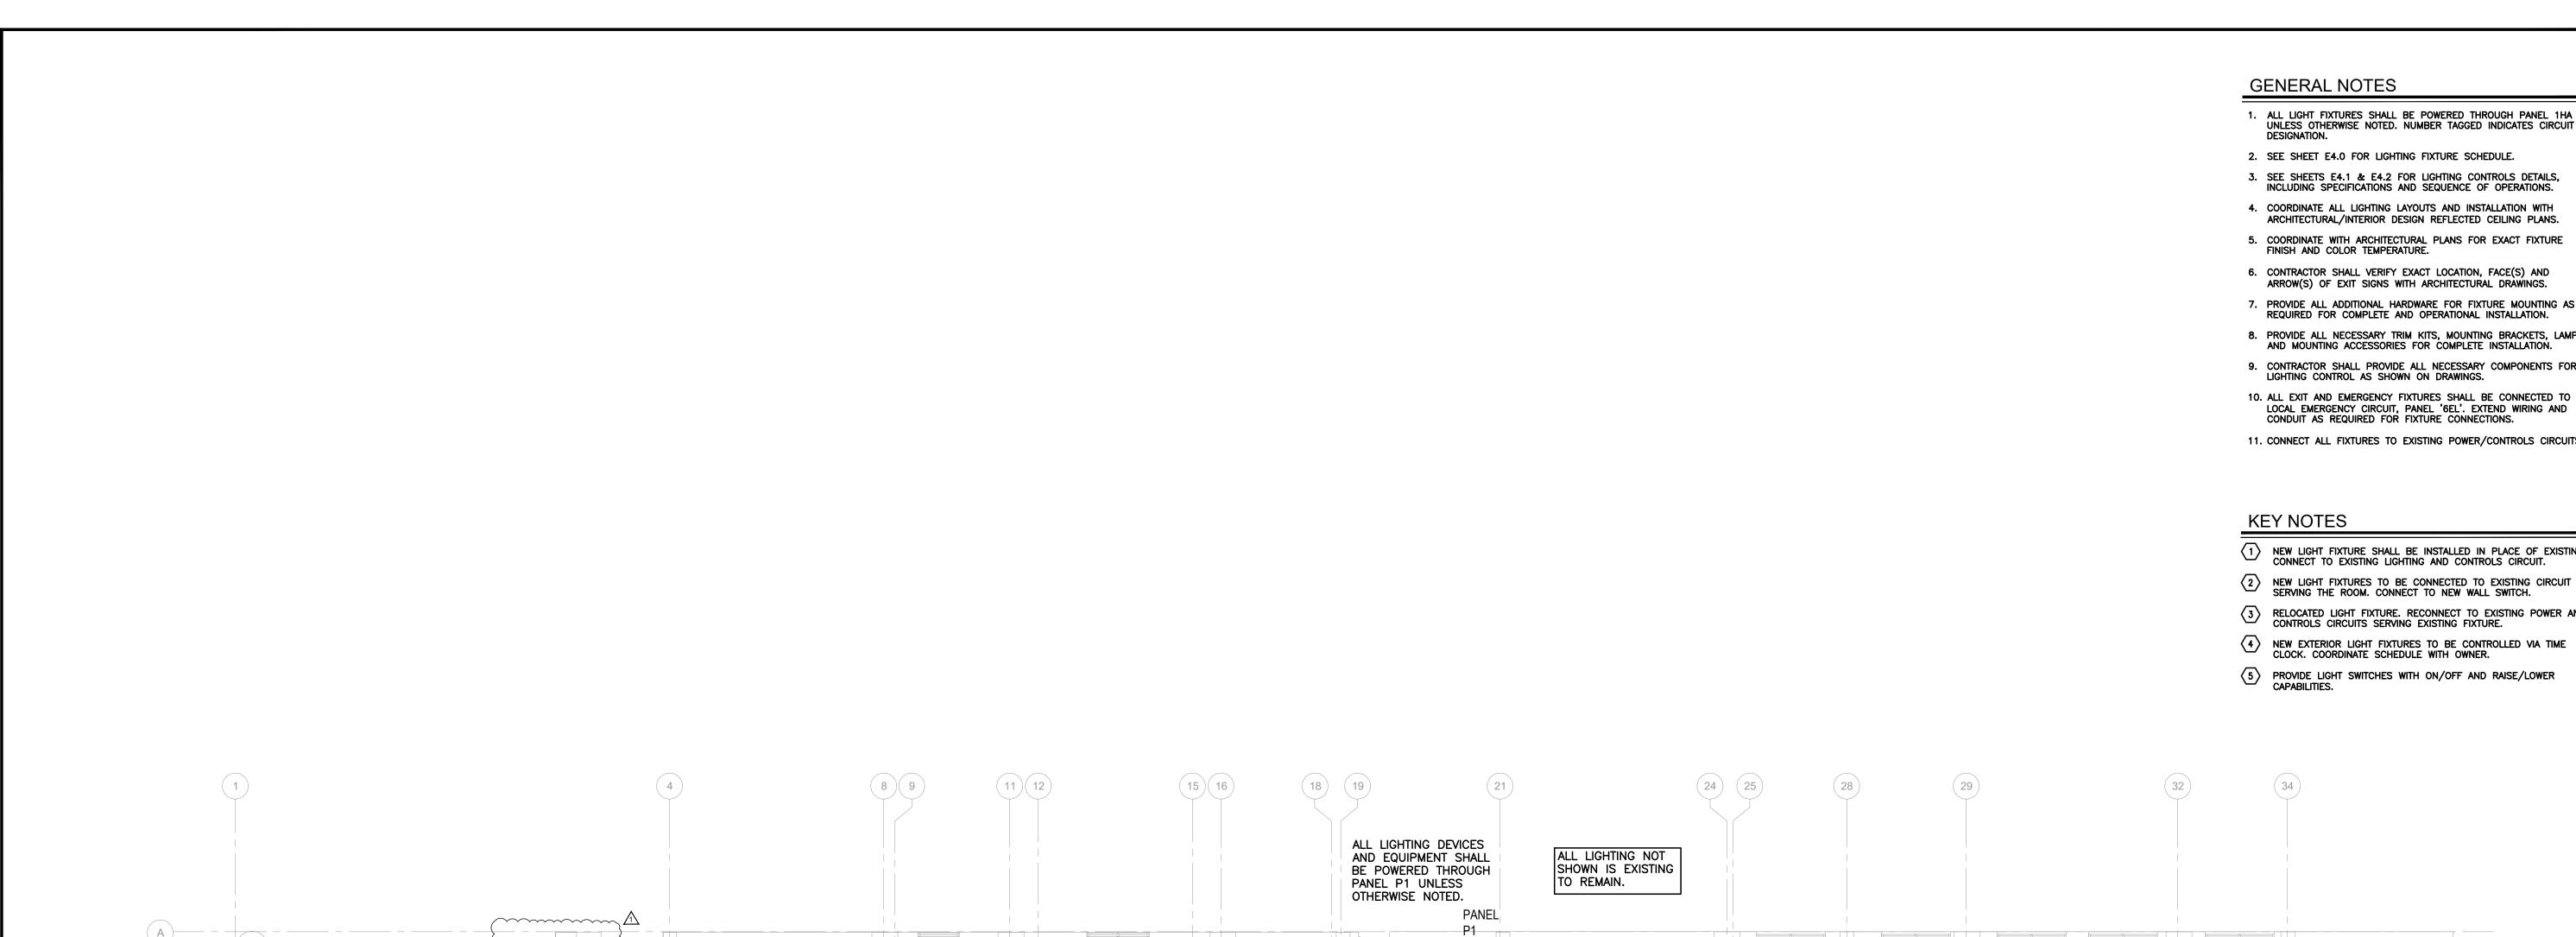

- 2. SEE SHEET E4.0 FOR LIGHTING FIXTURE SCHEDULE.
- 3. SEE SHEETS E4.1 & E4.2 FOR LIGHTING CONTROLS DETAILS, INCLUDING SPECIFICATIONS AND SEQUENCE OF OPERATIONS.
- ARCHITECTURAL/INTERIOR DESIGN REFLECTED CEILING PLANS.
- 5. COORDINATE WITH ARCHITECTURAL PLANS FOR EXACT FIXTURE FINISH AND COLOR TEMPERATURE.
- 6. CONTRACTOR SHALL VERIFY EXACT LOCATION, FACE(S) AND ARROW(S) OF EXIT SIGNS WITH ARCHITECTURAL DRAWINGS.
- 7. PROVIDE ALL ADDITIONAL HARDWARE FOR FIXTURE MOUNTING AS REQUIRED FOR COMPLETE AND OPERATIONAL INSTALLATION.
- 8. PROVIDE ALL NECESSARY TRIM KITS, MOUNTING BRACKETS, LAMPS AND MOUNTING ACCESSORIES FOR COMPLETE INSTALLATION.
- 9. CONTRACTOR SHALL PROVIDE ALL NECESSARY COMPONENTS FOR LIGHTING CONTROL AS SHOWN ON DRAWINGS.
- 11. CONNECT ALL FIXTURES TO EXISTING POWER/CONTROLS CIRCUITS.
- 1) NEW LIGHT FIXTURE SHALL BE INSTALLED IN PLACE OF EXISTING. CONNECT TO EXISTING LIGHTING AND CONTROLS CIRCUIT.
- NEW LIGHT FIXTURES TO BE CONNECTED TO EXISTING CIRCUIT SERVING THE ROOM. CONNECT TO NEW WALL SWITCH.
- RELOCATED LIGHT FIXTURE. RECONNECT TO EXISTING POWER AND CONTROLS CIRCUITS SERVING EXISTING FIXTURE.
- NEW EXTERIOR LIGHT FIXTURES TO BE CONTROLLED VIA TIME CLOCK. COORDINATE SCHEDULE WITH OWNER.
- PROVIDE LIGHT SWITCHES WITH ON/OFF AND RAISE/LOWER

HOMEWOOD ALL LIGHT FIXTURES SHALL BE POWERED THROUGH PANEL 1HA
 UNLESS OTHERWISE NOTED. NUMBER TAGGED INDICATES CIRCUIT SUITES by Hilton 901 Poydras Street

Project



New Orleans, LA



Issuance


No.	Description	Date
1	CONSTRUCTION	03/07
	DOCUMENTS	2022

Drawn By: Checked By: Project No. 1335


Drawing Title

**ELECTRICAL** FIRST LEVEL LIGHTING PLAN

Drawing Scale:

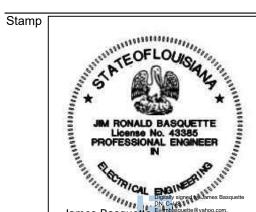

E2.00

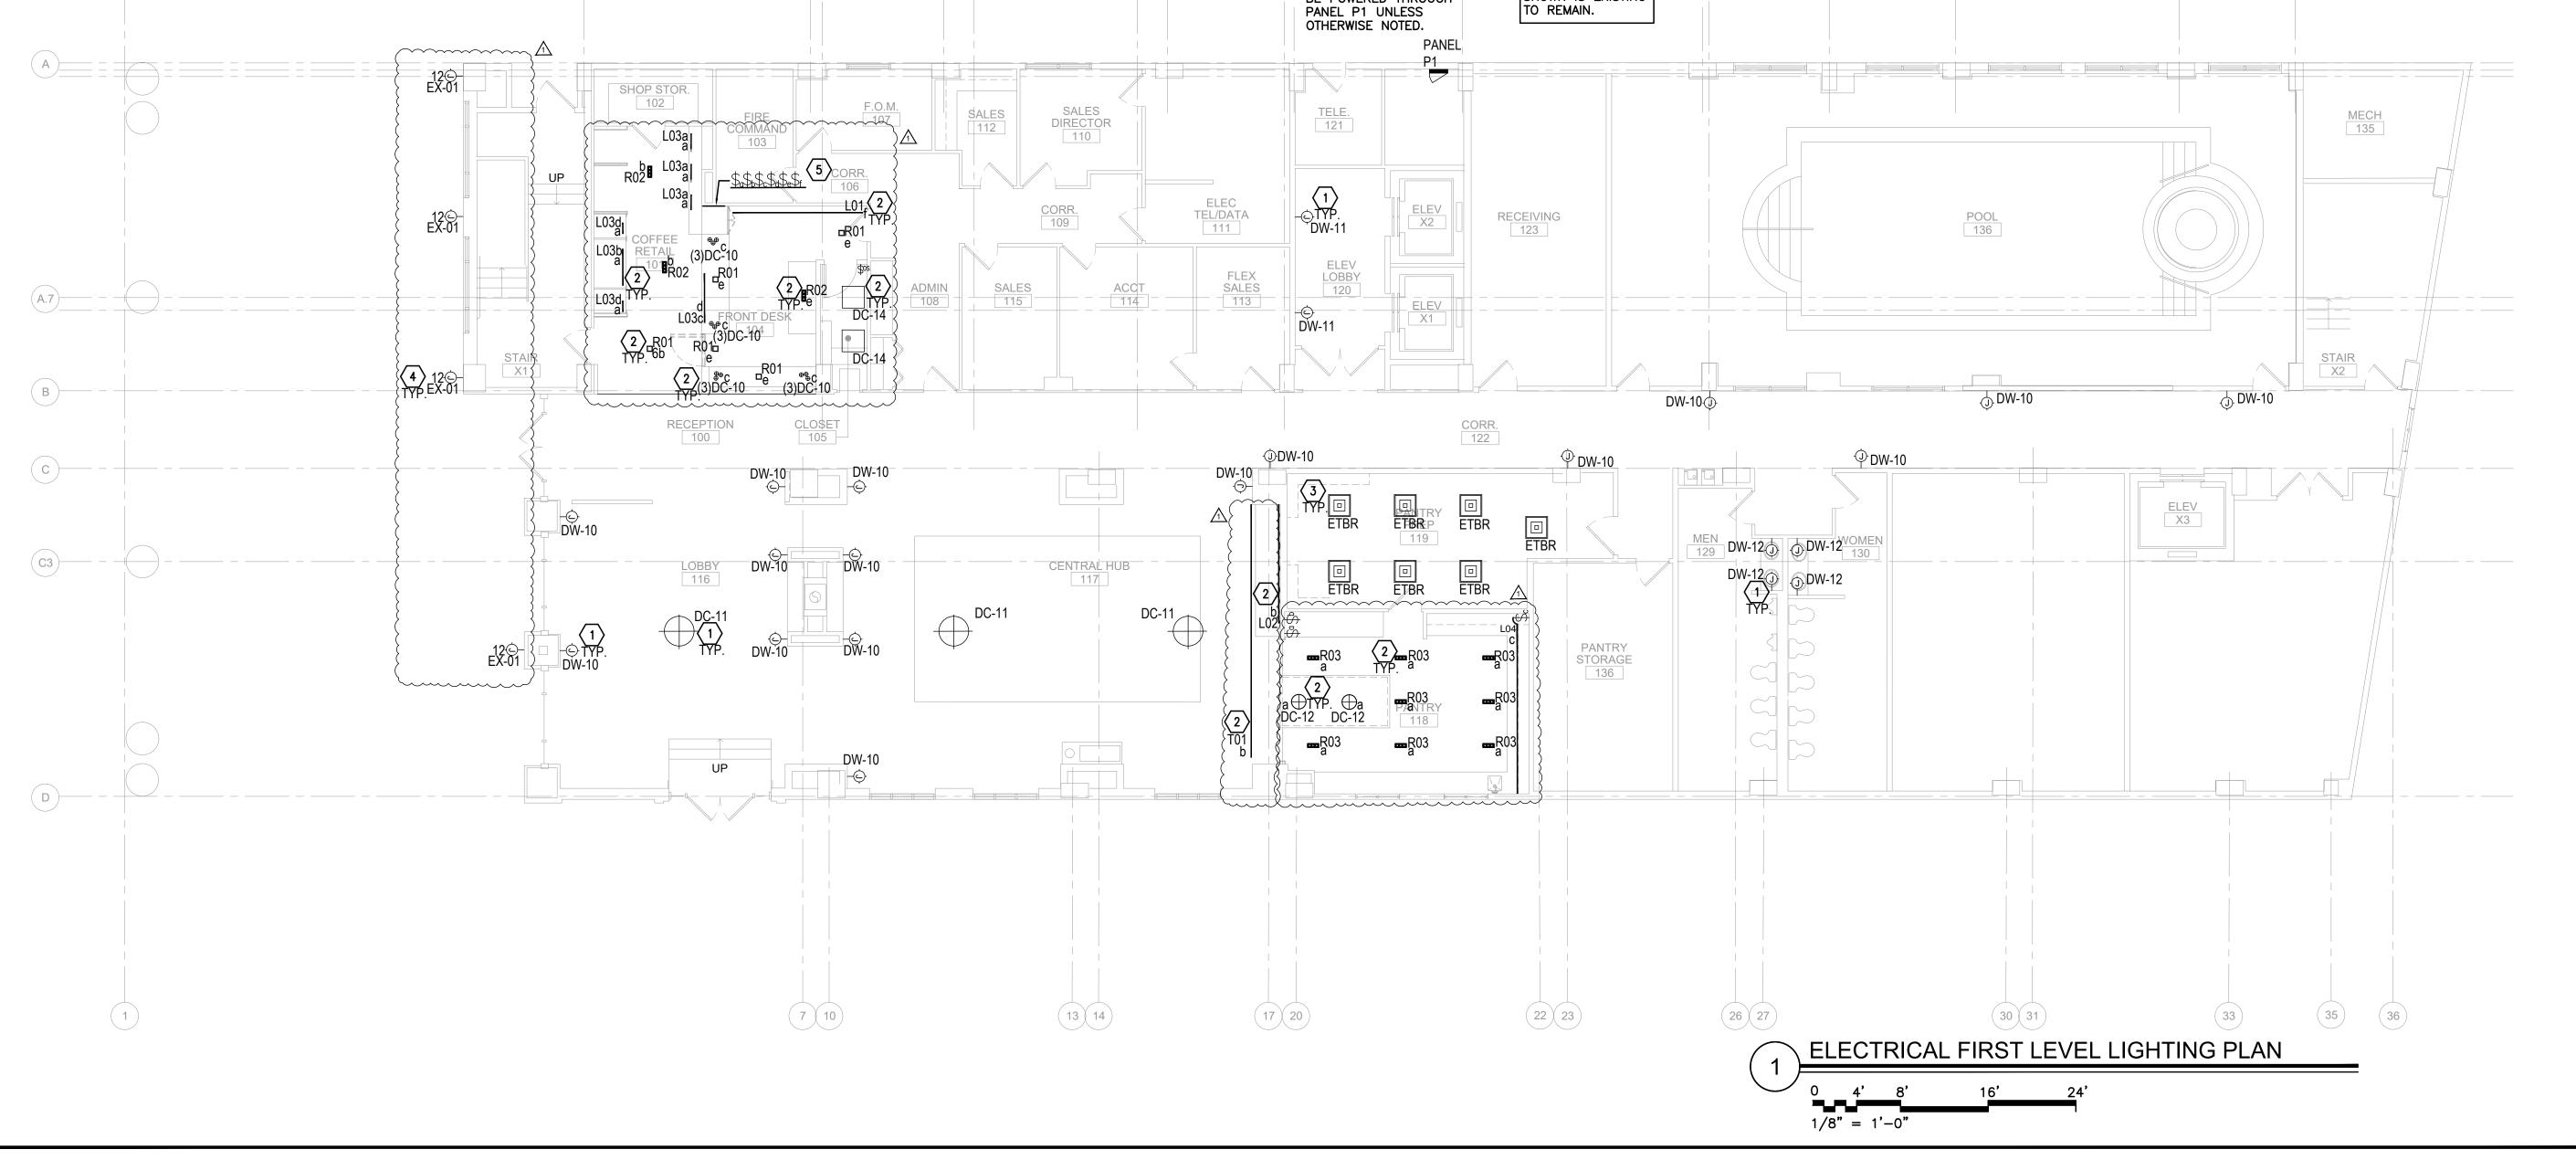

# **GENERAL NOTES** 4. COORDINATE ALL LIGHTING LAYOUTS AND INSTALLATION WITH **KEY NOTES** NEW LIGHT FIXTURES TO BE CONNECTED TO EXISTING CIRCUIT SERVING THE ROOM. CONNECT TO NEW WALL SWITCH. ALL LIGHTING DEVICES AND EQUIPMENT SHALL ALL LIGHTING NOT SHOWN IS EXISTING BE POWERED THROUGH TO REMAIN. PANEL PM UNLESS OTHERWISE NOTED. MAINT ELEC M08 OFFICE M26 BANQUET STORAGE STORAGE MAINT SHOP M06 HOUSEKEEPING M05 HSKPG STORAGE M04 CORRIDOR M01 ELEV LOBBY M09 BOARD ROOM M13 CORRIDOR M03 CORRIDOR M14 \$ETR

(C3)————

ALL LIGHT FIXTURES SHALL BE POWERED THROUGH PANEL 1HA UNLESS OTHERWISE NOTED. NUMBER TAGGED INDICATES CIRCUIT DESIGNATION.

2. SEE SHEET E4.0 FOR LIGHTING FIXTURE SCHEDULE.

- 3. SEE SHEETS E4.1 & E4.2 FOR LIGHTING CONTROLS DETAILS,
- INCLUDING SPECIFICATIONS AND SEQUENCE OF OPERATIONS.
- ARCHITECTURAL/INTERIOR DESIGN REFLECTED CEILING PLANS.
- 5. COORDINATE WITH ARCHITECTURAL PLANS FOR EXACT FIXTURE FINISH AND COLOR TEMPERATURE.
- 6. CONTRACTOR SHALL VERIFY EXACT LOCATION, FACE(S) AND ARROW(S) OF EXIT SIGNS WITH ARCHITECTURAL DRAWINGS.
- 7. PROVIDE ALL ADDITIONAL HARDWARE FOR FIXTURE MOUNTING AS REQUIRED FOR COMPLETE AND OPERATIONAL INSTALLATION.
- 8. PROVIDE ALL NECESSARY TRIM KITS, MOUNTING BRACKETS, LAMPS AND MOUNTING ACCESSORIES FOR COMPLETE INSTALLATION.
- 9. CONTRACTOR SHALL PROVIDE ALL NECESSARY COMPONENTS FOR LIGHTING CONTROL AS SHOWN ON DRAWINGS.
- 10. ALL EXIT AND EMERGENCY FIXTURES SHALL BE CONNECTED TO LOCAL EMERGENCY CIRCUIT, PANEL '6EL'. EXTEND WIRING AND CONDUIT AS REQUIRED FOR FIXTURE CONNECTIONS.
- 11. CONNECT ALL FIXTURES TO EXISTING POWER/CONTROLS CIRCUITS.
- 1 NEW LIGHT FIXTURE SHALL BE INSTALLED IN PLACE OF EXISTING. CONNECT TO EXISTING LIGHTING AND CONTROLS CIRCUIT.

STORAGE M21

LAUNDRY M23

DRYERS M25

LAUNDRY M20

□ ETBR

□ ETBR

30 31

MEZZANINE FLOOR - ELECTRICAL LIGHTING PLAN

HSKP OFFICE M22

26 27

1/8" = 1'-0"

EMP ROOM M15

22 23

FITNESS M12

MECH M11

17 20

13 14

7 10

- RELOCATED LIGHT FIXTURE. RECONNECT TO EXISTING POWER AND CONTROLS CIRCUITS SERVING EXISTING FIXTURE.

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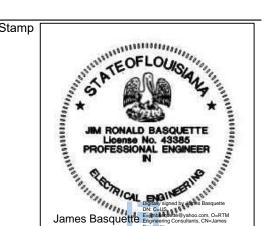


Issuance Description Date 03/07 CONSTRUCTION DOCUMENTS 2022


Drawn By: Checked By: Project No. 1335

Drawing Title

**ELECTRICAL** MEZZANINE LEVEL LIGHTING PLAN



E2.01

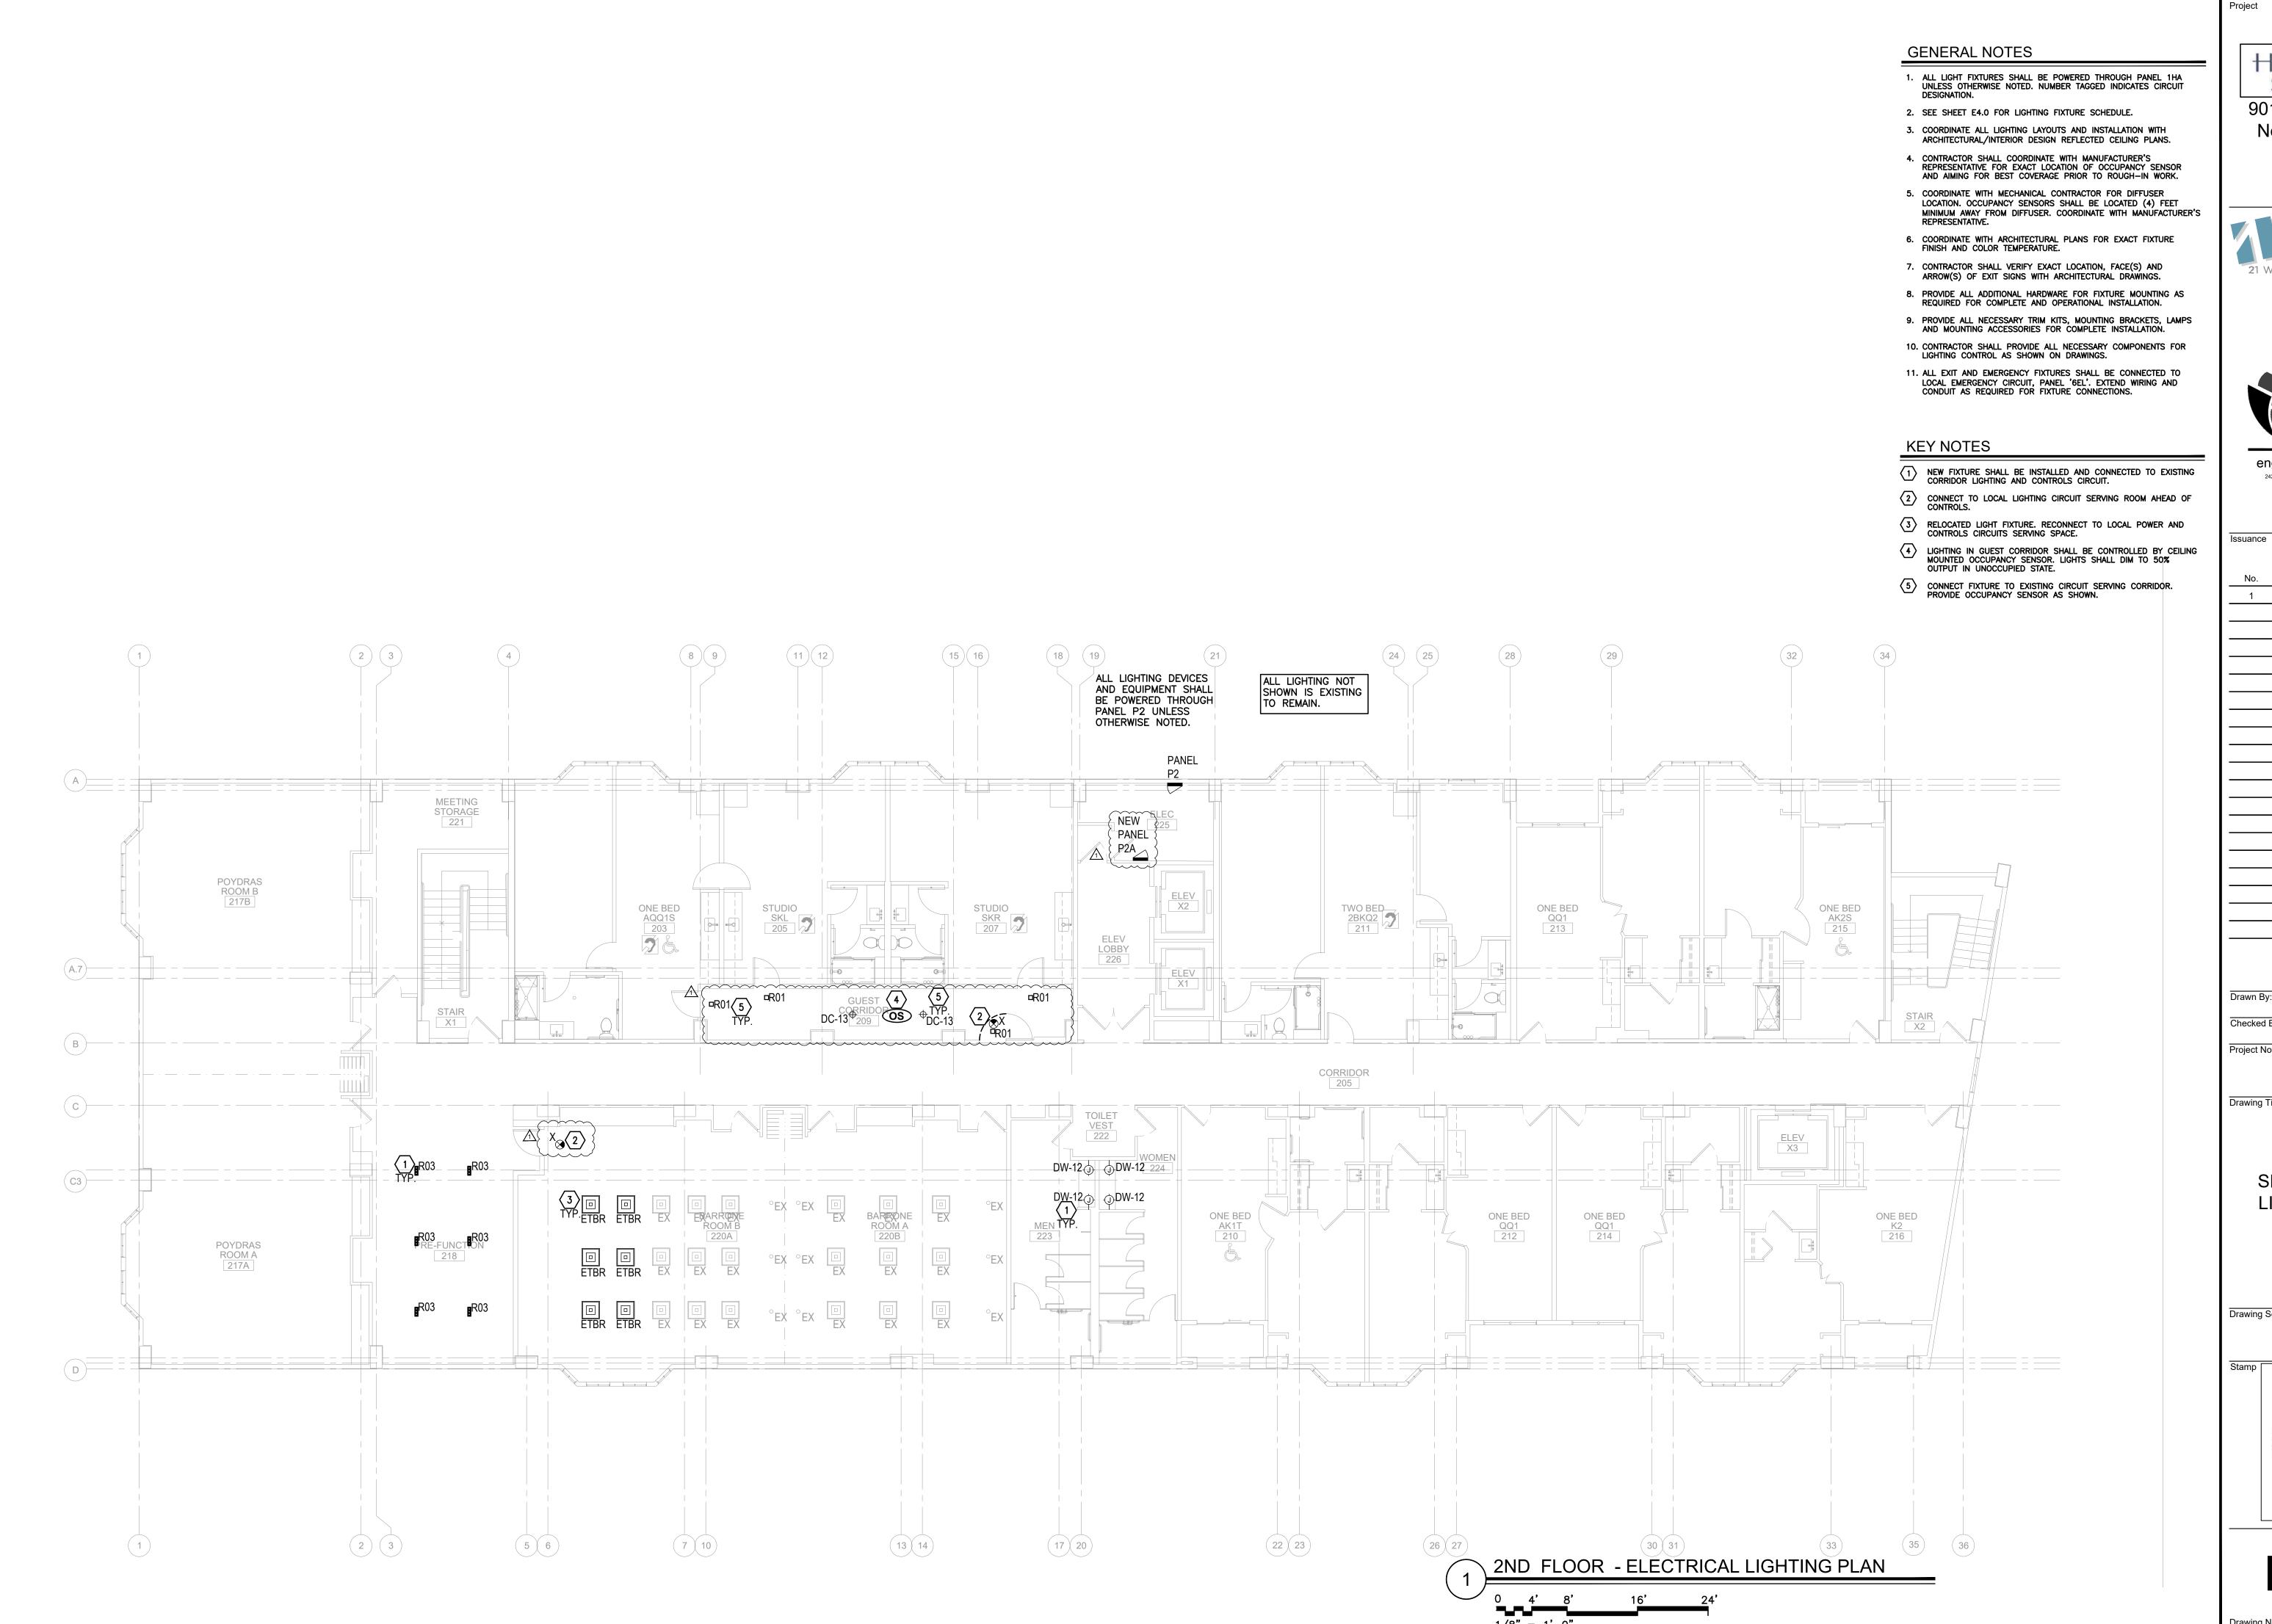

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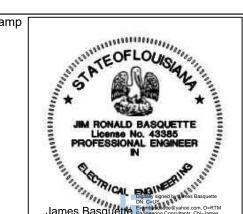
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No.	Description	Date
1	CONSTRUCTION	03/07
	DOCUMENTS	2022


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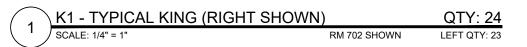
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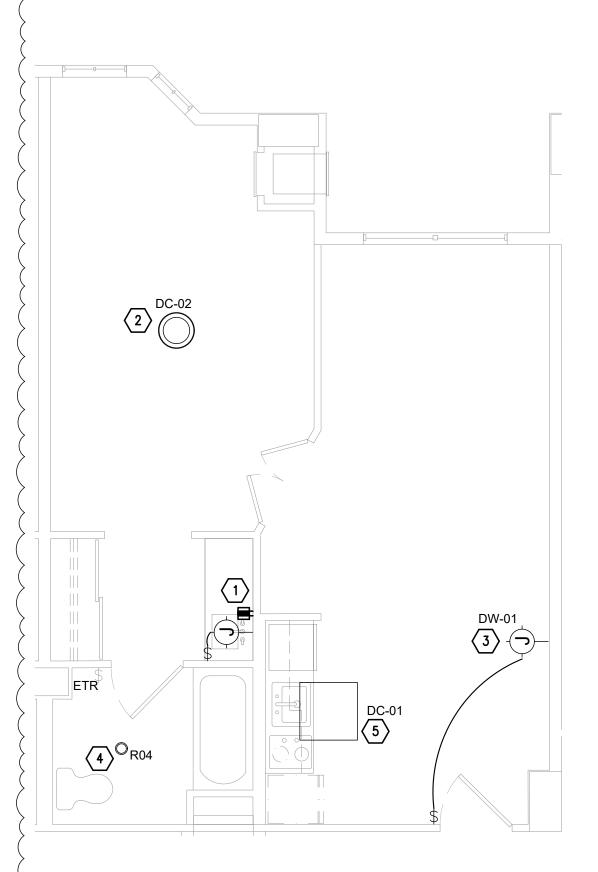
**ELECTRICAL** SECOND LEVEL LIGHTING PLAN




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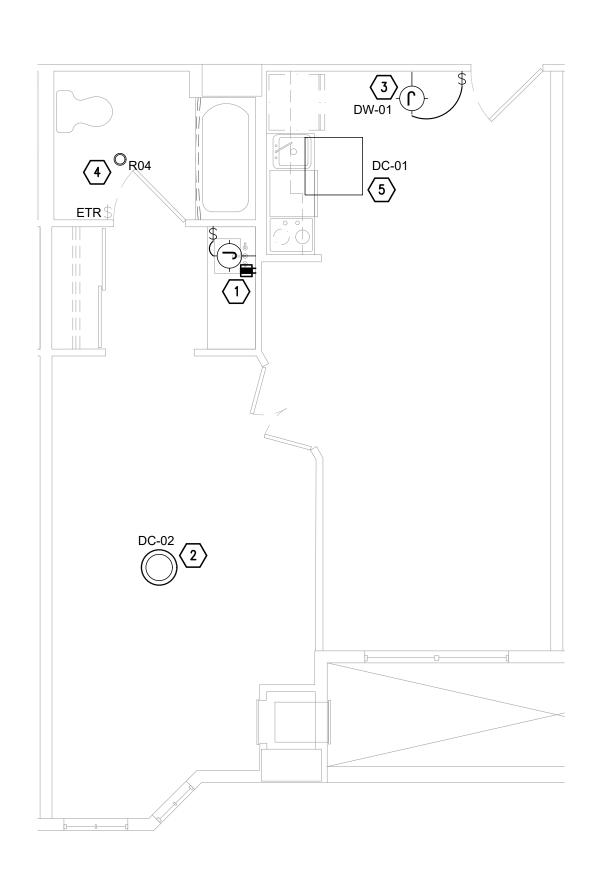







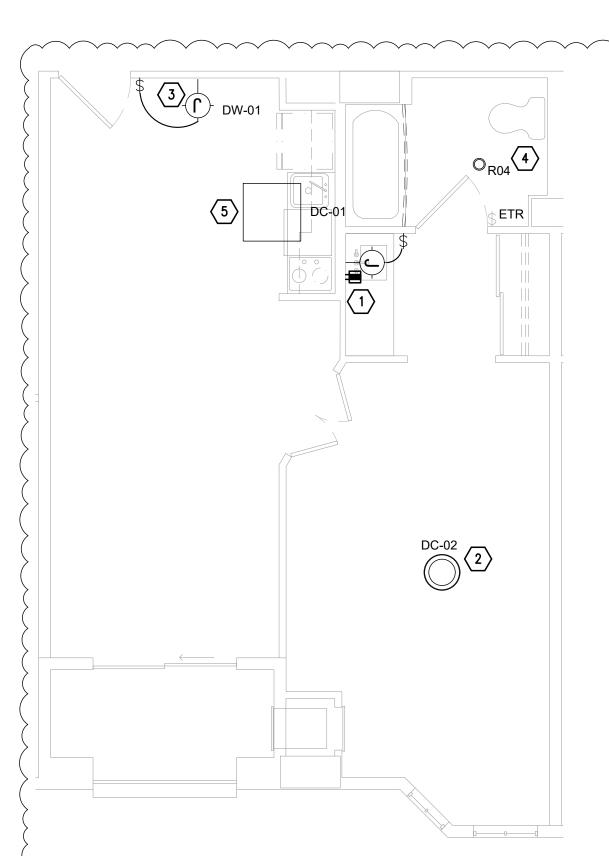

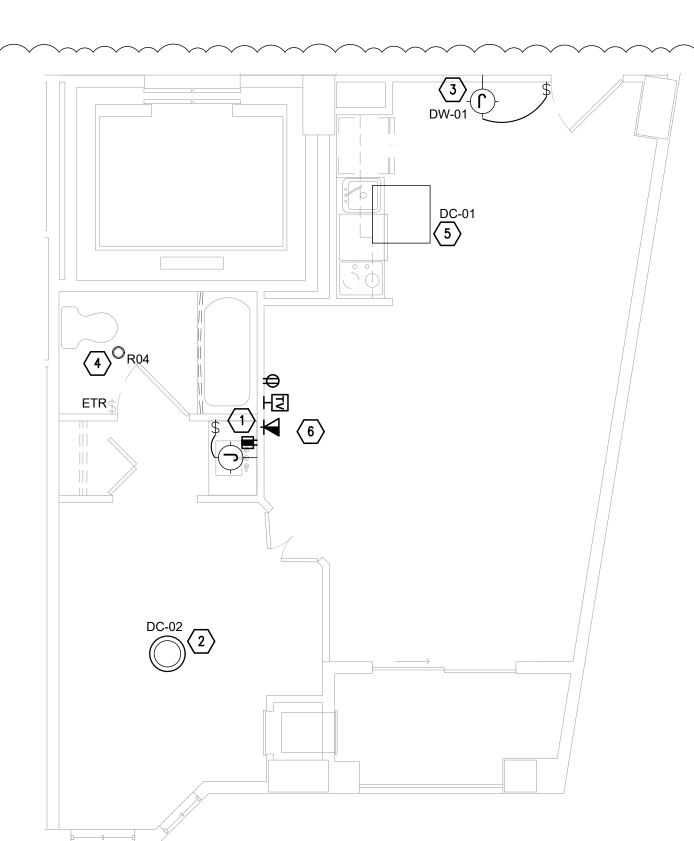




QQ1 - TYPICAL QUEEN/QUEEN (LEFT SHOWN) QTY: 19
SCALE: 1/4" = 1" RM 212 SHOWN RIGHT OTY: 15

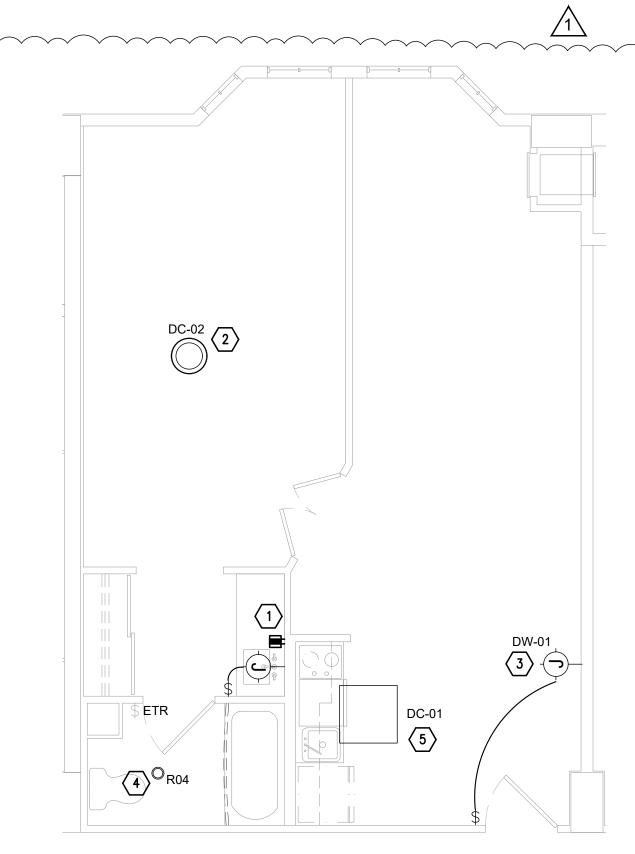

3 K3 - KING LONG LIVING ROOM BAY QTY: 10

SCALE: 1/4" = 1" RM 403 SHOWN

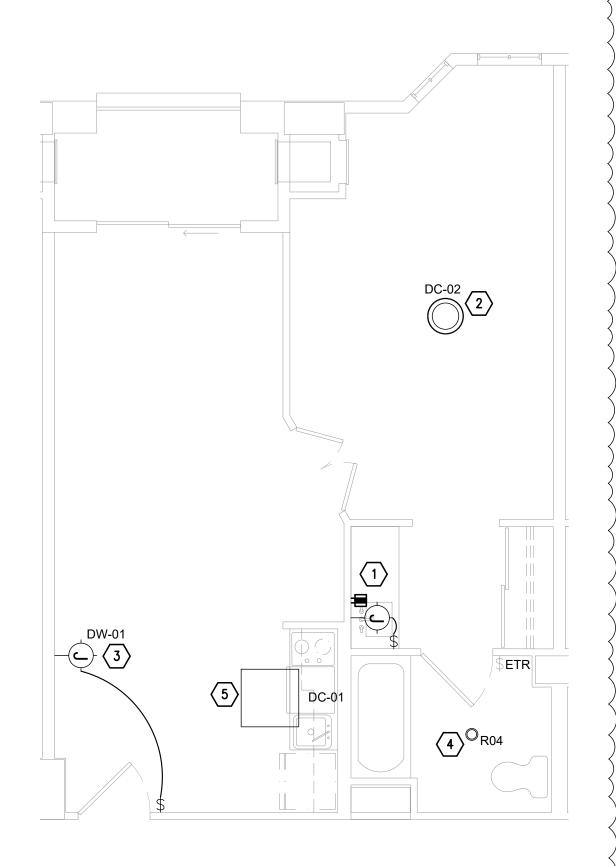

QQ2 - QN/QN SCONCE ON SIDE WALL (LEFT SHOWN) QTY: 4

# GENERAL NOTES

- 1. ALL ELECTRICAL DEVICES AND EQUIPMENT SHALL BE POWERED THROUGH PANEL 1LA UNLESS OTHERWISE NOTED. NUMBER TAGGED INDICATES CIRCUIT DESIGNATION.
- 2. RECEPTACLES AND DATA OUTLETS TO BE MOUNTED AT +18" AFF UNLESS NOTED OTHERWISE. VERIFY FINAL DEVICE MOUNTING HEIGHT AND RELATIVE PLACEMENT WITH OWNER/ARCHITECT PRIOR TO
- 3. TIE BACK ALL LOOSE WIRING (INCLUDING LOW VOLTAGE) IN AN ORDERLY FASHION.
- 4. ALL LOW VOLTAGE DEVICES AND WIRING SHALL BE INSTALLED BY A LOW VOLTAGE CONTRACTOR. ELECTRICAL CONTRACTOR SHALL ONLY PROVIDE DEVICE ROUGH—IN BOX AND 1-3/4" EMPTY CONDUIT FROM DEVICE BOX UP TO ACCESSIBLE CEILING SPACE.
- 5. IN AREAS WHERE THERE WILL BE NO CEILING, CONDUIT SHALL BE CONTINUOUS.
- 6. POWER OUTLETS MUST BE PROPERLY ALIGNED BETWEEN STUDS USING CADDY BRACKET WITH SPACING FOR (3) 4X4 JBOXES.
- 7. ALL DEVICES SHOWN ARE NEW UNLESS OTHERWISE NOTED.
- 8. CONDUCTOR INSULATION TYPE SHALL BE THW/THWN.
- 9. WIRE OF #8 AND LARGER SHALL BE STRANDED. WIRE OF #10 AND SMALLER SHALL BE SOLID.
- 10. CONTRACTOR SHALL COORDINATE FINAL ATTACHMENT REQUIREMENTS FOR ALL ELECTRICAL AND LOW VOLTAGE DEVICES LOCATED WITHIN FURNITURE.
- 11. ALL RECEPTACLES SHALL BE TAMPER RESISTANT PER 2014 NEC.

# KEY NOTES

- EXISTING JUNCTION BOX TO BE REMOVED. NEW CLOCK OUTLET SHALL BE INSTALLED AT EXISTING JUNCTION BOX LOCATION.
- EXISTING CEILING FAN TO BE REMOVED. NEW LIGHT FIXTURE SHALL BE INSTALLED AT EXISTING CEILING FAN LOCATION. CONNECT TO EXISTING POWER AND CONTROLS CIRCUIT.
- EXISTING JUNCTION BOX TO BE REMOVED. NEW WALL SCONCE SHALL BE INSTALLED AT EXISTING JUNCTION BOX LOCATION. CONNECT TO NEW WALL SWITCH.
- EXISTING COMBINATION EXHAUST FAN DOWNLIGHT TO BE REMOVED. NEW EXHAUST FAN TO BE INSTALLED IN EXISTING LOCATION. NEW DOWNLIGHT TO BE INSTALLED AND CONNECTED TO EXISTING POWER CIRCUIT. EXISTING SWITCH TO BE DISCONNECTED AND REWIRED TO NEW DOWNLIGHT.
- NEW FIXTURE SHALL BE INSTALLED IN EXISTING FIXTURE LOCATION. CONNECT TO EXISTING LIGHTING AND CONTROLS CIRCUIT
- 6 PROVIDE NEW POWER AND DATA MOUNTED AT 50" A.F.F. FOR NEW TV LOCATION. \*16 ROOM STACK ONLY.

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Project





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1 CONSTRUCTION 03/07
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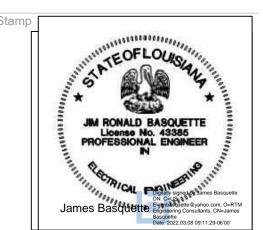
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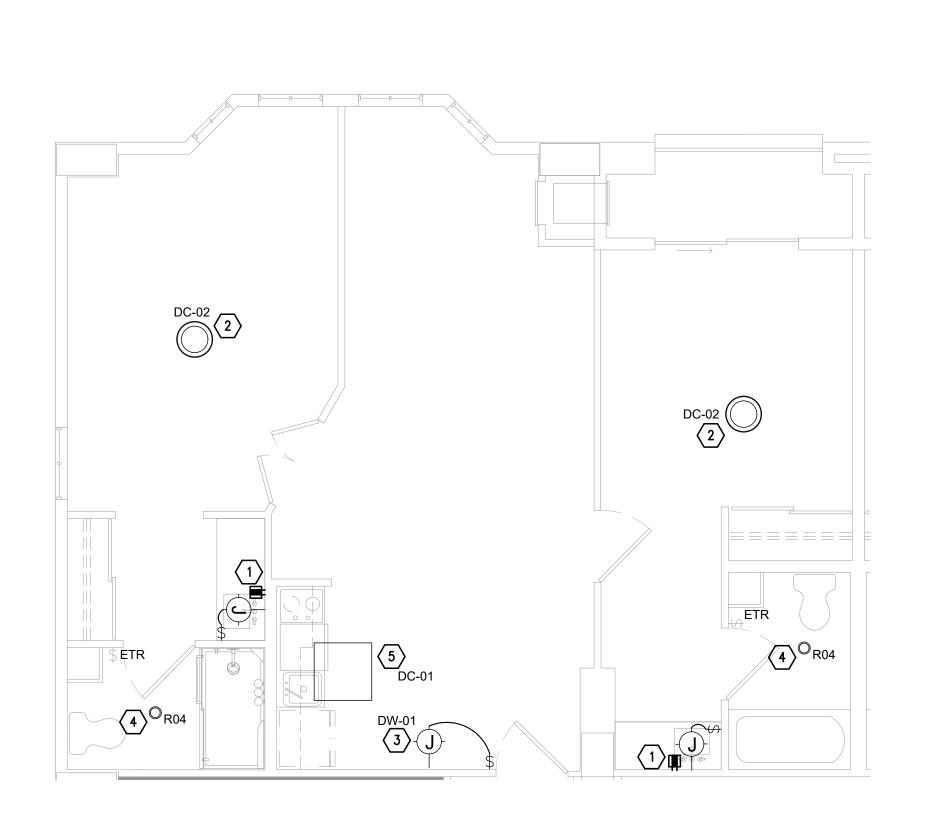
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ELECTRICAL ENLARGED PLANS


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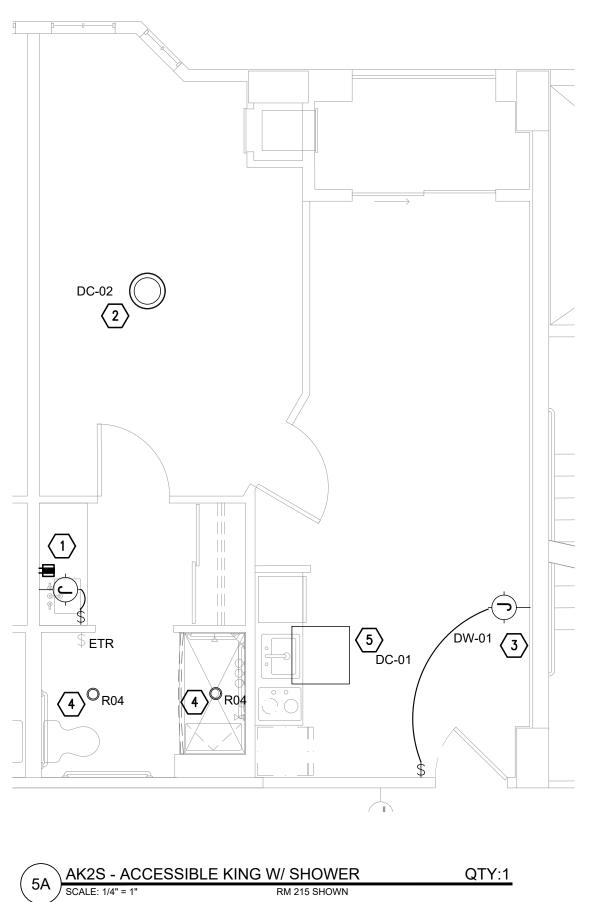



E3.00



1 2BKK - 2 BEDROOM KING/KING (RIGHT SHOWN) QTY:10
SCALE: 1/4" = 1" RM 1100 SHOWN LEFT QTY: 10




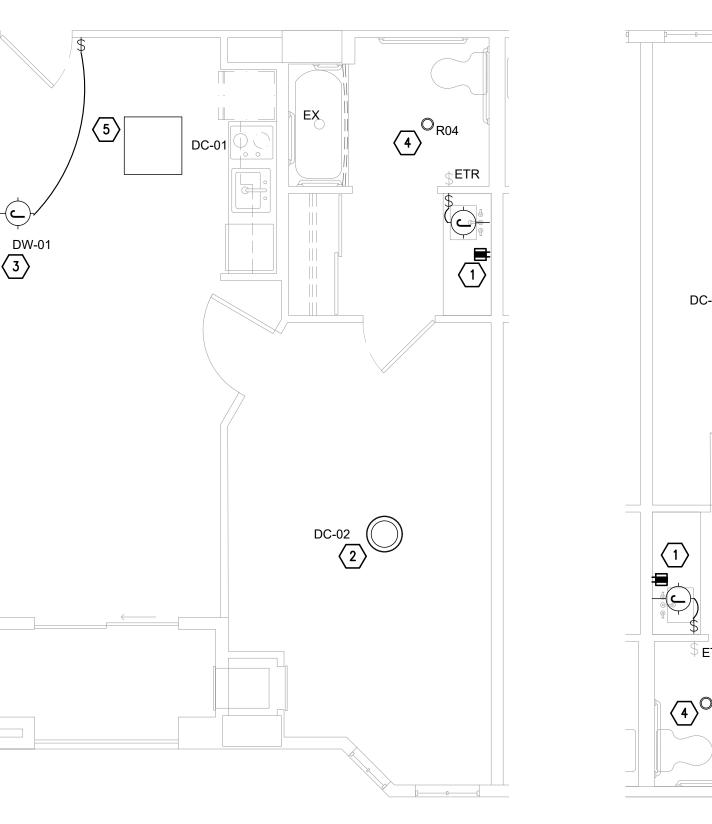

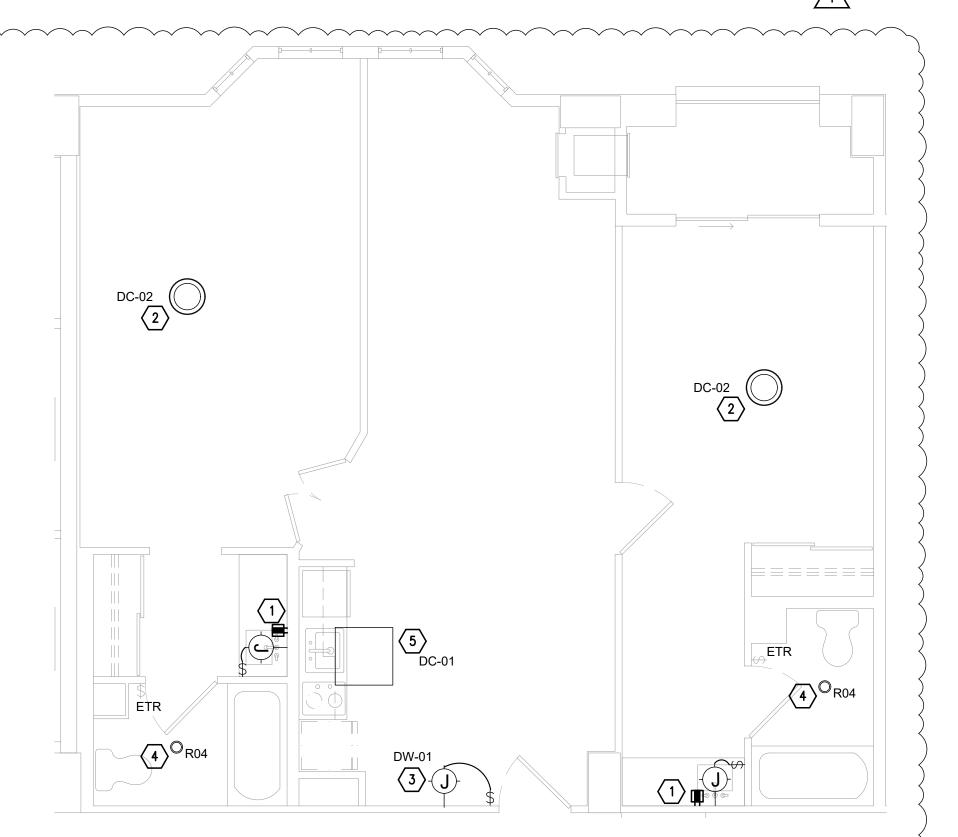

2 2BKQ1 - 2 BEDROOM KING/QUEEN QTY:8

SCALE: 1/4" = 1" RM 511 SHOWN

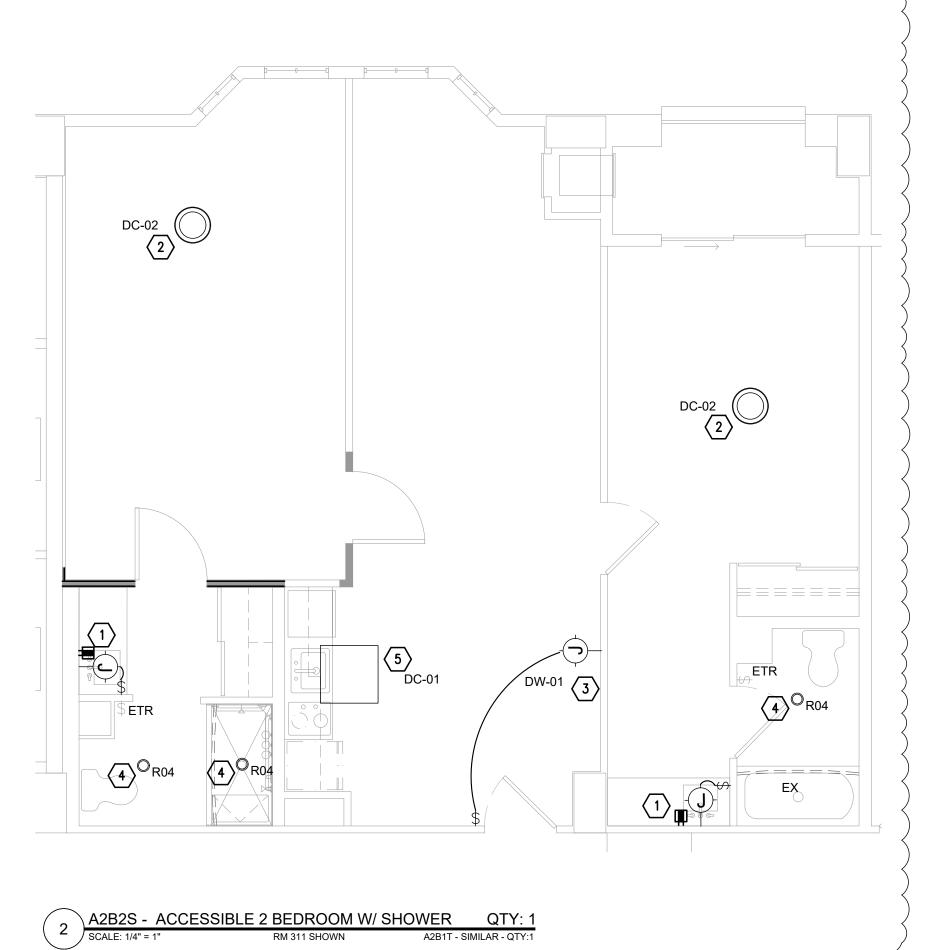

# GENERAL NOTES

- ALL ELECTRICAL DEVICES AND EQUIPMENT SHALL BE POWERED THROUGH PANEL 1LA UNLESS OTHERWISE NOTED. NUMBER TAGGED INDICATES CIRCUIT DESIGNATION.
- 2. RECEPTACLES AND DATA OUTLETS TO BE MOUNTED AT +18" AFF UNLESS NOTED OTHERWISE. VERIFY FINAL DEVICE MOUNTING HEIGHT AND RELATIVE PLACEMENT WITH OWNER/ARCHITECT PRIOR TO
- 3. TIE BACK ALL LOOSE WIRING (INCLUDING LOW VOLTAGE) IN AN ORDERLY FASHION.
- 4. ALL LOW VOLTAGE DEVICES AND WIRING SHALL BE INSTALLED BY A LOW VOLTAGE CONTRACTOR. ELECTRICAL CONTRACTOR SHALL ONLY PROVIDE DEVICE ROUGH—IN BOX AND 1—3/4" EMPTY CONDUIT FROM DEVICE BOX UP TO ACCESSIBLE CEILING SPACE.
- 5. IN AREAS WHERE THERE WILL BE NO CEILING, CONDUIT SHALL BE CONTINUOUS.
- 6. POWER OUTLETS MUST BE PROPERLY ALIGNED BETWEEN STUDS USING CADDY BRACKET WITH SPACING FOR (3) 4X4 JBOXES.
- 7. ALL DEVICES SHOWN ARE NEW UNLESS OTHERWISE NOTED.
- 8. CONDUCTOR INSULATION TYPE SHALL BE THW/THWN.
- 9. WIRE OF #8 AND LARGER SHALL BE STRANDED. WIRE OF #10 AND SMALLER SHALL BE SOLID.
- CONTRACTOR SHALL COORDINATE FINAL ATTACHMENT REQUIREMENTS FOR ALL ELECTRICAL AND LOW VOLTAGE DEVICES LOCATED WITHIN FURNITURE.
- 11. ALL RECEPTACLES SHALL BE TAMPER RESISTANT PER 2014 NEC.

# **KEY NOTES**

- EXISTING JUNCTION BOX TO BE REMOVED. NEW CLOCK OUTLET SHALL BE INSTALLED AT EXISTING JUNCTION BOX LOCATION.
- EXISTING CEILING FAN TO BE REMOVED. NEW LIGHT FIXTURE SHALL BE INSTALLED AT EXISTING CEILING FAN LOCATION. CONNECT TO EXISTING POWER AND CONTROLS CIRCUIT.
- EXISTING JUNCTION BOX TO BE REMOVED. NEW WALL SCONCE SHALL BE INSTALLED AT EXISTING JUNCTION BOX LOCATION. CONNECT TO NEW WALL SWITCH.
- EXISTING COMBINATION EXHAUST FAN DOWNLIGHT TO BE REMOVED. NEW EXHAUST FAN TO BE INSTALLED IN EXISTING LOCATION. NEW DOWNLIGHT TO BE INSTALLED AND CONNECTED TO EXISTING POWER CIRCUIT. EXISTING SWITCH TO BE DISCONNECTED AND REWIRED TO NEW DOWNLIGHT.
- 5 NEW FIXTURE SHALL BE INSTALLED IN EXISTING FIXTURE LOCATION. CONNECT TO EXISTING LIGHTING AND CONTROLS CIRCUIT.

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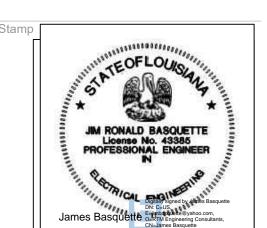
Project No.

1335

Drawing Title

ELECTRICAL ENLARGED PLANS

Drawing Scale:



E3.01

# GENERAL NOTES HEARING IMPAIRED RMS

- 1. FOR ROOMS INDICATED AS REQUIRING COMMUNICATIONS FEATURES, VISUAL NOTIFICATION DEVICES SHALL BE PROVIDED TO ALERT OCCUPANTS OR INCOMING TELEPHONE CALLS, A DOORKNOCK OR A BELL AND FIRE/SMOKE ALARM.
- 2. NOTIFICATION DEVICES SHALL NOT BE CONNECT TO THE VISUAL FIRE ALARM SIGNAL DEVICES.
- 3. TELEPHONES SHALL HAVE VOLUME CONTROLS COMPATIBLE WITH TE TELEPHONE SYSTEM. TELEPHONES SHALL HAVE AN ELECTRICAL OUTLET LOCATED WITHIN 48" OF THE TELEPHONE TO FACILITATE THE USE OF A TTY DEVICE.
- 4. CONTRACTOR SHALL VERIFY FIRE ALARM SYSTEMS AND SMOKE DETECTORS SHALL HAVE PERMANENTLY INSTALLED AUDIBLE AND VISUAL ALARMS.
- 5. DOORBELL HORN/STROBE DEVICES SHALL HAVE A PLAQUE WITH BLACK LETTERS THAT READS "DOOR BUTTON SIGNALER", PLAQUE SHALL BE SECURED WITH CLEAR SANITARY SEALANT.
- 6. PROVIDE SWITCH TO DISABLE DOORBELL, SWITCH SHALL BE SINGLE POLE TOGGLE TYPE WITH COVER PLATE AND PLAQUE. LOCATE SWITCH ON GUESTROOM SIDE OF DOOR, LOCATED NEXT TO LOCK STRIKE OF THE DOOR WITH AN APPLIED LABEL READING "DOORBELL SIGNAL OVERRIDE". SWITCH SHALL BE MOUNTED AT 46" AFF. PROVIDE GUESTROOM DOOR ANNUNCIATOR KIT AS FOLLOWS EDWARDS SIGNALING: SERIES CFA MODEL 7005-G5 HOTEL ROOM
- ANNUNCIATOR KIT OR EQUAL
  TO INCLUDE THE FOLLOWING COMPONENTS -MODEL 6536-G5 DOORBELL HORN STROBE -MODEL 592 TRANSFORMER -MODEL 620 DOORBELL PUSHBUTTON

-MODEL 147-1 FACEPLATE (NO TEXT ON FACEPLATE)

## HEARING IMPAIRED RMS KEYNOTES

- (H1) MOUNT DOORBELL PUSH BUTTON AT 46" AFF ON CORRIDOR SIDE OF DOOR NEXT TO LOCK STRIKE OF THE DOOR.
- PROVIDE JUNCTION BOX FOR CONNECTION TO DOOR ANNUNCIATOR
- KIT. CONNECT TO BEDROOM RECEPTACLE CIRCUIT.
- PROVIDE HORN/STROBE FOR CONNECTION TO THE DOOR ANNUNCIATOR KIT. CONTRACTOR SHALL MOUNT THE DOORBELL HORN/STROBE DEVICE AT 80" ABOVE THE FLOOR IN THE GUESTROOM.

CONTRACTOR SHALL MOUNT THE AUXILLARY DOORBELL HORN/STROBE ON THE BATHROOM WALL AT 80" AFF AND ANY ADDITIONAL ROOMS IN MULTI-ROOM UNITS.

# **GENERAL NOTES**


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- 3. TIE BACK ALL LOOSE WIRING (INCLUDING LOW VOLTAGE) IN AN ORDERLY FASHION.
- 4. ALL LOW VOLTAGE DEVICES AND WIRING SHALL BE INSTALLED BY A LOW VOLTAGE CONTRACTOR. ELECTRICAL CONTRACTOR SHALL ONLY PROVIDE DEVICE ROUGH-IN BOX AND 1-3/4" EMPTY CONDUIT FROM DEVICE BOX UP TO ACCESSIBLE CEILING SPACE.
- 5. IN AREAS WHERE THERE WILL BE NO CEILING, CONDUIT SHALL BE
- CONTINUOUS. 6. POWER OUTLETS MUST BE PROPERLY ALIGNED BETWEEN STUDS
- USING CADDY BRACKET WITH SPACING FOR (3) 4X4 JBOXES. 7. ALL DEVICES SHOWN ARE NEW UNLESS OTHERWISE NOTED.
- 8. CONDUCTOR INSULATION TYPE SHALL BE THW/THWN.
- 9. WIRE OF #8 AND LARGER SHALL BE STRANDED. WIRE OF #10 AND SMALLER SHALL BE SOLID.
- 10. CONTRACTOR SHALL COORDINATE FINAL ATTACHMENT REQUIREMENTS FOR ALL ELECTRICAL AND LOW VOLTAGE DEVICES LOCATED WITHIN
- 11. ALL RECEPTACLES SHALL BE TAMPER RESISTANT PER 2014 NEC.


# **KEY NOTES**

- 20A RECEPTACLE MOUNTED UNDERNEATH SINK FOR DISPOSAL. PROVIDE WITH GFCI CIRCUIT BREAKER. COORDINATE SWITCH
- LOCATION WITH ARCHITECTURAL DRAWINGS PRIOR TO ROUGH-IN. 20A RECEPTACLE FOR MICROWAVE OVEN. PROVIDE DEDICATED

CIRCUIT WITH GFCI CIRCUIT BREAKER.

20A RECEPTACLE FOR REFRIGERATOR. PROVIDE DEDICATED CIRCUIT WITH GFCI BREAKER.

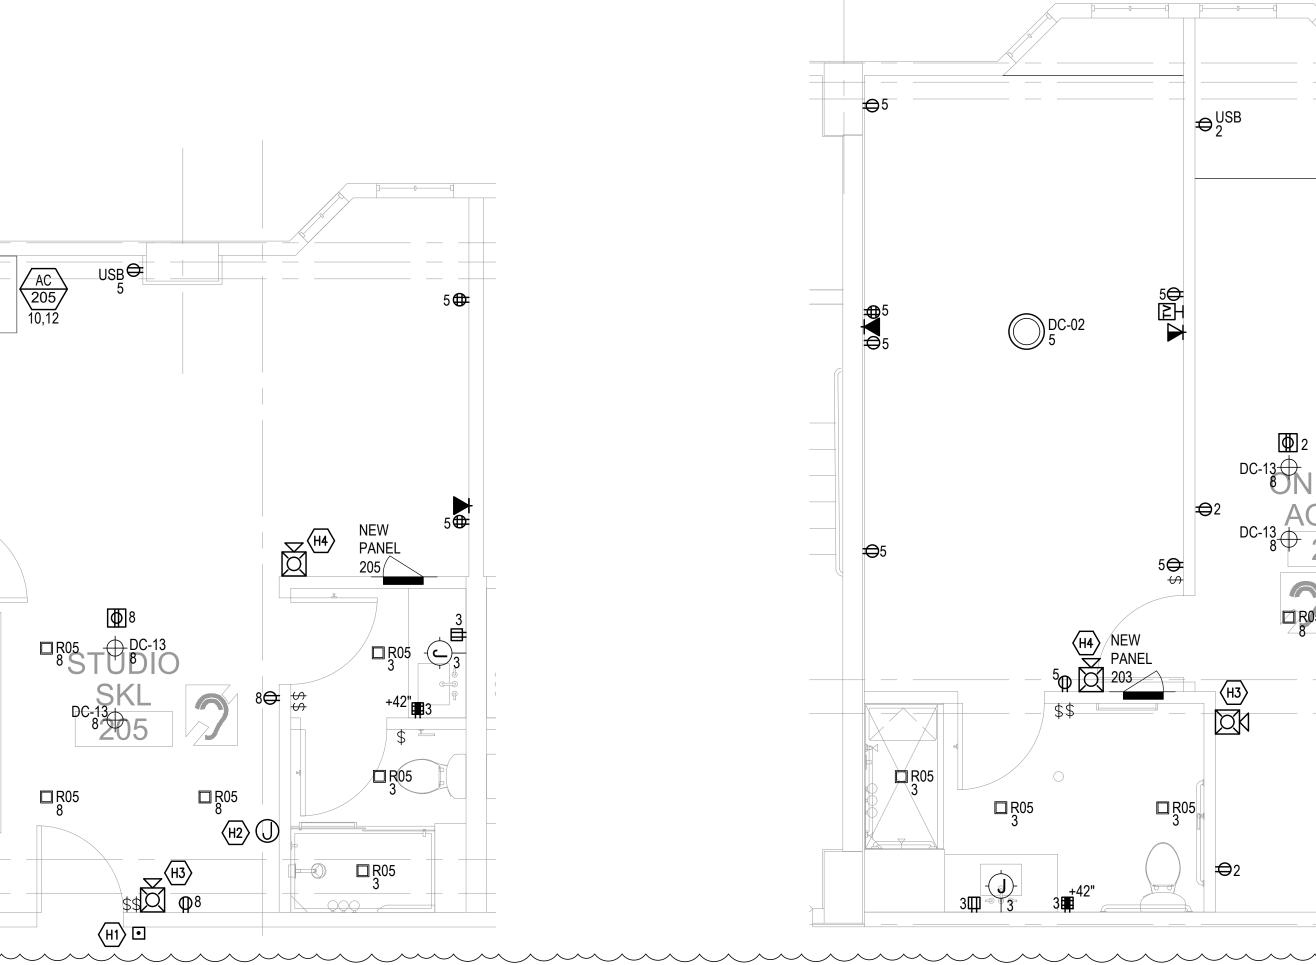


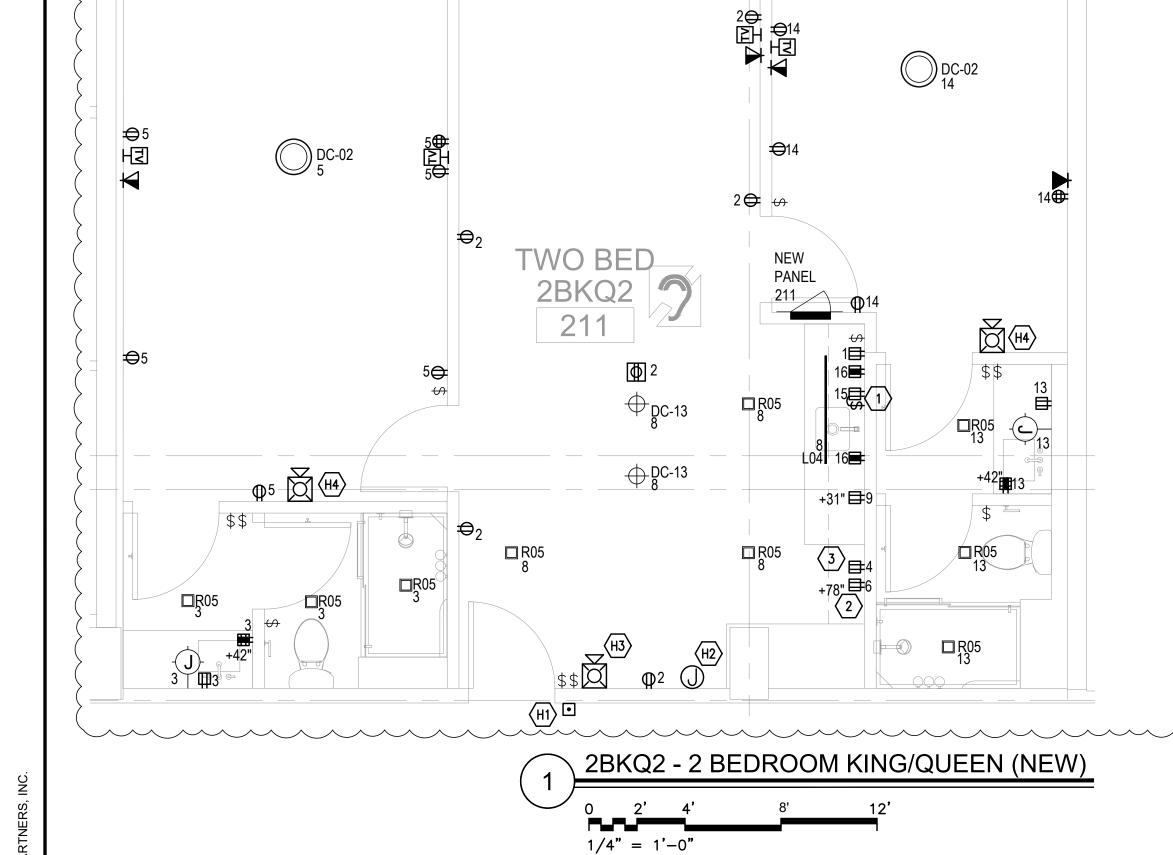

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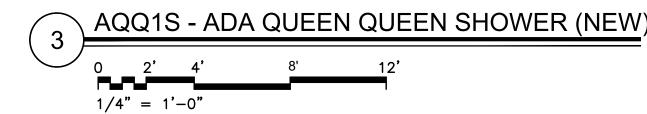
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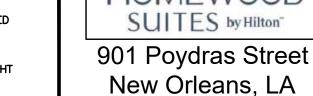
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**3**<sup>+18</sup> 4

• (H1)


Description Date 03/07 CONSTRUCTION DOCUMENTS 2022
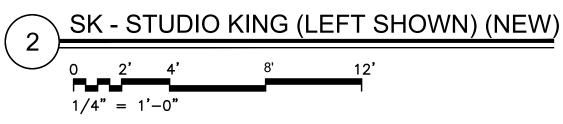
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**ELECTRICAL ENLARGED** POWER/LIGHTING **PLANS** 

Drawing Scale:

Drawing Title

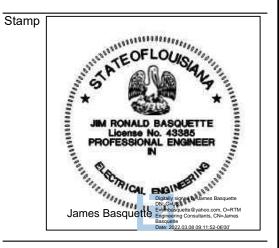


E3.02

# GENERAL NOTES

- 1. THE ELECTRICAL DEMOLITION PLAN IS TO BE USED AS AN OVERALL GUIDE TO THE SCOPE OF DEMOLITION WORK BEING PERFORMED. ELECTRICAL CONTRACTOR SHALL VERIFY AND CONFIRM EXACT SCOPE OF WORK AND PHASING WITH AN AUTHORIZED OWNER FIELD REPRESENTATIVE PRIOR TO BID AND COMMENCEMENT OF WORK.
- 2. THE EXISTING CONDITIONS ARE BASED ON "AS-BUILT" DRAWINGS AND/OR LIMITED FIELD VERIFICATIONS, AND MAY NOT SHOW ALL DEVICES/FIXTURES TO BE REMOVED. THE CONTRACTOR SHALL ADJUST TO ACTUAL FIELD CONDITIONS, ANY DISCREPANCIES SHALL BE IMMEDIATELY REPORTED TO THE ENGINEER FOR RESOLUTION.
- ALL EXISTING DEVICES/FIXTURES SHALL BE REMOVED UNLESS NOTED OTHERWISE, ITEMS MARKED WITH <E> ARE EXISTING TO REMAIN.
- 4. REMOVE ALL EXISTING WIRING AND CONDUIT BACK TO NEAREST DEVICE INDICATED TO REMAIN, OR TO SOURCE PANEL, WHICHEVER IS CLOSER. PRESERVE CONTINUITY OF ALL EXISTING CIRCUITS TO PENAIN
- VERIFY FUNCTIONALITY OF ALL EXISTING DEVICES/FIXTURES TO REMAIN, REPLACES AS NECESSARY.
- 6. THE CONTRACTOR SHALL REVIEW ALL EXISTING CONDUIT, WIRING, JUNCTION BOXES, AND ELECTRICAL, COMMUNICATION AND LIFE SAFETY DEVICES WITH THE LANDLORD AND TENANT REPRESENTATIVES PRIOR TO THE COMMENCEMENT OF ANY DEMOLITION WORK FOR THIS PROJECT. ALL EXISTING ITEMS TO REMAIN SHALL BE PROPERLY MARKED AT THE PROJECT SITE IN ACCORDANCE WITH THE REQUIREMENTS OF THE LANDLORD.
- 7. ALL MATERIALS SCHEDULED TO BE REMOVED SHALL BECOME THE PROPERTY OF THE CONTRACTOR. THE CONTRACTOR SHALL BE RESPONSIBLE FOR ALL HAULING AND DISPOSAL OF THE DEBRIS IN ACCORDANCE WITH STATE AND LOCAL ORDINANCES. ALL AREAS SHALL BE BROOM CLEANED UPON COMPLETION OF DEMOLITION WORK.

# **KEY NOTES**

- EXISTING LIGHTING TO BE REMOVED. REMOVE WIRE BACK TO NEAREST DEVICE EXISTING TO REMAIN. PREPARE FOR NEW INSTALLATION.
- D2 EXISTING LIGHTING TO BE REPLACED IN PLACE. DISCONNECT AND PRESERVE/PREPARE WIRING FOR NEW INSTALLATION.
- (D3) EXISTING LIGHT TO BE RELOCATED.

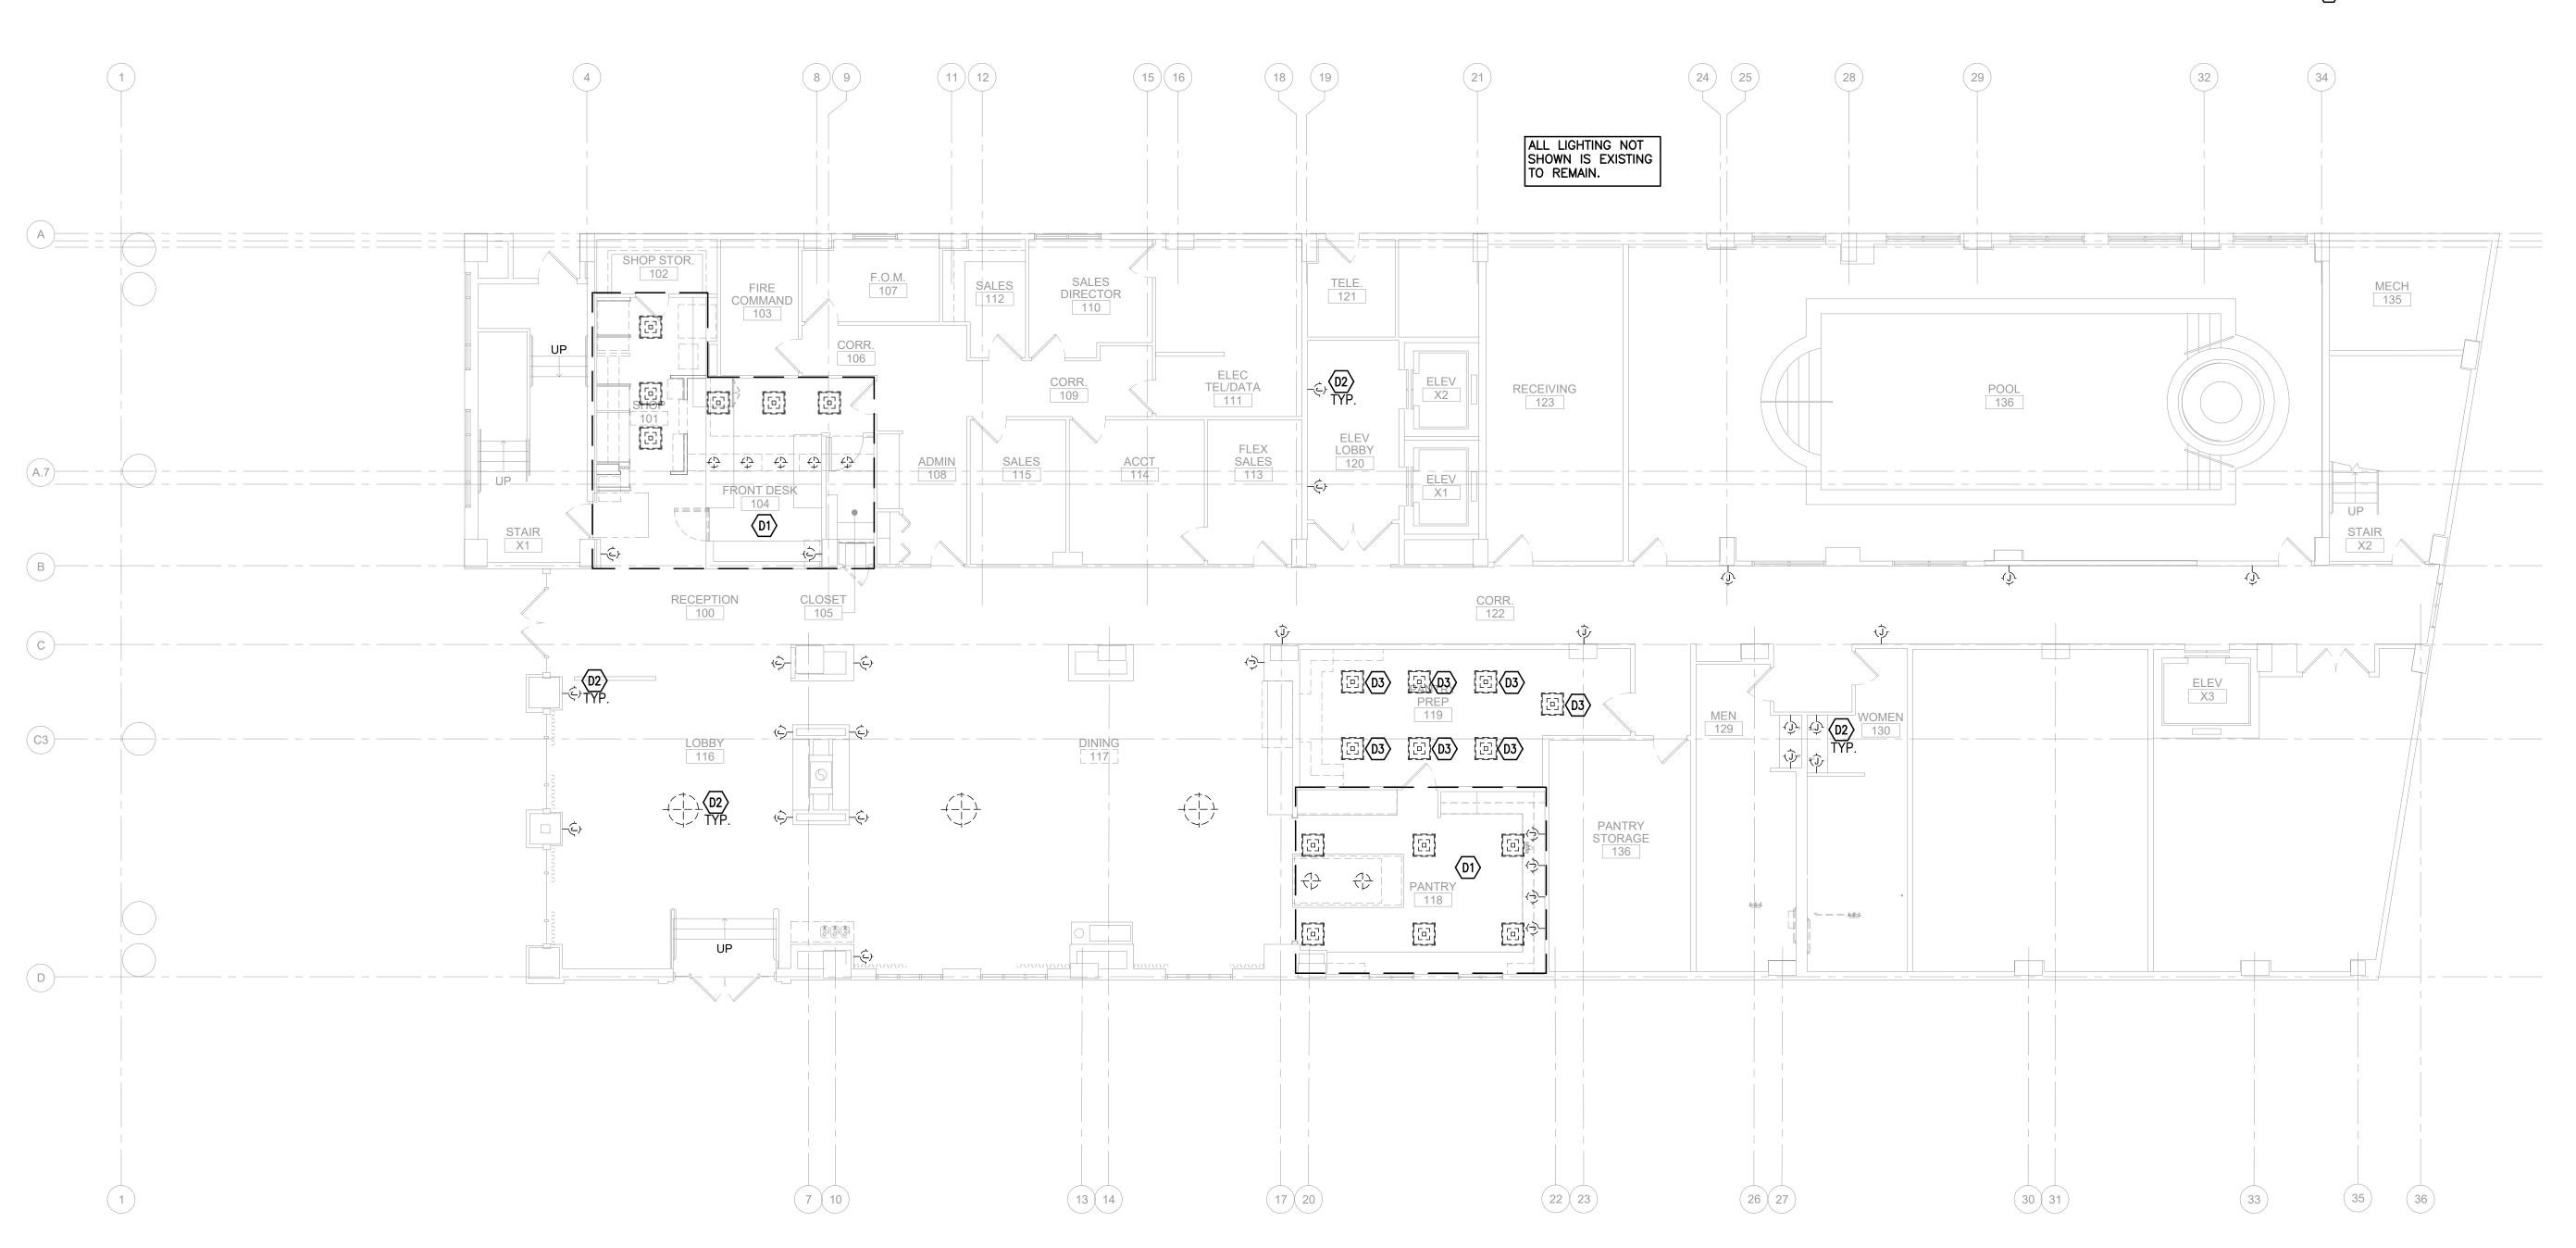

HOMEWOOD SUITES by Hilton<sup>-</sup> 901 Poydras Street New Orleans, LA

Project





Issuance

No.	Description	Date
1	CONSTRUCTION	03/07
	DOCUMENTS	2022

Drawn By: KS

Checked By: JB


Project No.

1335

Drawing Title

ELECTRICAL FIRST LEVEL DEMO RCP

Drawing Scale

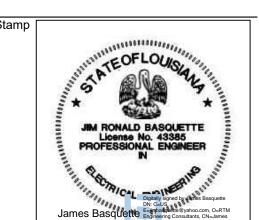

E4.00

OFFICE M07

HOUSEKEEPING M05

CORRIDOR M03 MAINT SHOP M06

13 14

BANQUET

7 10

CORRIDOR M01

-(-|-)-(D3)

STORAGE

UP STAIR X1

(A.7)-------

(C3)——

ALL LIGHTING NOT SHOWN IS EXISTING

TO REMAIN.

BOARD ROOM M13

> EMP ROOM M15

22 23

CORRIDOR M14

ELEC M08

ELEV LOBBY M09

BUSINESS CENTER M<del>19</del>

> MECH M11

17 20

GENERAL NOTES

- 1. THE ELECTRICAL DEMOLITION PLAN IS TO BE USED AS AN OVERALL GUIDE TO THE SCOPE OF DEMOLITION WORK BEING PERFORMED. ELECTRICAL CONTRACTOR SHALL VERIFY AND CONFIRM EXACT SCOPE OF WORK AND PHASING WITH AN AUTHORIZED OWNER FIELD REPRESENTATIVE PRIOR TO BID AND COMMENCEMENT OF WORK.
- 2. THE EXISTING CONDITIONS ARE BASED ON "AS-BUILT" DRAWINGS AND/OR LIMITED FIELD VERIFICATIONS, AND MAY NOT SHOW ALL DEVICES/FIXTURES TO BE REMOVED. THE CONTRACTOR SHALL ADJUST TO ACTUAL FIELD CONDITIONS, ANY DISCREPANCIES SHALL BE IMMEDIATELY REPORTED TO THE ENGINEER FOR RESOLUTION.
- 3. ALL EXISTING DEVICES/FIXTURES SHALL BE REMOVED UNLESS NOTED OTHERWISE, ITEMS MARKED WITH <E> ARE EXISTING TO DEMAND
- 4. REMOVE ALL EXISTING WIRING AND CONDUIT BACK TO NEAREST DEVICE INDICATED TO REMAIN, OR TO SOURCE PANEL, WHICHEVER IS CLOSER. PRESERVE CONTINUITY OF ALL EXISTING CIRCUITS TO REMAIN
- VERIFY FUNCTIONALITY OF ALL EXISTING DEVICES/FIXTURES TO REMAIN, REPLACES AS NECESSARY.
- 6. THE CONTRACTOR SHALL REVIEW ALL EXISTING CONDUIT, WIRING, JUNCTION BOXES, AND ELECTRICAL, COMMUNICATION AND LIFE SAFETY DEVICES WITH THE LANDLORD AND TENANT REPRESENTATIVES PRIOR TO THE COMMENCEMENT OF ANY DEMOLITION WORK FOR THIS PROJECT. ALL EXISTING ITEMS TO REMAIN SHALL BE PROPERLY MARKED AT THE PROJECT SITE IN ACCORDANCE WITH THE REQUIREMENTS OF THE LANDLORD.
- 7. ALL MATERIALS SCHEDULED TO BE REMOVED SHALL BECOME THE PROPERTY OF THE CONTRACTOR. THE CONTRACTOR SHALL BE RESPONSIBLE FOR ALL HAULING AND DISPOSAL OF THE DEBRIS IN ACCORDANCE WITH STATE AND LOCAL ORDINANCES. ALL AREAS SHALL BE BROOM CLEANED UPON COMPLETION OF DEMOLITION WORK.

# **KEY NOTES**

MECH M26

STORAGE M21

30 31

LAUNDRY M23

DRYERS
M25

35

WOMEN M18

26 27

GUEST LAUNDRY M20

> HSKP OFFICE M22

- D1) EXISTING LIGHTING TO BE REMOVED. REMOVE WIRE BACK TO NEAREST DEVICE EXISTING TO REMAIN. PREPARE FOR NEW INSTALLATION.
- D2 EXISTING LIGHTING TO BE REPLACED IN PLACE. DISCONNECT AND PRESERVE/PREPARE WIRING FOR NEW INSTALLATION.
- EXISTING LIGHTING TO BE REMOVED. REMOVE WIRE BACK TO NEAREST DEVICE EXISTING TO REMAIN AND RELABEL CIRCUIT AS SPARE.



Date 03/07

2022

Drawn By:

KS

Checked By:

JB

Project No.

1335

Drawing Title

Project

SUITES by Hilton

901 Poydras Street

New Orleans, LA

21 W 3rd St, Boston, MA 02127

engineering consultants 2420 Lakemont Ave | Suite 320 | Orlando, FL 32814 T: 407.678.2055 : www.rtmec.com


Description

CONSTRUCTION DOCUMENTS

Issuance

ELECTRICAL MEZZANINE LEVEL DEMO RCP

Drawing Scale:

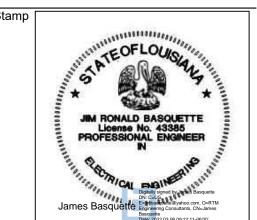


E4.01

# **GENERAL NOTES** ADJUST TO ACTUAL FIELD CONDITIONS, ANY DISCREPANCIES SHALL BE IMMEDIATELY REPORTED TO THE ENGINEER FOR RESOLUTION.

- 1. THE ELECTRICAL DEMOLITION PLAN IS TO BE USED AS AN OVERALL GUIDE TO THE SCOPE OF DEMOLITION WORK BEING PERFORMED. ELECTRICAL CONTRACTOR SHALL VERIFY AND CONFIRM EXACT SCOPE OF WORK AND PHASING WITH AN AUTHORIZED OWNER FIELD REPRESENTATIVE PRIOR TO BID AND COMMENCEMENT OF WORK.
- 2. THE EXISTING CONDITIONS ARE BASED ON "AS-BUILT" DRAWINGS AND/OR LIMITED FIELD VERIFICATIONS, AND MAY NOT SHOW ALL DEVICES/FIXTURES TO BE REMOVED. THE CONTRACTOR SHALL
- 3. ALL EXISTING DEVICES/FIXTURES SHALL BE REMOVED UNLESS NOTED OTHERWISE, ITÉMS MARKED WITH <E> ARE EXISTING TO
- 4. REMOVE ALL EXISTING WIRING AND CONDUIT BACK TO NEAREST DEVICE INDICATED TO REMAIN, OR TO SOURCE PANEL, WHICHEVER IS CLOSER. PRESERVE CONTINUITY OF ALL EXISTING CIRCUITS TO
- VERIFY FUNCTIONALITY OF ALL EXISTING DEVICES/FIXTURES TO REMAIN, REPLACES AS NECESSARY.
- 6. THE CONTRACTOR SHALL REVIEW ALL EXISTING CONDUIT, WIRING, JUNCTION BOXES, AND ELECTRICAL, COMMUNICATION AND LIFE SAFETY DEVICES WITH THE LANDLORD AND TENANT REPRESENTATIVES PRIOR TO THE COMMENCEMENT OF ANY DEMOLITION WORK FOR THIS PROJECT. ALL EXISTING ITEMS TO REMAIN SHALL BE PROPERLY MARKED AT THE PROJECT SITE IN ACCORDANCE WITH THE REQUIREMENTS OF THE LANDLORD.
- 7. ALL MATERIALS SCHEDULED TO BE REMOVED SHALL BECOME THE PROPERTY OF THE CONTRACTOR. THE CONTRACTOR SHALL BE RESPONSIBLE FOR ALL HAULING AND DISPOSAL OF THE DEBRIS IN ACCORDANCE WITH STATE AND LOCAL ORDINANCES. ALL AREAS SHALL BE BROOM CLEANED UPON COMPLETION OF DEMOLITION

# **KEY NOTES**

- EXISTING LIGHTING TO BE REMOVED. REMOVE WIRE BACK TO NEAREST DEVICE EXISTING TO REMAIN. PREPARE FOR NEW INSTALLATION.
- D2 EXISTING LIGHTING TO BE REPLACED IN PLACE. DISCONNECT AND PRESERVE/PREPARE WIRING FOR NEW INSTALLATION.
- EXISTING PANEL K2 SHALL BE REMOVED. REMOVE WIRE BACK TO SOURCE PANEL. RELABEL CIRCUIT BREAKER AS SPARE.
- (D4) EXISTING LIGHT TO BE RELOCATED.

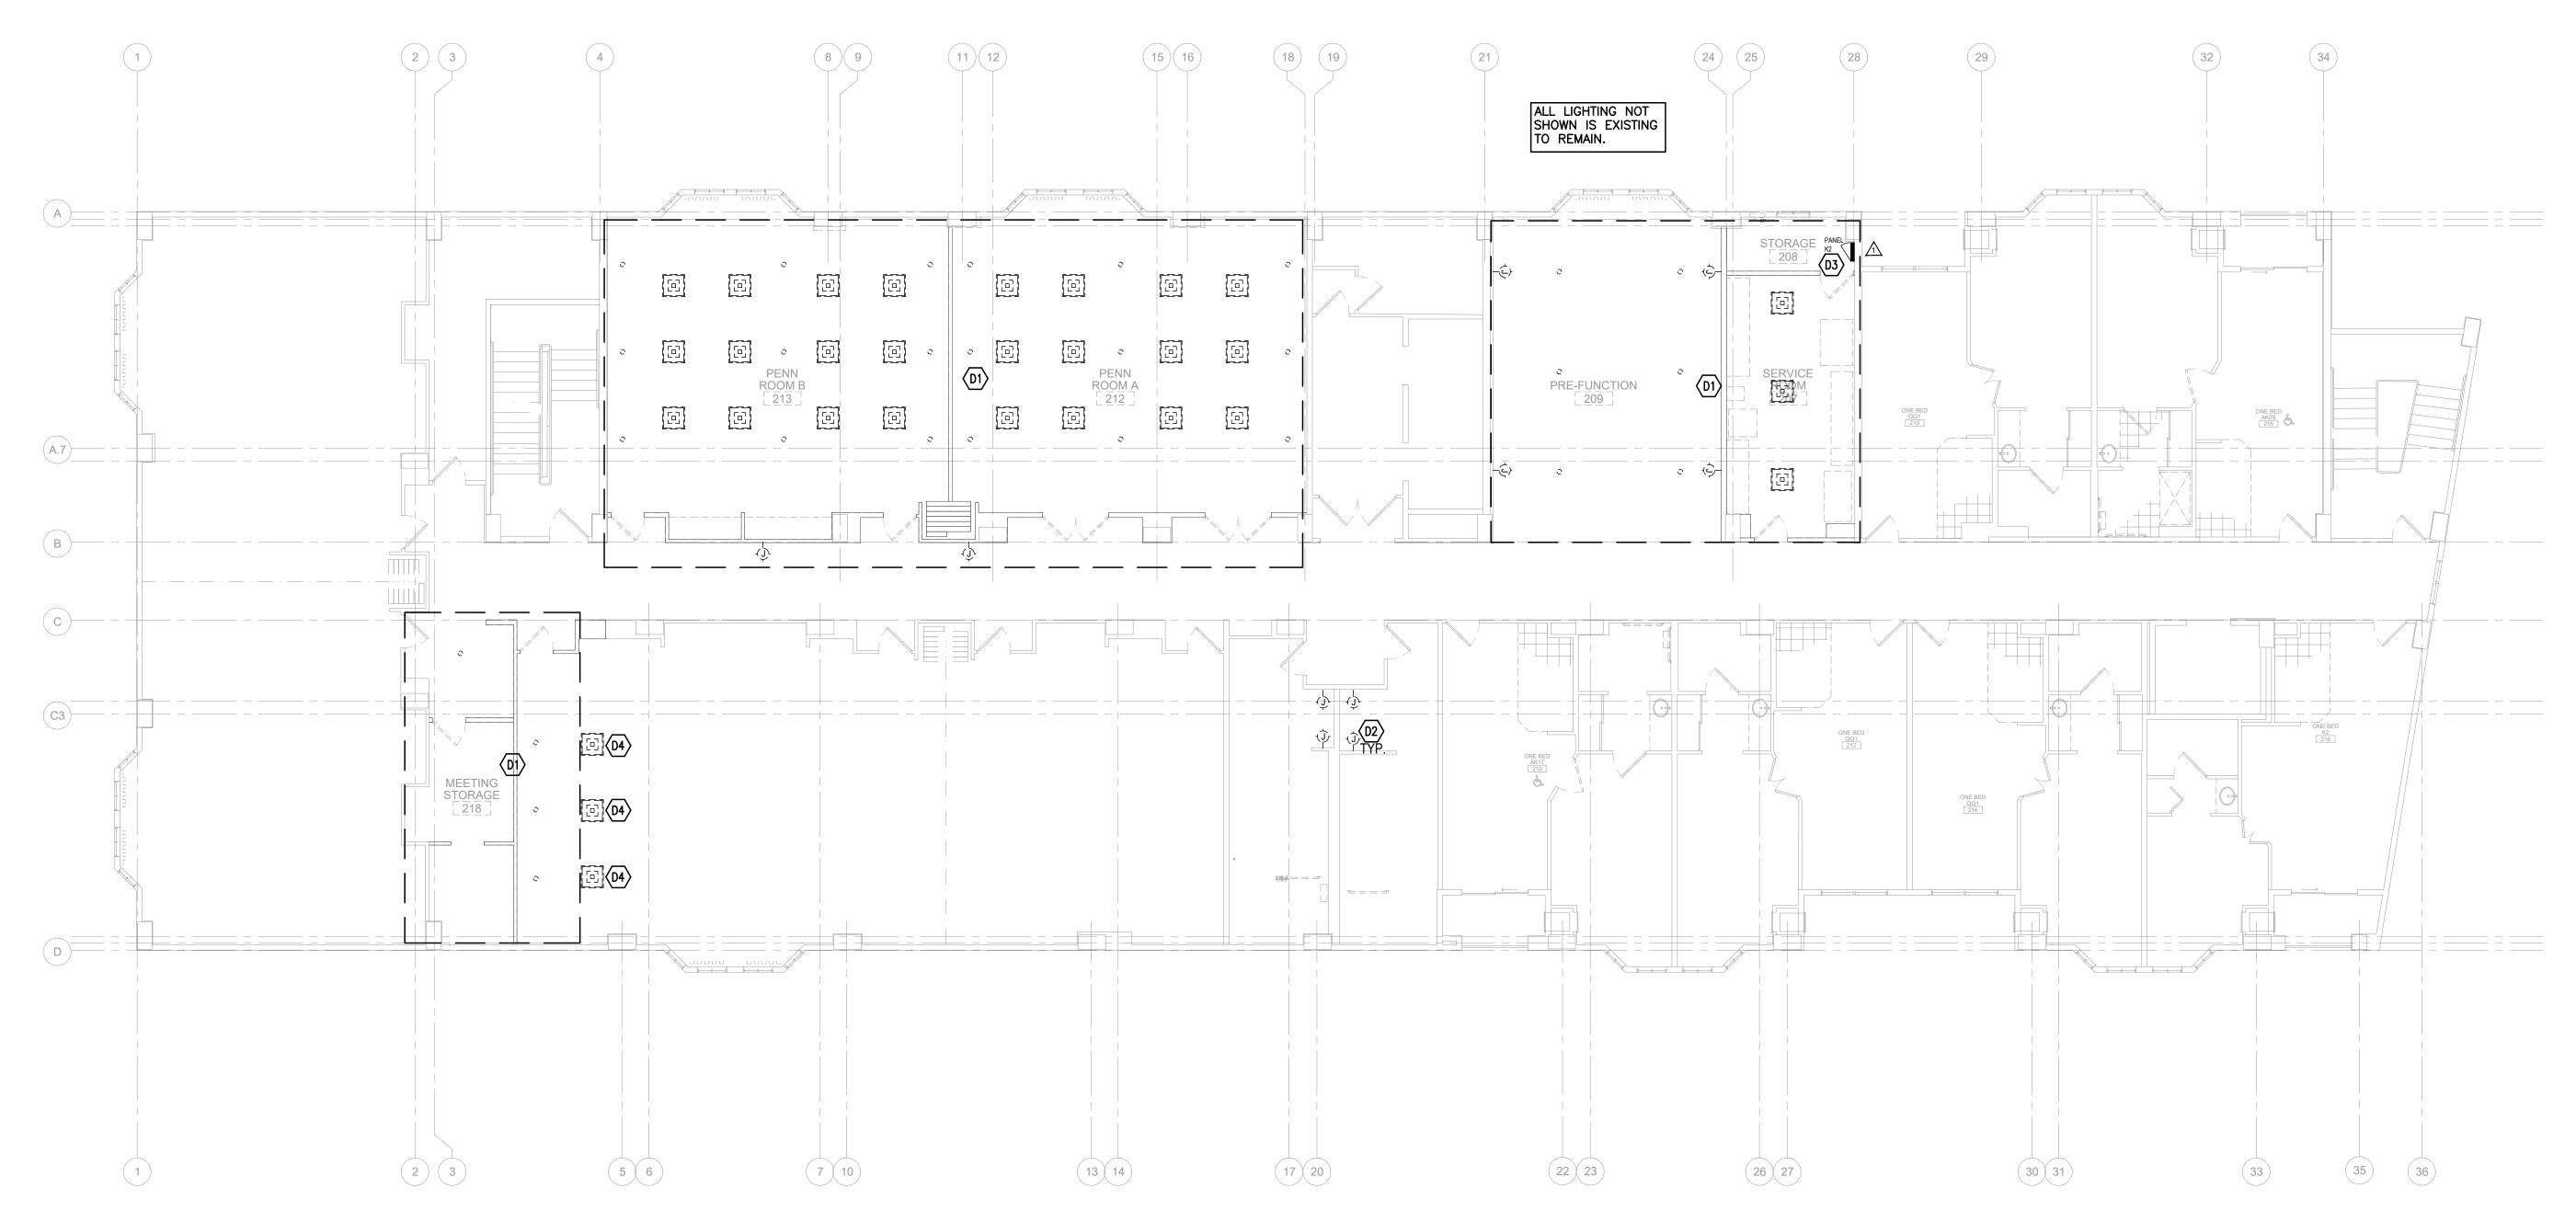

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Project





Issuance


No.	Description	Date
1	CONSTRUCTION	03/07
	DOCUMENTS	2022

Drawn By: Checked By: Project No. 1335

Drawing Title

ELECTRICAL SECOND LEVEL DEMO RCP

Drawing Scale:

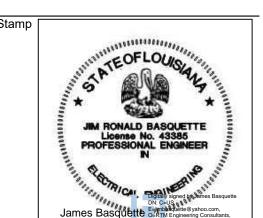

E4.02

	LIGHT FIX	KTURE SCHEDULE		
TYPE	MANUFACTURER & PART NUMBER	DESCRIPTION	VOLTAGE	WATTAGE
□R01	ZANIBONI LIGHTING D2 STE3Q 13 30 B 6 C WS Z GO OD	3" LED SQUARE DOWNLIGHT 95 CRI, 3000K, 60 DEGREE BEAM ANGLE, 0-10V DIMMING TO 1%, MATTE WHITE FINISH	120V	13W
<b>R</b> 02	FLOS ARCHITECTURAL 03.9430.40	LIGHT SHADOW ADJUSTABLE 4 LAMP TRIMLESS LED LUMINAIRE, 90 CRI, 1140L, 3000K, 23 DEGREE BEAM ANGLE, WHITE FINISH	120V	10.8W
<b>8</b> R03	SOLIAS XFR13 XM20 40C 30K/1500L WH/WH	RECESSED LED FIXTURE 3 LAMP LED LUMINAIRE, WHITE INTERIOR, WHITE TRIM, 1500LM, 90 CRI, 3000K, 40 DEGREE BEAM ANGLE	120V	22.4W
L01	FLOS ARCHITECTURAL 03.2281.14A LED90W24V-PWM-B01	RECESSED CEILING OR WALL MOUNTED 12" WALL-WASHER LED, 90CRI, 3000K, BLACK FINISH	120V	4.5W
L02	FLOS ARCHITECTURAL 03.2285.14A LED90W24V-PWM-B01	RECESSED CEILING OR WALL MOUNTED 24" WALL—WASHER LED, 90CRI, 3000K, BLACK FINISH	120V	9W
<u>L03</u> a,b,c,d	PUREEDGE LIGHTING LC45 5W 17,39,53,12 D 30D	45 DEGREE SURFACE MOUNT LINEAR LED LIGHT, 90 CRI, 3000K WARM DIM TO 2000K, DIFFUSED LENS, (L03a – 17", L03b – 39", L03c – 53", L03d – 12")	120V	5W/FT
<u>T</u> 01	FLOS ARCHITECTURAL 09.3864.40 LED90W24V-PWM-B01	ZERO TRACK SPOT LED SURFACE MOUNTED, 90 CRI, 3000K, 24VDC	120V	10.5W
- J DW-10	RENAISSANCE PART #	LED WALL SCONCE WITH FROSTED WHITE DIFFUSER, 2700K. SEE INTERIOR DESIGNER FFE SPECIFICATIONS FOR FINAL FIXTURE. OFCI.	120V	12W
DW-11	MARA WALL PART #	DIMMABLE LED COMPATIBLE ELV AND TRIAC DIMMERS, 90 CRI, 2700K.SEE INTERIOR DESIGNER FFE SPECIFICATIONS FOR FINAL FIXTURE. OFCI.	120V	16.8W
- <b>(J)</b> - DW-12	ARTERIORS PART #	LED QUIMBY SCONCE. SEE INTERIOR DESIGNER FFE SPECIFICATIONS FOR FINAL FIXTURE. OFCI.	120V	40W
⊕ DC-10	HUDSON VALLEY LIGHTING 5104—AGB	5" DIAMETER LED PENDANT. SEE INTERIOR DESIGNER FFE SPECIFICATIONS FOR FINAL FIXTURE. OFCI.	120V	8W
DC-11	HUDSON VALLEY LIGHTING 4724—AGB	46" DIAMETER 24 BULB LED PENDANT. SEE INTERIOR DESIGNER FFE SPECIFICATIONS FOR FINAL FIXTURE. OFCI.	120V	96W
DC-12	ARTERIORS VOLTA PENDANT (49330)	22" DIAMETER LED PENDANT. SEE INTERIOR DESIGNER FFE SPECIFICATIONS FOR FINAL FIXTURE. OFCI.	120V	60W
⊕ DC-13	ASHLEY LIGHTING 73291-0A0-P57D	24" ROUND SURFACE MOUNT LED WITH FROSTED WHITE DIFFUSER. SEE INTERIOR DESIGNER FFE SPECIFICATIONS FOR FINAL FIXTURE. OFCI.	120V	30W
DC-14	SOLIAS FP22 8 35 40S WH FM	2X2 RECESSED LED PANEL, 80 CRI, 4,000L, 3500K, WHITE FINISH	120V	36W
EX-01	HINKLEY 23250Z	EXTERIOR ARCHITECTURAL WALL SCONCE WITH BRONZE FINISH. SEE INTERIOR DESIGNER FFE SPECIFICATIONS FOR FINAL FIXTURE. CFCI.	120V	60W

	LIGHT FIXTU	RE SCHEDULE - UNITS		
TYPE	MANUFACTURER & PART NUMBER	DESCRIPTION	VOLTAGE	WATTAGE
© R04	USAI LIGHTING B4RDRT	4.5" ROUND DOWNLIGHT, 80+ CRI, 3000K	120V	90W
□R05	USAI LIGHTING B4SDRT	4.5" SQUARE LED DOWNLIGHT, 80+ CRI, 3000K	120V	9W
L04	JESCO LIGHTING GROUP S602P-48-30 WITH DL-PS-60/24-HW-DIM	48" LINEAR LED, 3000K. SEE INTERIOR DESIGNER FFE SPECIFICATIONS FOR FINAL FIXTURE. OFCI. PROVIDE WITH 60W POWER SUPPLY. PROVIDE ALL COMPONENTS REQUIRED FOR A COMPLETE INSTALLATION.	24V DC	19.9W
DW-XX		WALL MOUNTED VANITY LIGHT. SEE INTERIOR DESIGNER FFE SPECIFICATIONS FOR FINAL FIXTURE. OFCI.	120V	40W
- J DW-01		WALL SCONCE. SEE INTERIOR DESIGNER FFE SPECIFICATIONS FOR FINAL FIXTURE. OFCI.	120V	40W
DC-01	RENAISSANCE RL-62-1053	2X2 LED PANEL WITH WHITE FINISH, 3000K, 90CRI. SEE INTERIOR DESIGNER FFE SPECIFICATIONS FOR FINAL FIXTURE. OFCI.	120V	45W
O DC-02	ASHLEY LIGHTING (B) GR-204	15" ROUND FLUSH MOUNTED CEILING LIGHT WITH INNER DIFFUSER AND CLEAR OUTER SHADE, 2700K. SEE INTERIOR DESIGNER FFE SPECIFICATIONS FOR FINAL FIXTURE. OFCI.	120V	17W
⊕ <sub>DC-13</sub>	ASHLEY LIGHTING 73291-0A0-P57D	24" ROUND SURFACE MOUNT LED WITH FROSTED WHITE DIFFUSER. SEE INTERIOR DESIGNER FFE SPECIFICATIONS FOR FINAL FIXTURE. OFCI.	120V	30W

**GENERAL NOTES** 

- CONTRACTOR SHALL PROVIDE SUBMITTAL OF ALL FIXTURES TO OWNER, ARCHITECT AND INTERIOR DESIGNER. SUBMITTAL SHALL BE APPROVED BY OWNER, ARCHITECT AND ENGINEER PRIOR TO PROCUREMENT.
- 2. ANY SUBSTITUTION OF FIXTURES WILL REQUIRE A FULL PHOTOMETRIC ANALYSIS TO BE PROVIDED FOR ALL SUBSTITUTED AREAS. LIGHTING VENDOR/DISTRIBUTOR WILL BE RESPONSIBLE FOR GATHERING AND EVALUATING DATA TO MATCH INTENDED FIXTURE PHOTOMETRIC RESULTS. SUBSTITUTED FIXTURES WILL NOT BE APPROVED WITHOUT PHOTOMETRIC PROVIDED WITH SUBMITTAL.
- 3. SUBSTITUTION OF LIGHT FIXTURES SHALL BE PRESENTED FIFTEEN DAYS PRIOR TO BID. ANY ADDITIONAL ENGINEERING COST FOR RE-WORK OR EXTRA SUBMITTAL EVALUATION FOR SUBSTITUTIONS SHALL BE PAID FOR BY GENERAL CONTRACTOR.

HOMEWOOD SUITES by Hilton 901 Poydras Street New Orleans, LA





Issuance

No. Description Date

1 CONSTRUCTION 03/07

DOCUMENTS 2022


Drawn By: KS
Checked By: JB
Project No.

Drawing Title

ELECTRICAL SCHEDULES

Drawing Scale

Stamp

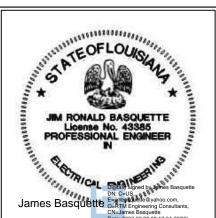

E5.00

Drawing Number

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7TH FLOOR 6TH FLOOR 5TH FLOOR 4TH FLOOR 3RD FLOOR NEW 200A PNL 120/208V 'P2A' NEW 1 200A 3P 2ND FLOOR (3)#3 +(1)#8G IN 1"C ——— MEZZANINE MAIN SWITCHBOARD "MSA2" 120/208V. 3ø, 4W, 2000A (65KAIC) MAIN SWITCHBOARD "MSA1" 120/208V. 3Ø, 4W, 2500A (65KAIC) SERVICE "MSA2" TO MAIN ELEC. SERVICE "MSA1"\_\_\_\_\_ TO MAIN ELEC. 1st FLOOR

GENERAL RISER NOTES

1. ALL EQUIPMENT SHOWN IS EXISTING UNLESS NOTED OTHERWISE.

RISER KEY NOTES

NEW 200A/3P FUSED DISCONNECT SWITCH TO MATCH EXISTING BUS DUCT MANUFACTURER AND ALL ELECTRICAL CHARACTERISTICS. COORDINATE ALL REQUIRED POWER SHUTDOWNS WITH OWNER IN ADVANCE.

EXISTING PANEL TO BE REMOVED. REMOVE WIRE/CONDUIT BACK TO SOURCE. RELABEL CIRCUIT BREAKER AS SPARE.

HOMEWOOD SUITES by Hilton 901 Poydras Street New Orleans, LA





Issuance

No.	Description	Date
1	CONSTRUCTION	03/07
	DOCUMENTS	2022

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JB


Project No.

1335

Drawing Title

ELECTRICAL RISER DIAGRAM -FLOORS 1 - 7

Drawing Scale

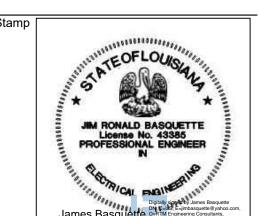

E5.01

	D FOR: APPROVAL	CATION: 205	<u> </u>						MAIN:	1004	MLO			CO	NN I	OAD.	10.8 KVA	—
		LTAGE: 120		,					SYSTEM						ED: T		10.0 10.0	
			RFACE						BUS R	ATING	100A	١		GR	OUND	BUS:	YES COPPER	
СКТ	LOAD SERVED	COND	PHASE	NEUT	GND	BKR	DMD	L1	L2	L3	DMD	BKR	COND	PHASE	NEUT	GND	LOAD SERVED	CK
1	DISHWASHER					20/1	R	900 360			R	20/1					recpt — Kitchen	2
3	GFCI					_	R		900		R	20/1					REFRIGERATOR	4
5	LTG & RECPT - BATHROOM					20/1	L	607 -			R	-					GFCI	6
7	RECPT - BEDROOM					20/1	R		1080 900		R	20/1					MICROWAVE	8
9	SPARE					20/1	_	_			R	-					GFCI	1
11	COOK TOP					20/2			1250 647		L	20/1					LTG & RECPT - KITCHEN	1.
13						20/2	K	1250 1000			N	20/2					AC	1
5	DISPOSAL					20/1			900 1000		N							1
17	GFCI					-	R	_			_	-					"	1
9	n					-	_				_	-					"	2
21	"					-	_	_			_	_					**	2
23	"					-	_				_	_					"	2
	INTER	RRUPT RATIN	IG: <b>10</b>	KAIC	•			4117	6677					FR	OM:			
				1							•							
LOA	DS (IN VA ) CONNECTE	DEMAND FACTOR	MINIM FEED		LOAD	os		COI	NECTE	DEM/ FACT		MININ FEED		REMA CONT		JS LOA	ADS <u>0</u> 1.25 <u>0</u>	
	TING <u>1254</u>	1.25	156		NON-	-SEAS	SONAL	-	0	1.0	0	0		REMA NON-		าทบอบ	JS LOADS <u>2900</u> 1.0 <u>2900</u>	
	EPTS TO 10 KVA 4140	1.0	414			SEST N	40T0	_	0 0	0.2		0		DEMA	ND L	DADS		
REC	EPTS REMAINING0	0.5	0	_	LARG	ESI I	иОТО	_		0.2	25		-				<del></del>	
	CE HEATING0	0.0	0	_	WATE	R HE	ATING	· _	0	1.0	0	0		TOTAL	CON	INECTE	ED LOAD <u>10.8</u> KVA <u>51.9</u>	AMP
SPA						HEN E			2500	1.0		250						AMP

1. PROVIDE GFCI CIRCUIT BREAKER.

		ATED: 3/7/2022 5:01 pm ED FOR: APPROVAL						PAI	NEL	_ 20	)3								
		LOCATION VOLTAGE TRIM:							SYSTE	100A M: 1ø, RATING	3W	4		FE	ED: T	OP	11.5 KVA		
	СКТ	LOAD SERVED	COND	PHASE	NEUT G	ND BK	RDMD	L1	L2	L3	DMD	BKR	COND	PHASE	NEUT	GND		LOAD SERVED	СКТ
1.	1	DISHWASHER				20/	1 R	900 900			R	20/1					R	ECPT - LIVING	2
	3	GFCI				_	R	300	900		R	20/1						REFRIGERATOR	4
	5	LTG & RECPT — BATHROOM				20/	1 L	607 -			R	-						GFCI	6
	7	LTG & RECPT - BEDROOM				20/	1 L		1457 900		R	20/1						MICROWAVE	8
	9	SPARE				20/	1 _	=			R	-						GFCI	10
	11	COOK TOP				20/			1250 116		L	20/1						LTG — KITCHEN	12
	13					20/	2 K	1250 1000			N	20/2						AC	14
1.	15	DISPOSAL				20/	1 N		900 1000		N	20/2							16
	17	GFCI				_	R	_ 360			R	20/1					RE	CPT - KITCHEN	18
	19	17					_				_	-						99	20
	21	17					_				_	-						**	22
	23	29									_							**	24
		INTERRUPT	RATING	6: 10k/	AIC			5017	6523		]			FR	OM:				
	LO	ADS (IN VA ) CONNECTED DE		MINIMU FEEDE		DADS		COI	NECTE	D DEM/ FACT		MINIM		REMA CONT		JS LOA	ADS	<u> </u>	
	RE	CEPTS TO 10 KVA 3960	.25 1.0 0.5	2725 3960 0	_   M	ON-SE OTORS ARGEST		_	0	1. <sup>0</sup>		0		REMA NON- DEMA	-CONT		S LOADS	2900 1.0 <u>2900</u> 0 1.0 <u>0</u>	
	SP	ACE HEATINGO	0.0	0	_   w	ATER H	EATING	_	0	1.	0	0		TOTAL	CON	INECTE	D LOAD	11.5 KVA 55.5	AMPS
	AIR	R CONDITIONING 0	1.0	0	_  ĸ	ITCHEN	EQUIP		<u> 2500</u>	1.	0	_250	00_	MIN.	FEEDE	R/PA	NEL CAP.	<u>12.1</u> KVA <u>58.1</u>	AMPS
														OVER	ALL D	EMAN	) FACTOR	1.05	

		ATED: 3/7/2022 5:04 pm ED FOR: APPROVAL							1A9	<b>NEL</b>	. 20	)7							
		LOCATIO VOLTAGI TRIM:	E: 120		,					SYSTE	100A M: 1ø, RATING	3W	١		FE	ED: T	0P	10.4 KVA YES COPPER	
	СКТ	LOAD SERVED	COND	PHASE	NEUT	GND	BKR	DMD	L1	L2	L3	DMD	BKR	COND	PHASE	NEUT	GND	LOAD SERVED	CK
•	1	DISHWASHER					20/1	R	500 360			R	20/1					RECPT - KITCHEN	2
Ī	3	GFCI					-	R		900		R	20/1					REFRIGERATOR	4
Ī	5	LTG & RECPT - BATHROOM					20/1	L	607 —			R	-					GFCI	6
Ī	7	RECPT - BEDROOM					20/1	R		1080 900		R	20/1					MICROWAVE	8
Ī	9	SPARE					20/1	ı	_			R	-					GFCI	10
Ī	11	соок тор					20/2			1250 647		L	20/1					LTG & RECPT - KITCHEN	12
	13						20/2	K	1250 1000			N	20/2					AC	14
$\cdot$	15	DISPOSAL					20/1	N		900 1000		N							16
	17	GFCI					_	R				-	-					"	18
	19	"					_	-		-		_	-					"	20
	21	"					-	1				-	-					"	22
Ī	23	99					-	1		_		_	-					29	24
Ī		INTERRUP'	ratin	G: 10	KAIC				3717	6677		]			FR	OM:			•

LOADS (IN VA ) CONNECTED DEMAND MINIMUM FACTOR FEEDER LOADS CONNECTED DEMAND MINIMUM FACTOR FEEDER CONTINUOUS LOADS  LIGHTING 1254 1.25 1568 NON-SEASONAL NOTORS	01.250
LIGHTING 1254 1.25 1568 NON-SEASONAL NON-CONTINUOUS LOADS	
RECEPTS TO 10 KVA 3740       1.0 3740       MOTORS       0 1.0 0       NON-CONTINUOUS LOADS         RECEPTS REMAINING       0 0.5 0       LARGEST MOTOR       0 0.25 0       DEMAND LOADS	<u>2900</u> 1.0 <u>2900</u> <u>0</u> 1.0 <u>0</u>
SPACE HEATING 0 0.0 0 WATER HEATING 0 1.0 0 TOTAL CONNECTED LOAD AIR CONDITIONING 0 1.0 0 KITCHEN EQUIP. 2500 1.0 2500 MIN. FEEDER/PANEL CAP.  OVERALL DEMAND FACTOR	10.4 KVA 50 AMPS 10.7 KVA 51.5 AMPS 1.03

		ATED: 3/7/2022 5:07 pm ED FOR: APPROVAL							PAI	NEL	_ 21	11								
		LOCATIO VOLTAGE TRIM:	E: 120		,					SYSTE	100A M: 1ø, RATING	3W			FE	ED: T		13.6 KVA YES COPPER		
	СКТ	LOAD SERVED	COND	PHASE	NEUT	GND	BKR	DMD	L1	L2			BKR	COND	PHASE	NEUT	GND	LOAD SERVED	СКТ	
1.	1	DISHWASHER					20/1	R	500 1260			R	20/1					RECPT - LIVING	2	
	3	GFCI					-	R		900		R	20/1					REFRIGERATOR	4	1.
	5	LTG & RECPT — BATHROOM					20/1	L	607 -	-		R	-					GFCI	6	
	7	LTG & RECPT — BEDROOM					20/1	L		1637 900		R	20/1					MICROWAVE	8	1.
	9	SPARE					20/1	-		-		R	1					GFCI	10	
	11	COOK TOP					20/2			1250 107		L	20/1					LTG — KITCHEN	12	
	13						20/2	K	1250 1000	-		N	20/2					AC	14	
	15	LTG & RECPT — BATHROOM					20/1			607 1000		N							16	
1.	17	DISPOSAL					20/1	N	900 1277			L	20/1					LTG & RECPT — BEDROOM	18	
	19	GFCI					_	R		 360		L	20/1					recpt — Kitchen	20	
	21	"					_	_	-			-	_					"	22	
				1															$\overline{}$	4

23 "	INTERR	UPT RATIN		 c	<u>  -</u>	 6794	6761		_	-	FR	OM:			91	•		24
LOADS (IN VA )	CONNECTED	DEMAND FACTOR	MINIMUM FEEDER	LOA	NDS	со	NNECTE	DEMA FACT		MININ FEED	REMA CONT		s LO	ADS	0	_ 1.25	0	-
LIGHTING RECEPTS TO 10 KVA RECEPTS REMAINING	<u>4595</u> <u>3560</u> 0	1.25 1.0 0.5	5744 3560 0	МО	N-SEA FORS GEST	_	0 0	1.0 0.2		0	 REMA NON- DEMA	CONT		JS LOADS	2900		<u>2900</u> 0	
SPACE HEATING AIR CONDITIONING	0	0.0 1.0	0		ER HE	_	0 2500	1.0 1.0		0 250				ED LOAD NEL CAP.	13.6 14.7		65.2 70.7	_
											OVER	ALL D	EMAN	D FACTOR	1.08	_		

<sup>1.</sup> PROVIDE GFCI CIRCUIT BREAKER.

1. PROVIDE GFCI CIRCUIT BREAKER.

Project

HOMEWOOD SUITES by Hilton 901 Poydras Street New Orleans, LA





Issuance


Description	Date
CONSTRUCTION	03/07
DOCUMENTS	2022
	CONSTRUCTION

Drawn By:	KS	
Checked By:	JB	
Project No.		
	1335	

Drawing Title

ELECTRICAL PANEL SCHEDULES

Drawing Sca

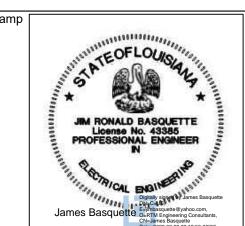

=5.02