

ATTIC VENTILATION WILL BE CONTINUOUS RIDGE VENTS AND

TERMITE SHIELDS WILL BE 26 GA GALVANIZED AT EACH PIER UNDER

#2 PINE LUMBER WILL BE USED FOR FRAMING LUMBER

CONTRACTOR TO REMOVE DEBRIS FROM PROPERTY

ENCLOSED AREAS BELOW FLOOD GRADE SHALL HAVE A MINIMUM OF 1

SQ. IN. PER 1 SQ. FT. OF WATER FLOW VENTING.

MINIMUM INSULATION REQUIRED FLOORS- R-19

WALL- R-13

CEILING- R-30


BUILDING MATERIAL USED BELOW DESIGN FLOOD ELEVATION MUST BE WATER RESISTANT


WINDOWS INSTALLED IN BATHTUB ENCLOSURES LESS THAN 60" F.F.F. REQUIRE SAFETY GLAZING AND WINDOWS WITHIN 2' OF DOORS AND WITHIN 5' OF STAIRS


FLOOD VENTS WHERE APPLICABLE SHALL BE 1'-0" OR LESS ABOVE


WINDOWS WHERE BOTTOM EDGE IS LESS THAN 18" REQUIRES SAFET

ALL EXTERIOR WALL TO BE 6" STUDS

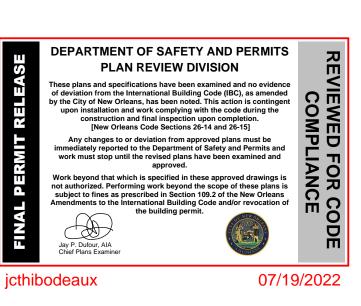

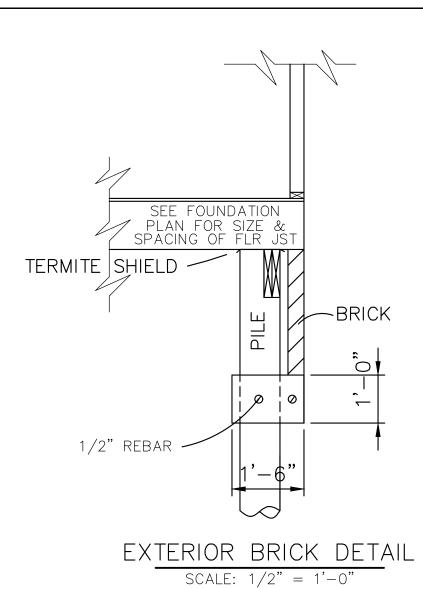

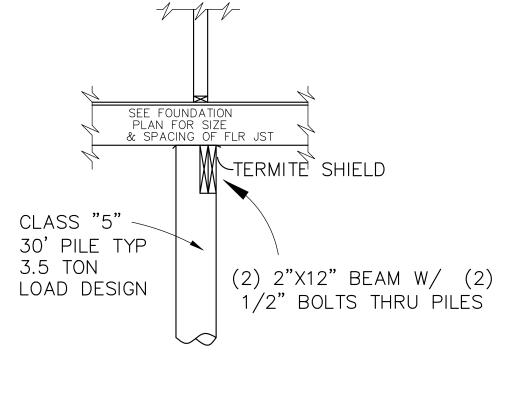

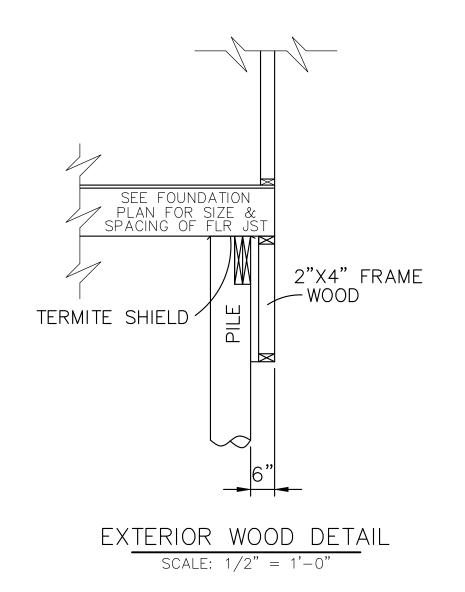

INTERIOR FOOTING DETAIL SCALE: 1/2" = 1'

42'-0" _ 2-2"X12" BEAM IN NOTCHED PILE 2"X10" FLR. UST 16" o.c. PILE CUT IN HALF FOR BRICK STEPS

> FOUNDATION PLAN SCALE: 1/4" = 1'-0"

CLASS 5 30' PILE WITH 3.5 TON LOAD DESIGN DRIVEN WITH STEEL DROP HAMMER OR RAPID IMPACT HAMMER METHOD, TO REFUSAL

SOIL TREATMENT, CHEMICAL TERMITICIDE OR TEMITE SHIELDS WILL BE USED FOR TERMITE PROTECTION, BUILDER VERIFY


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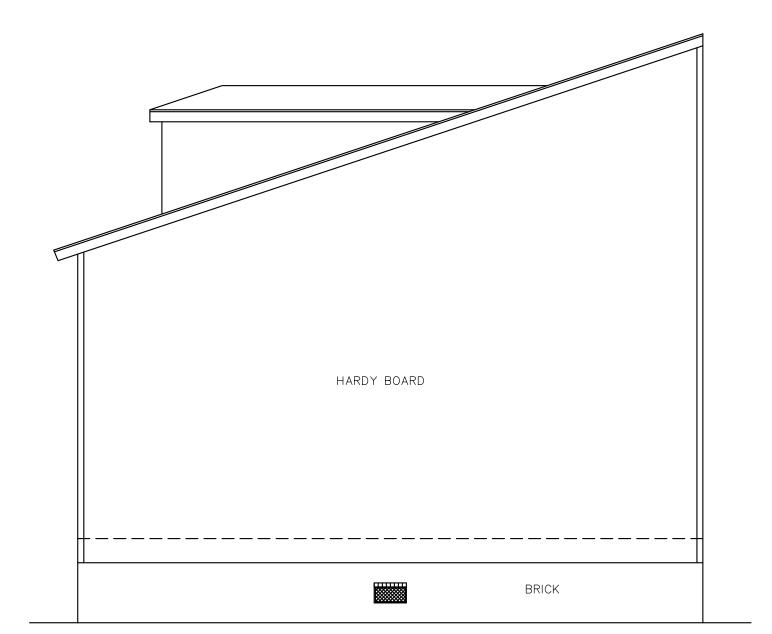
LIZZELL BROOKS 1962 N. TONTI STREET ORLEANS PARISH 504-874-7266

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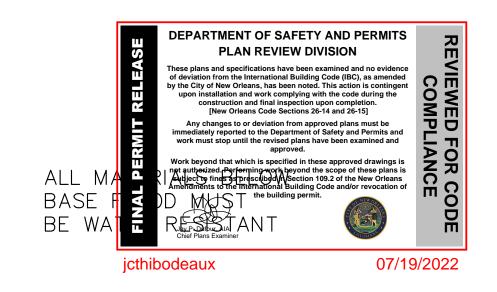
RIGHT ELEVATION

SCALE: 1/4" = 1'-0"




LEFT ELEVATION

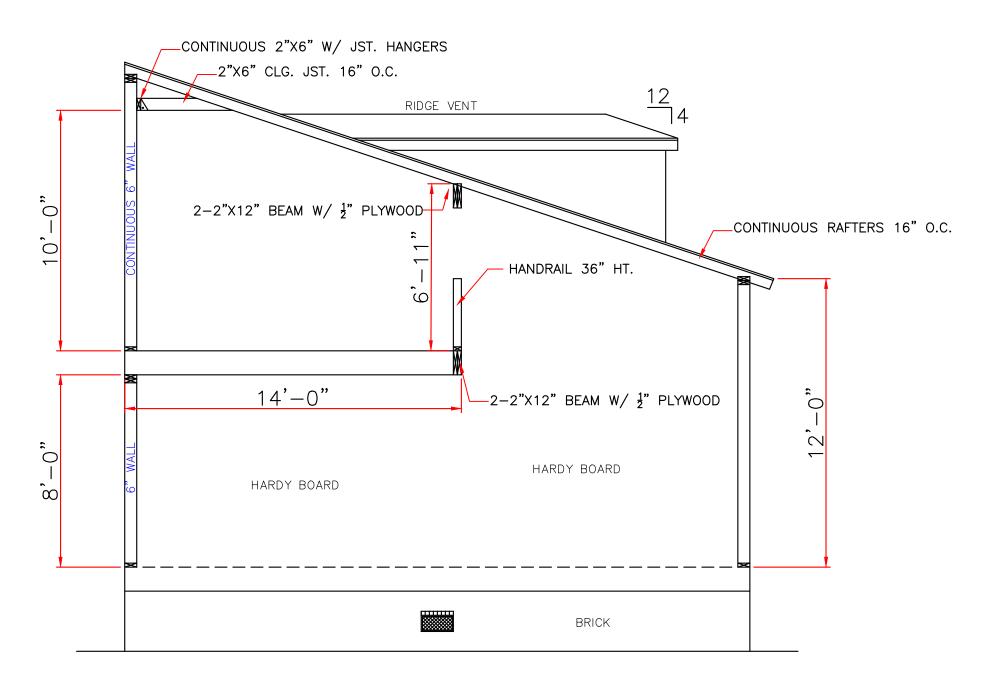SCALE: 1/4" = 1'-0"






 $\frac{\mathsf{FRONT} \;\; \mathsf{ELEVATION}}{\mathsf{SCALE}: \;\; 1/4" \; = \; 1'-0"}$

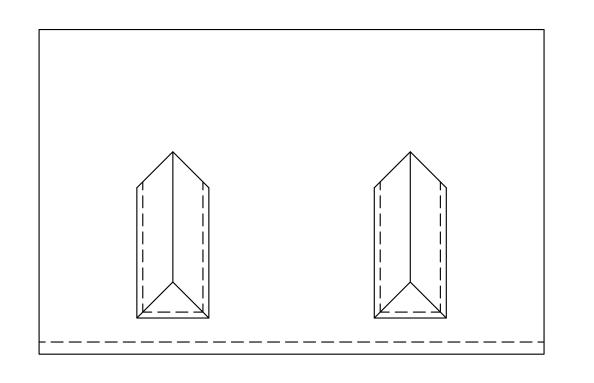

ROOF PLAN

 $\frac{}{\text{SCALE: } 1/8" = 1'-0"}$

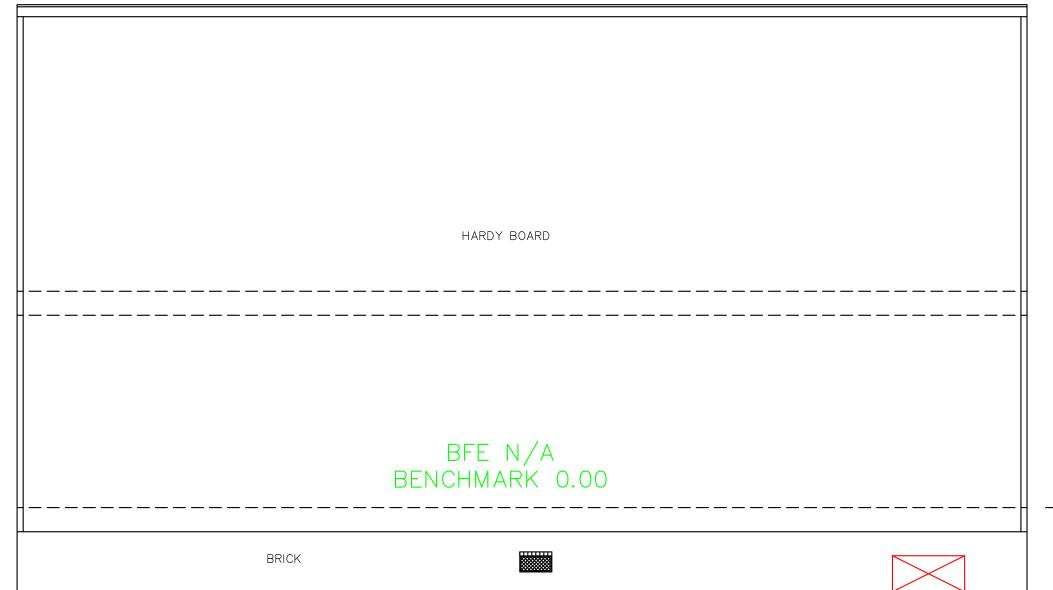

REAR ELEVATION

SCALE: 1/4" = 1'-0"

TOP OF FINISH FLOOR AT OR ABOVE MINIMUM BASE FLOOD.

36"X18" CRAWL SPACE

ALL MATERIALS RELOW

ALL MATERIALS BELOW BASE FLOOD MUST BE WATER RESISTANT





LIZZELL BROOKS


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3 DATE SHEET NO

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SECOND FLOOR PLAN SCALE: 1/4" = 1'-0"



1. AFCI PROTECTION SHALL BE PROVIDED FOR DINING ROOMS, FAMILY ROOMS, LIVING ROOMS, HALLWAYS, CLOSETS, BEDROOMS, ETC.

2. SMOKE DETECTORS: (A)SHALL BE INSTALLED IN EACH SLEEPING ROOM. (B) SHALL BE INSTALLED OUTSIDE, IN THE VICINITY OF EACH SLEEPING ROOM. (C) SHALL BE 120 VOLT, HARDWIRED, INTERCONNECTED, WITH A BATTERY BACKUP. (D) SHALL NOT BE INSTALLED WITHIN 36 INCHES OF A RETURN AIR GRILLE OR ANY PADDLE FAN BLADE.

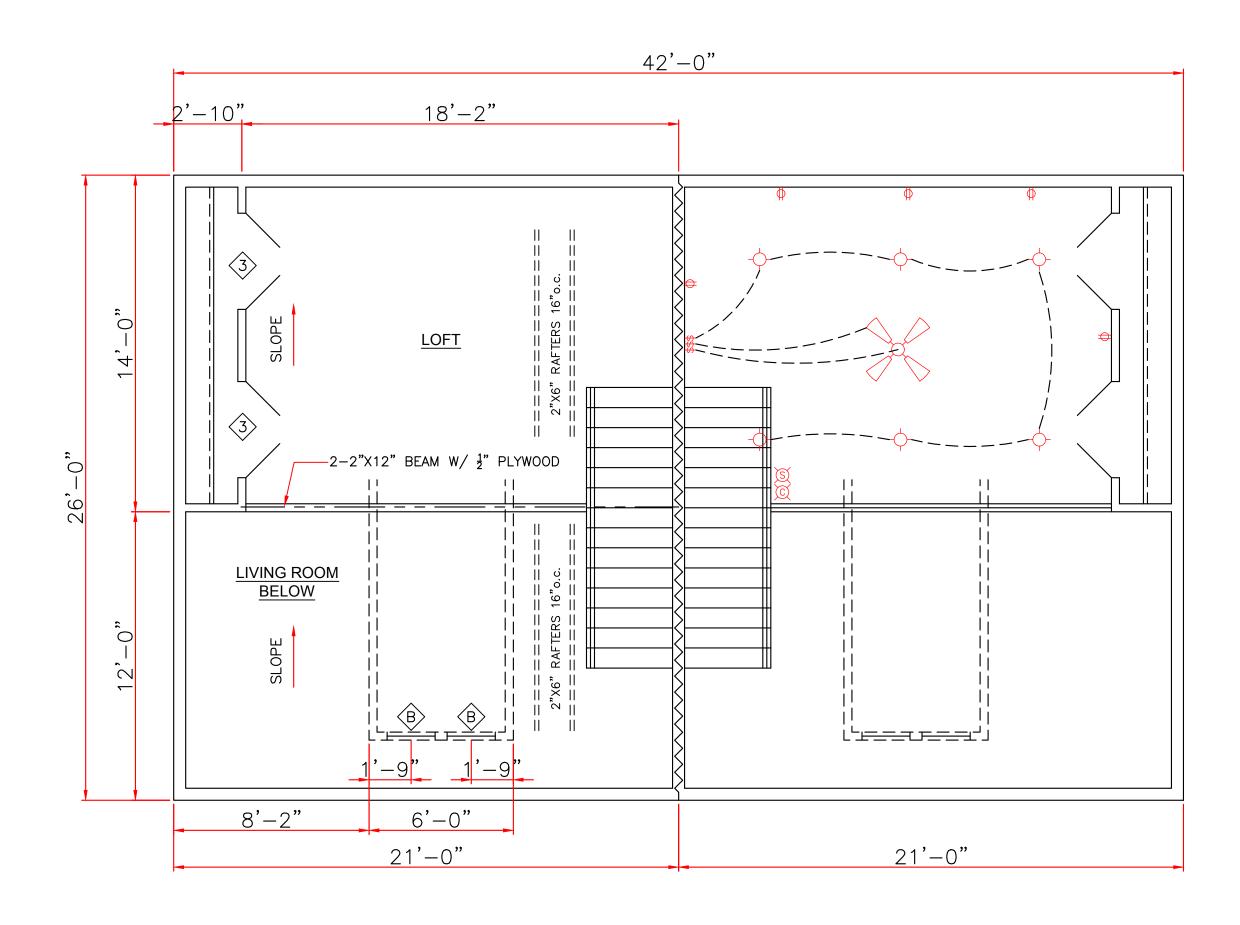3. KITCHEN: (A) ALL RECEPTACLES OVER COUNTERTOP SHALL BE GFI PROTECTED REGARDLESS OF DISTANCE FROM THE SINK. (B) THE DISHWASHER SHALL BE CONNECTED BY MEANS OF AN APPLIANCE CORD TO A RECEPTACLE UNDER THE SINK. THE RECEPTACLE WILL NOT BE GFI PROTECTED.

4. BATHROOMS: (A) ALL RECEPTACLES SHALL BE GFI PROTECTED.

(B) LIGHTS OVER BATHTUBS SHALL HAVE COVERS THAT ARE
LISTED FOR "DAMP LOCATION" (C) LIGHTS OVER SHOWERS SHALL
HAVE COVERS LISTED FOR "WET LOCATION."


5. EXTERIOR RECEPTACLES SHALL ALL BE GFI PROTECTED AND

SHALL HAVE WEATHERPROOF COVERS.

6. A RECEPTACLE (NOT SHOWN ON THE PLAN) WILL BE INSTALLED ON THE EXTERIOR WALL WITHIN 25 FEET OF THE AIR CONDITIONING EQUIPMENT.

LEGEND 110 VOLT OUTLET CEILING FAN 110 VOLT WATER PROOF OUTLET FLOOD LIGHTS RECESSED LIGHTS WALL SWITCH 15A., 120V., SINGLE POLE SINGLE THROW, MOUNT AT 3 WAY WALL SWITCH 15A., 120V. MOUNT AT 60" AFF DEPARTMENT OF SAFETY AND PERMITS PLAN REVIEW DIVISION These plans and specifications have been examined and no evidence of deviation from the International Building Code (IBC), as amended by the City of New Orleans, has been noted. This action is contingent upon installation and work complying with the code during the construction and final inspection upon completion.

[New Orleans Code Sections 26-14 and 26-15] DETECTOR CARBON MONOX Any changes to or deviation from approved plans must be Conditional plans must be Conditional Permits and Permits and CEILING LIGHT Work beyond that which is specified in these approved drawings is not authorized. Performing work beyond the scope of these plans is subject to fines as prescribed in Section 109.2 of the New Orleans Amendments to the International Building Code and/or revocation of the building correction. INCANDESCENT, VENT/LIGHT FIXT 07/19/2022 jcthibodeaux

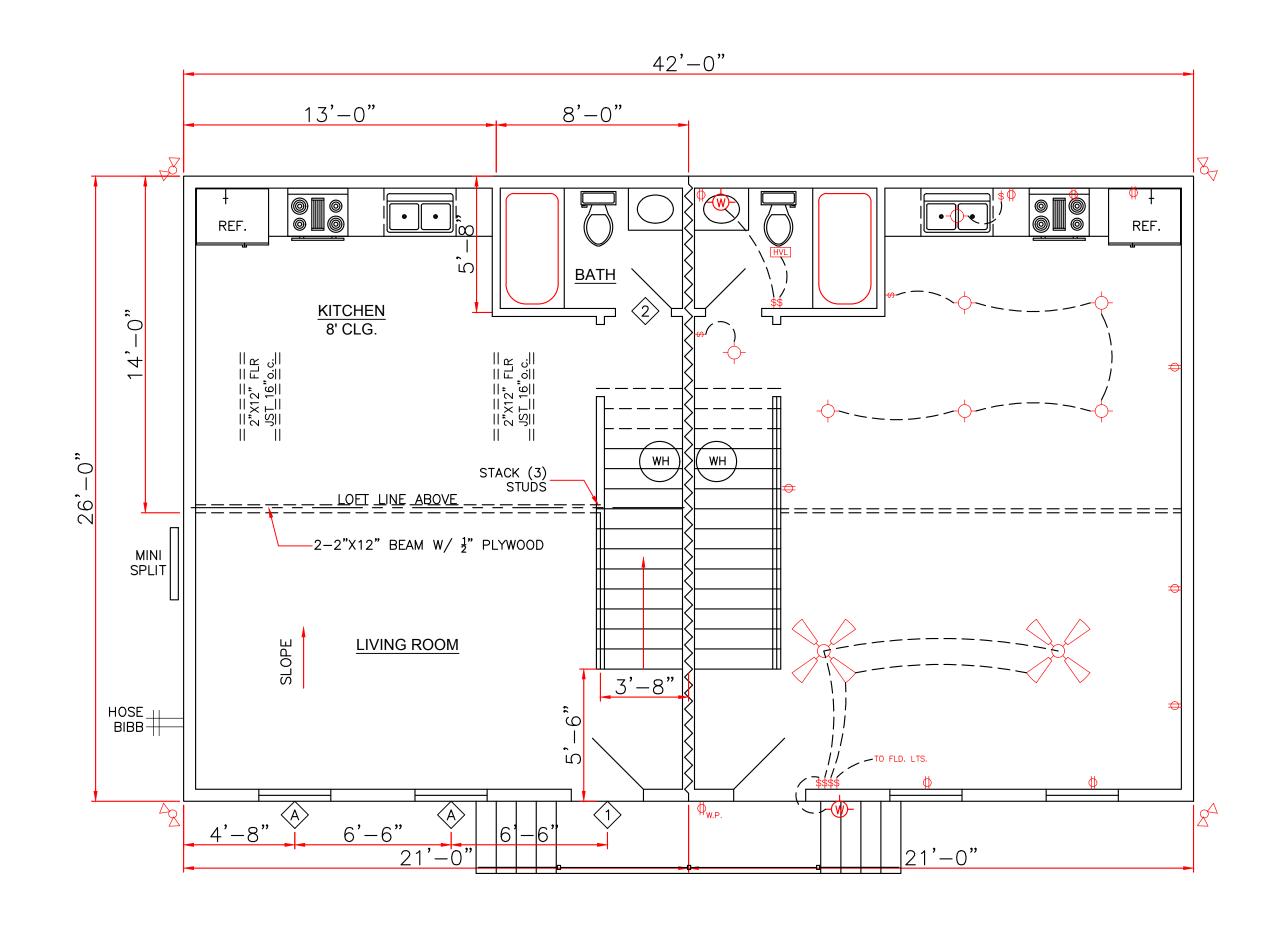


FIRST FLOOR PLAN SCALE: 1/4" = 1'-0"

SQUARE	FOOTAGE
LIVING	1092
LOFT	588
TOTAL	1680

	DOORS		
1	3'0"X8'0"X1 3/4"	EXT. INSUL. W/ 12" TRANSOM	
2	2′0″X8′0″X1 3/8″	INTERIOR RAISED PANEL	
3	2-2'0"X6'8"X1 3/8"	INTERIOR RAISED PANEL PAIR	

	WINDOWS		
А	3′0″X6′0″	VINYL S.H. 2/2 LTS W/ 12" TRANSOM	
В	2′0″X3′0″	VINYL S.H. 2/2 LTS	
	ENERGY PERFORMANCE RATING: U-FACTOR=.55; SOLAR HEAT GAIN COEFFICIANT=.35		

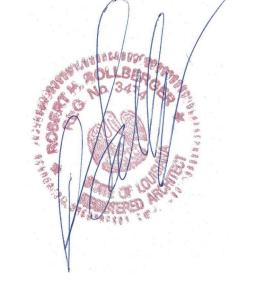







WIND BORNE DEBRIS PROTECTION

WINDOWS IN BUILDING LOCATED IN WIND BORNE DEBRIS REGIONS SHALL HAVE GLAZED OPENINGS PROTECTED FROM WIND BORNE DEBRIS. WOOD STRUCTURAL PANELS WITH A MIN. THICKNESS OF 1/2" AND A MAX. SPAN OF 8 FEET SHALL BE PERMITTED FOR OPENING PROTECTION IN ONE AND TWO STORY BUILDINGS. PANELS SHALL BE PRECUT TO COVER THE GLAZED OPENINGS WITH ATTACHMENT HARDWARE PROVIDED.

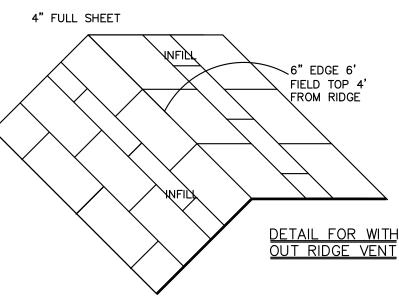

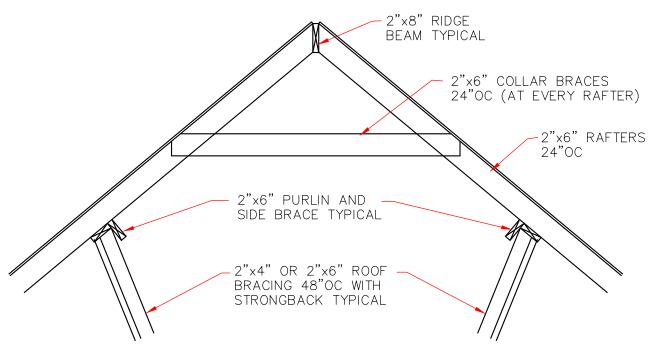


TYPICAL ROOF BRACING DETAIL

CONTINUOUS

H8 CLIPS MAY BE INSTALLED ON EITHER SIDE OF STUD WALL


NOT TO SCALE

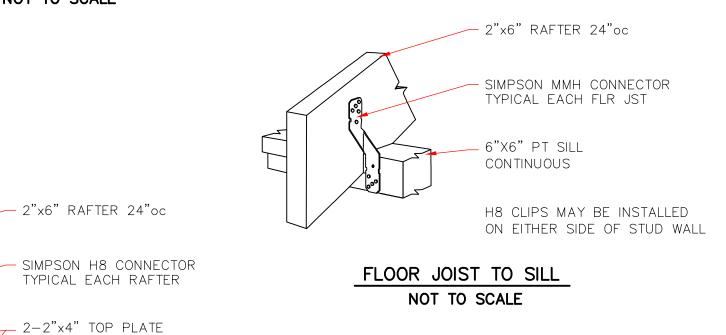

RAFTER TO TOP PLATES NOT TO SCALE

4'-0" __2-2"x4" TOP PLATE ___ 2"x4" STUDS 16"0C SOLID OSB WINDSTORM SHEATHING FROM TOP OF TOP PLATE TO BOTTOM OF BOTTOM PLATE 8d COMMON NAILS OR EQUAL 12"OC VERTICAL ALONG EACH 8d COMMON NAILS OR EQUAL 6"OC VERTICAL AND HORIZONTAL AROUND SHEET PERIMETER - 2"x4" CC BOTTOM PLATE

> 7/16" STORM SHEATHING TYPICAL ALL EXTERIOR WALLS SCALE: 3/4" = 1'-0"

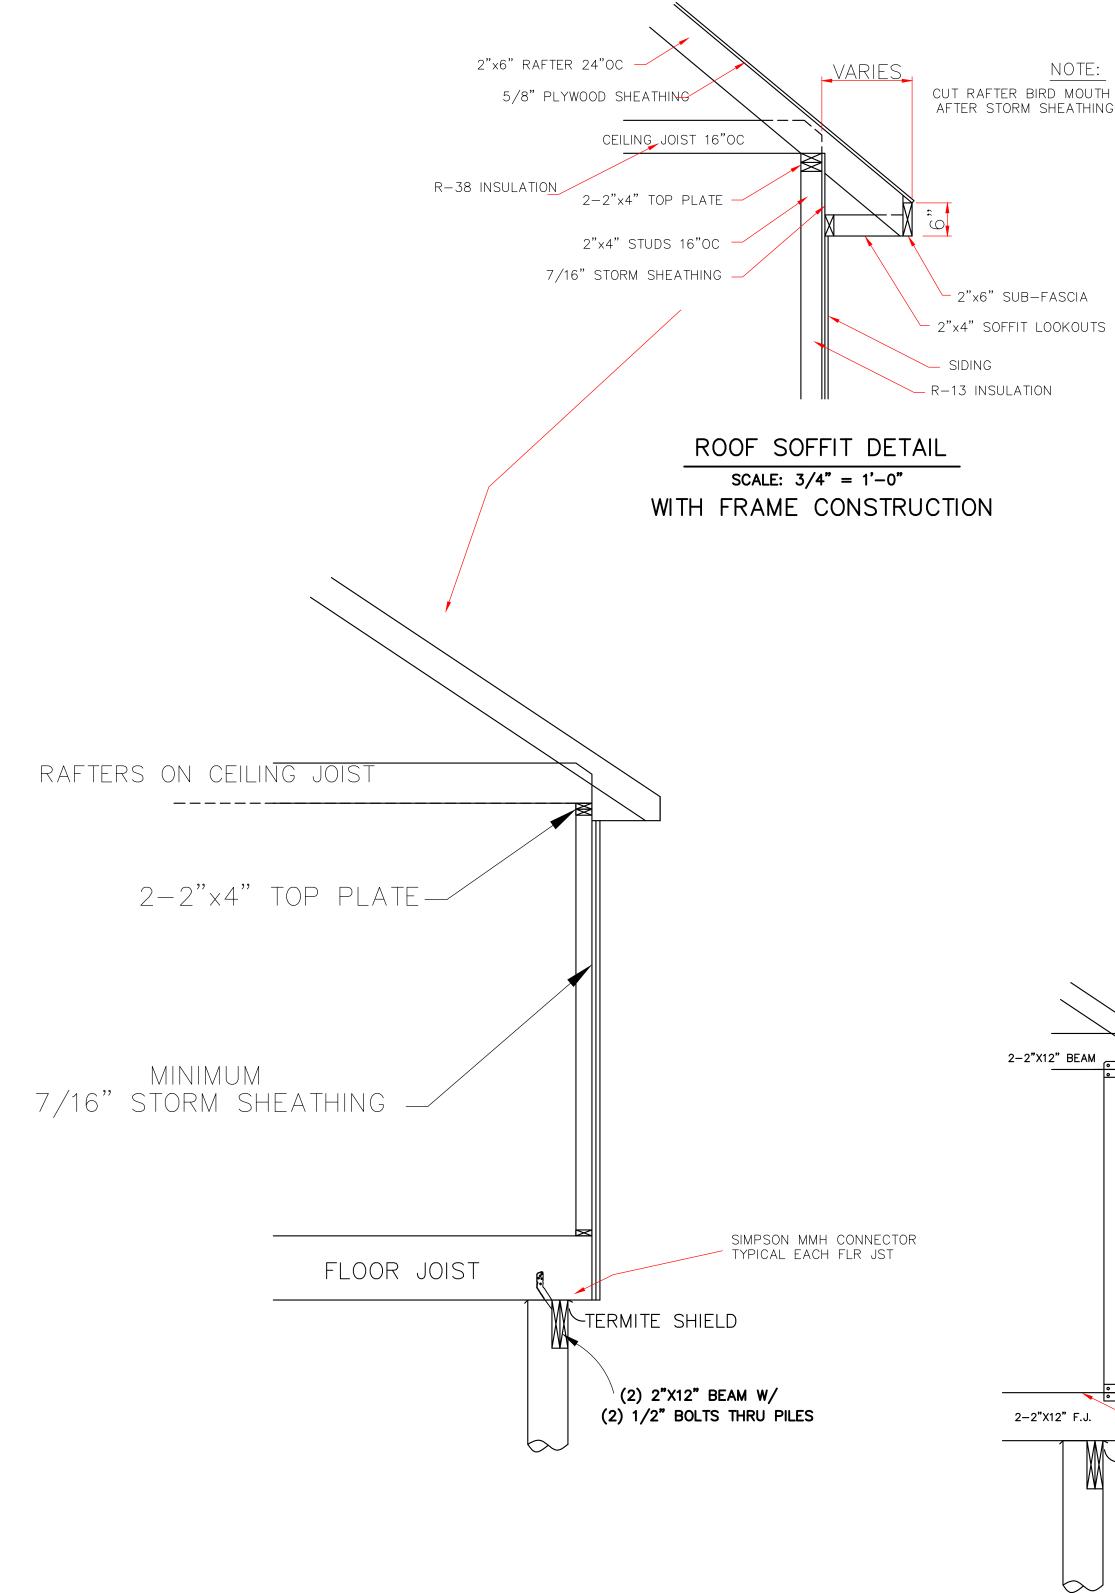

SEE FOUNDATION DETAIL

CONTINUOUS LOAD PATH


1/2" SCALE




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COLUMN SECTION

NOT TO SCALE

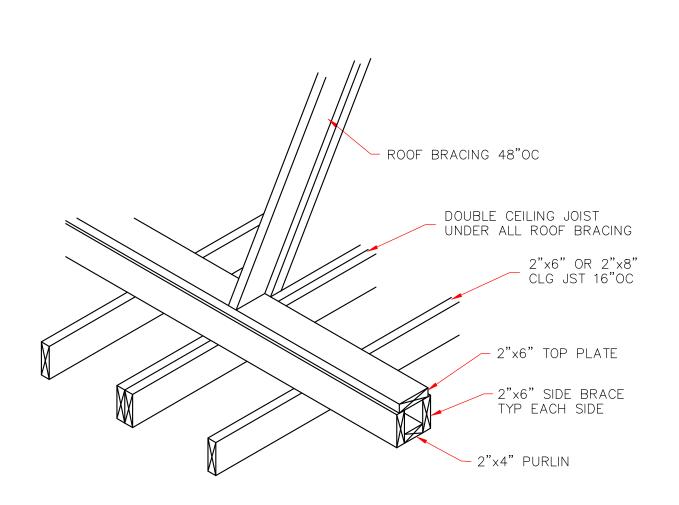

STRONGBACK DETAIL FOR 2"x6" OR 2"x8" JOIST NOT TO SCALE

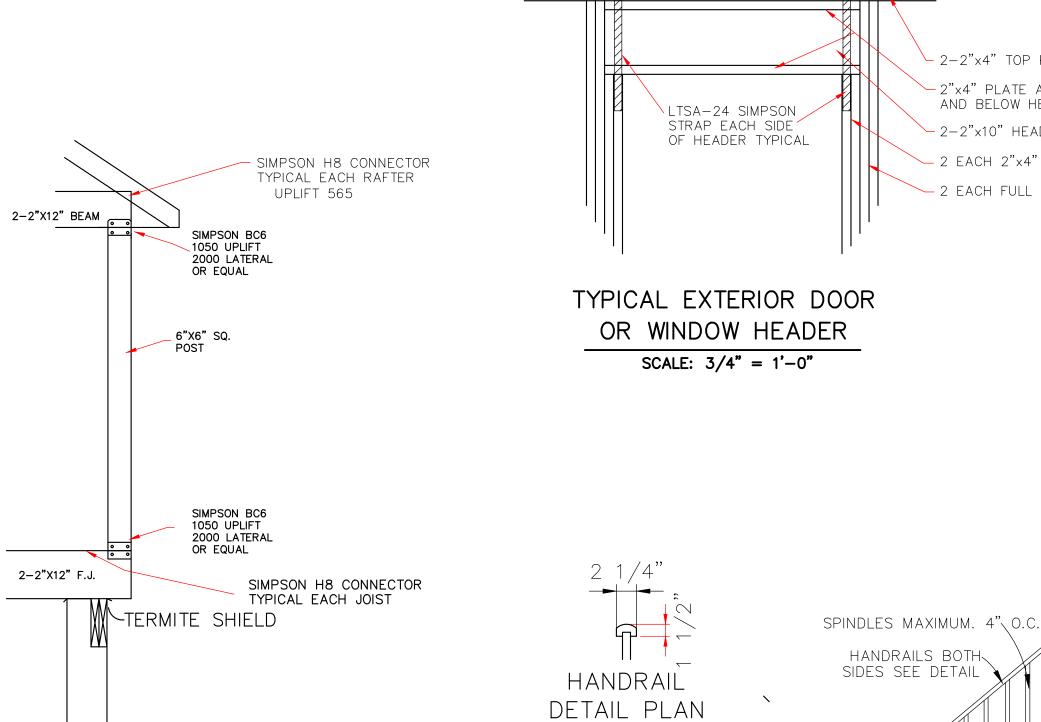

STAIR DETAIL PLAN SCALE: 1/2" = 1'-0"

- 2-2"x4" TOP PLATE

-2"x4" PLATE ABOVE

AND BELOW HEADER

-2-2"x10" HEADER BEAM

- 2 EACH 2"x4" JACK STUDS

- 2 EACH FULL LENGTH STUDS

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SCALE: $1" = \overline{1"}$

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