

**GENERAL CONSTRUCTION NOTES:**

- All utilities information is based on the best available information. The contractor shall verify exact utility location prior to any demolition or construction. Contractor shall call *Louisiana One Call* system prior to any construction. Any conflict or discrepancy discovered must be immediately brought to the engineer of record's attention.
- The contractor shall be fully responsible for any damage to the existing public or private utility lines, including but not limited to water lines, wastewater collection systems, and storm sewers. All damages shall be repaired in accordance with the New Orleans Sewerage and Water Board standard specifications, with no cost to the city of New Orleans, or owner.
- Any damage to any of the existing pavement and/or utilities must be repaired immediately. The contractor must notify the appropriate utility owner, who will make the repairs at the contractor's expense.
- The contractor, on behalf of the owner, is to obtain all permits required by the city of New Orleans.
- Guidelines set forth in the federal manual on uniform traffic control devices, as currently mended, shall be observed. The contractor shall be responsible for providing adequate flagmen, signing, striping, warning devices, etc. during construction - both day and night.
- All pipe and reinforcement steel shall be kept free of dirt and other debris. Any damage to the coating of the various material must be repaired.
- Access to all existing streets and driveways shall be maintained at all times.
- The contractor is required to follow all applicable OSHA rules and regulations.
- Surface restoration: at the end of all construction projects. The contractor shall restore the existing facilities, i.e., the property, equal to or better than existing site conditions prior to construction.
- Trench backfill for utilities shall be compacted to at least 95% of maximum density per ASTM -698. Moisture content shall be within 3% of optimum. Lifts shall be 6-inch maximum, measured loose.
- Material to conform to materials specifications.
- For new drainage outfall line connection to existing city drainage lines, see city general notes SWB 7260-D. For new drainage outfall line connections to existing city catch basins/culverts see city general note SWB 8175-SD.
- All drainage systems to be cleaned/flushed out prior to close out and turn over to ownership. All debris should be removed to ensure a clean system without clogs is in place.
- All drainage openings to have covers before and during construction to keep excess debris from entering the system. If the system intends to be used prior to completions of construction/renovations, GC to place erosion barriers around system openings to keep debris from entering the system.

**DEMOLITION NOTES:**

- Existing utilities shall be protected throughout the demolition process.
- Trees to remain unless otherwise noted. Trees are to be protected at all times throughout demolition and construction.
- Contractor to create and abide by an erosion and sedimentation management plan that meets the EPA construction management plan.

**STREET AND RIGHT-OF-WAY NOTES:**

- Utility contractor shall provide temporary silt barrier fence on all non-curb inlets, which will remain in place after underground contract is complete.
- Condition of the road and/or right-of-way, upon completion of job, shall be as good as or better than the condition prior to starting work.
- Adequate drainage shall be maintained at all times during construction and any drainage ditch or structure disturbed during construction, shall be restored to the satisfaction of the owning authority by the contractor.
- Contractor to take necessary precautions to protect root systems of shrubs, plants and trees along the area of excavation.
- Establish and maintain all control points and bench marks necessary for the work.
- Where a state or local municipal standard detail duplicates a detail shown in the plans, the more stringent detail, as determined by the reviewing agency, shall apply.

**STORM SEWER CONSTRUCTION NOTES:**

- Storm sewer pipe shall be type "S" corrugated high density polyethylene pipe (HDPE) smooth flow, schedule 40 PVC or reinforced concrete pipe (c-76, class iii or v) as noted on plans.
- All storm sewer trenches shall be backfilled with engineered fill material.
- All existing catch basins and storm sewer lines shall be inspected and cleared of debris. If an existing drain or drain line is found to be damaged or unserviceable the engineer is to be notified.
- Contractor shall provide 12" minimum clearance at sewer and water line crossings.
- When the top of curb elevation or bottom of pavement slab is above natural ground, the contractor shall backfill from the natural ground to top of curb in layers, not exceeding 6 inches in depth and each layer compacted to not less than 95 % standard proctor density and shall fill from curb to edge of tree line.
- The contractor shall be responsible for protecting, maintaining, and restoring any back slope drainage systems disturbed as a result of his work.

**PARKING AND TRAFFIC CONTROL NOTES:**

- Handicap accessible parking spaces shall conform to the requirements of the Americans with Disabilities Act (ADA) of 2010 unless otherwise noted.
- All limits of pavement to be curbed unless noted or detailed otherwise.
- All standard parking spaces to be 8 feet 6 inches in width by 18 feet in length unless noted or detailed otherwise.
- All pavement striping to be painted with 2 coats of paint 4" wide. refer to site plan, sheet CXXX for striping layout.
- Refer to architectural/building plans for exact location and dimensions of exit porches, ramps, truck docks, precise building dimensions, and exact utility entrance locations.
- Refer to architectural/building plans for location of handicap signage.

**PAVEMENT NOTES:**

- Paving subgrade shall be 6" thick, engineered fill, compacted to 95% of maximum density per ASTM D-698. Moisture content shall be within 3% of optimum.
- Concrete sidewalks shall be 4" thick reinforced with 6x6 welded wire fabric (WWF).
- The new pavement shall be finished to match the surrounding pavement.
- Joints or score marks are to be sharp and clean without showing edges of jointing tool.
- Saw-cut tie-ins at existing curbs as necessary to insure smooth transitions. Contractor shall saw-cut and transition to meet existing pavement as necessary and as directed by inspector to ensure positive drainage. (typical all intersections).
- Concrete paving expansion joints are to be located at a maximum of 20'-0".
- All concrete to be 4,000 psi compressive strength at 28-days unless otherwise noted.

**ENERGY NOTES:**

**WARNING: OVERHEAD ELECTRICAL FACILITIES**

Overhead lines may exist on the property. We have not attempted to mark those lines since they are clearly visible, but you should locate them prior to beginning any construction. Contractor is responsible for the safety of construction workers. To arrange for lines to be turned off or removed, call Entergy of New Orleans.

**CAUTION: UNDERGROUND GAS FACILITIES**

Locations of Entergy main lines are shown in an approximate location only. Service lines are usually not shown. Our signature on these plans only indicates that our facilities are shown in approximate location. It does not imply that a conflict analysis has been made. The contractor shall coordinate construction with local utilities. The contractor is fully responsible for any damages caused by the contractor's failure to exactly locate and preserve these underground facilities.

**CIVIL ANNOTATIONS**

**MARK**

**DEFINE**

BOC  
TOC  
BOW  
TOW  
TOR  
VIF  
RIM  
BOS  
BOR  
TOD  
EJ  
CJ  
IJ  
MH  
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G  
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WV

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C.O.

BOTTOM OR CURB  
TOP OF CURB  
BOTTOM OF WALL  
TOP OF WALL  
TOP OF RAMP  
VERIFY IN FIELD  
RIME ELEVATION  
BOTTOM OF STAIR  
BOTTOM OF RAMP  
TOP OF DRAIN  
EXPANSION JOINT  
CONTROL JOINT  
ISOLATION JOINT  
MAN HOLE  
SEWER  
GAS  
WATER  
DRAINAGE  
WATER VALVE

WATER METER

EXITING CATCH BASIN

SMALL CAR PARKING

HANDICAPPED ACCESSIBLE PARKING

DIRECTION OF VEHICULAR CIRCULATION

GAS LINE

CATCH BASIN

POWER LINE

CLEAN OUT

Civil Drawing List				
Sheet Number	Sheet Name	Current Revision	Current Revision Date	Current Revision Description
C000	Civil General Notes			
C100.0	Survey			
C100.1	Existing Site Plan			
C101	New Site Plan			
C102	Drainage Plan			
C201	Civil Details 1			
C202	Civil Details 2			
C203	Civil Details 3			
C204	Civil Details 4			



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NO REVISION DATE

Permit Set 9/28/2021

Restoration and Renovation of:

747 St. Charles Ave.  
New Orleans, LA 70130

20070 JOB NO

Civil General Notes TITLE

12" = 1'-0" SCALE

LDS /JP DRAWN/CHK


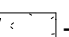
C000

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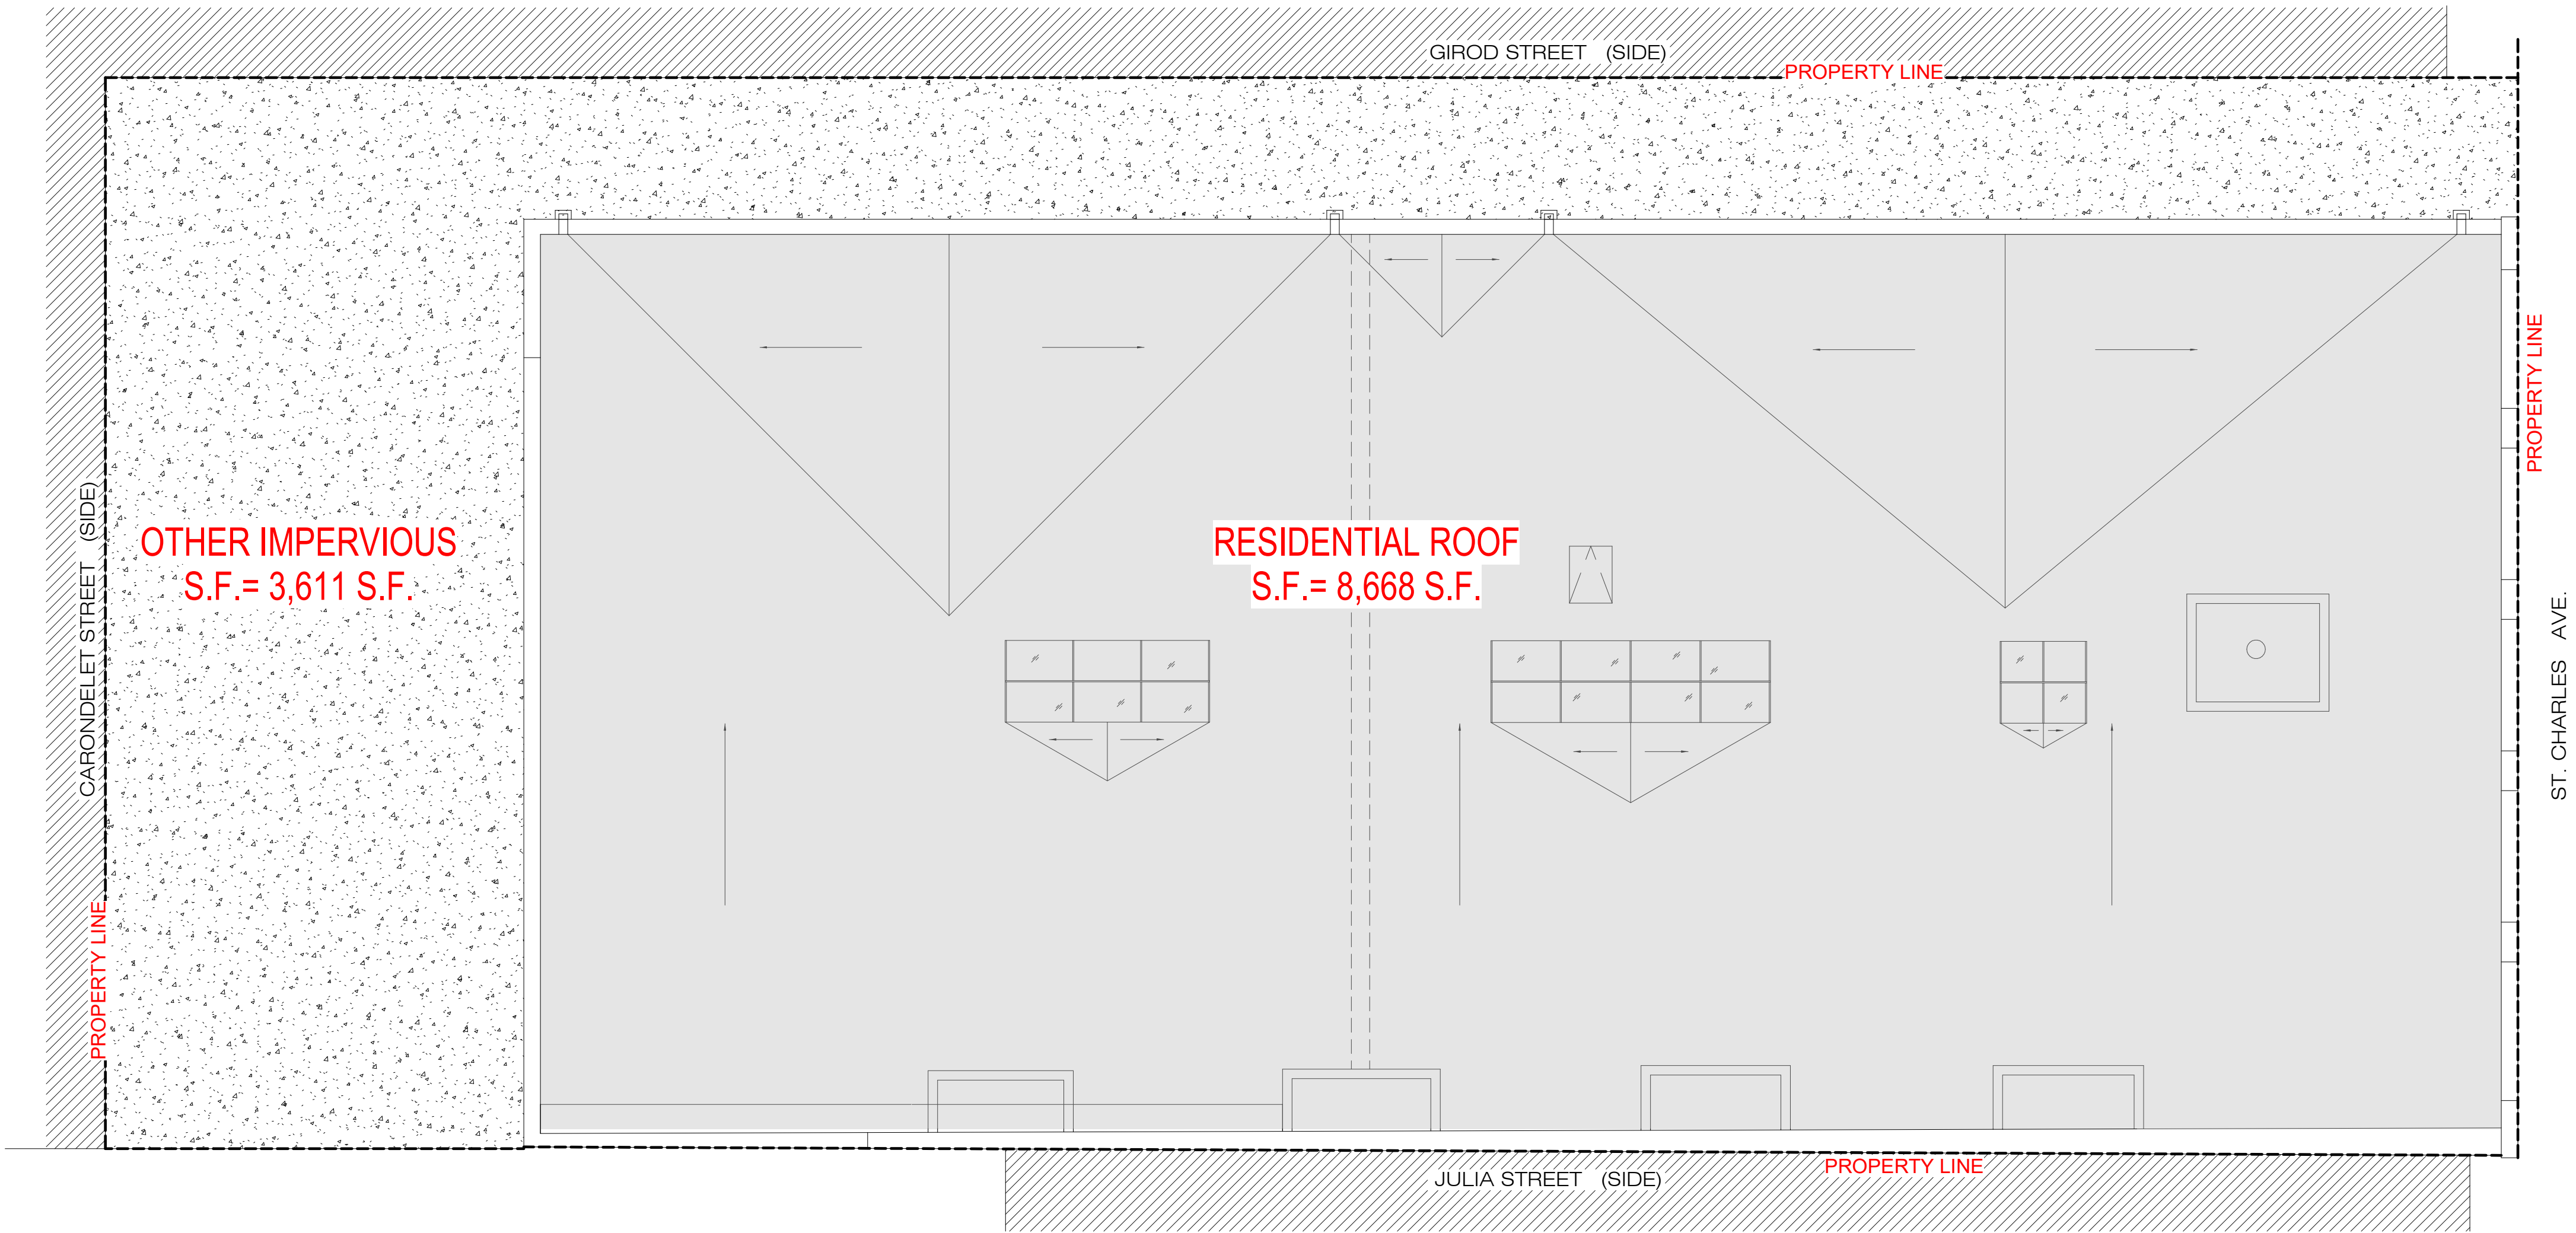


MATERIAL LEGEND:

1.  -DENOTES EXISTING RESIDENTIAL ROOF.
2.  -DENOTES EXISTING OTHER IMPERVIOUS PAVEMENT.

PRE-DEVELOPMENT DRAINAGE AREA 1 TOTAL AREAS :

1. COMMERCIAL ROOF TOTAL S.F.= 8,668 S.F.
2. OTHER IMPERVIOUS PAVEMENT TOTAL S.F.= 3,611 S.F.



1 Existing Site Plan

C100.1 1/8" = 1'-0"



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Exisitng Site Plan TITLE

As indicated SCALE

LDS /JP DRAWN/CHK




C100.1


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NEW SITE PLAN LEGEND:

1. DENOTES EXISTING COMMERCIAL ROOF.
2. DENOTES REFINISH CONCRETE PAVEMENT.
3. DENOTES NEW OUTDOOR POOL.
4. DENOTES NEW COVER SITTING AREA.
5. DENOTES DOWNSPOUD LOCATION.
6. DENOTES NEW LANDSPACE ISLAND LOCATION.
7. DENOTES EXISTING CATCH BASIN.
8. DENOTES EXISTING SIDEWALK, REPAIR TO CITY SPECIFICATIONS IF REQUIRED.

MATERIAL LEGEND:

1.  -DENOTES NEW COMMERCIAL/RESIDENTIAL ROOF.
2.  -DENOTES NEW LANDSCAPE AREAS. SEE LA PLANS.
3.  -DENOTES NEW CONCRETE PAVEMENT.

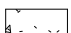

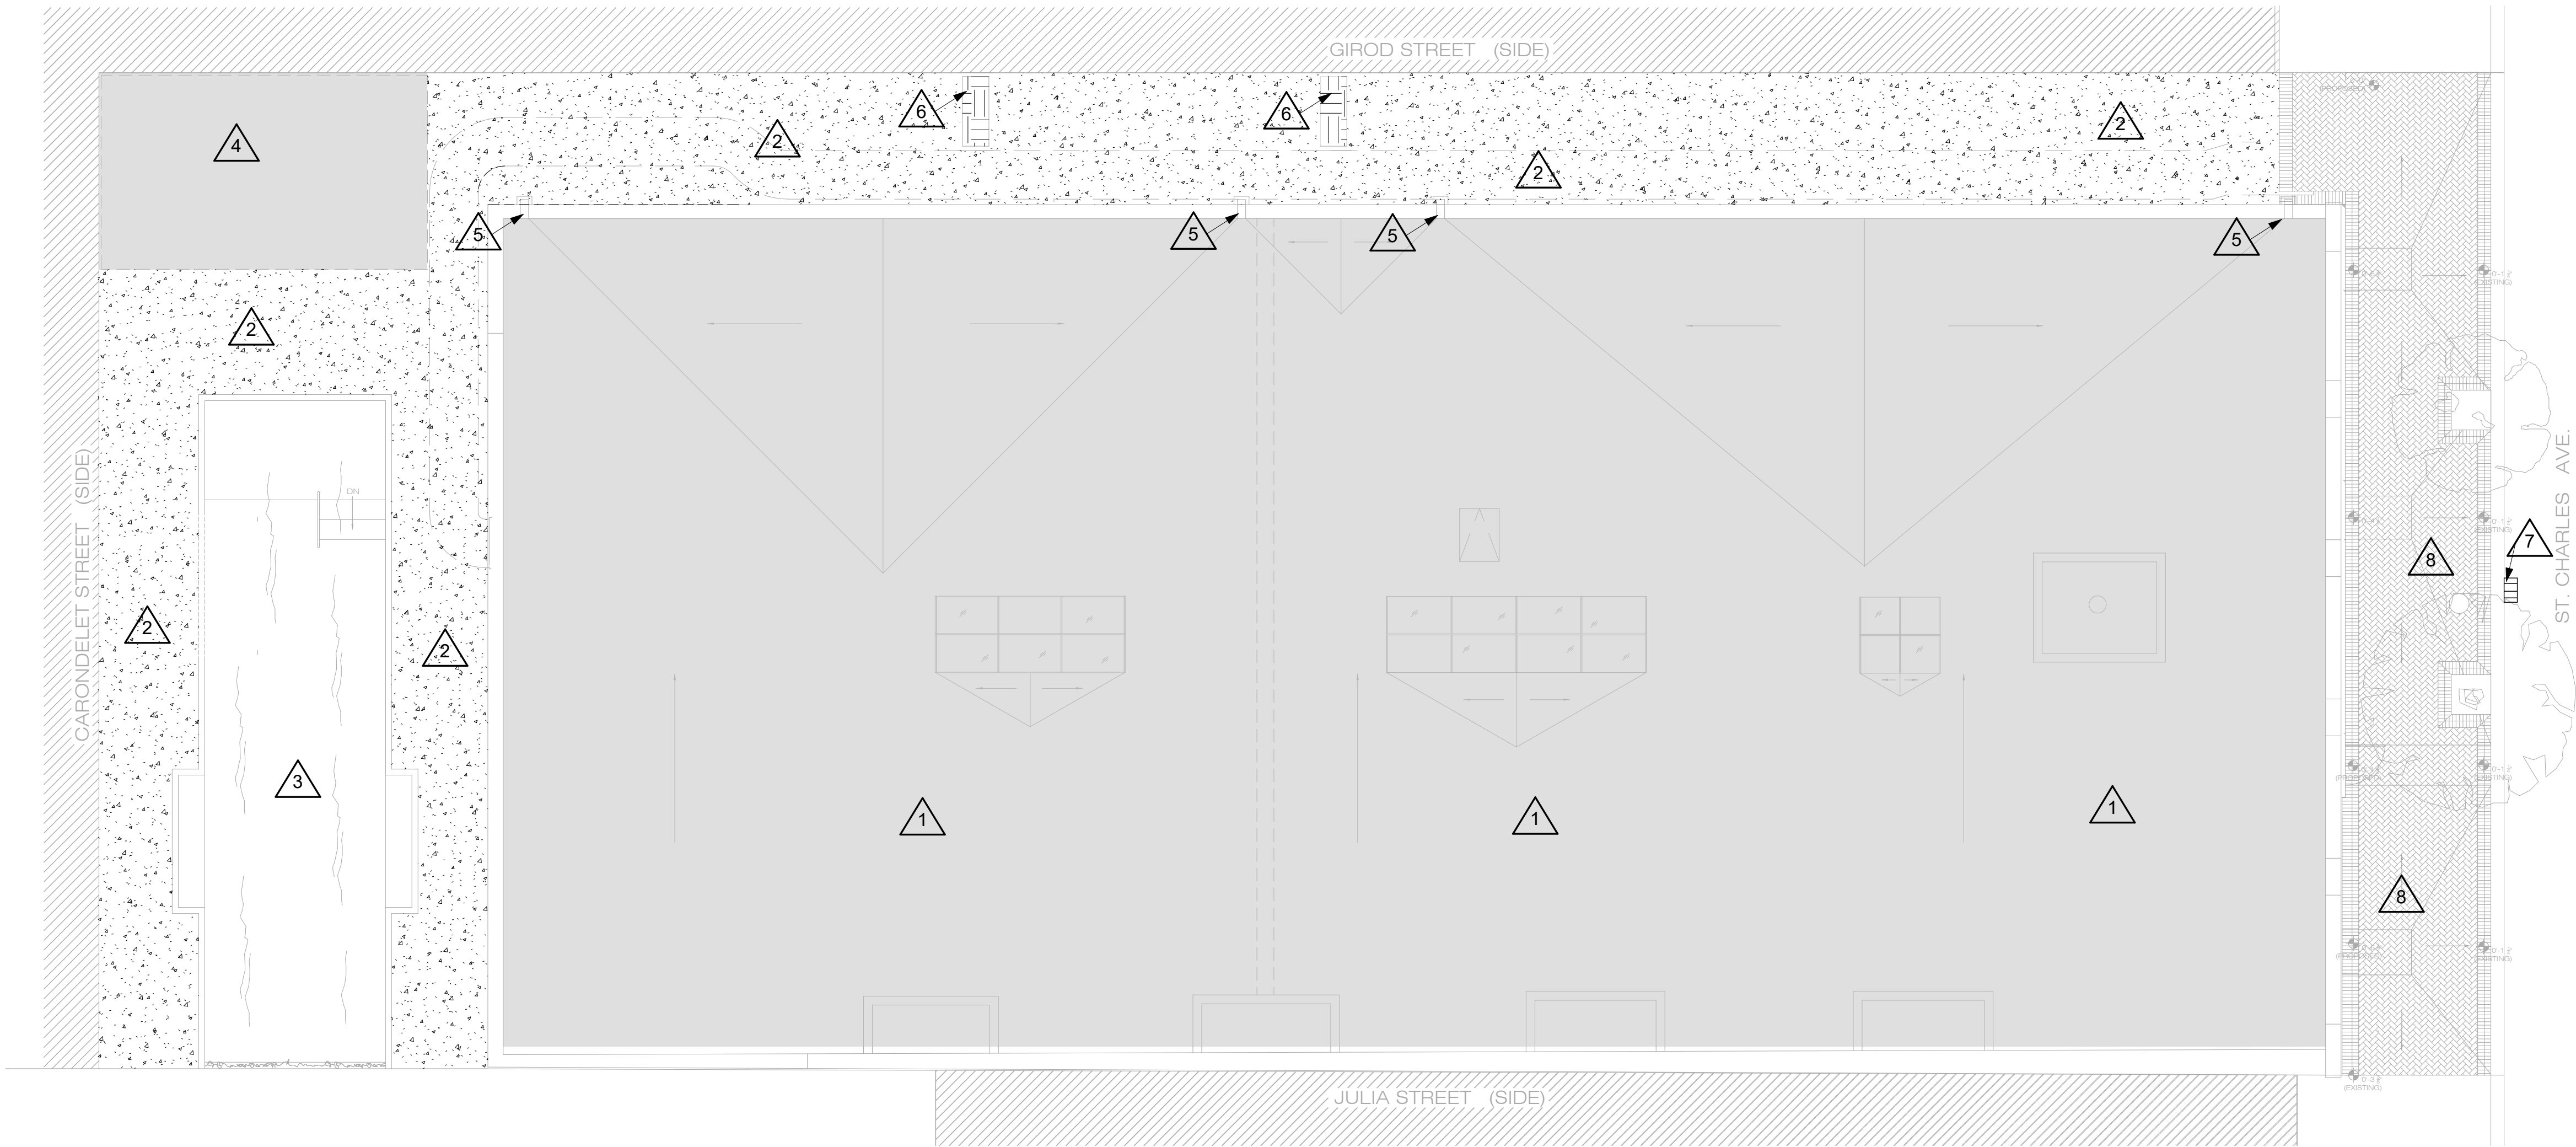1 New Site Plan

C101 1/8" = 1'-0"



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20070	JOB NO
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New Site Plan	TITLE
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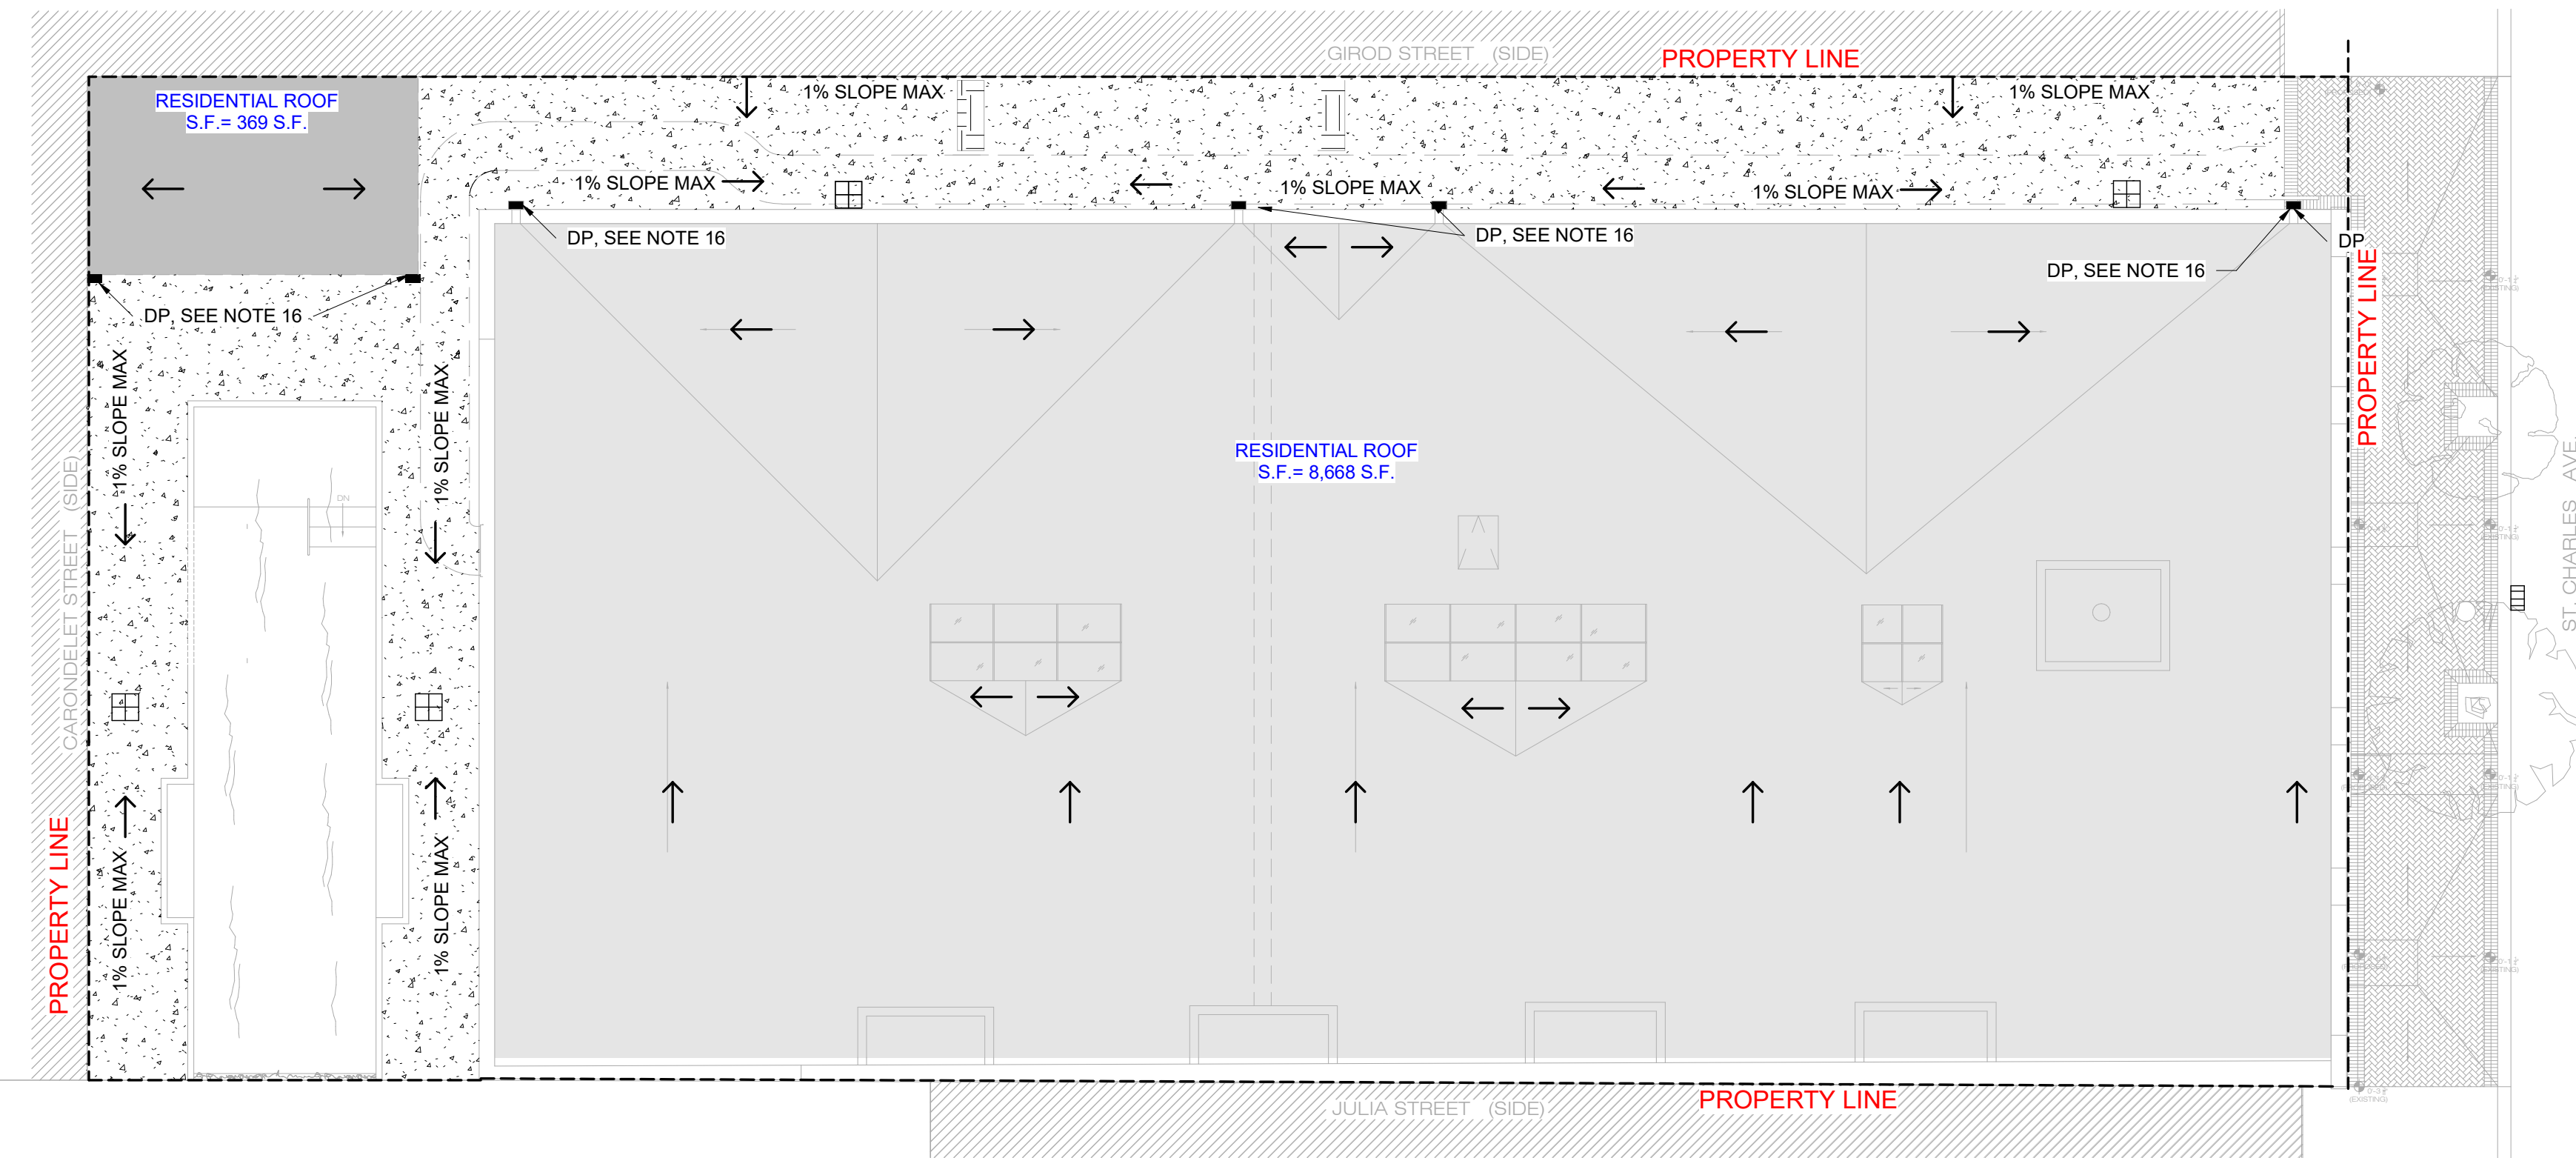
As indicated	SCALE
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LDS /JP	DRAWN/CHK
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C101

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**DRAINAGE PLAN NOTES:**

1. SEE PAVING PLAN FOR ELEVATIONS AND SLOPES OF PAVING.
2. SEE ARCH. PLANS FOR FINISHED FLOOR ELEVATIONS.
3. SEE DRAWING C00 FOR GENERAL NOTES.
4. SEE DRAWINGS C200S FOR TYPICAL DETAILS.
5. COORDINATE ALL NEW AND EXISTING UNDERGROUND UTILITIES WITH FOUNDATIONS AND SUBMIT ALL-PURPOSED SLEEVE LOCATIONS TO ARCH/ENG FOR REVIEW.
6. REFER TO CIVIL SPECIFICATIONS, GENERAL NOTES, AND SCHEDULES FOR OTHER INFORMATION NOT SHOWN.
7. ALL PIPE CONNECTIONS TO BE AT 45 DEGREES.
8. -DENOTES 24' X 24' CATCH BASIN.
9. - DENOTES DOWNSPOUT LOCATIONS. COORD. DOWNSPOUT LOCATIONS WITH ARCH AND MEP ON EXACT LOCATIONS OF ROOF.
10. SEE DRAINAGE PLAN FOR LOCATIONS OF PERFORATED PIPE.
11. SEE DRAINAGE PLAN FOR LOCATIONS OF SOLID PVC UNDERGROUND STORMWATER PIPE.
12. SEE L.A. PLANS FOR ALL LANDSCAPE INFORMATION.
13. SEE DRAINAGE PLAN FOR INVERT ELEVATIONS
14. DRAIN PIPE SLOPES SHALL REMAIN CONSISTENT THROUGH PIPE INTERSECTIONS.
15. SEE DRAINAGE PLAN FOR ALL DRAINAGE PIPES SLOPES.
16. THIS DOWNSPOUT LOCATION IS TO HAVE A SPLASH PAD FOR STORM WATER TO SHEET FLOW TO POWERBLOCK PERMEABLE PAVERS AREA.
17. THIS DOWNSPOUT LOCATION IS TO HAVE A DOWNSPOUT BOOT, SEE CIVIL DETAILS.

**DRAINAGE AREA 1 LEGEND:**


1. **BLUE** - WORDING DENOTES ALL AREAS CONTRIBUTING TO DRAINAGE AREA 1.

**MATERIAL LEGEND:**

1. -DENOTES NEW COMMERCIAL/RESIDENTIAL ROOF.
2. -DENOTES NEW LANDSCAPE AREAS. SEE LA PLANS.
3. -DENOTES NEW CONCRETE PAVEMENT.

**1 Roof Drainage Plan**

C102 3/32" = 1'-0"

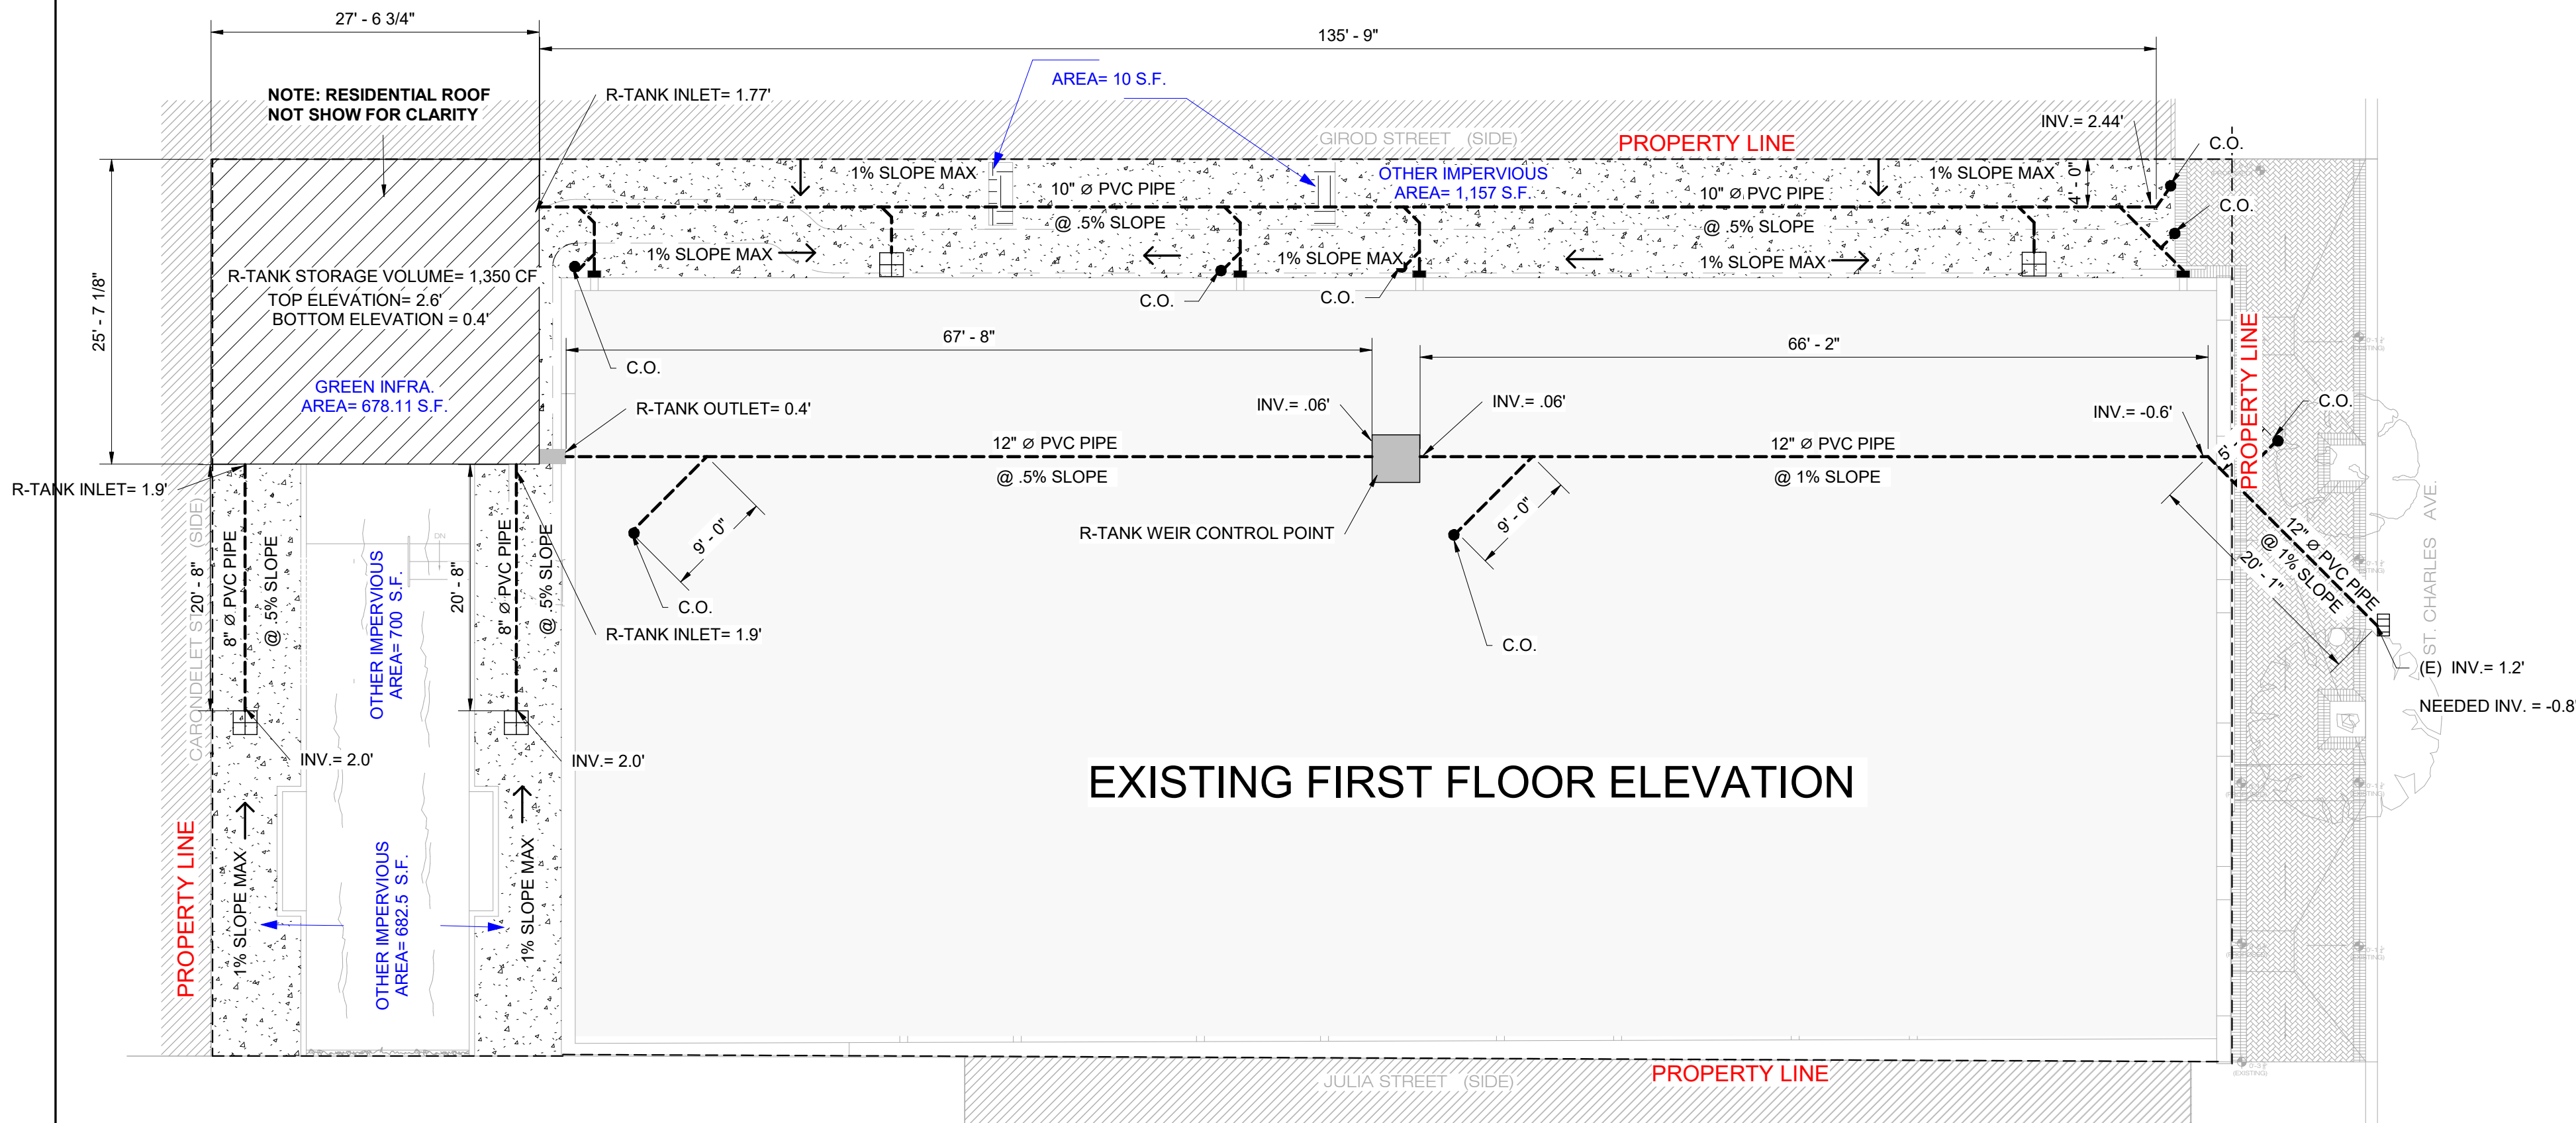

**2 Drainage Plan**

C102 3/32" = 1'-0"



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Drainage Plan TITLE



As indicated SCALE

LDS /JP DRAWN/CHK

**C102**

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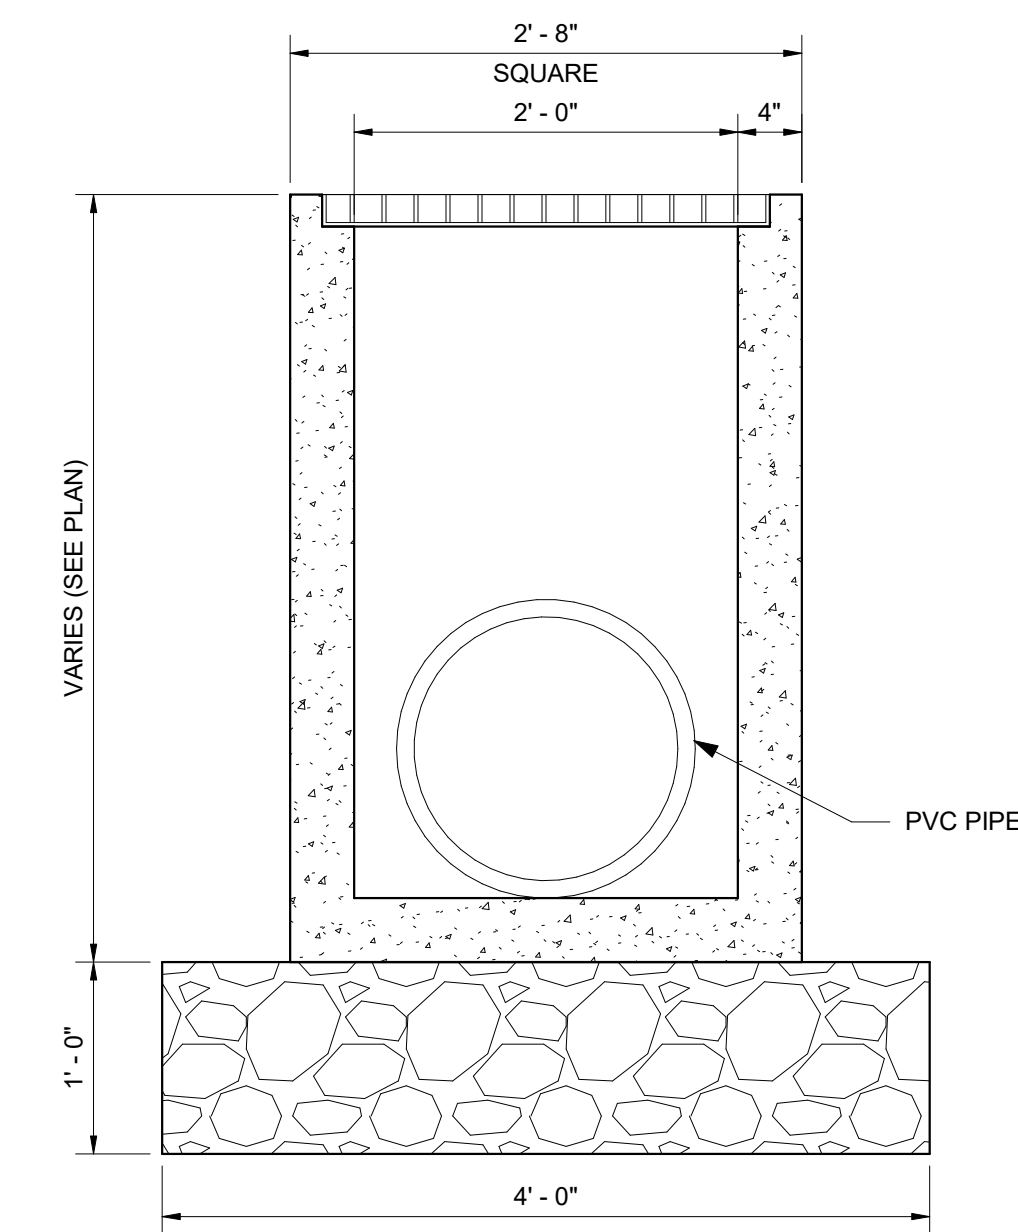


#### SECTION B-B N.T.S.

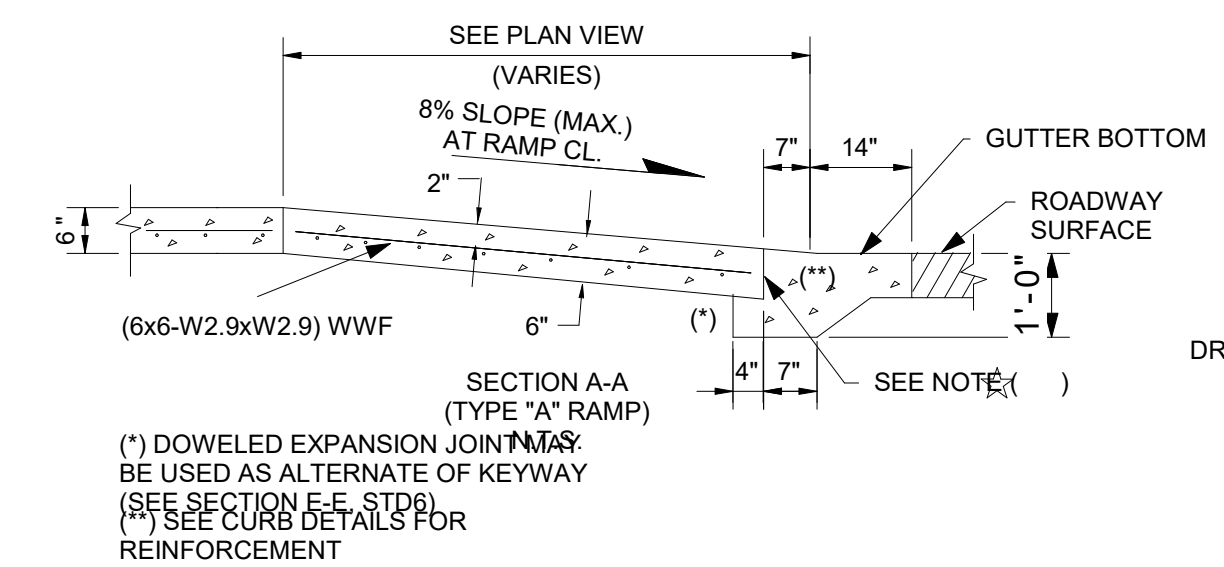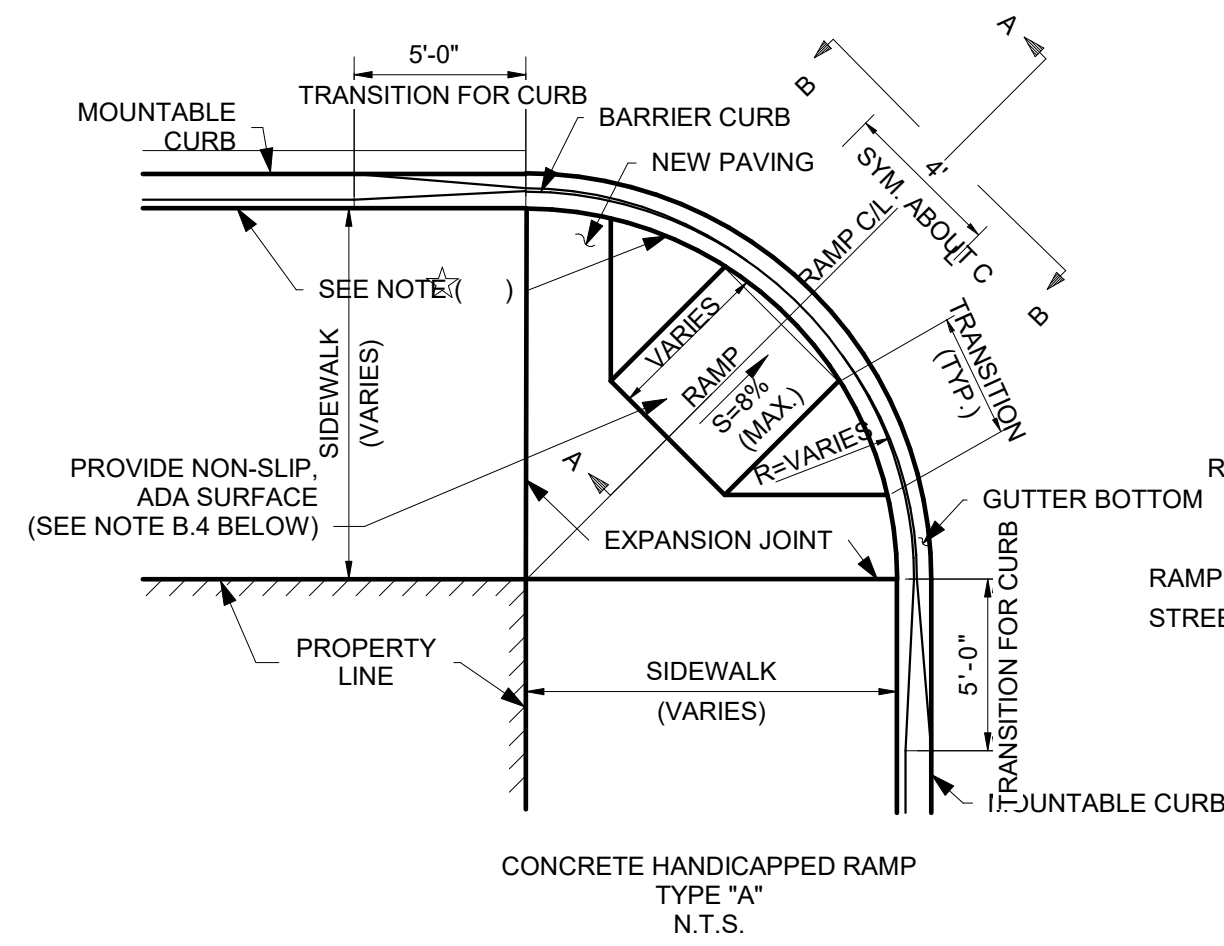- CONSTRUCTION NOTES:
1. THE SLOPE OF THE RAMP SHALL NOT EXCEED 8%
  2. THE SLOPE OF THE SIDEWALK AND SIDEWALK TRANSITION SHALL NOT EXCEED 8%
  3. THE WIDTH OF THE RAMP SHALL NOT BE LESS THAN 4 FEET (1.2 M) BUT MAY EXCEED THIS WHERE NECESSARY.
  4. SURFACE TEXTURE OF THE CONCRETE RAMP SHALL BE COMPILED WITH THE LATEST EDITION OF ADA REGULATIONS
- (\*) EXPANSION JOINT IS REQUIRED WHEN THE RAMP TRANSITION IS NEEDED.


### 1 TYPICAL DETAIL

C201 ADA Ramp Detail



### 5 24"x24" Catch Basin


C201 1" = 1'-0"

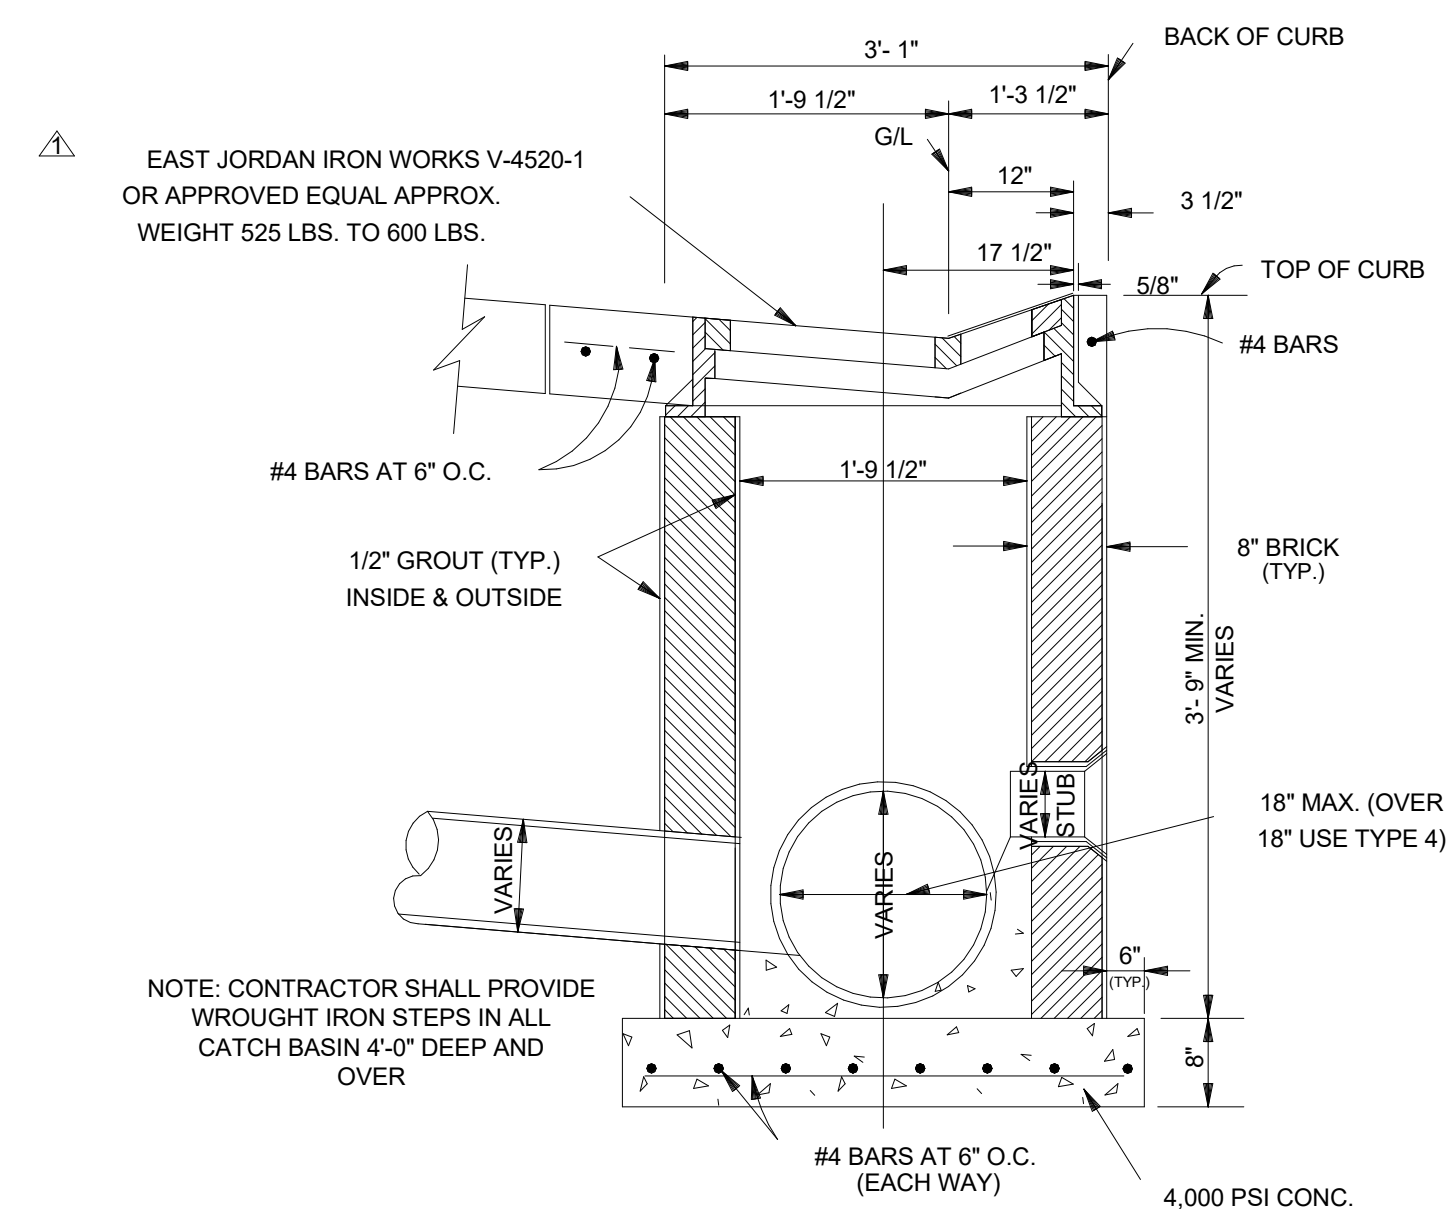

#### SIDE ELEVATION OF ROLLOVER CATCH BASIN TYPE 2 N.T.S.


### 6 Catchbasin Detail

C201 3/4" = 1'-0"

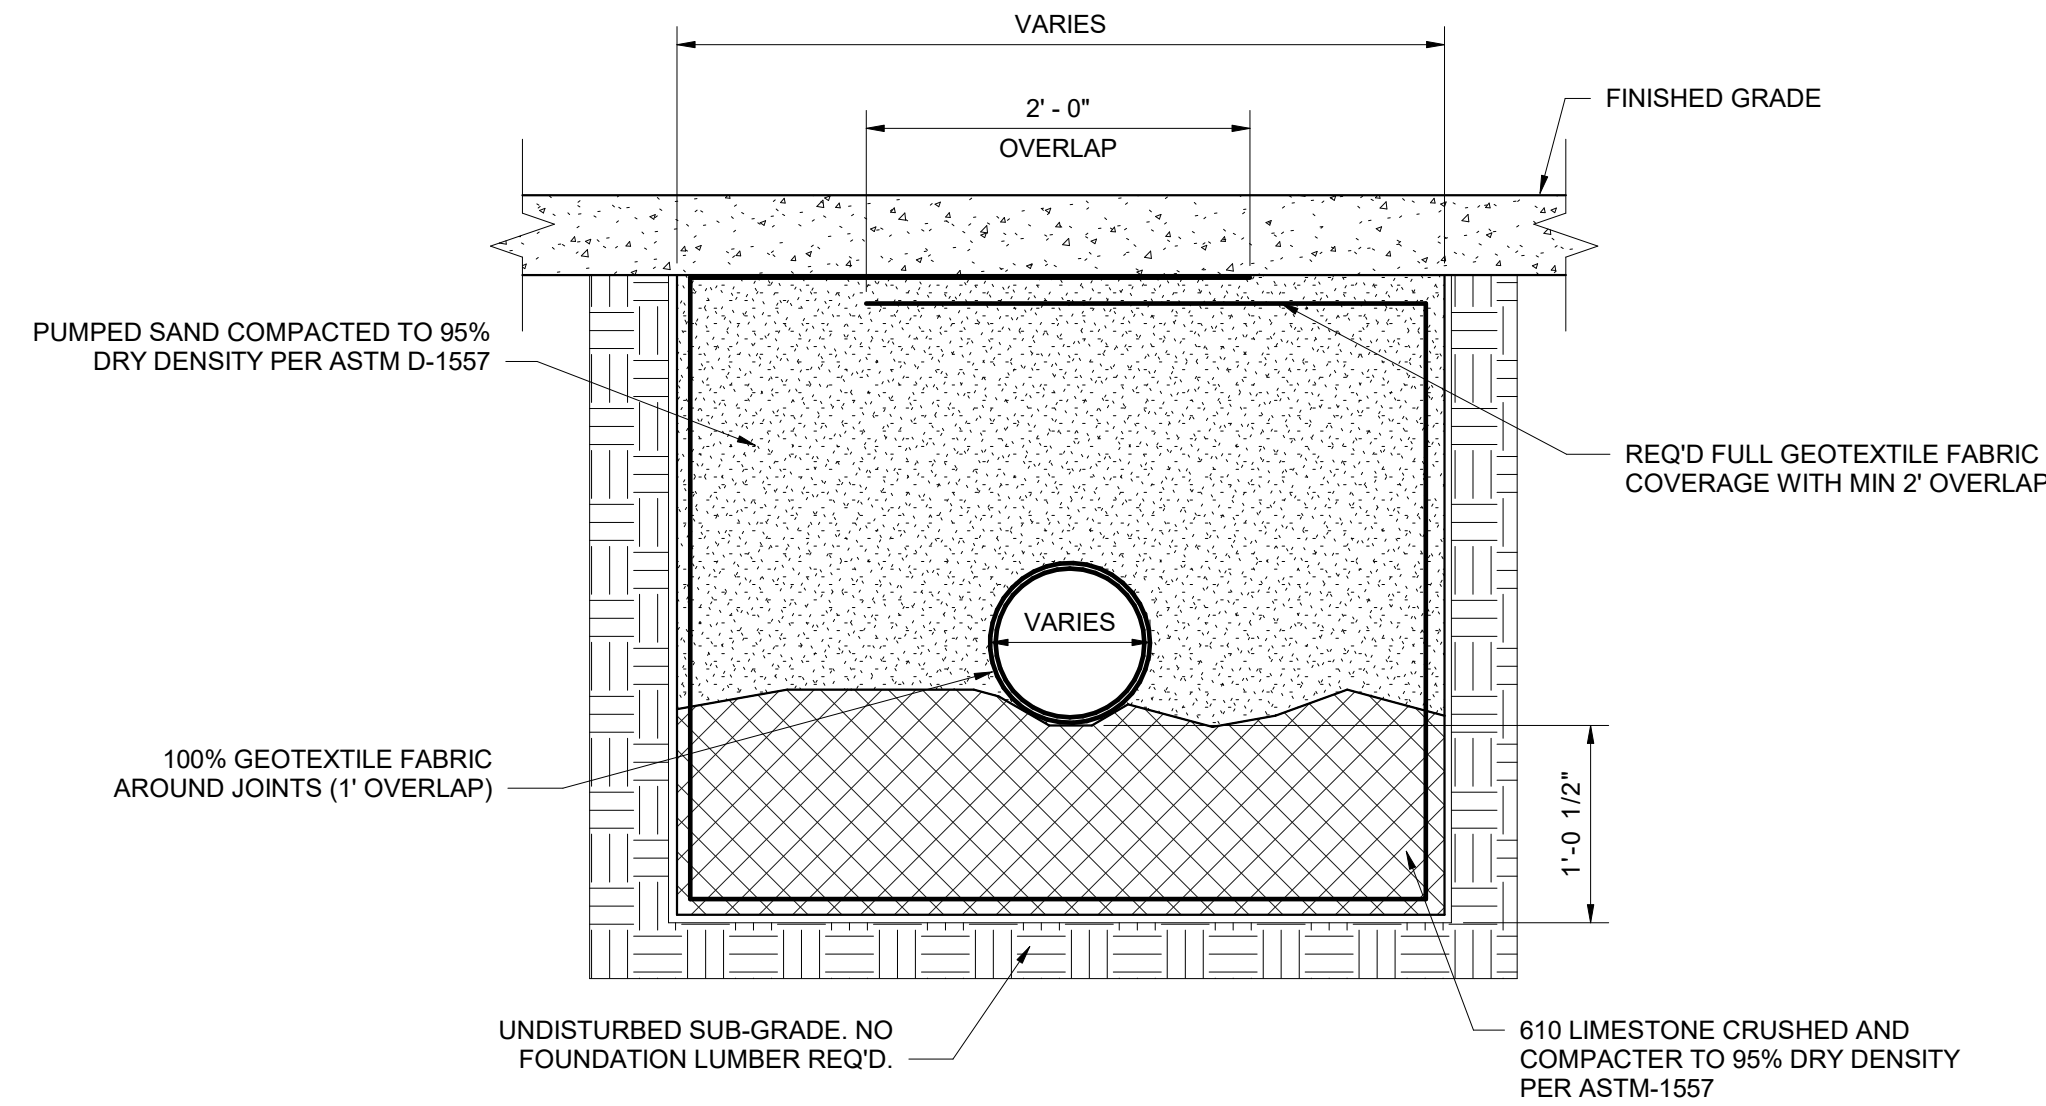


### 2 TYPICAL DETAIL

C201 Civil Drainage Trench Detail

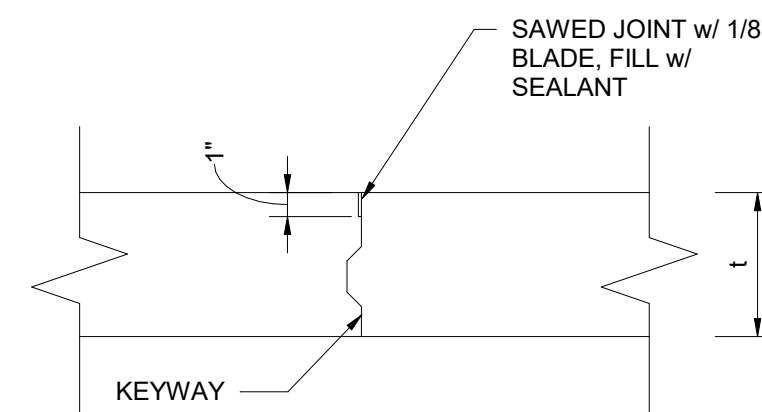


### 3 Typical Control Joint

C201 1 1/2" = 1'-0"

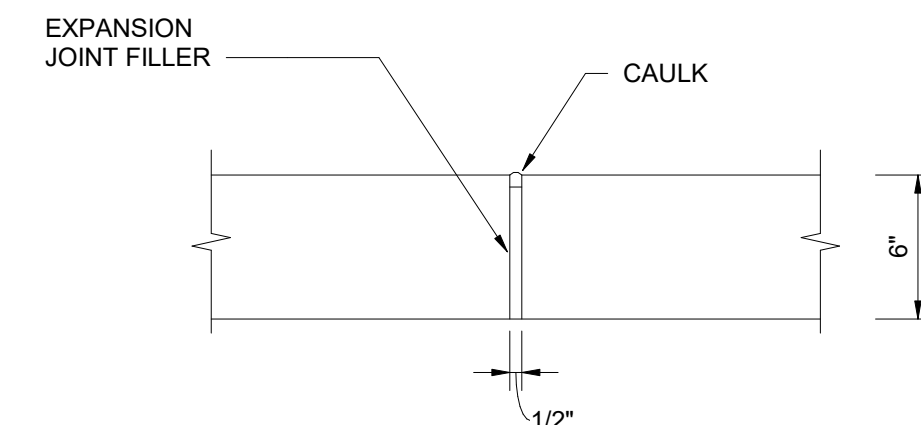

### 4 Typical Expansion Joint Detail

C201 1 1/2" = 1'-0"

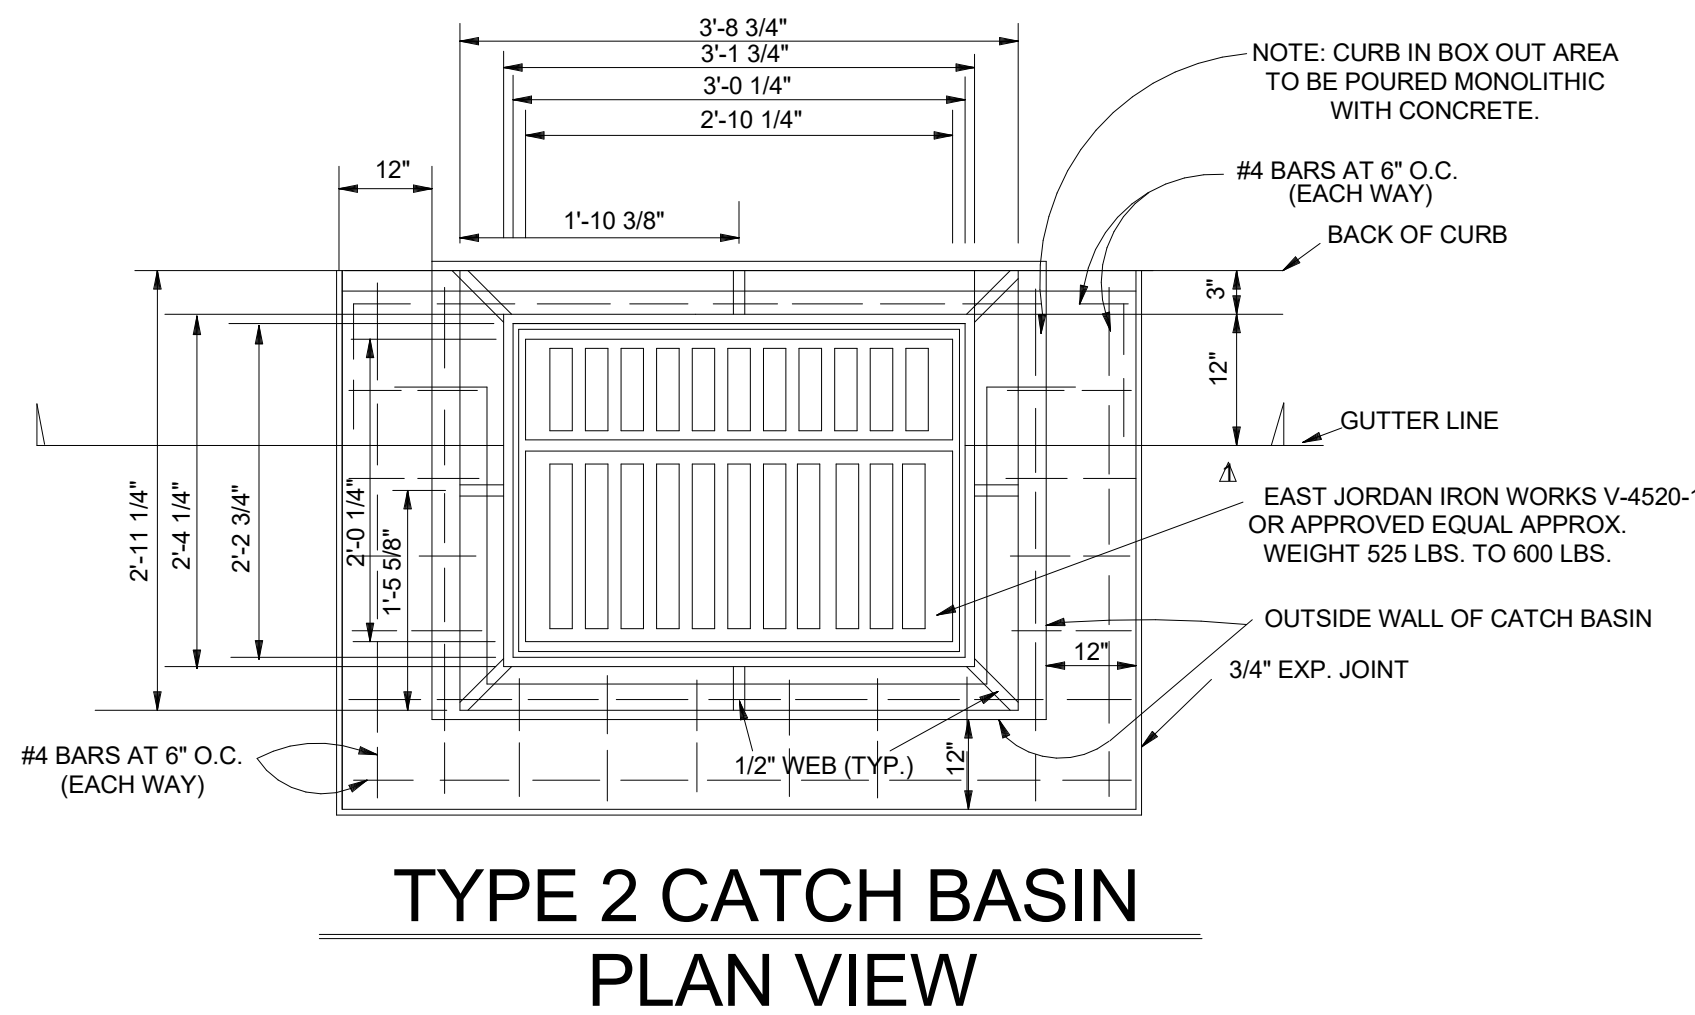

#### TYPE 2 CATCH BASIN PLAN VIEW

NOTE:  
ALL GREY IRON CASTINGS FOR MANHOLES, AND CATCH BASINS  
OF ALL TYPES SHALL CONFORM TO THE REQUIREMENTS OF A.S.T.M.  
A-48, CLASS 30, AND SHALL BE FURNISHED WITHOUT PAINT  
(AASHTO#M306-891)



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Civil Details 1 TITLE

As indicated SCALE

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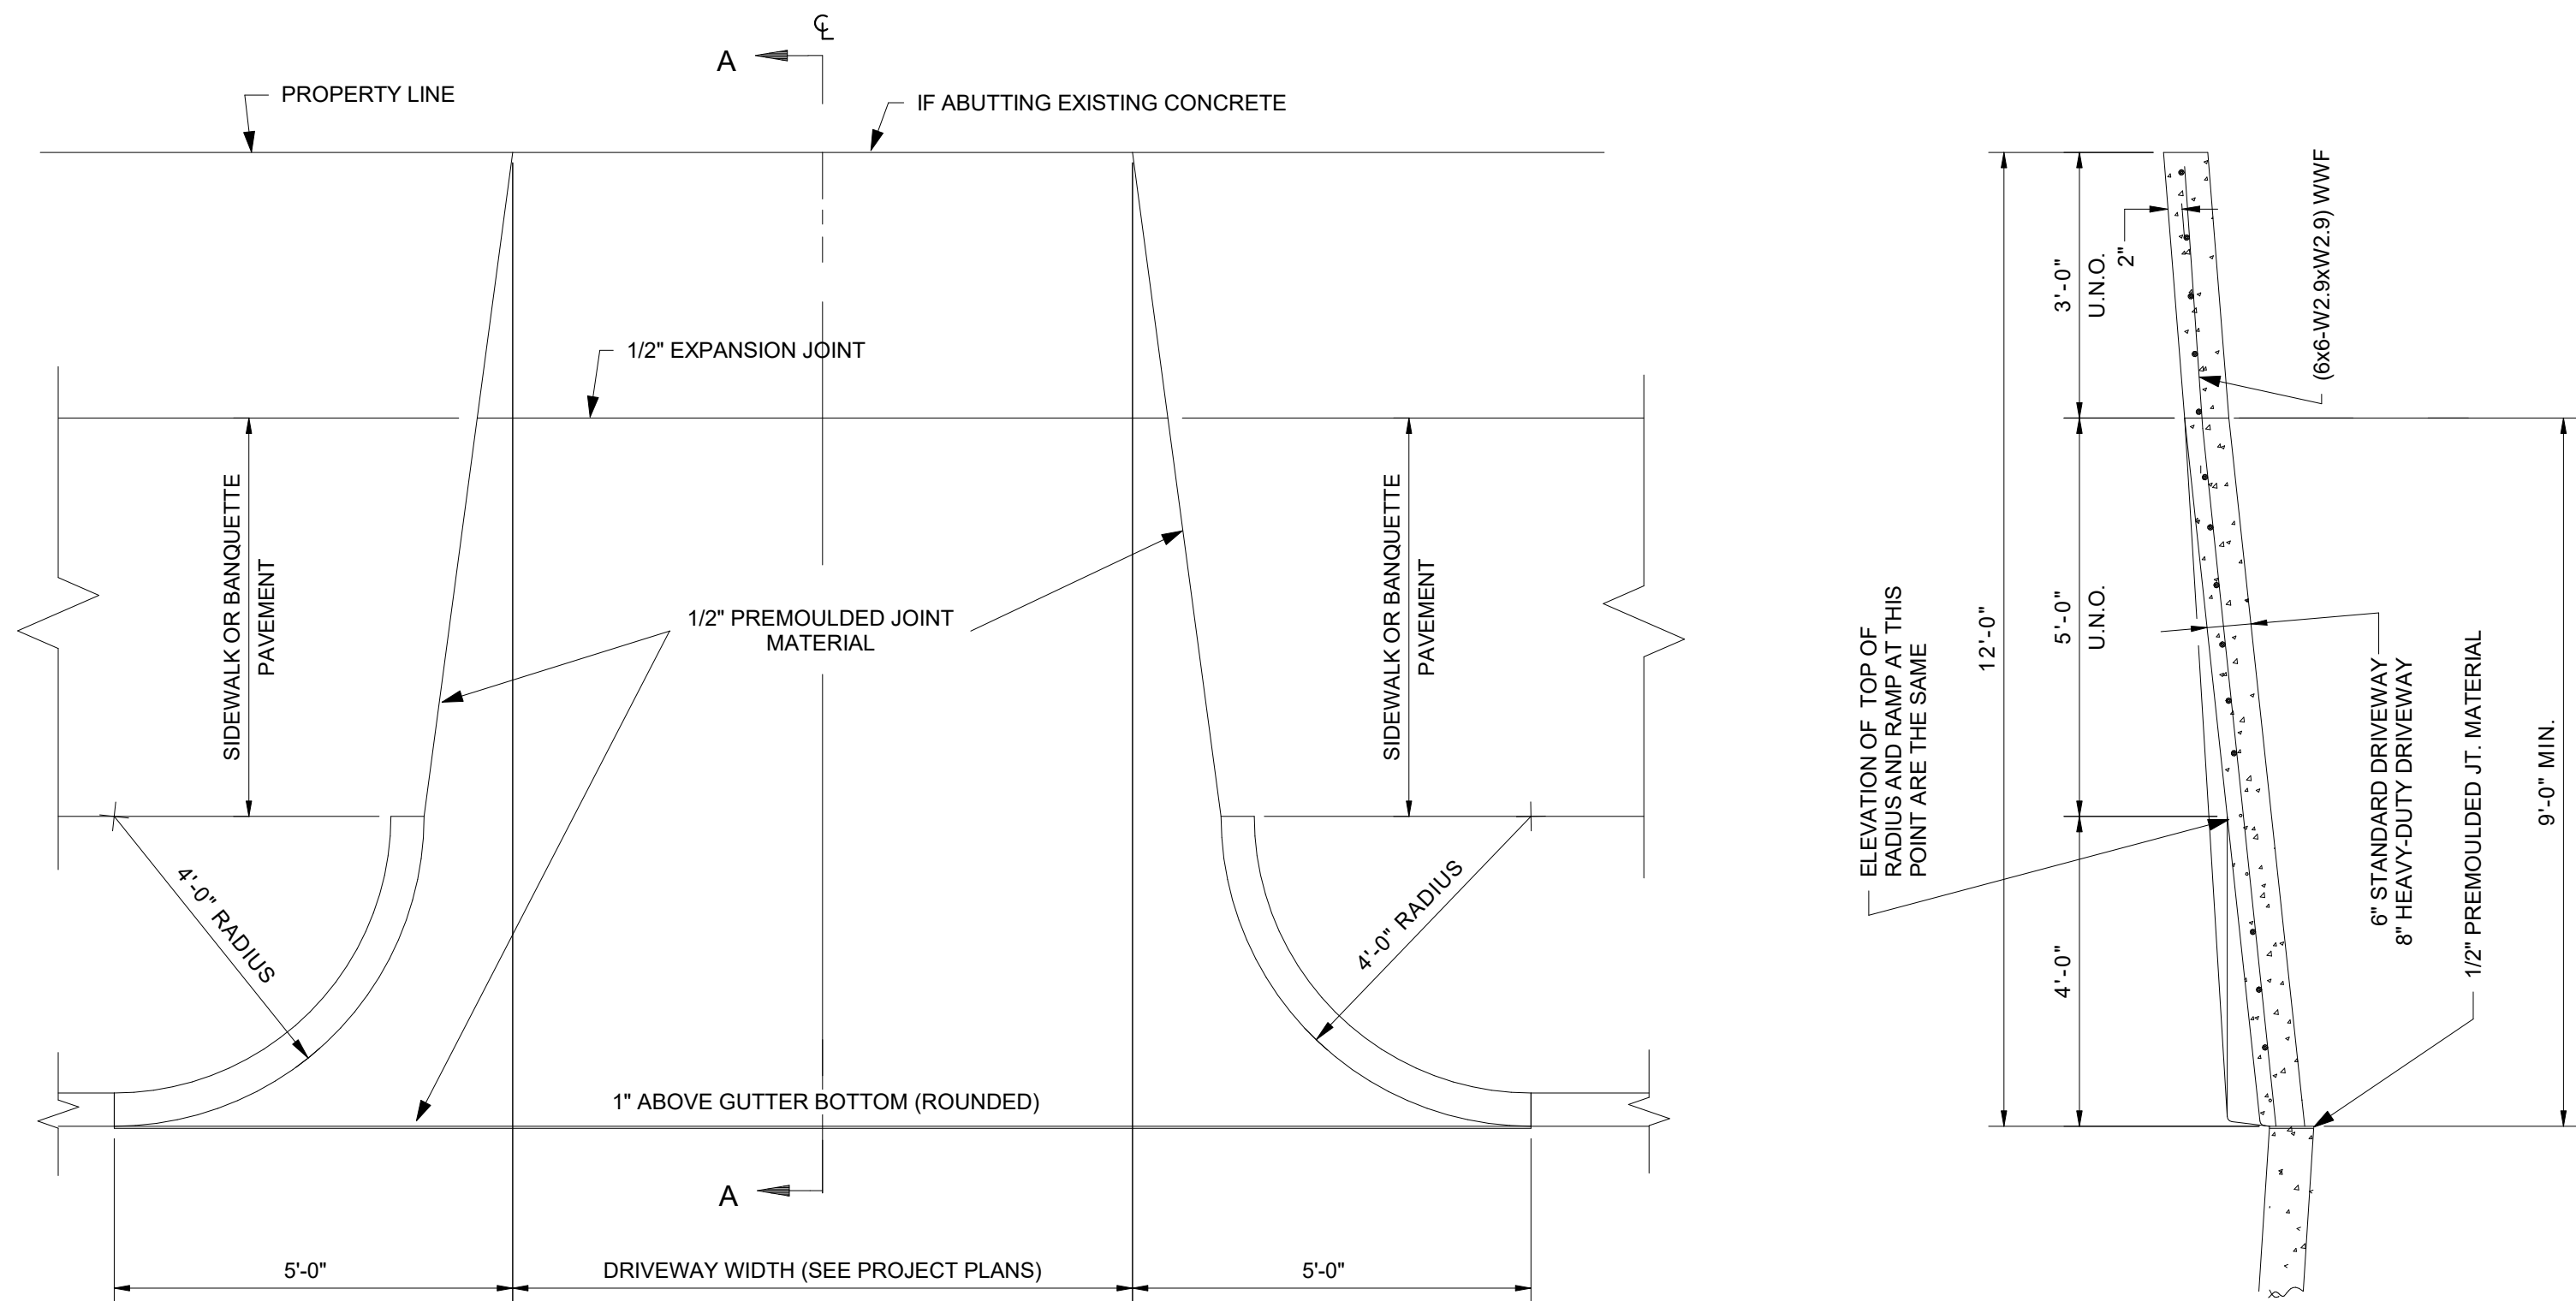
C201

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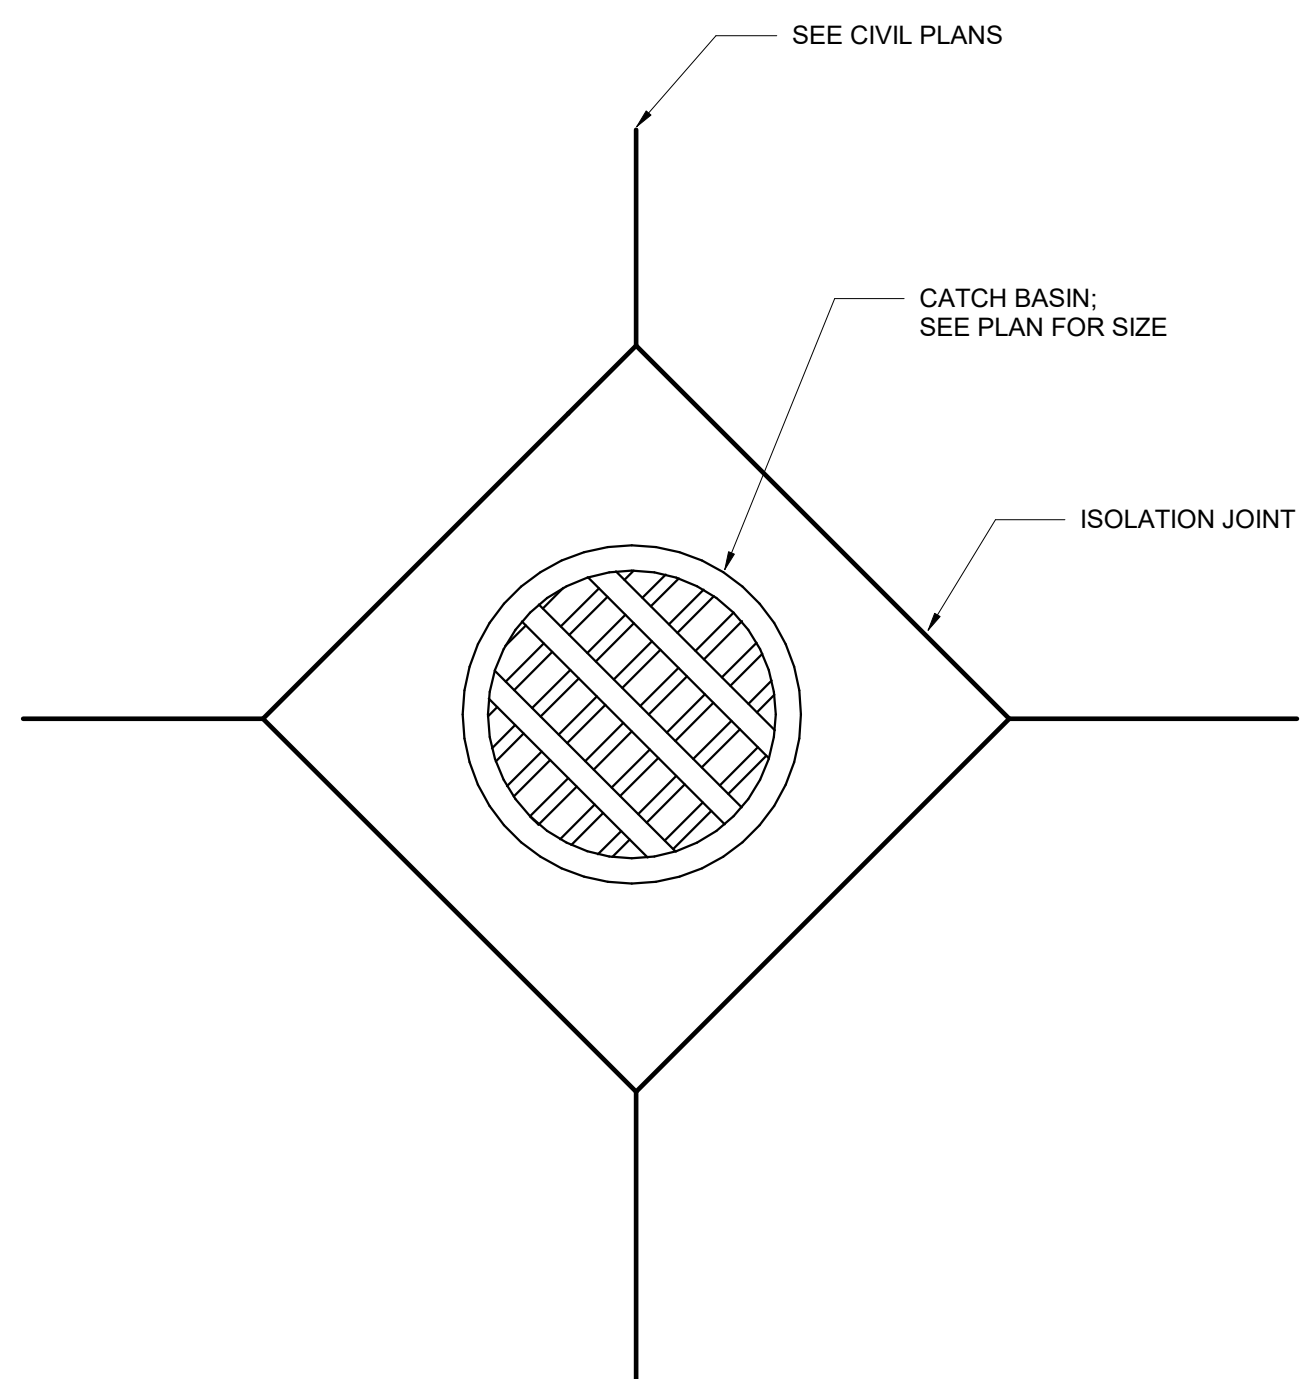
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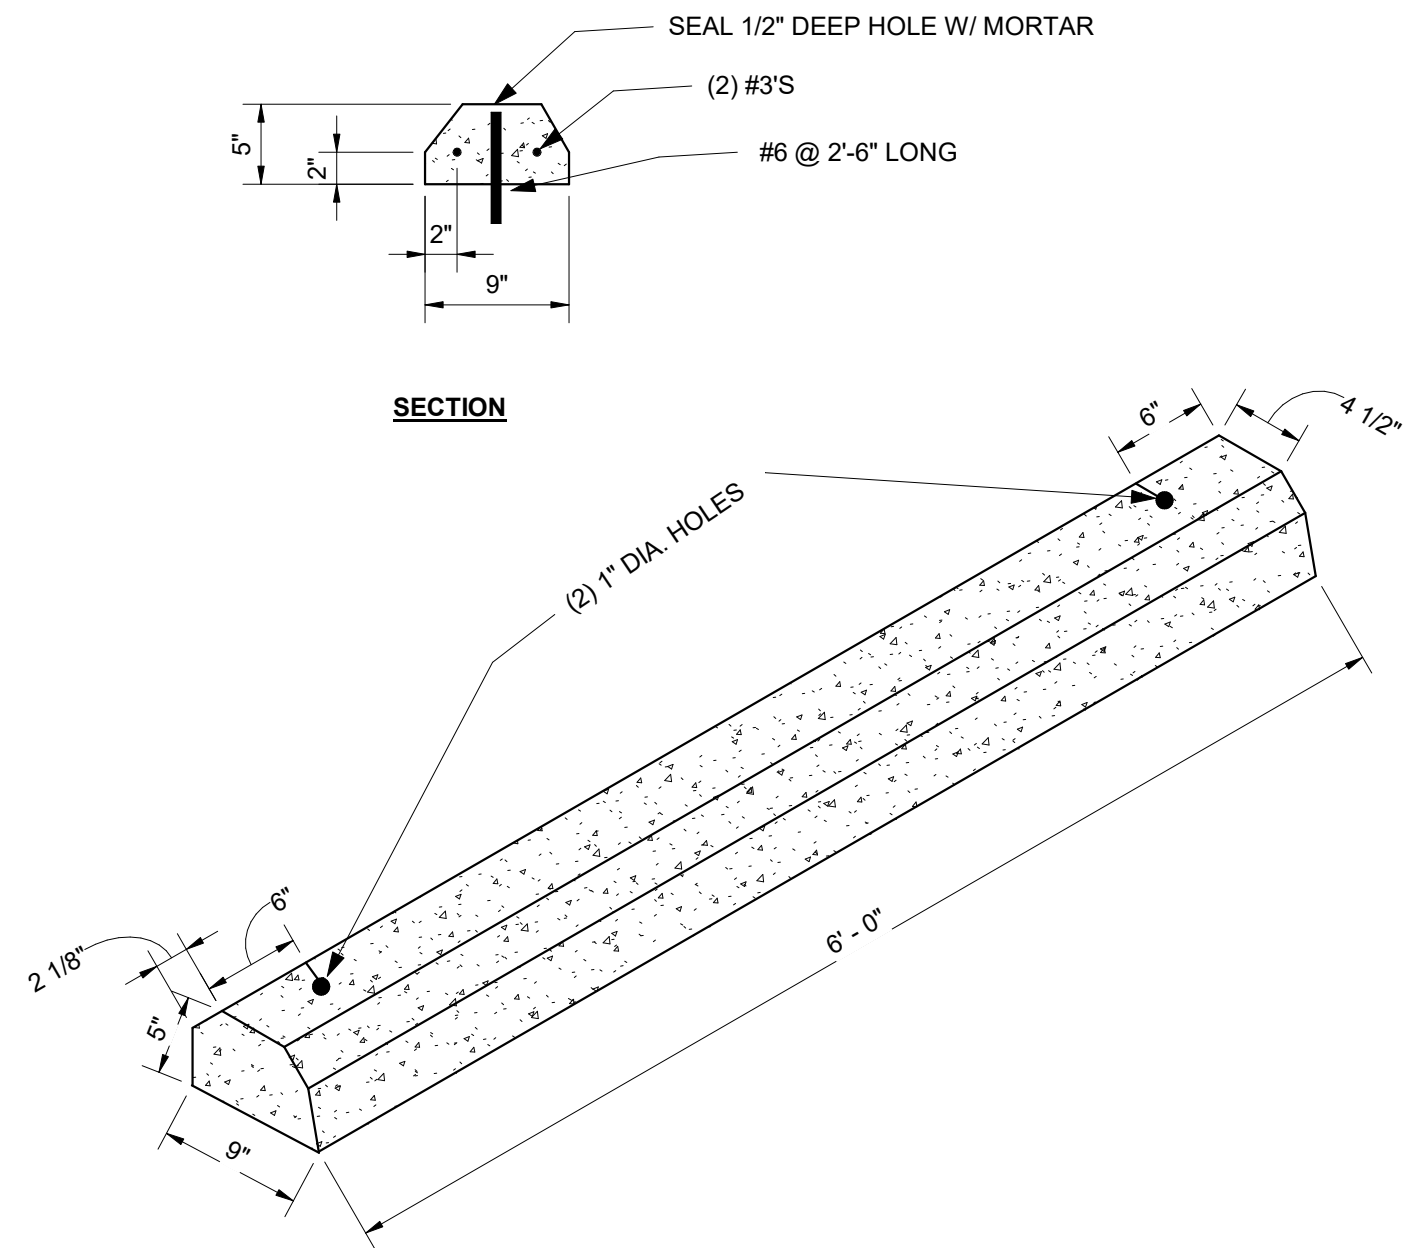


DETAIL OF STANDARD DRIVEWAY  
FOR CONCRETE VERTICAL CURB


1 TYPICAL DETAIL  
C202 Civil Driveway Details




3 TYPICAL DETAIL  
C202 Grate Detail-Top View



4 Wheel Stop Typical Detail  
C202 1" = 1'-0"

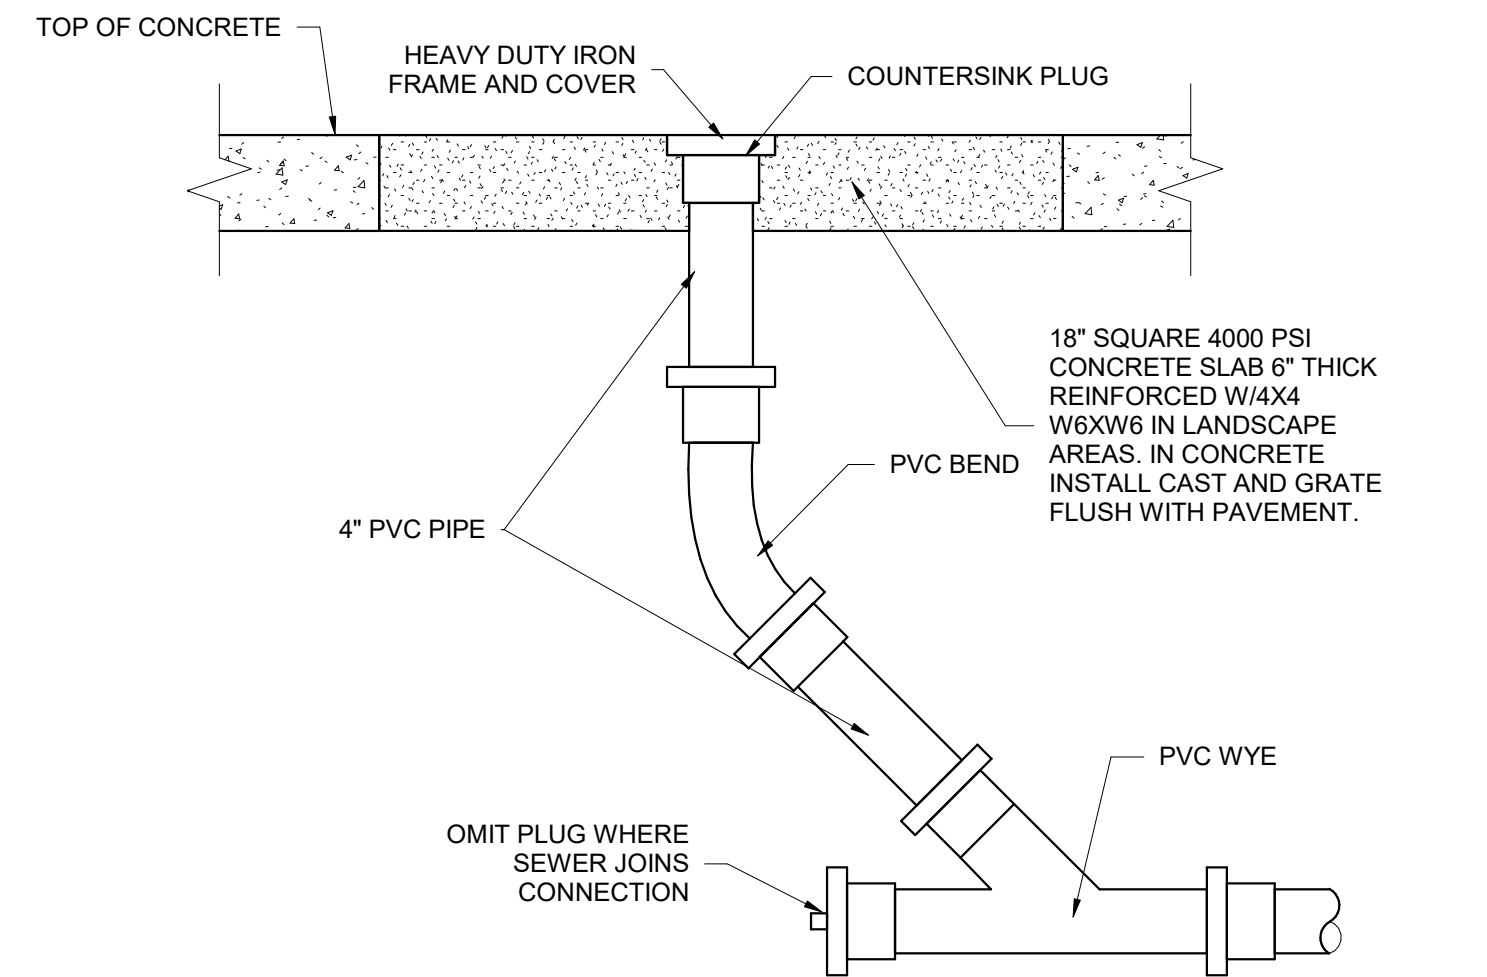

2 TYPICAL DETAIL  
C202 Clean Out Detail

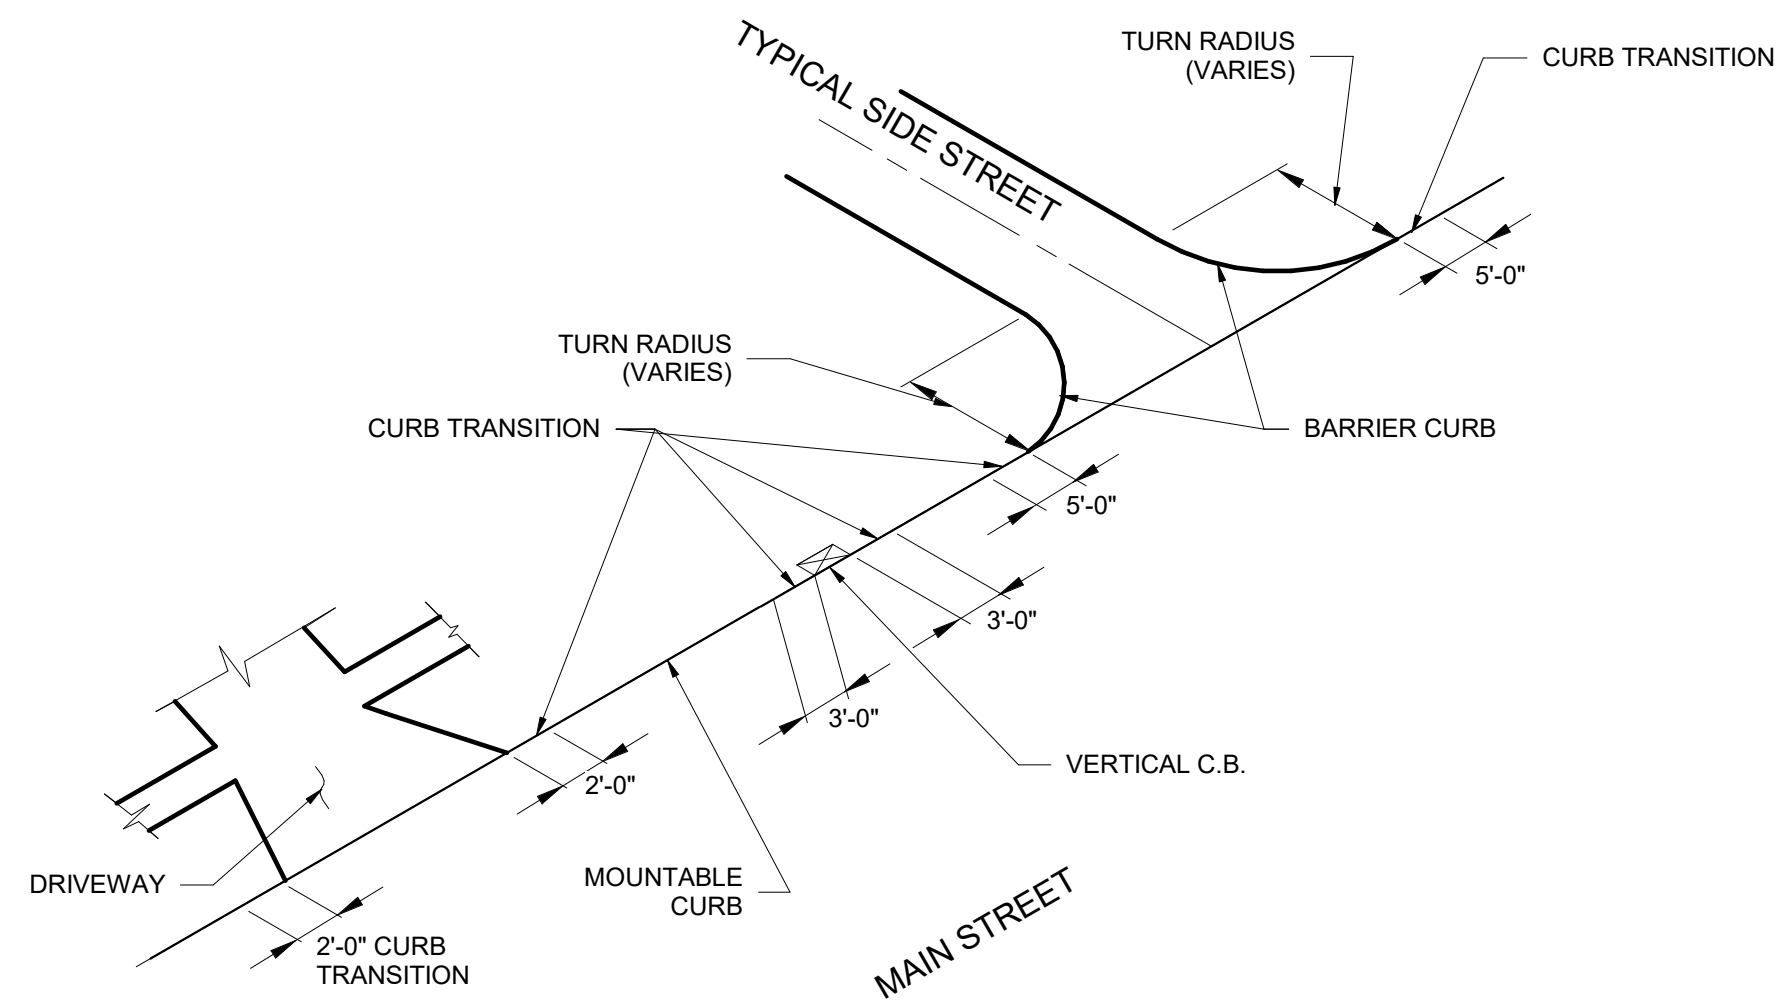

5 Typical Curb Cutout-Locations of Curb Transition  
C202 1 1/2" = 1'-0"



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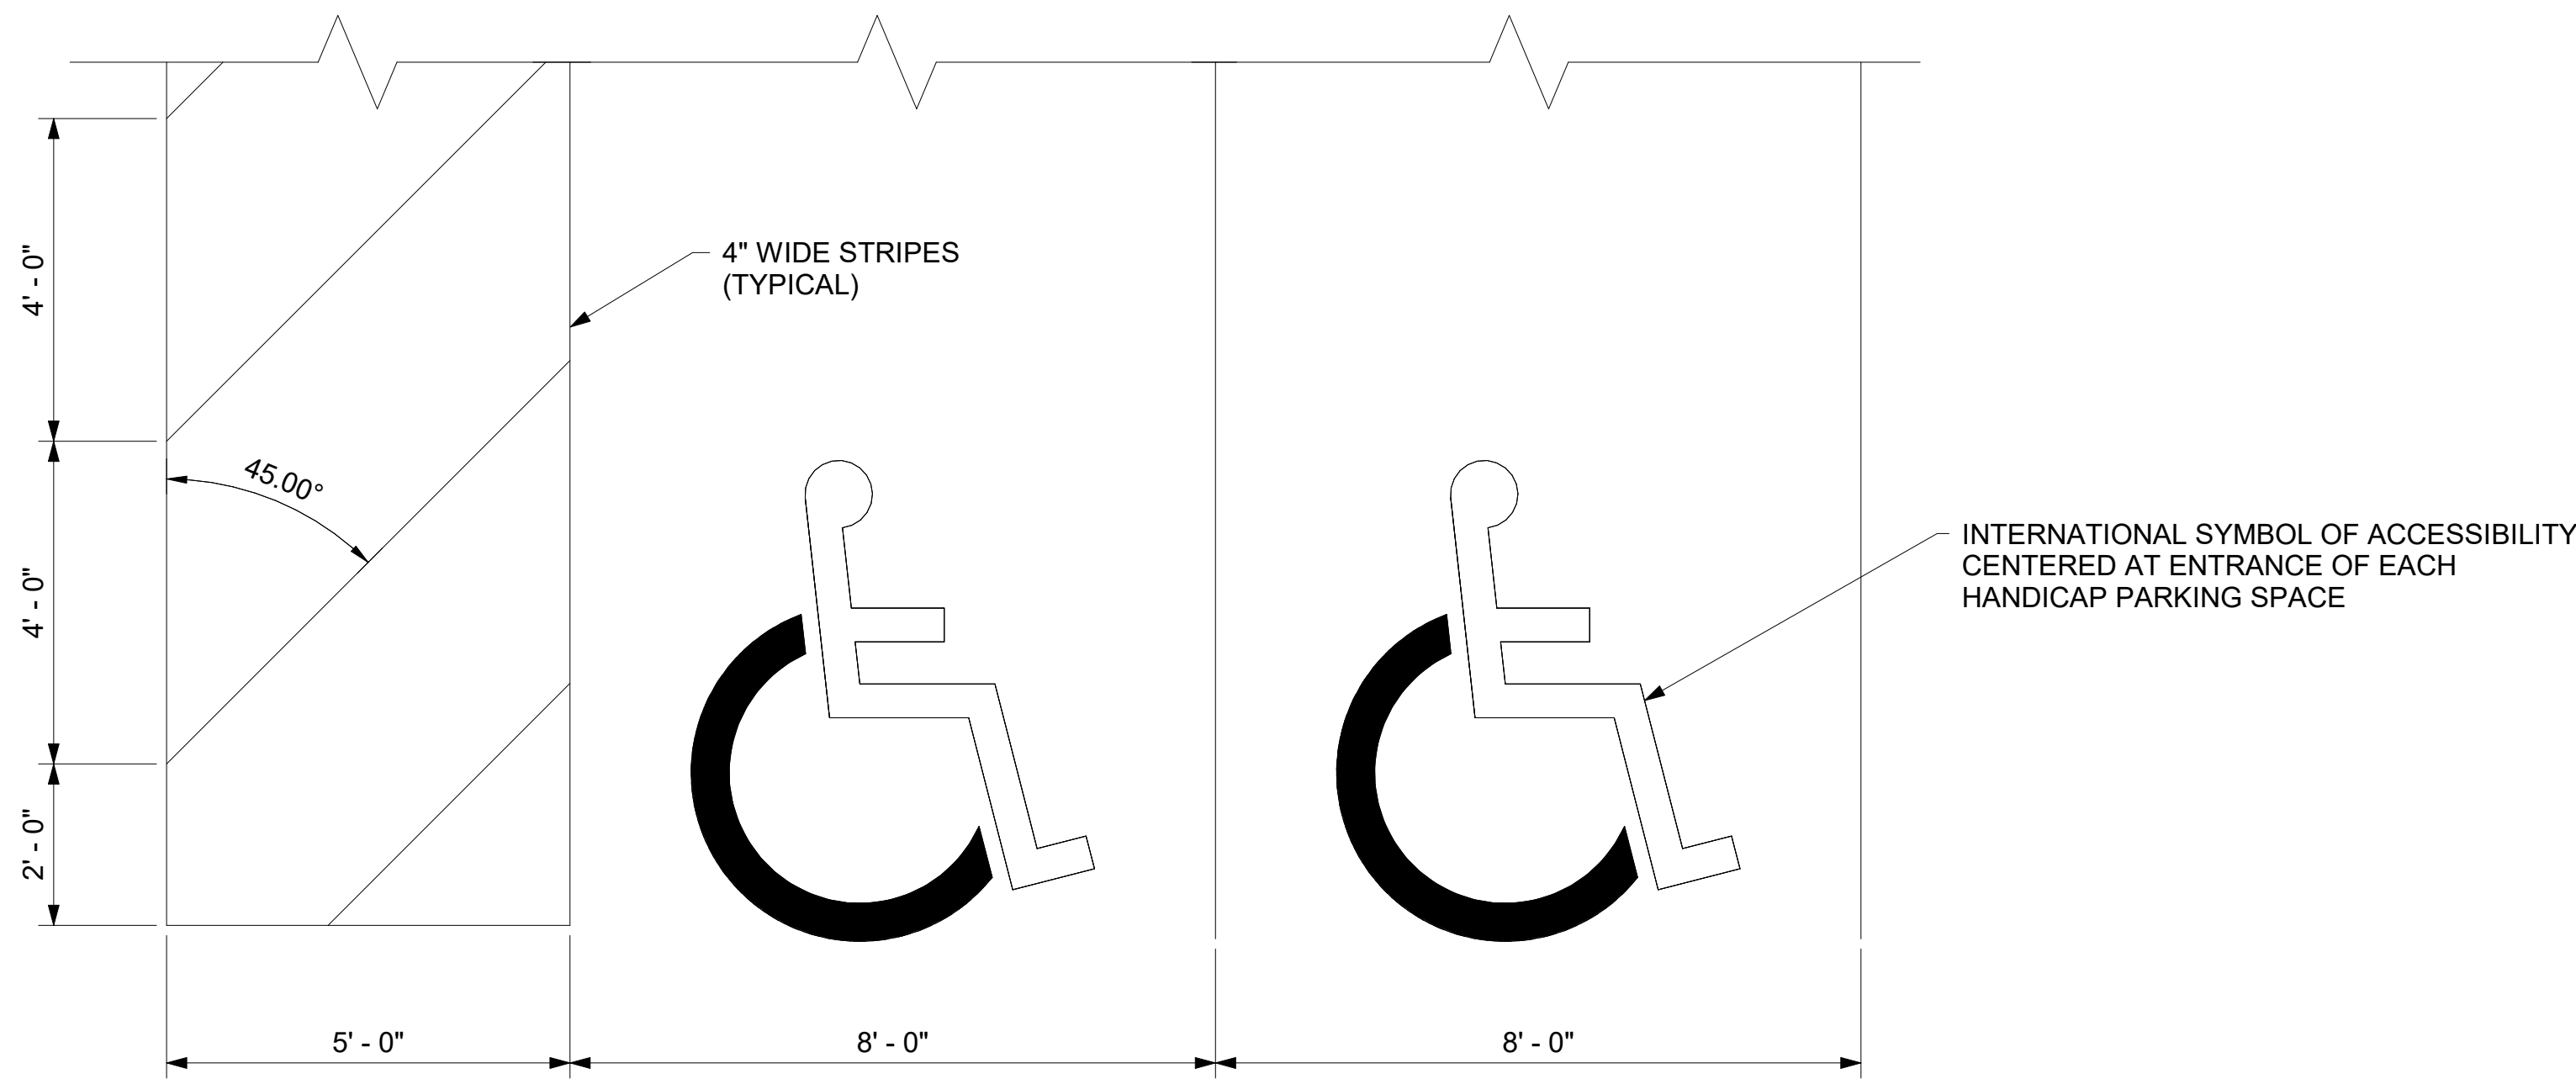
Civil Details 2 TITLE

As indicated SCALE

LDS /JP DRAWN/CHK

C202


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NOTE:  
ALL DIMENSIONS ARE FROM CENTER TO CENTER OF STRIPING.


## 1 TYPICAL DETAIL

C203 Civil HC Striping



## 3 TYPICAL DETAIL

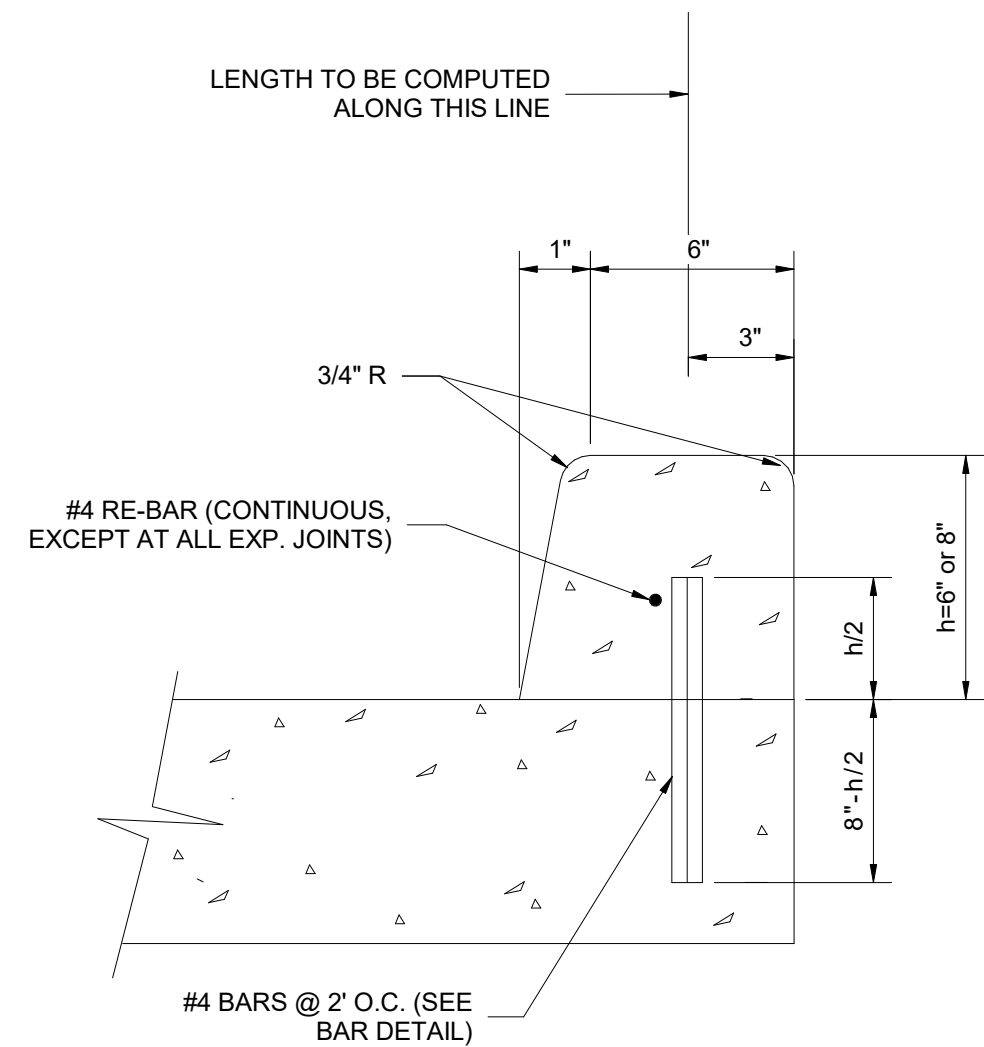
C203 Typical Curb Cutout-Doweled Barrier Curb

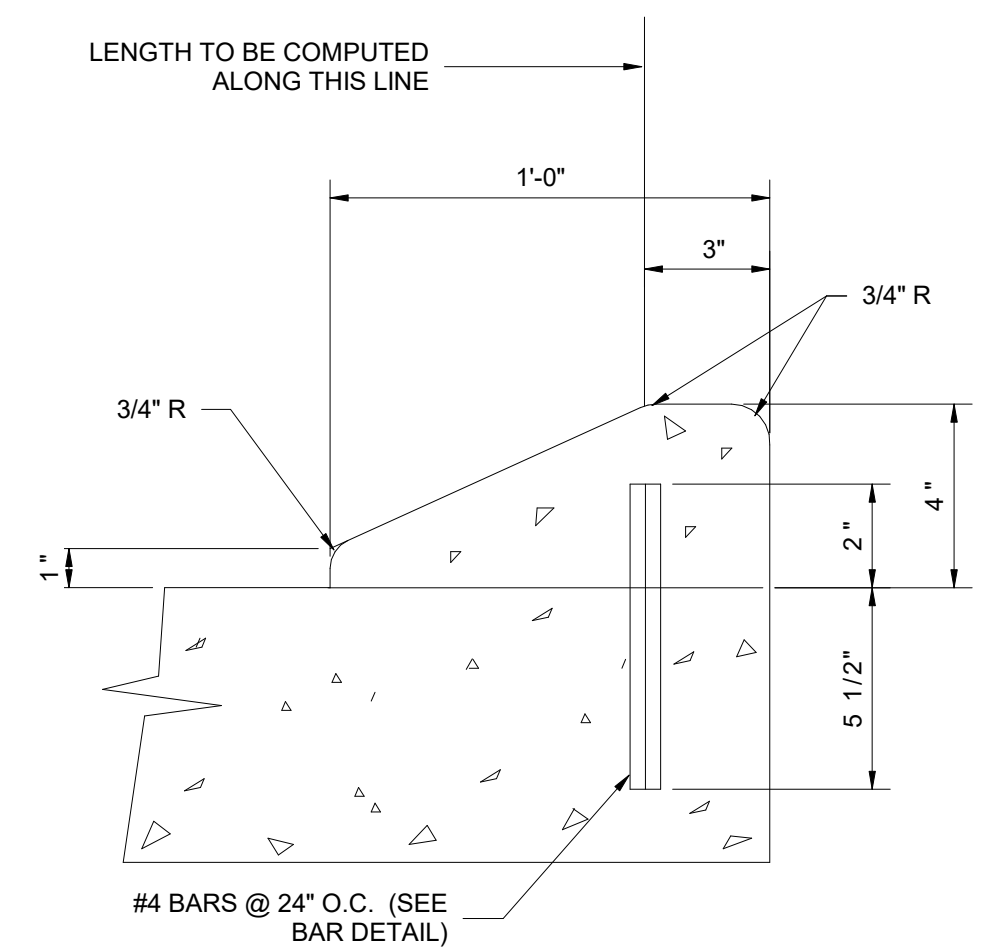

DETAILS MM


## 6 Typical Curb Cutout-Integral Mountable Curb

C203 1 1/2" = 1'-0"

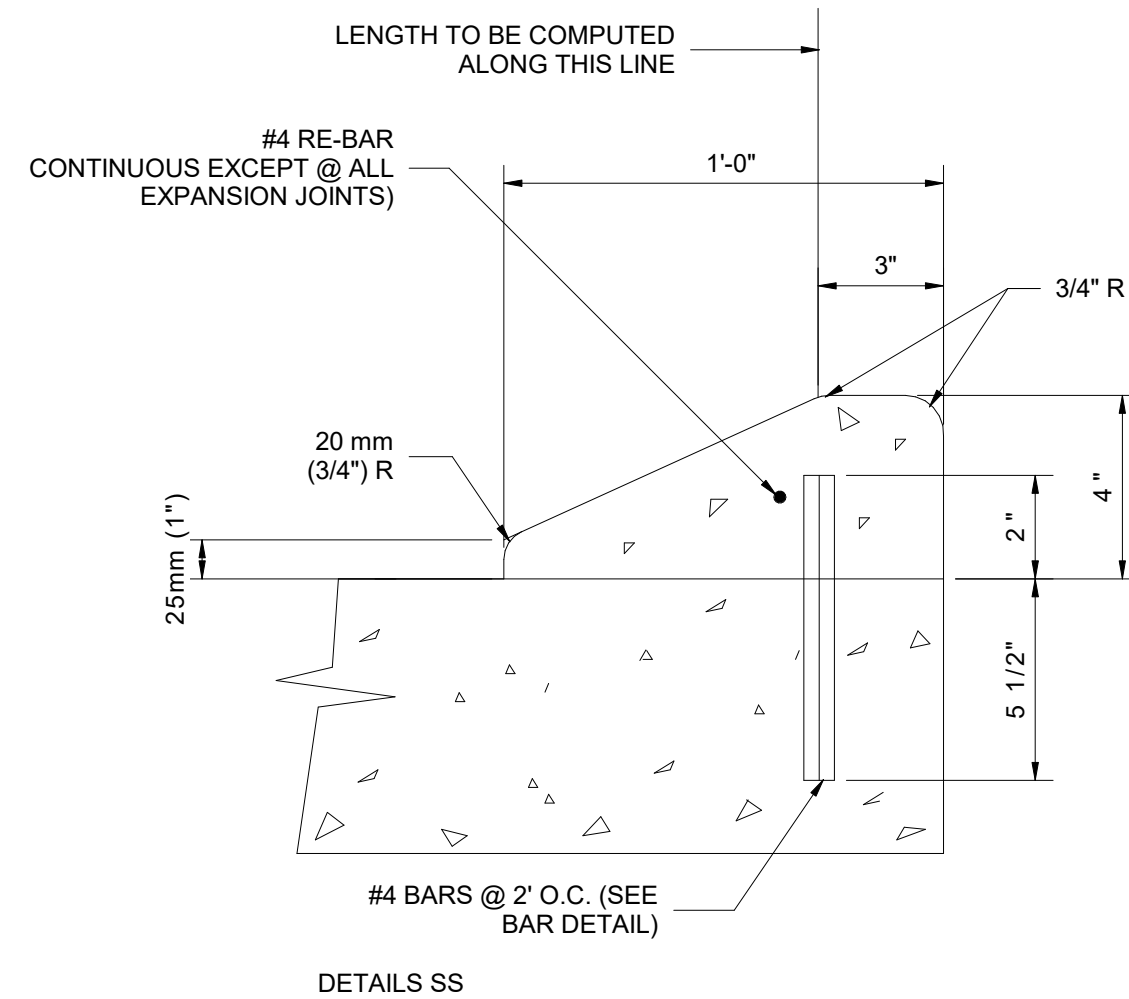


## 4 TYPICAL DETAIL

C203 Typical Curb Cutout-Doweled Mountable Curb

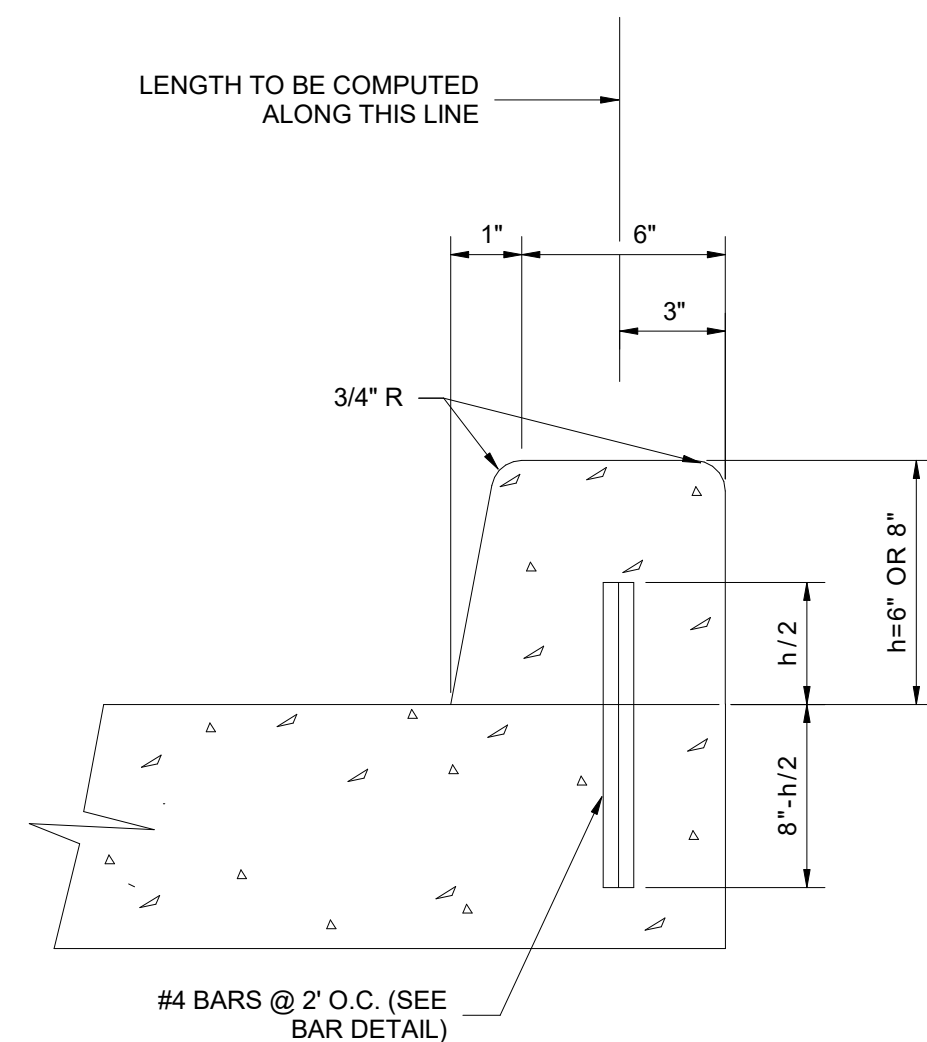

## 7 Typical Curb Cutout-Integral Barrier Curb

C203 1 1/2" = 1'-0"

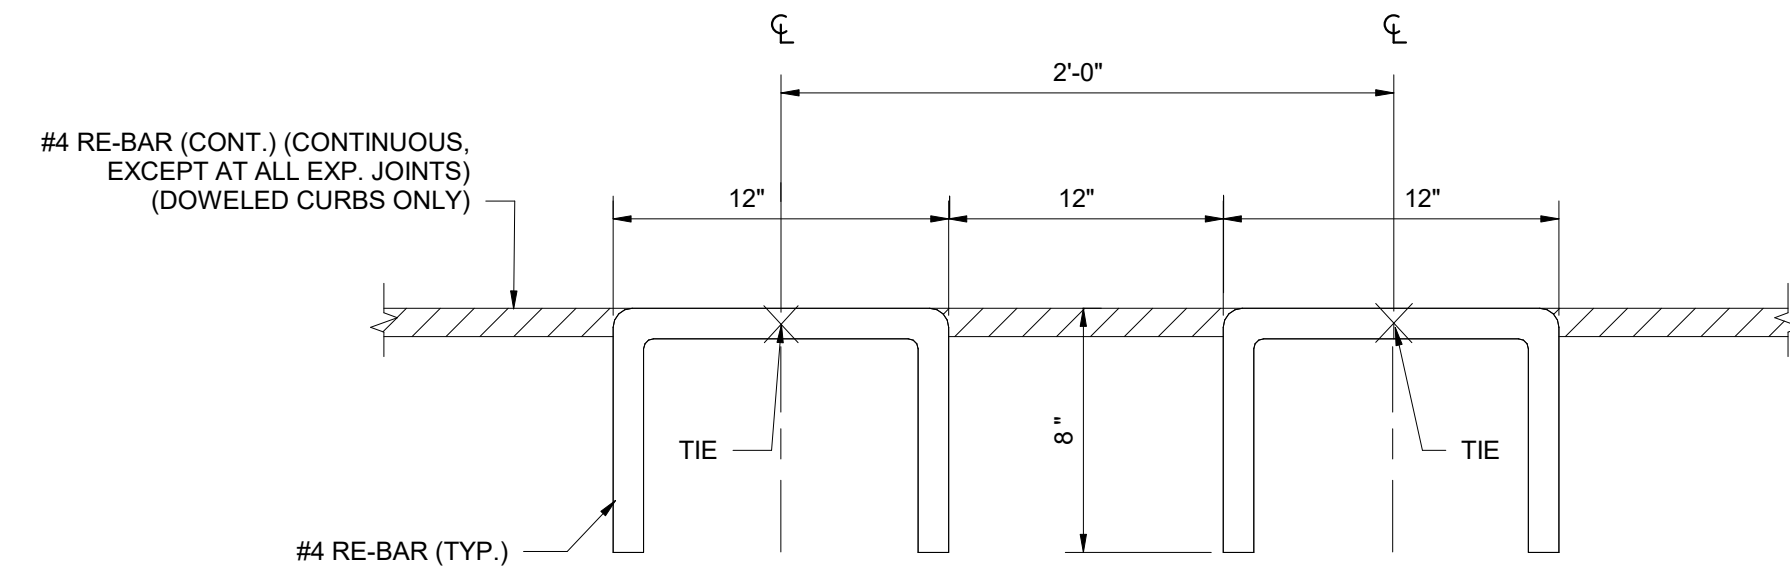



SHOWING DIMENSIONS AND SPACING OF #4 DEF. REINF. STEEL BARS FOR CONC. CURB

NOTE:


CURBS TO HAVE JOINTS AT 20' MAXIMUM INTERVALS

## 2 TYPICAL DETAIL

C203 Typical Curb Cutout-Bar Detail

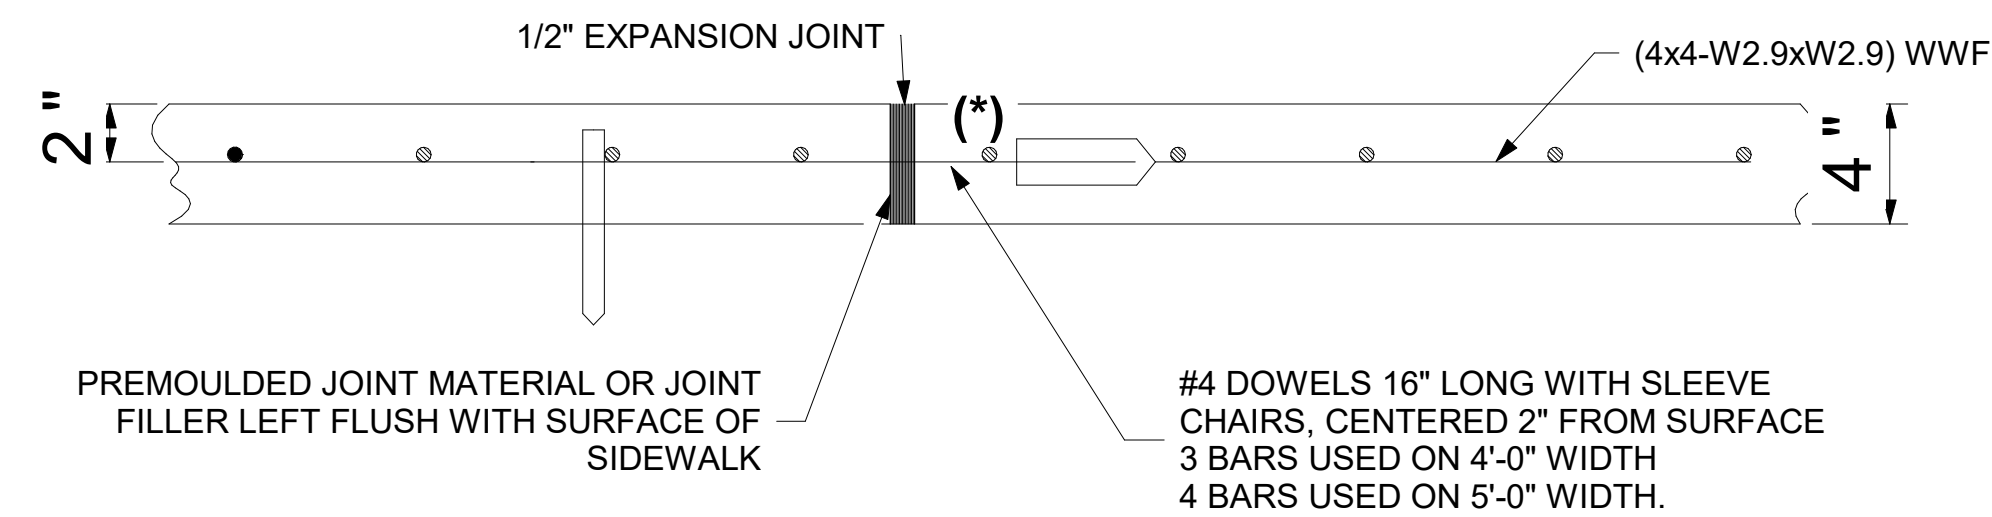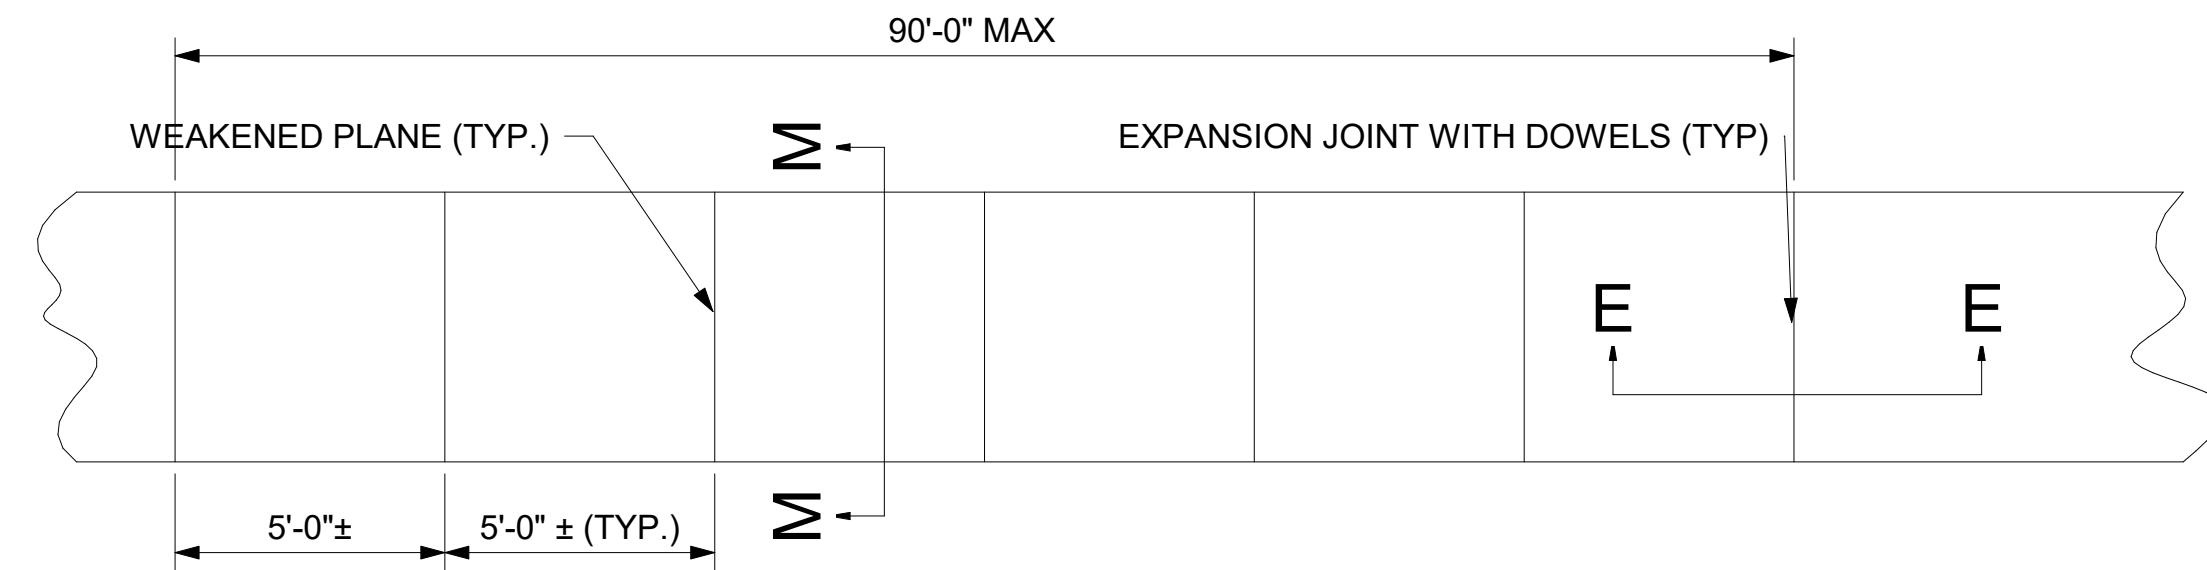

## SECTION E-E

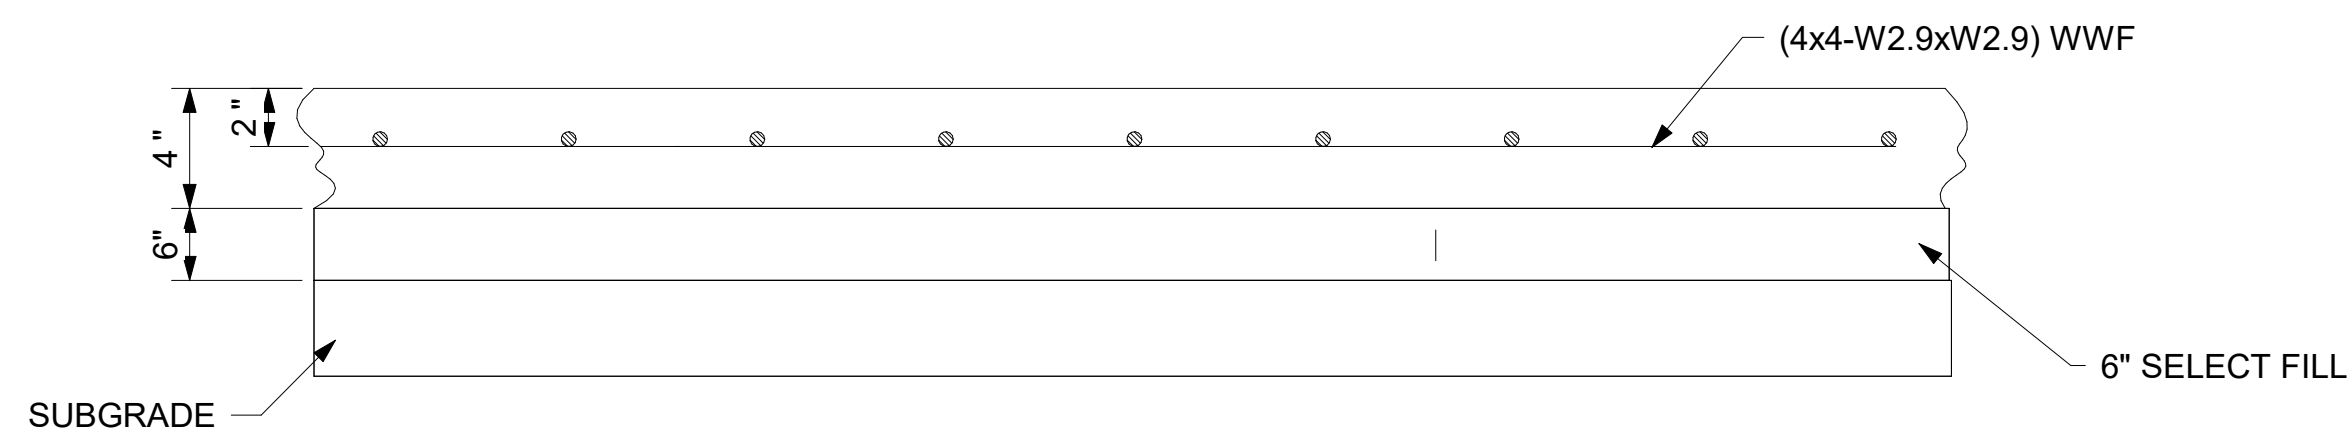

## SECTION M-M

## 5 Civil Sidewalk

C203 3/4" = 1'-0"



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New Orleans, LA 70130

20070 JOB NO

Civil Details 3 TITLE


As indicated SCALE

LDS /JP DRAWN/CHK

C203

**PACE**  
GROUP LLC  
CONSULTANTS AND ENGINEERS  
400 S Norman C. Francis Pkwy,  
New Orleans, LA 70119  
(504) 208 3834  
www.pacegroupllc.com




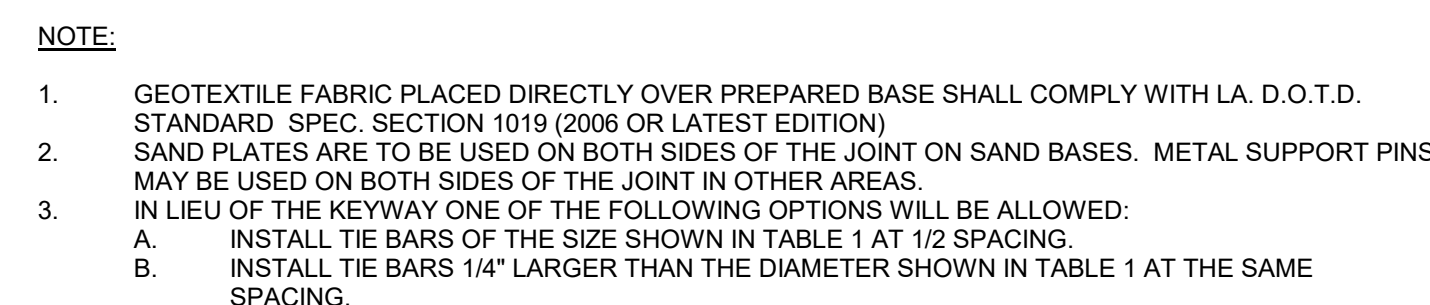

2	TYPICAL DETAIL
C204	Typical Transverse Expansion Joint for Pavement (Type EJ)




C204	Typical Longitudinal Construction Joint for Pavement (Type LCJ)
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C204	Typical Transverse Butt Joint for Pavement (Type BJ)
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C204	1" = 1'-0"
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NO	REVISION	DATE
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Permit Set	9/28/202
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Restoration and Renovation of:

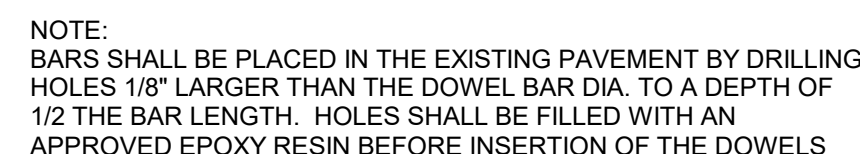747 St. Charles Ave.  
New Orleans, LA 70130

20070 JOB M

Civil Details 4 TIT

As indicated	SCA
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LDS /JP DBAWN/CH

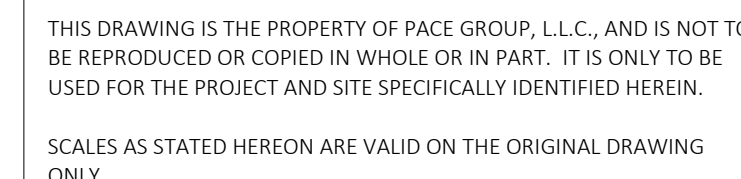C204

**PACE**  
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**400 S Norman C. Francis Pkwy,  
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## R-TANK SUBSURFACE STORAGE SYSTEM



### PROJECT INFORMATION


Project Name	TBD
City/County	New Orleans
State	LA
Site Designation	Underground Detention

### SUBSURFACE STORAGE REQUIREMENTS

Storage Volume Required	1,350 cf	ENTER VALUE
R-Tank System Width	15.00 ft	ENTER VALUE
Use Stone Storage Volume	YES	SELECT FROM LIST
Stone Void Ratio	40%	ENTER VALUE
Dead Storage Required	NO	SELECT FROM LIST

### R-TANK DESIGN

R-Tank Selected	UD SINGLE	SELECT FROM LIST
Width of R-Tank	23.62 in	
Length of R-Tank	23.62 in	
Height of R-Tank	14.17 in	
Volume of Storage per Module	4.35 cf	
Number of R-Tanks Wide	7	
Number of R-Tanks Long	25	
Number of Rotated End R-Tanks	0	
Total Number of R-Tank Modules	175	
R-Tank System Width	13.78 ft	
R-Tank System Length	49.21 ft	
Backfill Perimeter Width (2ft typ)		
Sides	2.00 ft	ENTER VALUE
Ends	2.00 ft	ENTER VALUE
R-Tank System Excavation Width	17.78 ft	
R-Tank System Excavation Length	53.21 ft	
Effective Footprint of System (Excavation)	945.96 sq.ft.	
Base Thickness	3 in	ENTER VALUE
Use Base for Storage	YES	
Cover Thickness	12 in	ENTER VALUE
Use Cover for Storage	YES	
Storage Volume Provided in R-Tank only	761 cf	
Storage Volume Provided in Backfill (40% Voids)	599 cf	
<b>Total System Storage Volume</b>	<b>1,360 cf</b>	
Volume of Backfill Required	56 cy	

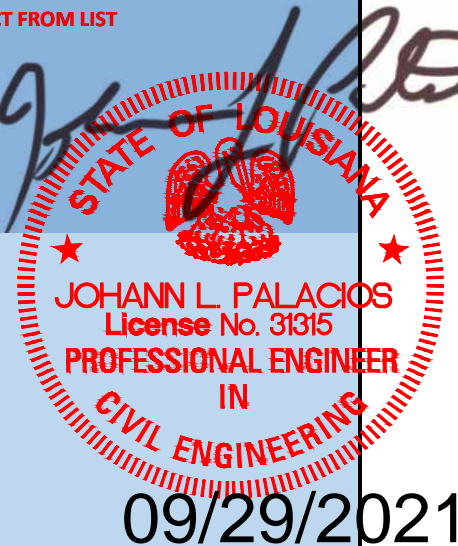



GENERAL


- ALL WORK SHALL BE PERFORMED IN ACCORDANCE WITH THE LATEST EDITION OF:
  - AMERICAN CONCRETE INSTITUTE (ACI) LATEST EDITION
  - AMERICAN INSTITUTE OF STEEL CONSTRUCTION (AISC) LATEST EDITION
  - AMERICAN SOCIETY OF CIVIL ENGINEERS STANDARDS (ASCE) LATEST EDITION
  - AMERICAN FOREST AND PAPER ASSOCIATION (NDS) LATEST EDITION
- DO NOT SCALE CONTRACT DRAWINGS FOR THE PURPOSE OF ESTABLISHING DIMENSIONS.
- THE CONTRACTOR SHALL BE RESPONSIBLE FOR ALL FINAL DIMENSIONS AND FIT-UP OF THE STRUCTURE, INCLUDING VERIFYING ALL EXISTING CONDITIONS AND DIMENSIONS BEFORE COMMENCING WORK OR FABRICATING MATERIALS.
- THE CONTRACTOR SHALL VERIFY THE LOCATION OF ALL EXISTING UTILITIES BEFORE COMMENCING ANY WORK. ANY INTERFERENCE SHALL BE BROUGHT TO THE ATTENTION OF THE STRUCTURAL ENGINEER.
- CHECK ALL DIMENSIONS ON STRUCTURAL DRAWINGS AGAINST ARCHITECTURAL DRAWINGS.
- COORDINATE WITH THE ARCHITECTURAL, MECHANICAL, PLUMBING, ELECTRICAL, AND CIVIL DRAWINGS AND VERIFY THE EXACT LOCATION OF ALL INSERTS, OPENINGS, SLEEVES, FINISHES, DEPRESSIONS, SLOPES, PADS AND OTHER PROJECT REQUIREMENTS BEFORE COMMENCING ANY WORK. ANY DISCREPANCIES SHALL BE BROUGHT TO THE ATTENTION OF THE STRUCTURAL ENGINEER.
- CONCRETE TRUCKS, CRANES, FORKLIFTS, OR ANY VEHICLE WITH A WHEEL LOAD GREATER THAN 2,000 POUNDS SHALL NOT BE PERMITTED ON THE STRUCTURAL SLAB.
- CONSTRUCTION MATERIALS SHALL BE DISTRIBUTED SUCH THAT THE LOAD SHALL NOT EXCEED THE DESIGNED LIVE LOAD PER SQUARE FOOT.
- THE CONTRACTOR SHALL BE RESPONSIBLE FOR THE DESIGN, PLACEMENT, MAINTENANCE, ETC. OF ANY AND ALL SHORING, BRACING, TIE BACKS, ETC. NEEDED TO SUPPORT ANY PART OF THE NEW OR EXISTING CONSTRUCTION DURING THE ENTIRE CONSTRUCTION PROCESS TO ENSURE THE SAFETY AND INTEGRITY OF THE STRUCTURE UNTIL THE NECESSARY PERMANENT ELEMENTS ARE IN PLACE.
- DESIGN LOAD CRITERIA:

EARTHWORK

- THE CONTRACTOR SHALL BE RESPONSIBLE IN PERFORMING ALL EARTH WORK IN ACCORDANCE WITH SPECIFICATION 312000 EARTH WORK.
- THE CONTRACTOR SHALL ASSUME FULL RESPONSIBILITY FOR MAINTAINING THE STABILITY OF ALL EXCAVATED FACES IN COMPLIANCE WITH OSHA REQUIREMENTS UNTIL FINAL ACCEPTANCE OF WORK.
- ALL LIFTS SHALL BE HEAVILY PROOF-ROLLED WITH A MODERATELY HEAVY LOADED PNEUMATIC ROLLER. SOILS THAT ARE OBSERVED TO RUT OR DEFLECT EXCESSIVELY UNDER THE MOVING LOADS SHALL BE UNDERCUT AND REPLACED WITH PROPERLY COMPACTED FILL.
- BACK FILL: SHALL BE CLASSIFIED AS SC OR CL WITH A PLASTICITY INDEX BETWEEN 5 AND 25
- ALL FILL SHALL BE PLACED IN LIFTS NO GREATER THAT 6 INCHES AND COMPACTED TO 95% MODIFIED PROCTOR.
- EXCESS EXCAVATED MATERIAL AND/OR UNUSED BACK FILL MATERIALS SHALL BE REMOVED FROM SITE.
- WASHED SAND SHALL COMPLY WITH ASTM C33 FOR FINE AGGREGATE
- PILE CAPACITY = 5 TONS PER 35FT CLASS 5 TIMBER PILE PER NEW ORLEANS PILE CAPACITY MAPS

STRUCTURAL STEEL

- ALL STRUCTURAL STEEL HAS BEEN DESIGNED IN ACCORDANCE WITH THE AISC SPECIFICATION FOR STRUCTURAL STEEL BUILDINGS.
- UNLESS NOTED OTHERWISE ALL W STRUCTURAL STEEL SHAPES SHALL CONFORM TO ASTM A992 OR ASTM A572 GRADE 50. C AND S STRUCTURAL STEEL SHAPES, RODS, PLATES, AND ANGLES SHALL BE IN ACCORDANCE WITH ASTM A36.
- TUBE SECTIONS SHALL BE ASTM A-500 GRADE B (46 KSI YIELD).
- PIPE SECTIONS SHALL BE ASTM A53 TYPE S, GRADE B (35 KSI YIELD).
- SPLICES IN STRUCTURAL STEEL NOT SHOWN ON THE STRUCTURAL DRAWINGS WILL NOT BE ACCEPTED WITHOUT SPECIFIC APPROVAL OF THE STRUCTURAL ENGINEER.
- UNLESS NOTED OTHERWISE ALL CONNECTION BOLTS IN SINGLE PLATE CONNECTIONS SHALL BE 1" DIAMETER ASTM A325N (SEE SCHEDULE) AND ALL OTHER CONNECTION BOLTS SHALL BE 3/4" DIAMETER ASTM A325N.
- UNLESS NOTED OTHERWISE ALL ANCHOR BOLTS SHALL BE 3/4" DIAMETER ASTM A307. ALL ANCHOR BOLTS SHALL BE HEADED AT THE UNTHREADED END.
- UNLESS NOTED OTHERWISE EVERY WELD SHALL DEVELOP THE FULL STRENGTH OF THE LESSER OF THE MEMBERS IT JOINS. ALL BUTT, GROOVE, OR BEVEL WELDS SHALL BE COMPLETE, FULL PENETRATION.
- WHERE POSSIBLE, ALL BOLT HOLES IN STRUCTURAL STEEL SHALL BE DRILLED OR PUNCHED IN THE SHOP. ANY HOLES REQUIRED TO BE MADE AT THE PROJECT SITE SHALL BE MECHANICALLY DRILLED OR PUNCHED. NO BURNING OF HOLES SHALL BE ALLOWED.
- UNLESS SHOWN OTHERWISE ALL CAP AND BASE PLATES SHALL BE WELDED TO THE COLUMNS CONTINUOUSLY ALL AROUND WITH A 1/4" FILLET WELD.
- EXPANSION ANCHORS SHALL BE INSTALLED IN ACCORDANCE WITH THE MANUFACTURER'S INSTRUCTIONS AND SHALL HAVE A MINIMUM EMBEDMENT AS DETAILED.

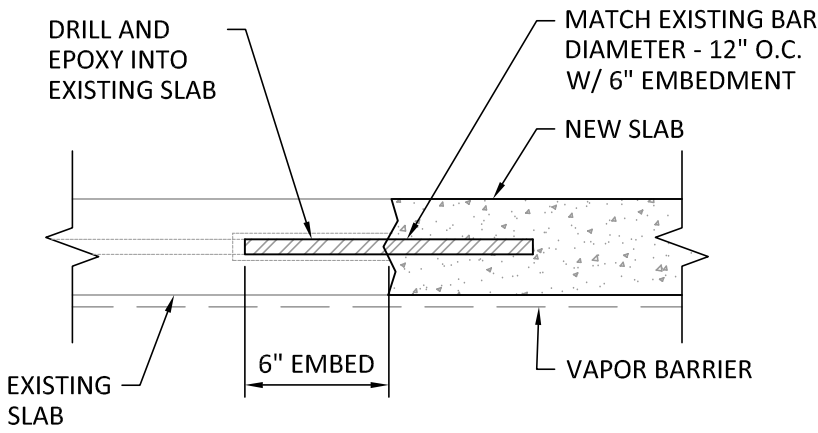

CONCRETE REPAIR DETAIL

CAST-IN-PLACE CONCRETE (NON-PRESTRESSED)

- STRUCTURAL CONCRETE HAS BEEN DESIGNED IN ACCORDANCE WITH THE "BUILDING CODE REQUIREMENTS FOR STRUCTURAL CONCRETE", ACI 318 LATEST EDITION.
- WORK SHALL CONFORM TO ALL REQUIREMENTS OF ACI 301-LATEST EDITION, "SPECIFICATIONS FOR STRUCTURAL CONCRETE", PUBLISHED BY THE AMERICAN CONCRETE INSTITUTE, FARMINGTON HILLS, MICHIGAN, EXCEPT AS MODIFIED BY THE REQUIREMENTS OF THESE CONTRACT DOCUMENTS.
- TOLERANCES FOR CONCRETE CONSTRUCTION AND MATERIALS SHALL CONFORM TO ALL REQUIREMENTS OF ACI 117-LATEST EDITION, "SPECIFICATIONS FOR TOLERANCES FOR CONCRETE CONSTRUCTION AND MATERIALS", PUBLISHED BY THE AMERICAN CONCRETE INSTITUTE, FARMINGTON HILLS, MICHIGAN, EXCEPT AS MODIFIED BY THE REQUIREMENTS OF THESE CONTRACT DOCUMENTS.
- WORK SHALL CONFORM TO ALL REQUIREMENTS OF ACI 305.1-LATEST EDITION, "SPECIFICATIONS FOR HOT WEATHER CONCRETING", PUBLISHED BY THE AMERICAN CONCRETE INSTITUTE, FARMINGTON HILLS, MICHIGAN, EXCEPT AS MODIFIED BY THE REQUIREMENTS OF THESE CONTRACT DOCUMENTS.
- ALL CONCRETE SHALL BE NORMAL WEIGHT CONCRETE, UNIT WEIGHT APPROXIMATELY 145 PCF, UNLESS OTHERWISE NOTED. CLEARLY IDENTIFY INTENDED USE FOR EACH MIX DESIGN SUBMITTED FOR APPROVAL.
- CONCRETE SHALL CONFORM TO THE FOLLOWING:

- W/C RATIO  
A. FOUNDATION, SLABS 3,600 PSI @ 28 DAYS (NORMAL WEIGHT) 0.45
- ALL CONCRETE IN CONTACT WITH SOILS SHALL USE TYPE I-II CEMENT.
- MIXING WATER SHALL BE POTABLE. THE USE OF WASH WATER AS A PORTION OF THE MIXING WATER SHALL NOT BE PERMITTED.
- CLEAN ALL CONSTRUCTION JOINTS THOROUGHLY AND PURPOSELY ROUGHEN THE SURFACE TO 1/4" AMPLITUDE USING A ROTARY HAMMER PRIOR TO PLACING ADJACENT CONCRETE.
- SLABS AND GRADE BEAMS SHALL NOT HAVE JOINTS IN A HORIZONTAL PLANE. ANY STOP IN CONCRETE WORK MUST BE MADE AT CENTER OF SPAN OR AT CENTER OF SUPPORT WITH VERTICAL BULKHEADS AND HORIZONTAL KEYS, UNLESS OTHERWISE SHOWN. ALL CONSTRUCTION JOINTS SHALL BE AS APPROVED BY THE ENGINEER.
- PLACEMENT OF SLEEVES OR OPENINGS THROUGH GRADE BEAMS IS NOT PERMITTED UNLESS INDICATED ON STRUCTURAL DRAWINGS OR APPROVED, IN WRITING, BY ENGINEER.
- CAREFULLY COORDINATE THE PLACEMENT OF ALL CAST-IN-PLACE EMBEDDED ITEMS AND ANCHOR RODS. ANCHOR RODS SHALL BE SET WITH A TEMPLATE. ALL EMBEDDED ITEMS SHALL BE SECURELY ATTACHED TO FORM WORK OR REINFORCING.
- PLACE .010 INCH VAPOR BARRIER BENEATH ALL INTERIOR SLABS AND BEAMS. LAP 12" MIN. TO ACCOMMODATE CONCRETE POURING DIRECTION. SEAL ALL SEAMS AND PENETRATIONS, INCLUDING PILES PER MANUFACTURER'S DIRECTIONS.

STEEL LINTEL SCHEDULE


CLEAR OPENING	SIZE ANGLE
UP TO 5'-0"	3-1/2"x3"x1/4"
5'-1" TO 7'-0"	3-1/2"x3-1/2"x1/4"
7'-1" TO 9'-0"	5"x3"x1/4"
9'-1" TO 10'-0"	5"x3"x5/16"
10'-1" TO 11'-0"	5"x3"x3/8"
11'-1" TO 12'-0"	6"x3"x3/8"
12'-1" AND OVER	ANALYSIS REQUIRED

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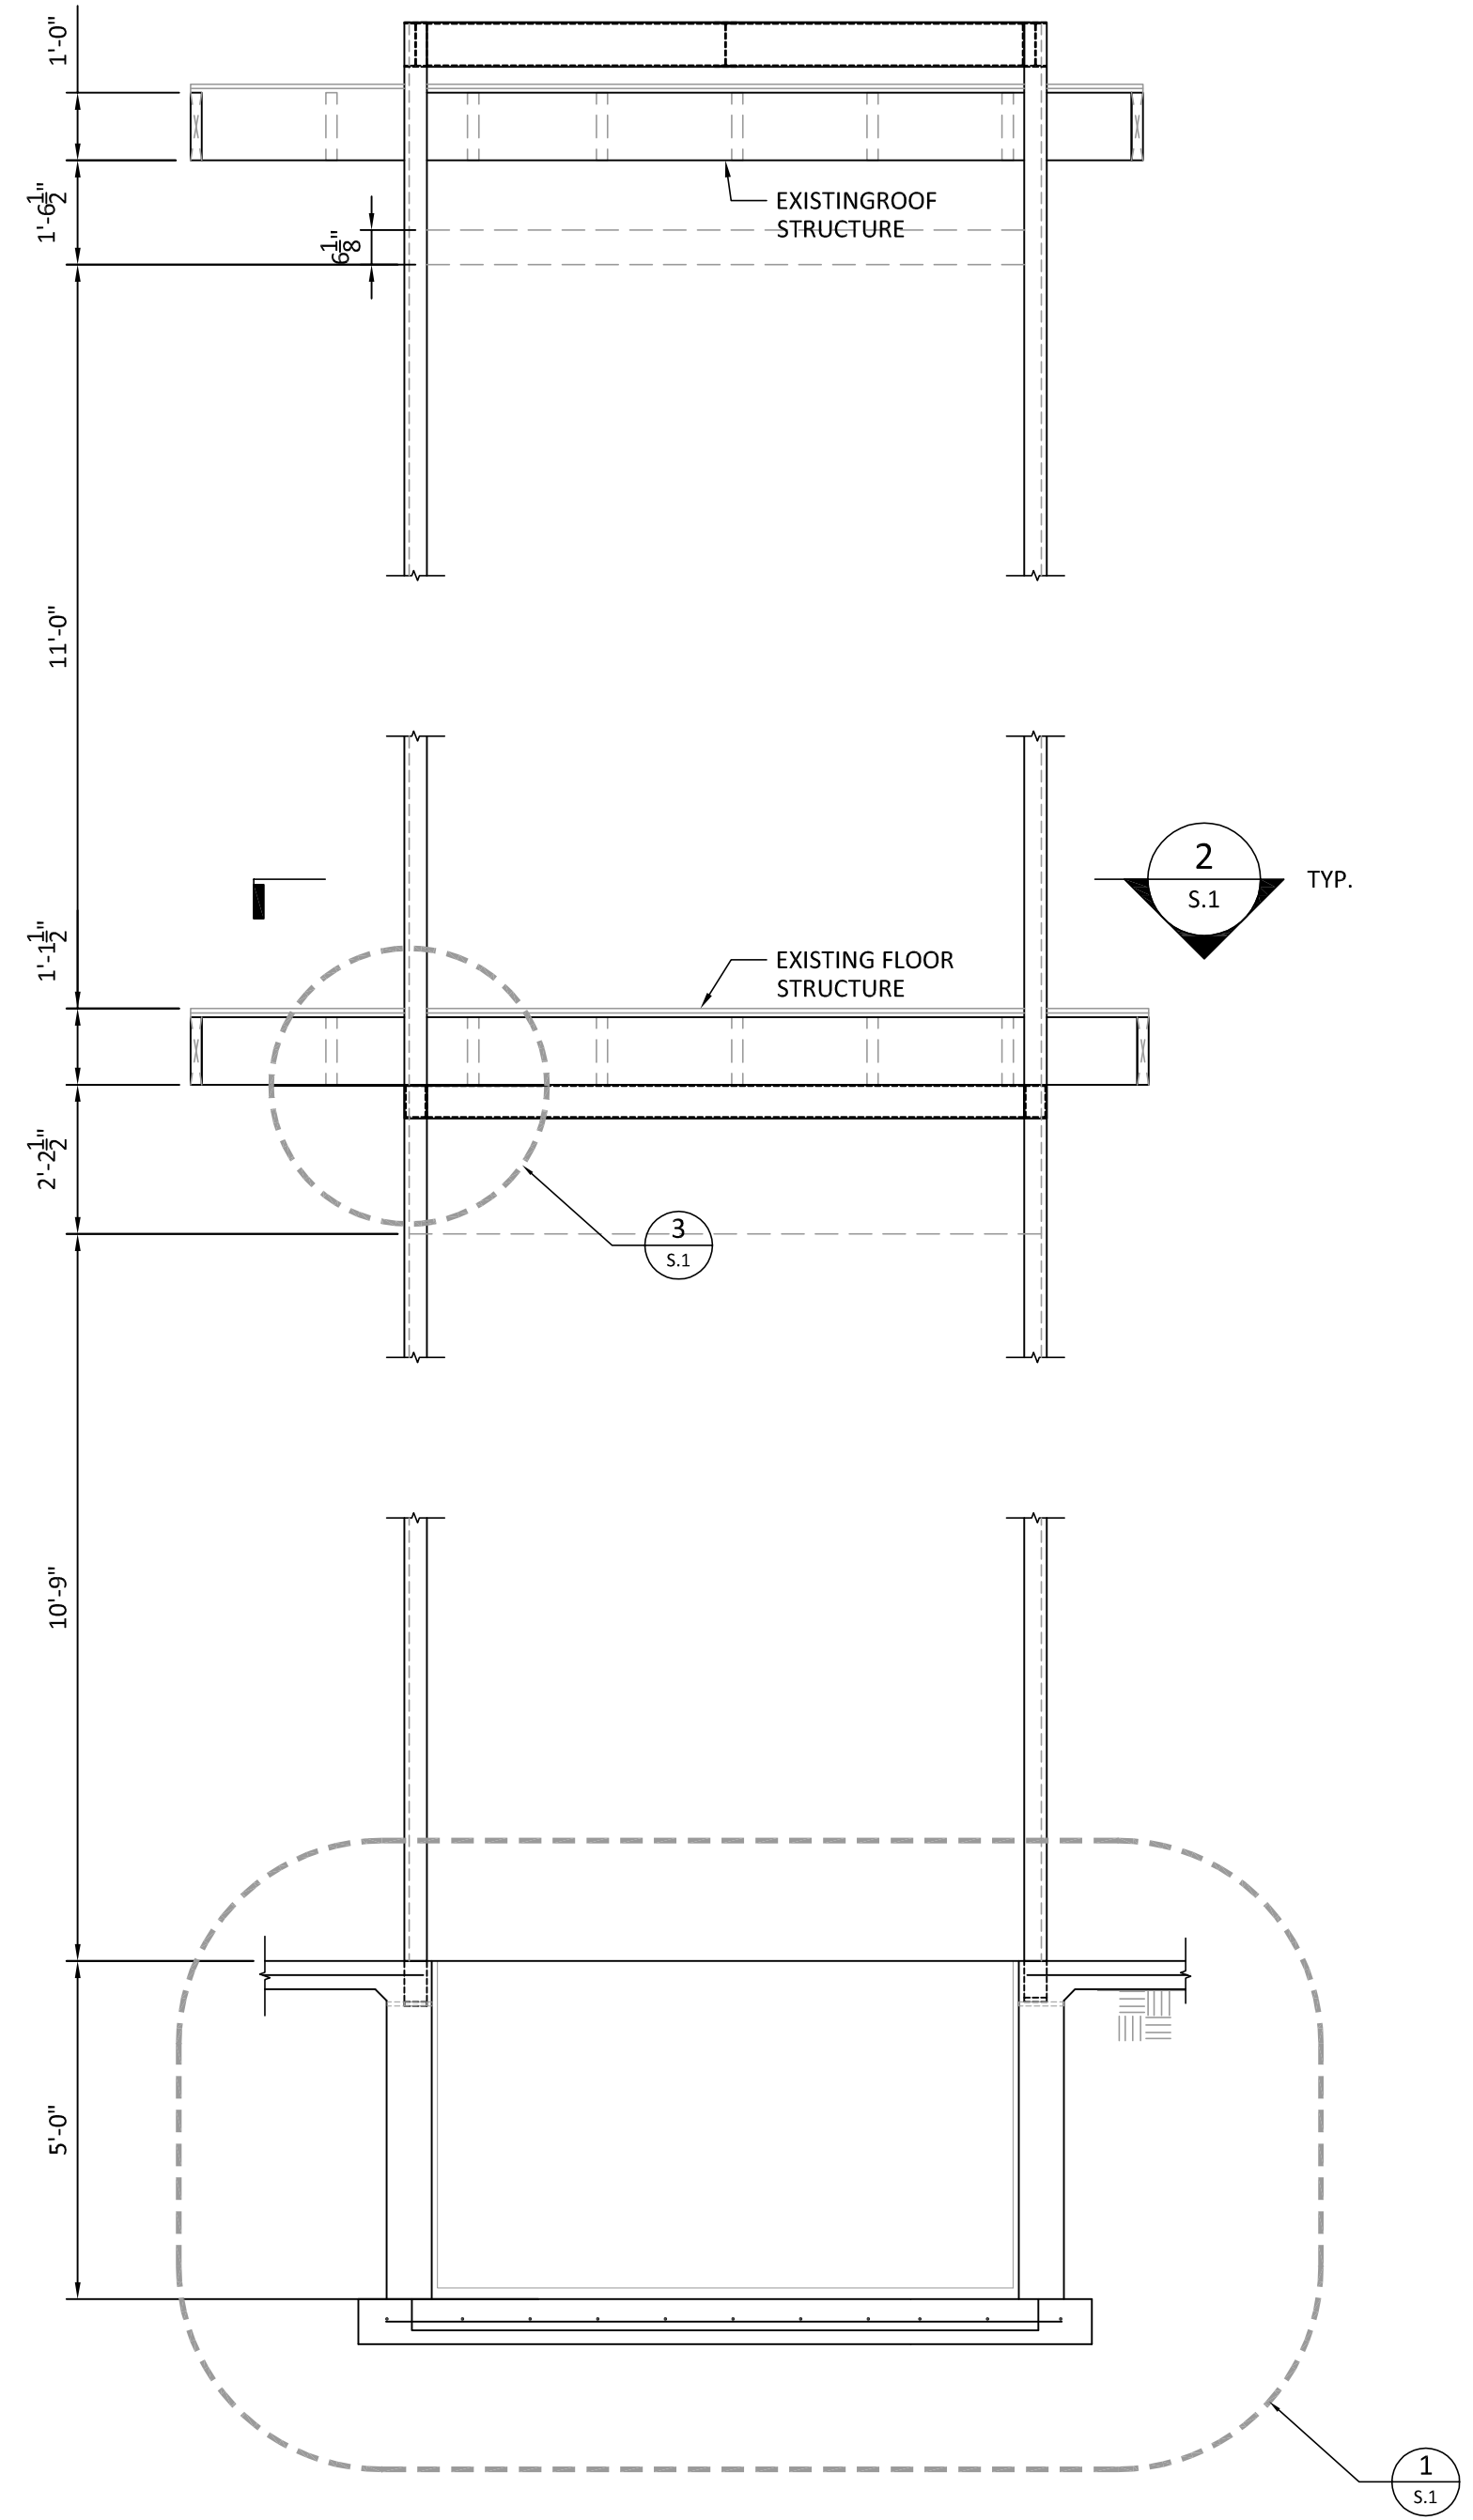
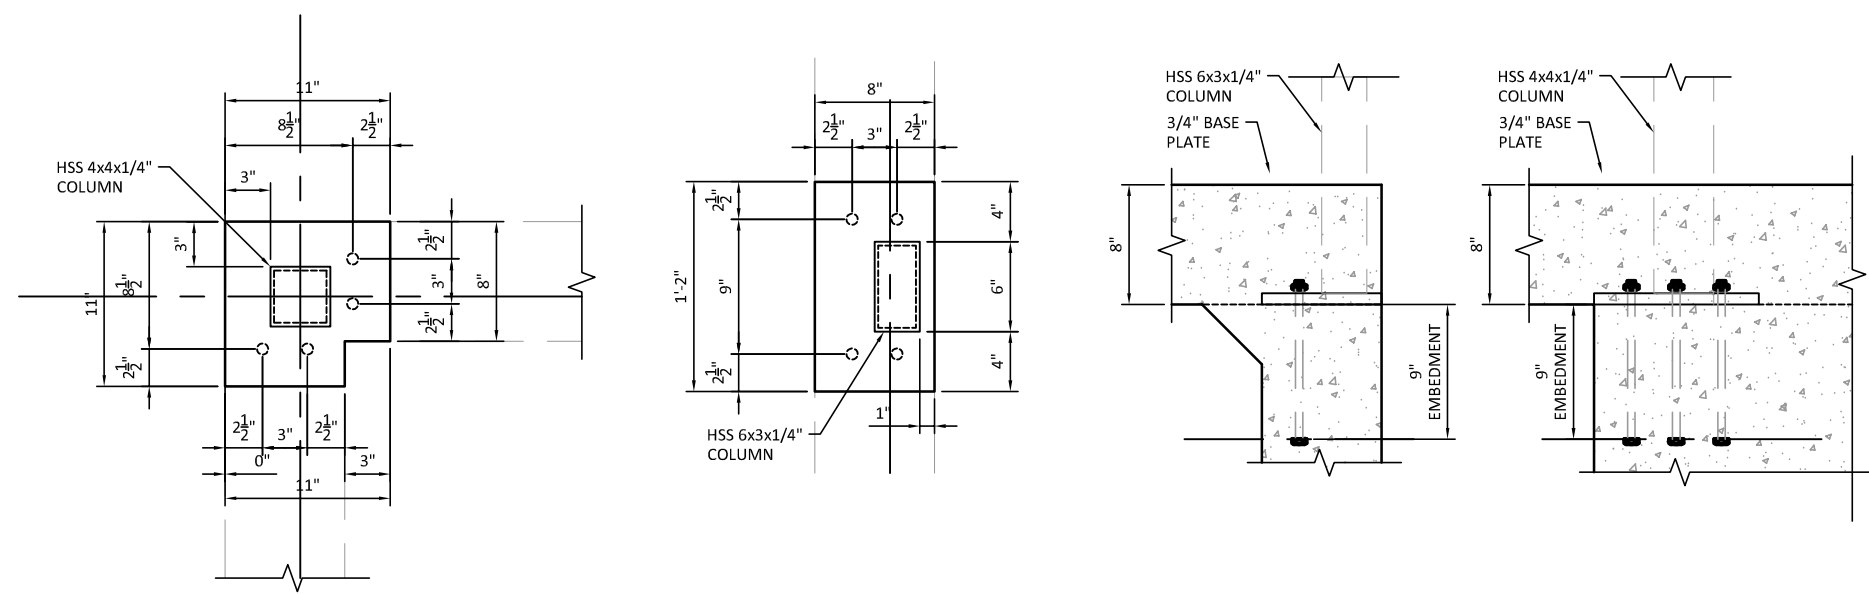
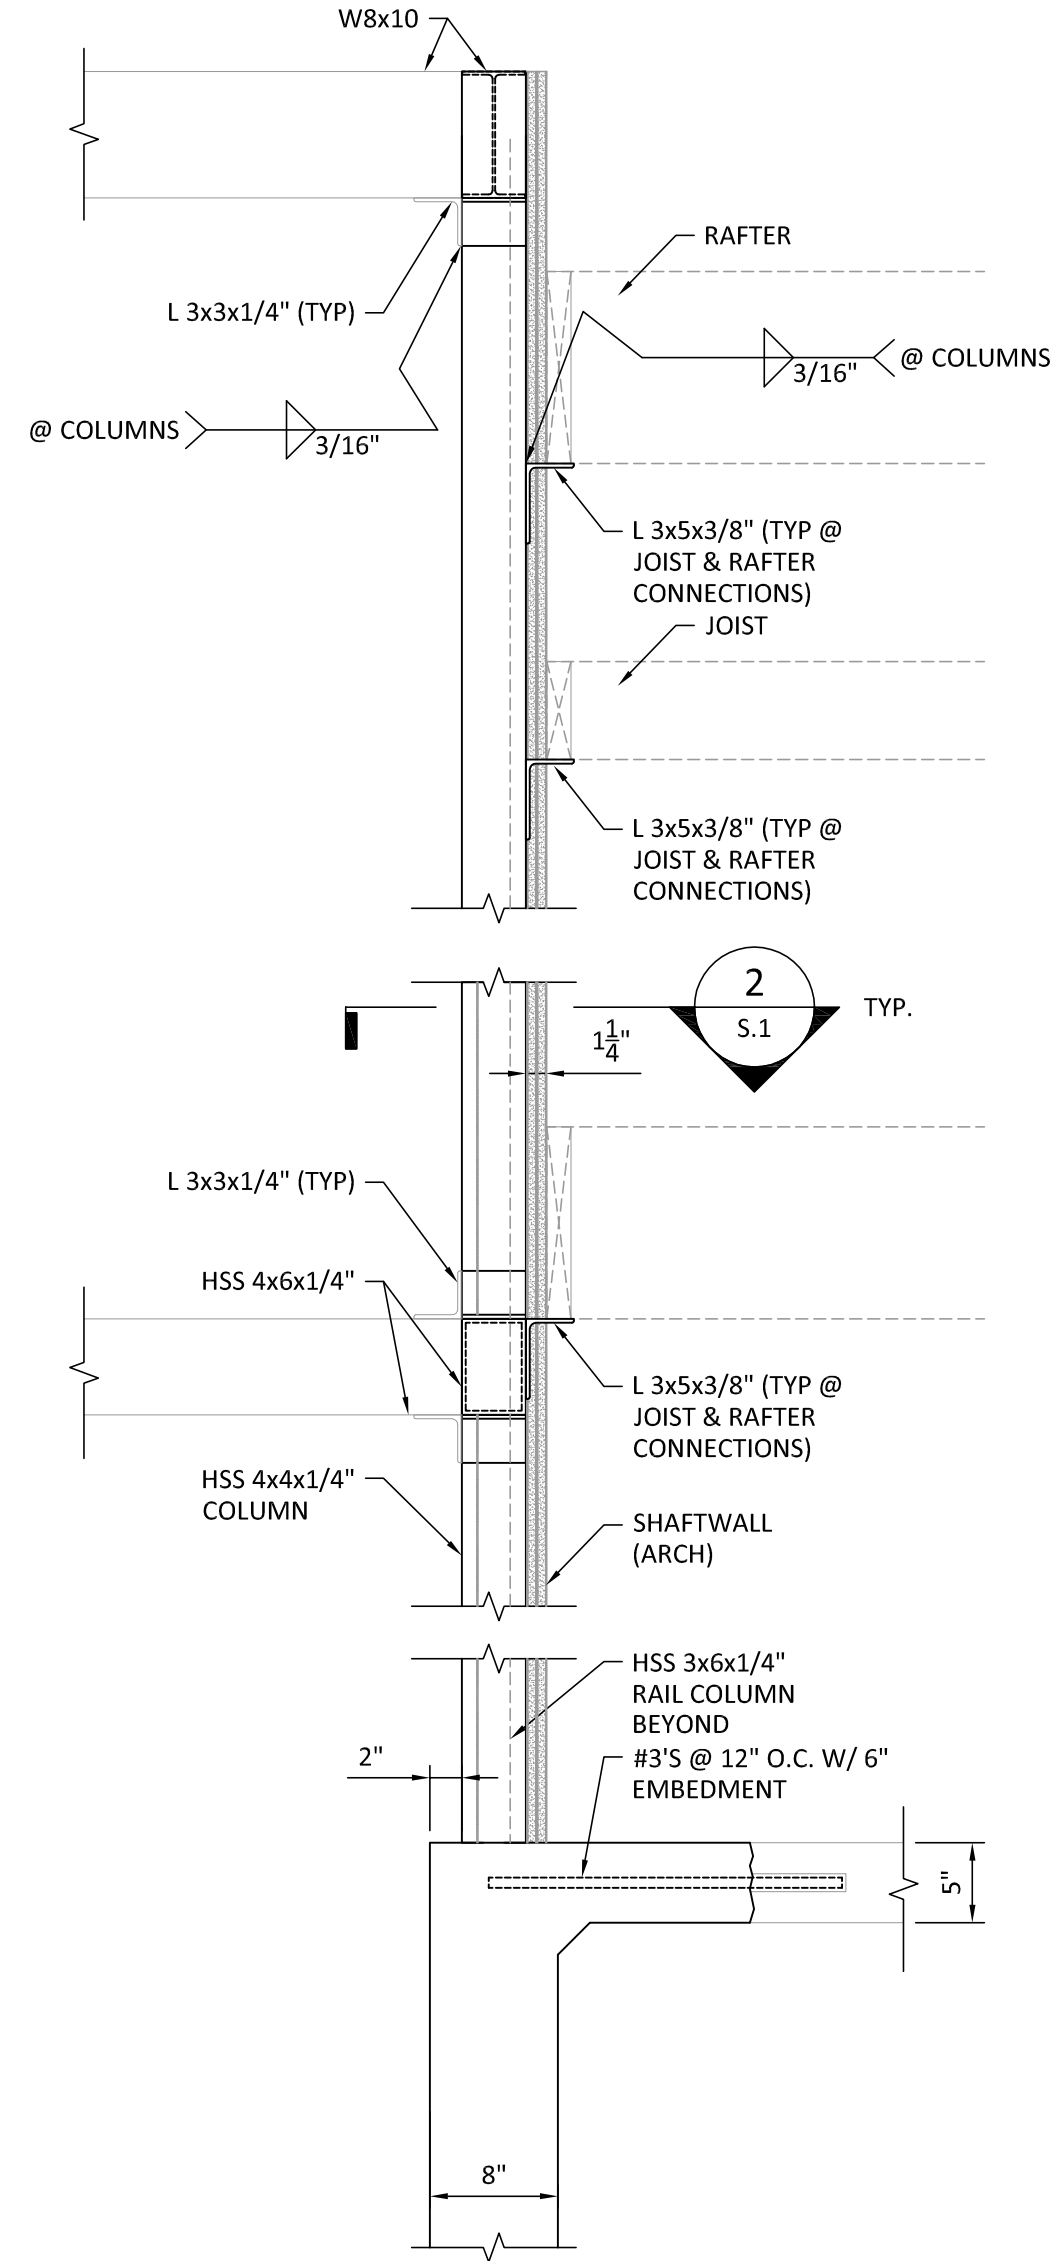
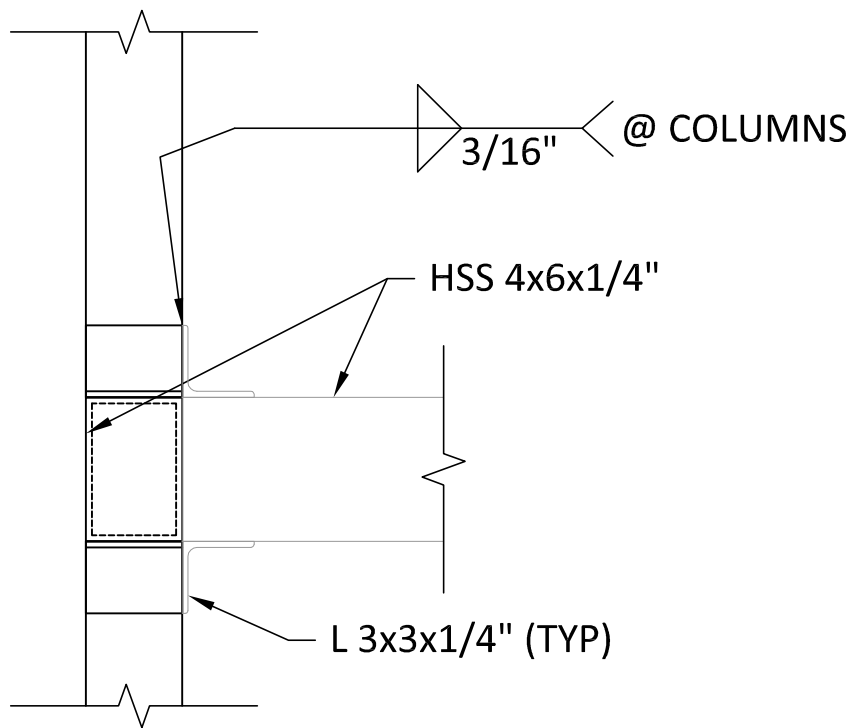
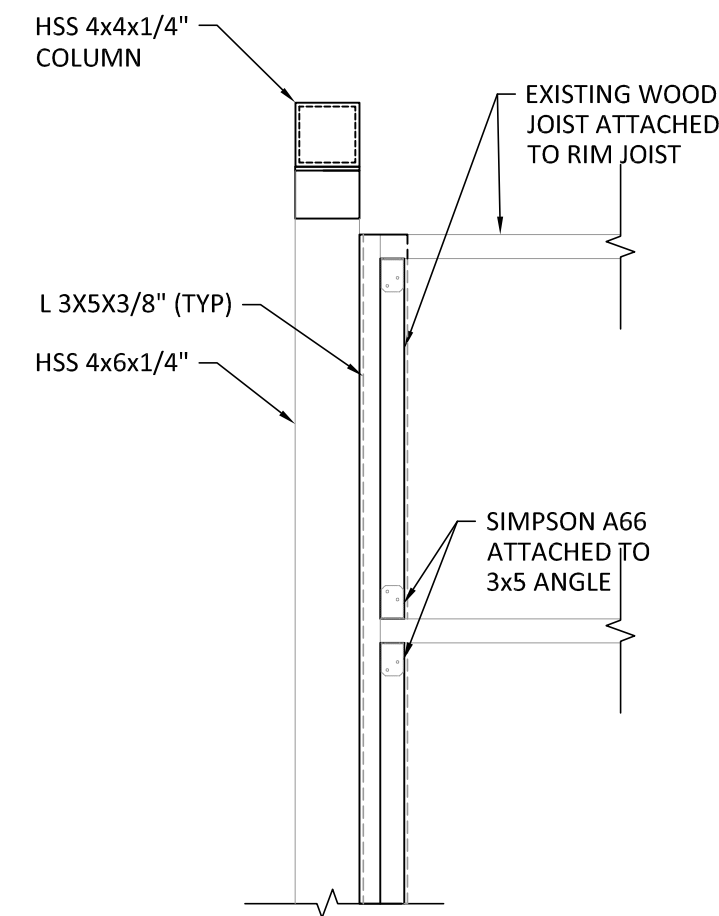
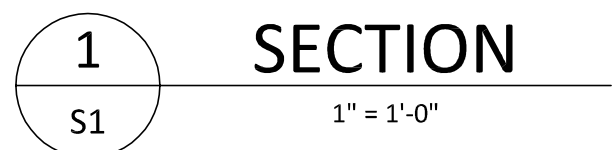
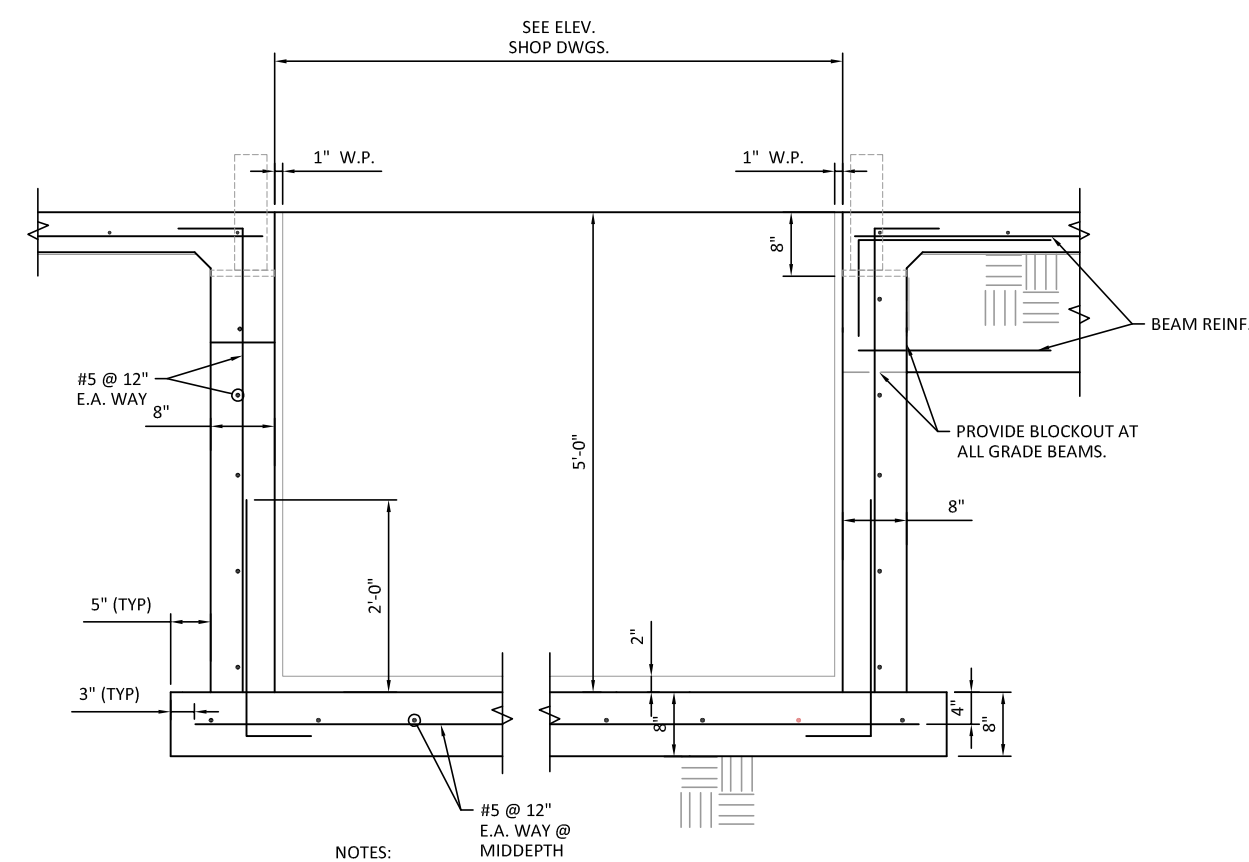
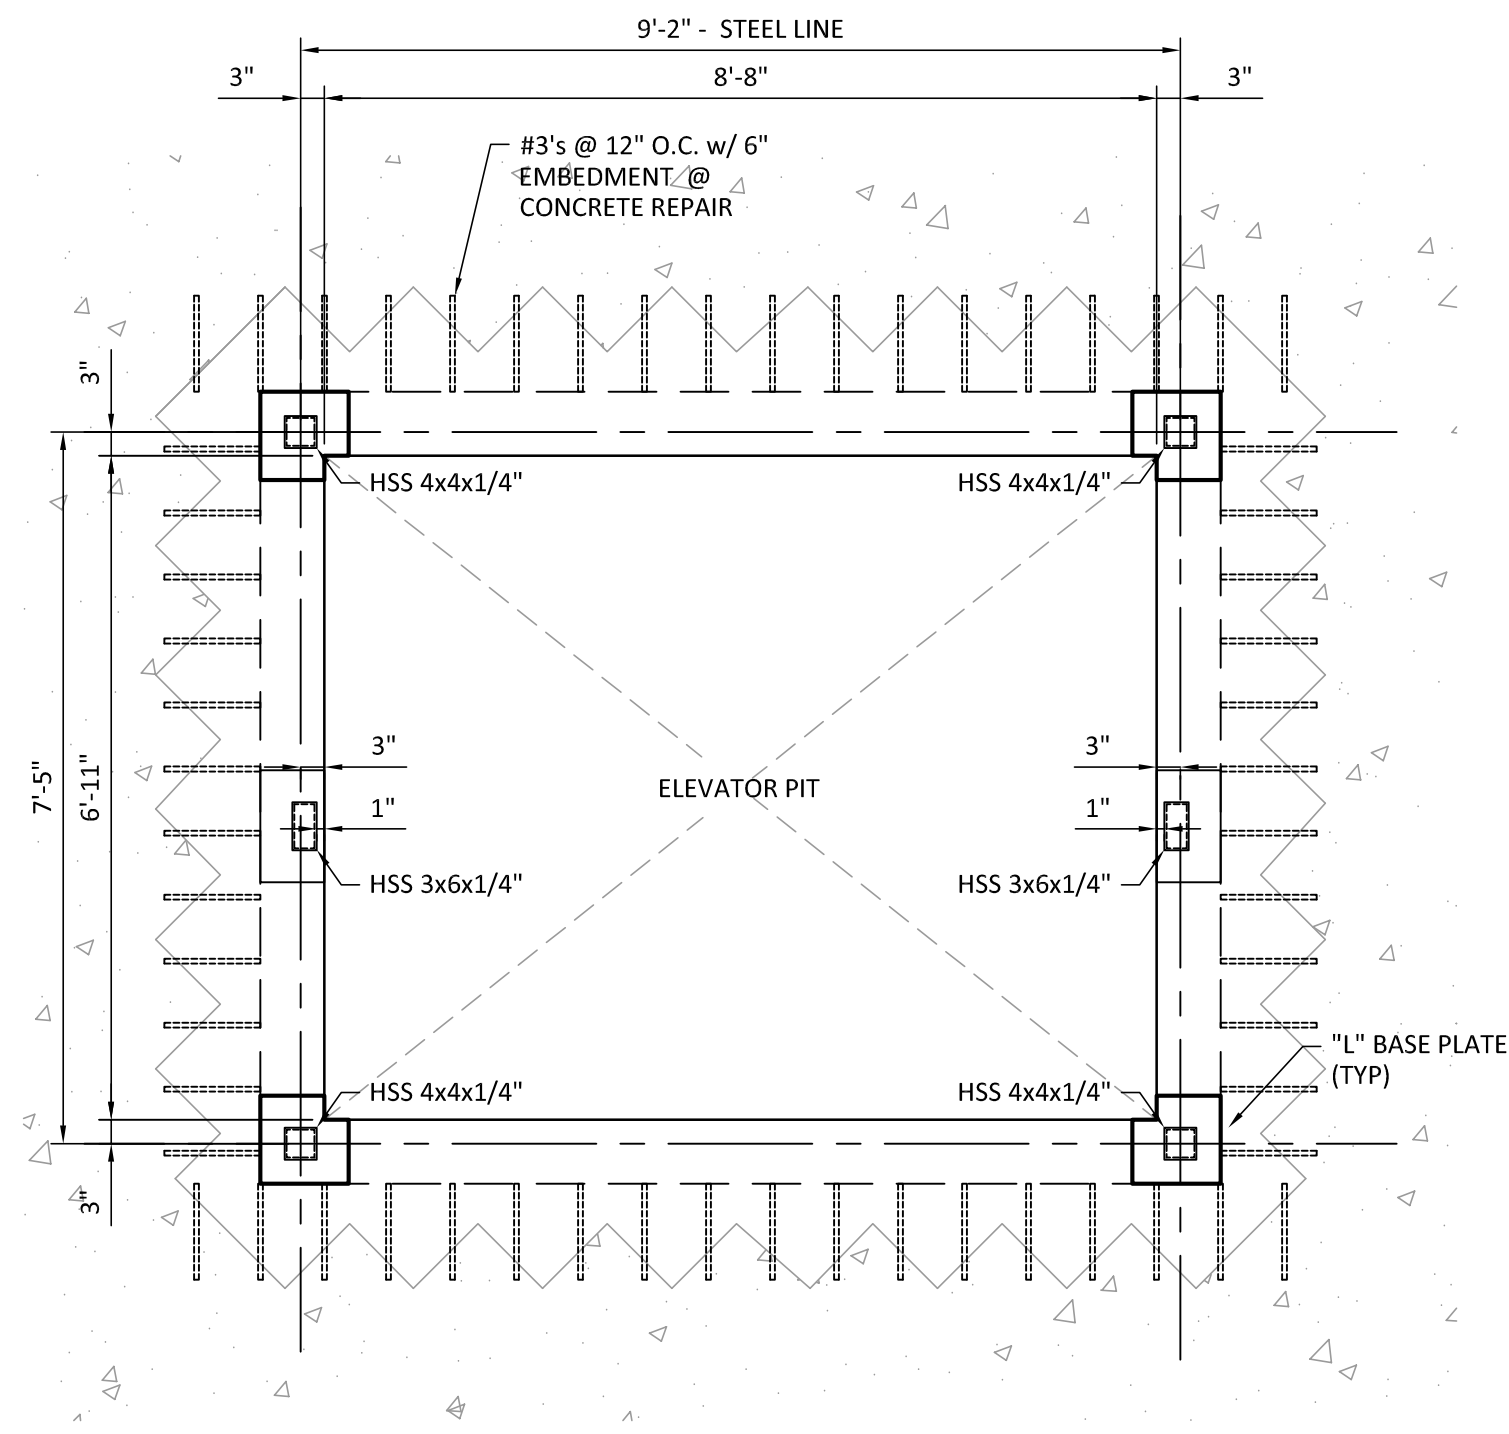
747 ST CHARLES AVE  
RENOVATION - HOTEL PROJECT  
747 ST CHARLES AVE  
NEW ORLEANS, LA  
GENERAL NOTES

NO.	DATE:	REVISIONS	APP'D



SHEET NO.

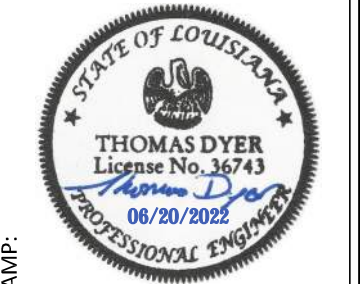S0.0



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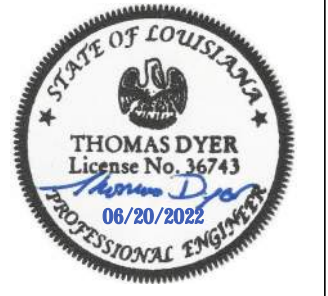
747 ST CHARLES AVE

RENOVATION - HOTEL PROJECT



747 ST CHARLES AVE

NEW ORLEANS, LA

ELEVATOR DETAILS


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SHEET NO.

S2.0

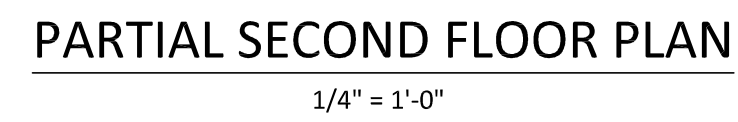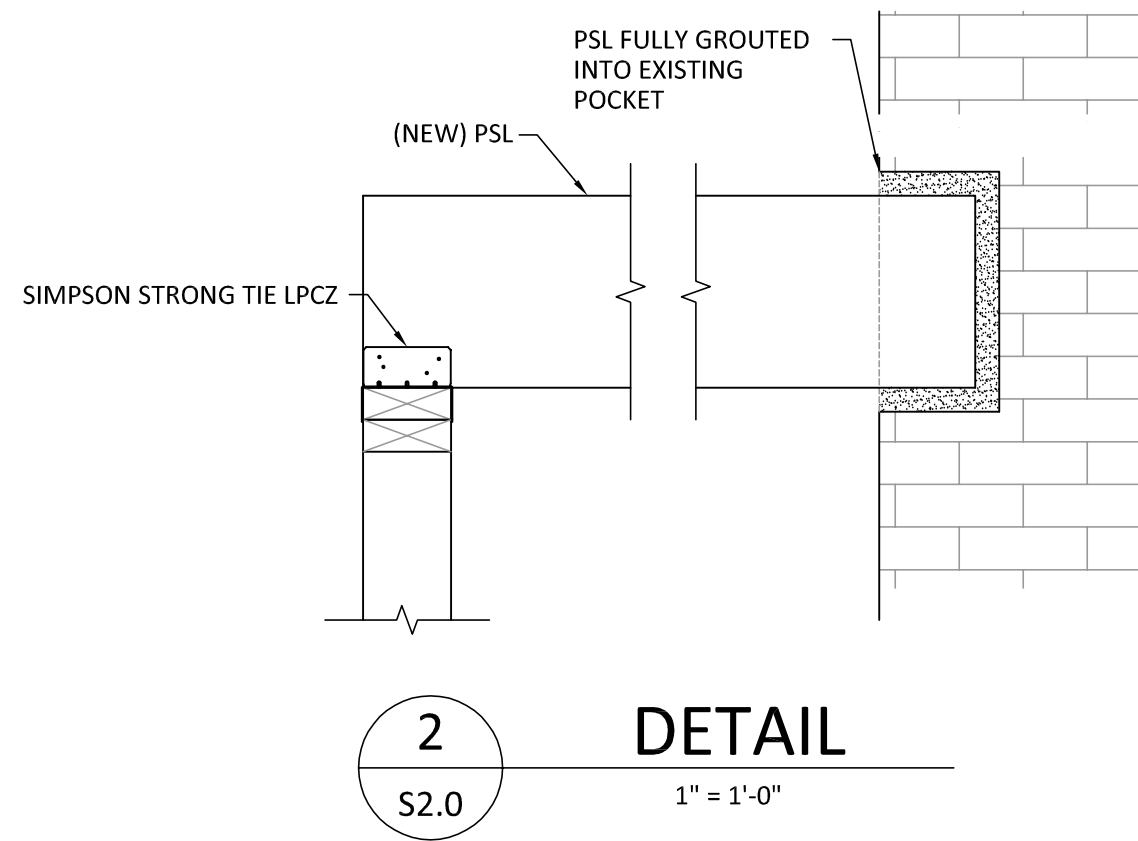

PARTIAL FIRST FLOOR PLAN  
1/4" = 1'-0"

ST. CHARLES AVE.

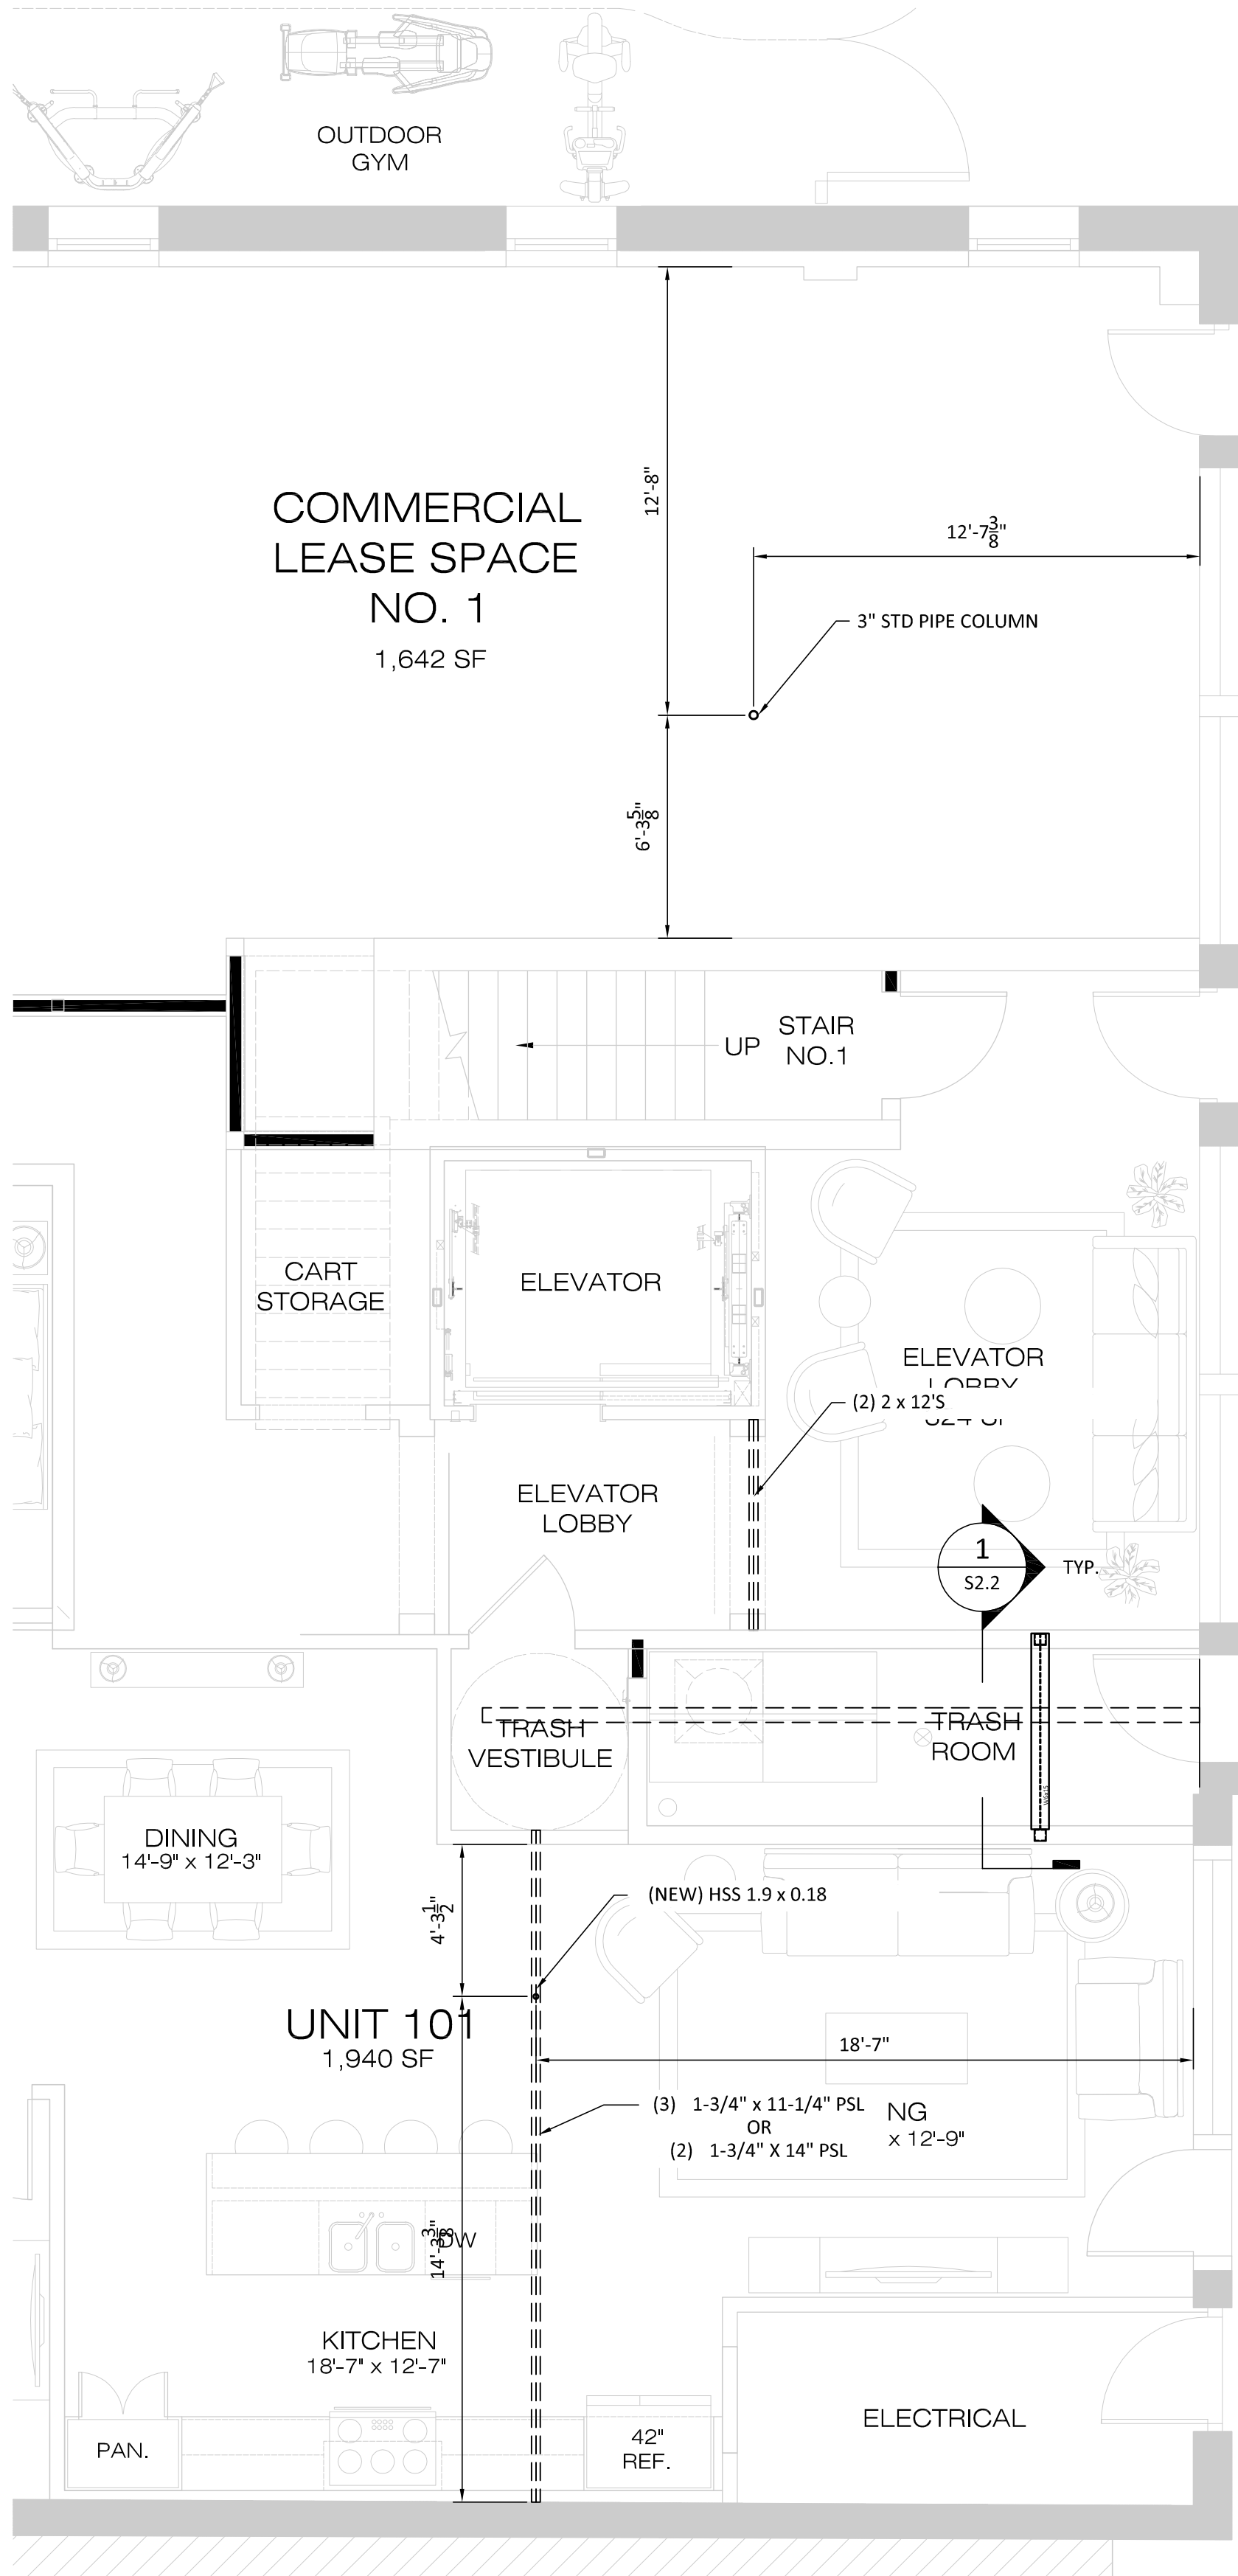CADD FILE NAME:  
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DESIGNED BY:  
SAD

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CHECKED BY:  
TD

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21020

SCALE: (22x34)  
VARIES

SCALE: (11x17)  
-

DATE:  
04/15/2021


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RENOVATION - HOTEL PROJECT  
747 ST CHARLES AVE  
NEW ORLEANS, LA

ELEVATOR DETAILS

NO.	DATE:	REVISIONS	APP'D

STATE OF LOUISIANA  
THOMAS DYER  
License No. 36743  
06/20/2022  
PROFESSIONAL ENGINEER

STAMP:




**Kyle Associates, LLC**  
Planning, Engineering, and Landscape Architecture  
638 Village Lane N. • Metairie, LA 70001 • 852.727.2577

SHEET NO.

S2.1






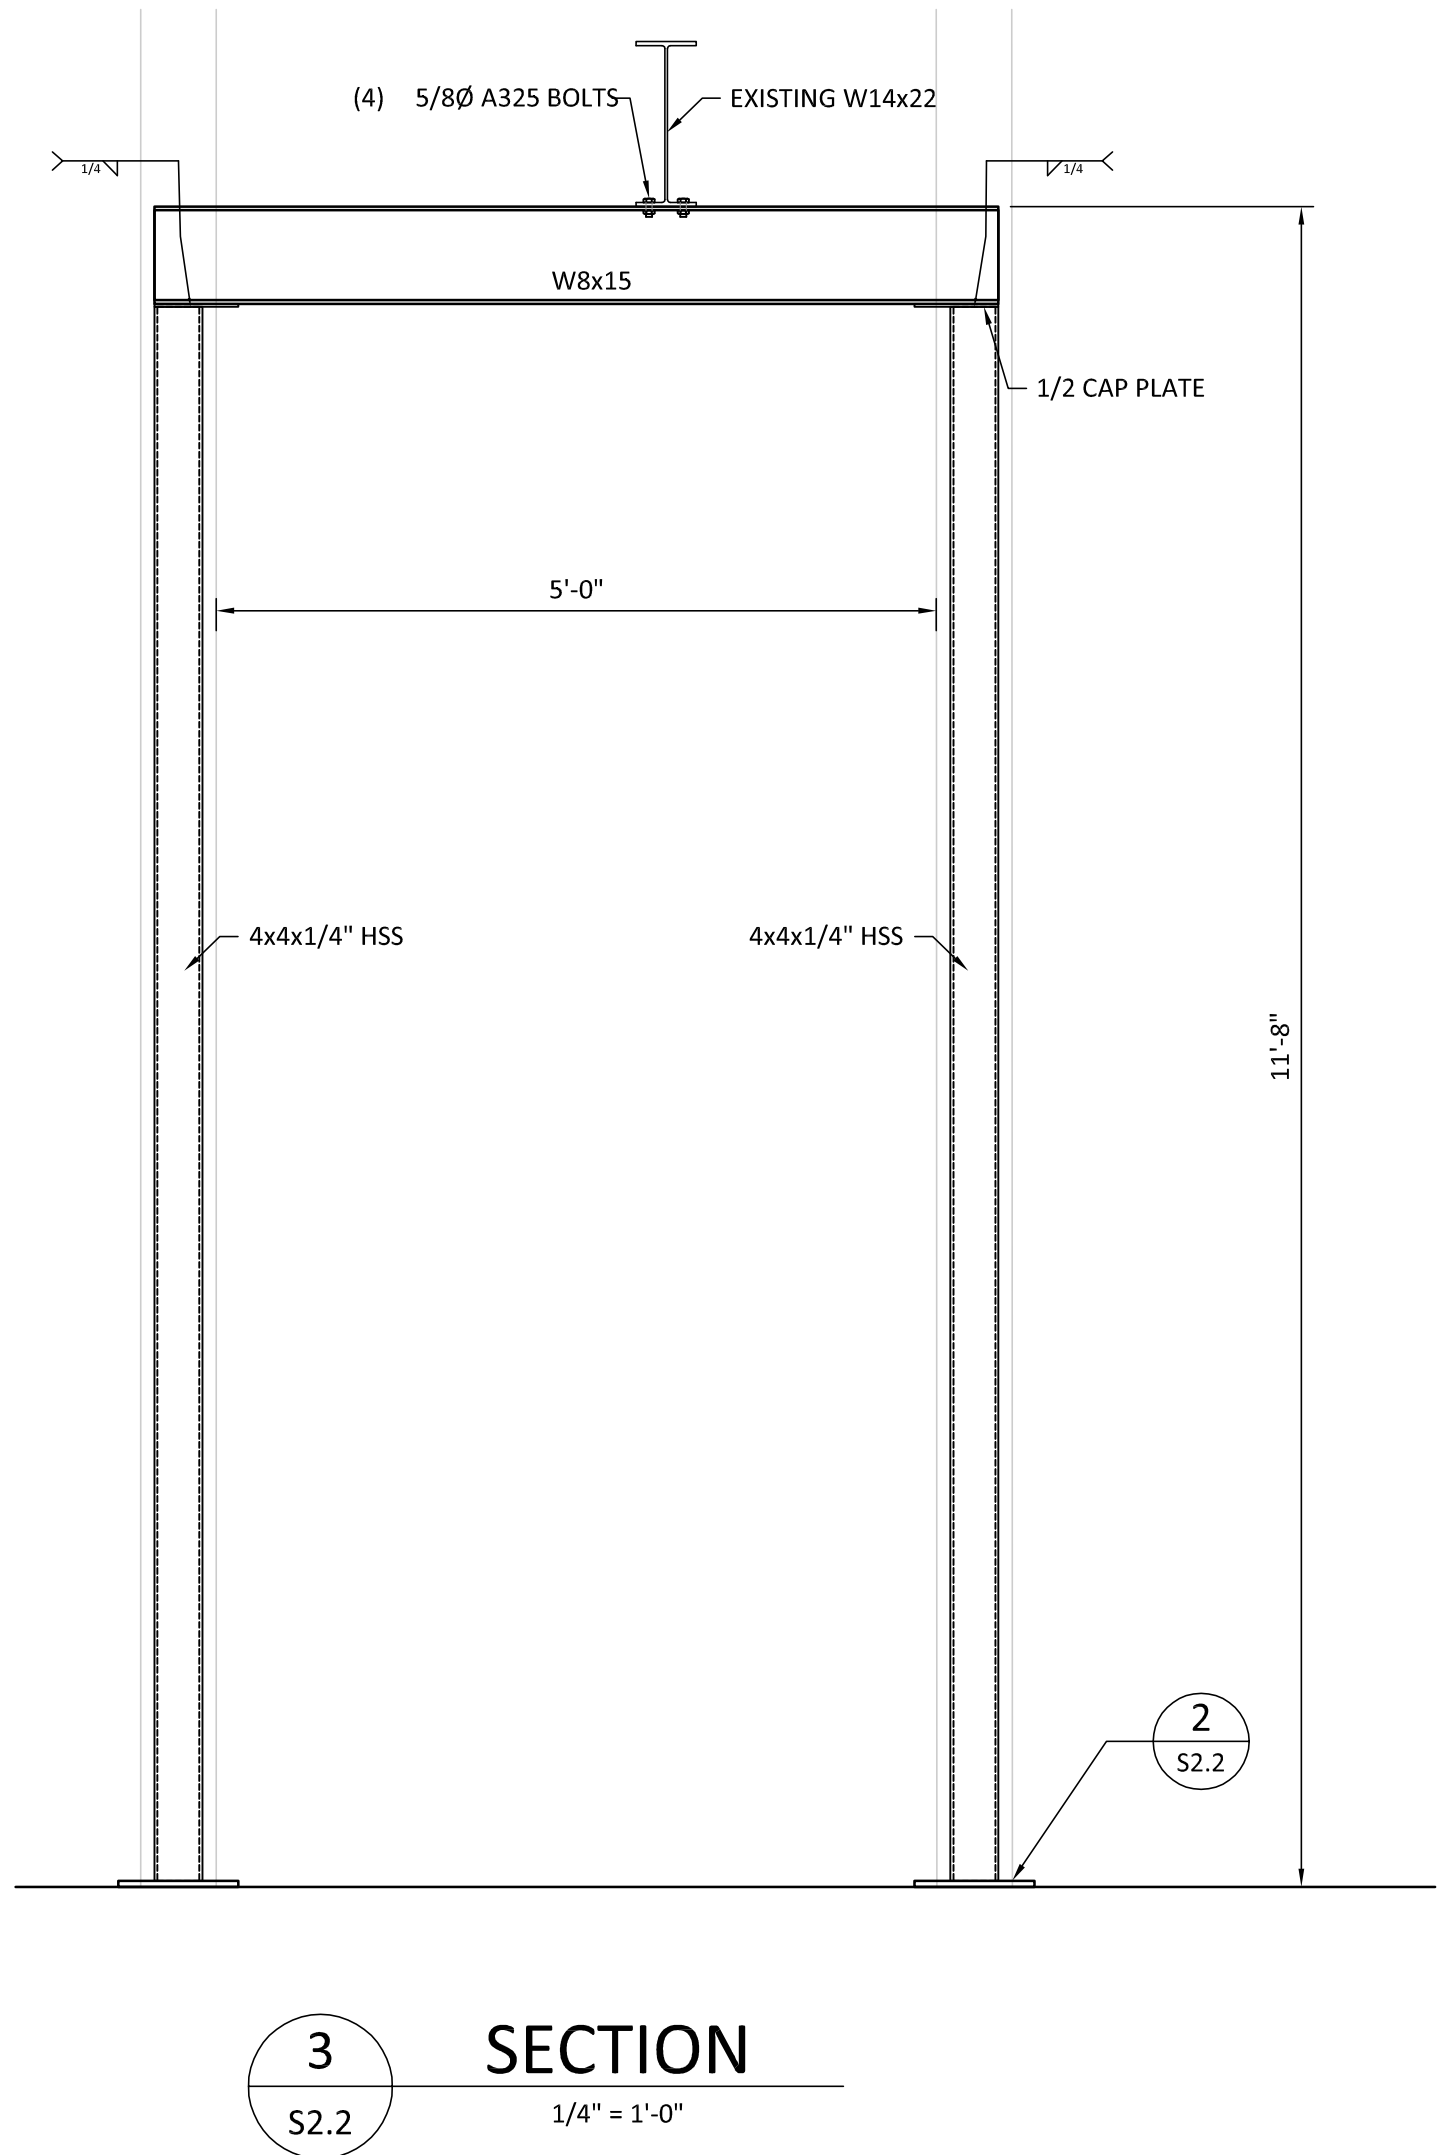

1  
S2.2

SECTION

1-1/2" = 1'-0"

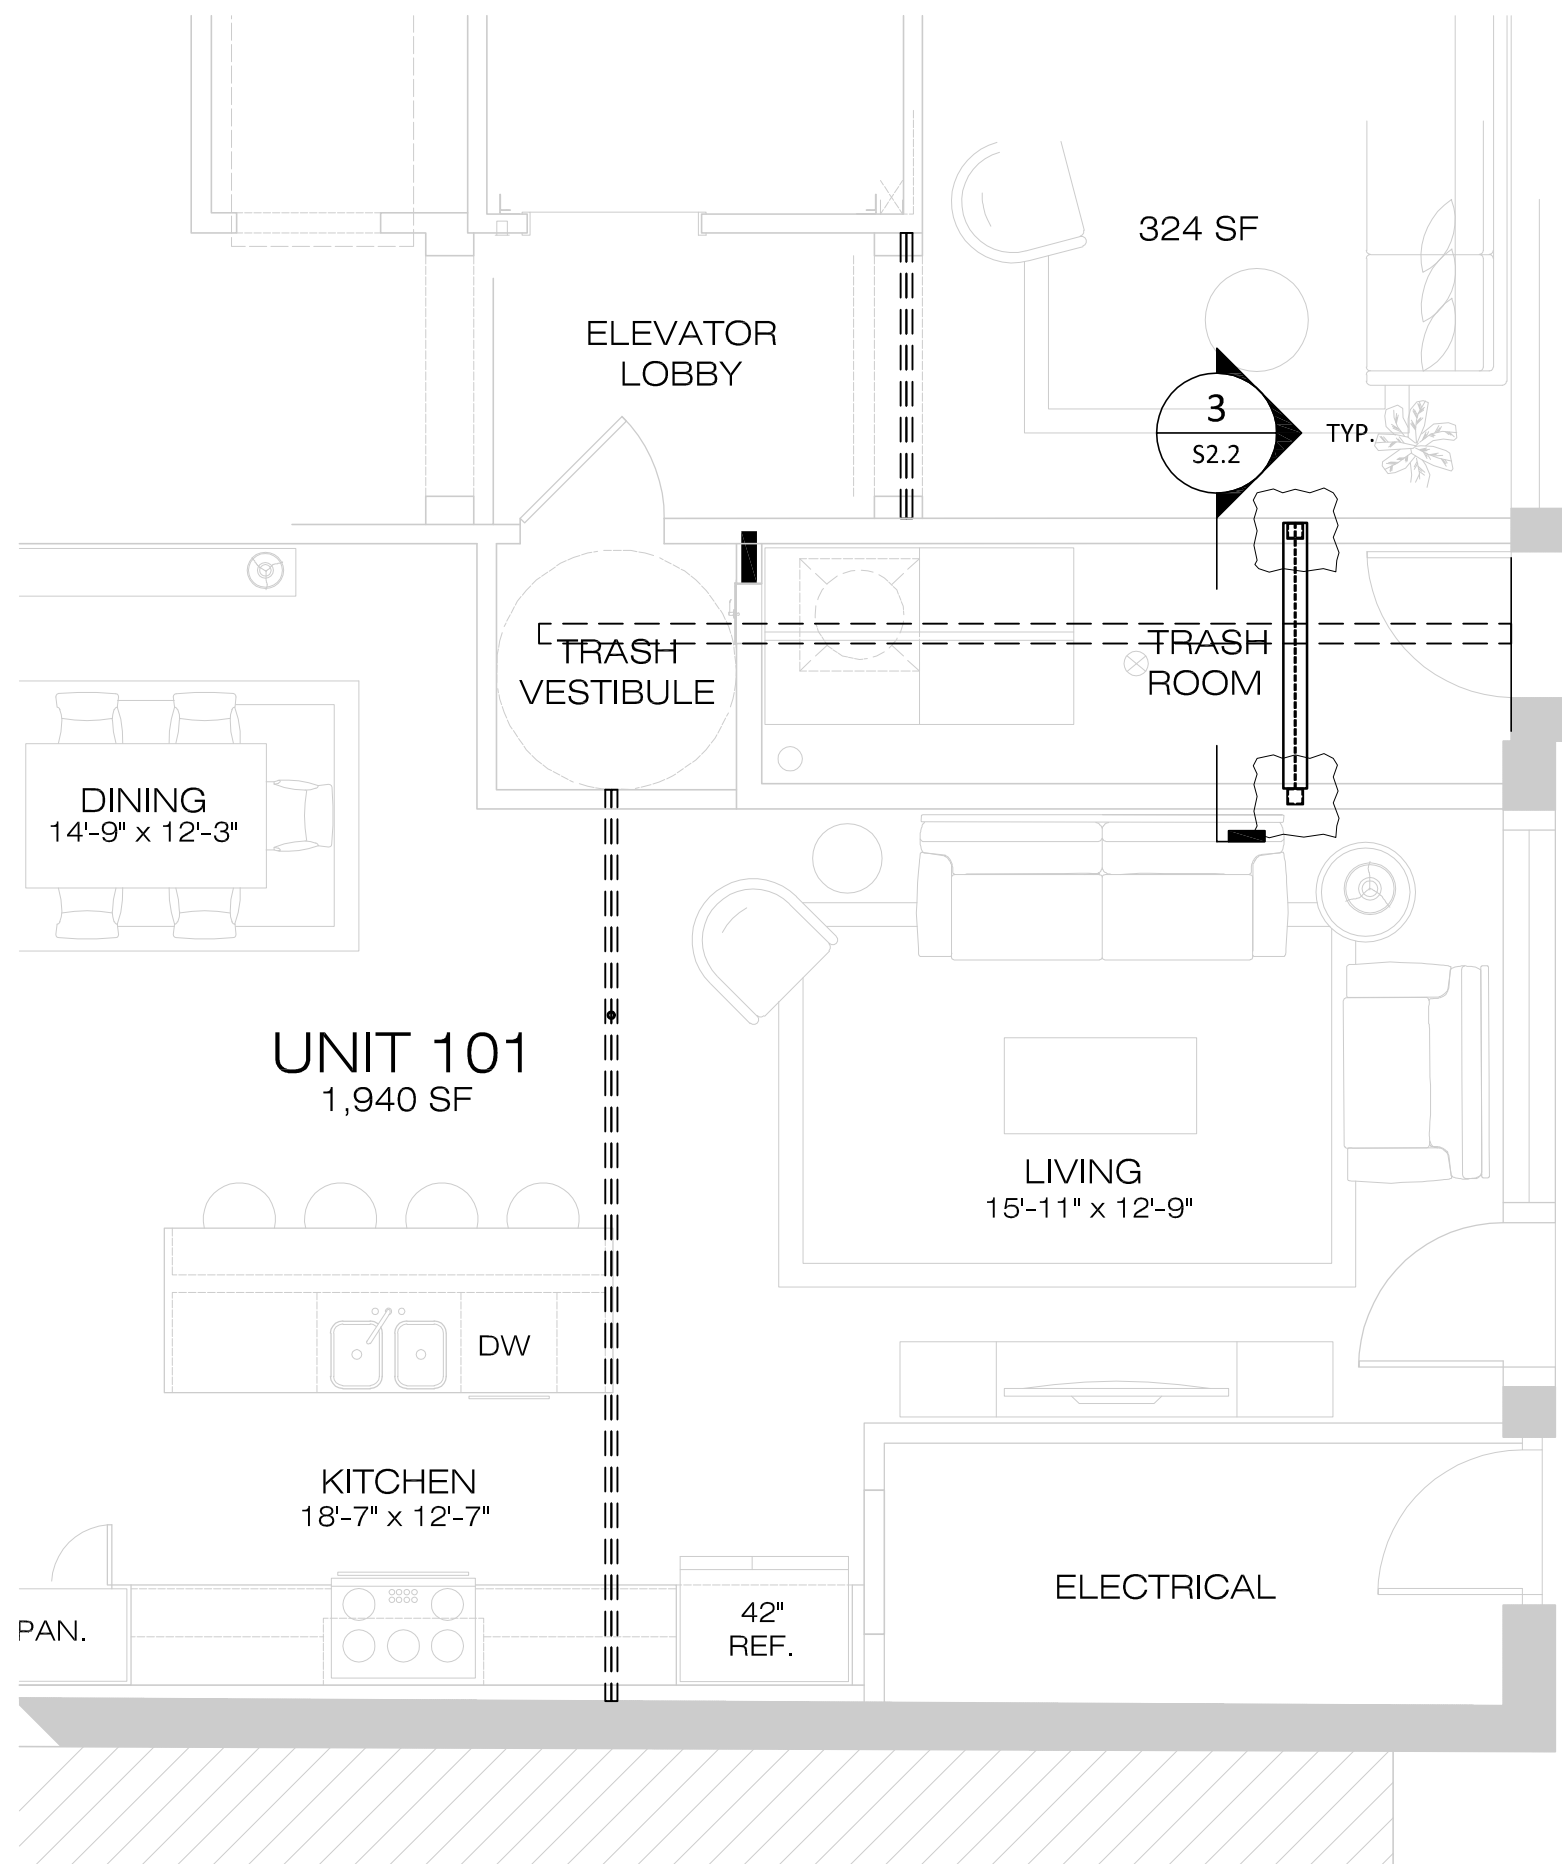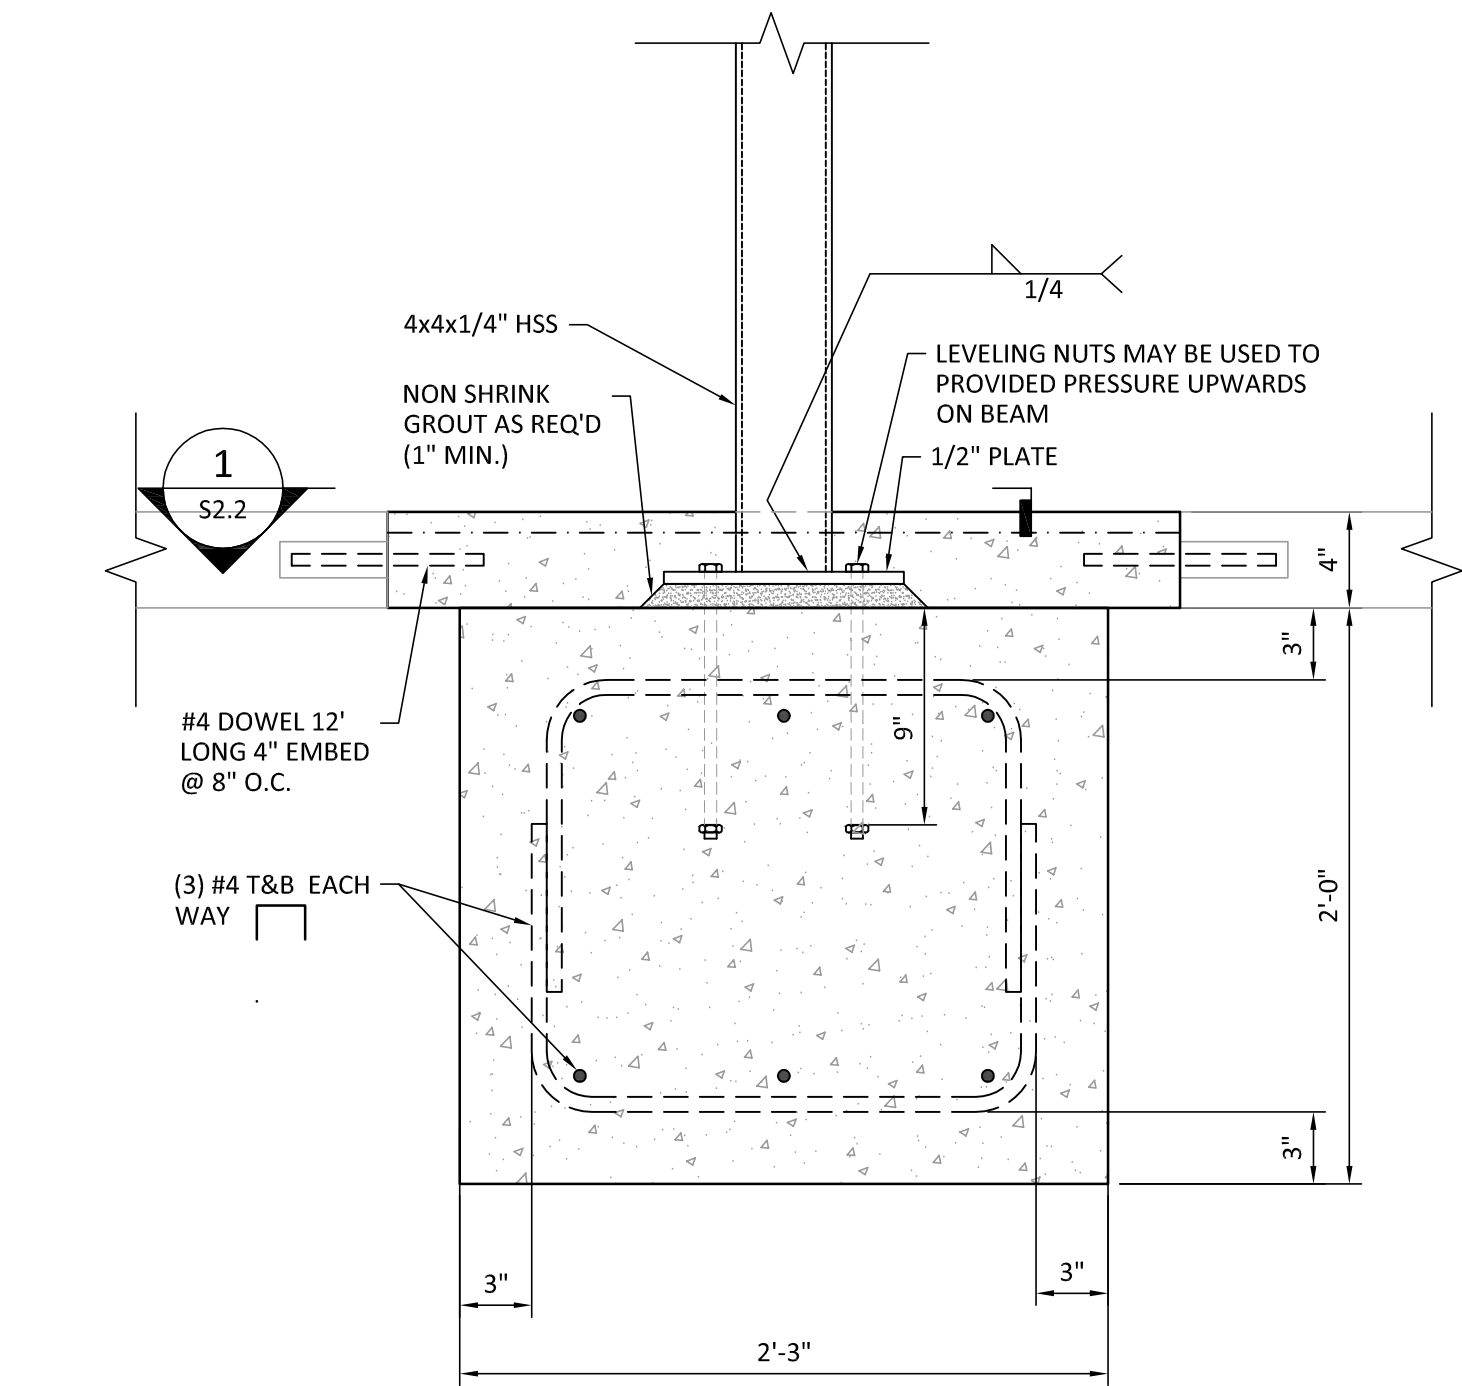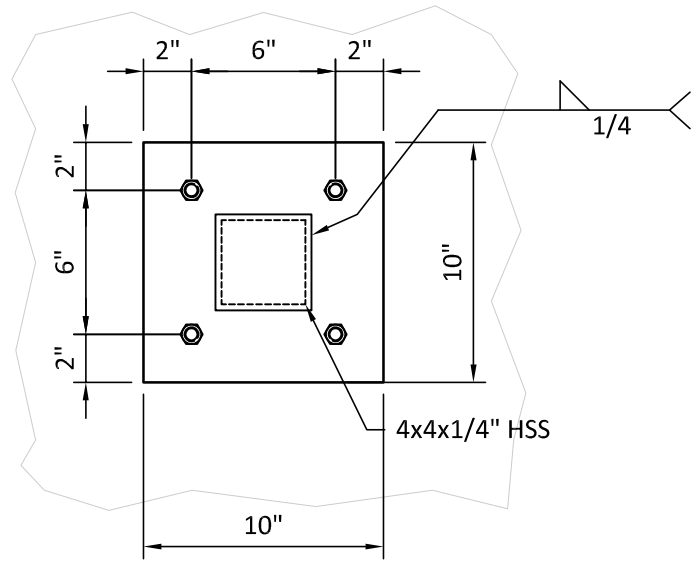

PARTIAL FIRST FLOOR PLAN

ST. CHARLES


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747 ST CHARLES AVE  
RENOVATION - HOTEL PROJECT  
747 ST CHARLES AVE  
NEW ORLEANS, LA


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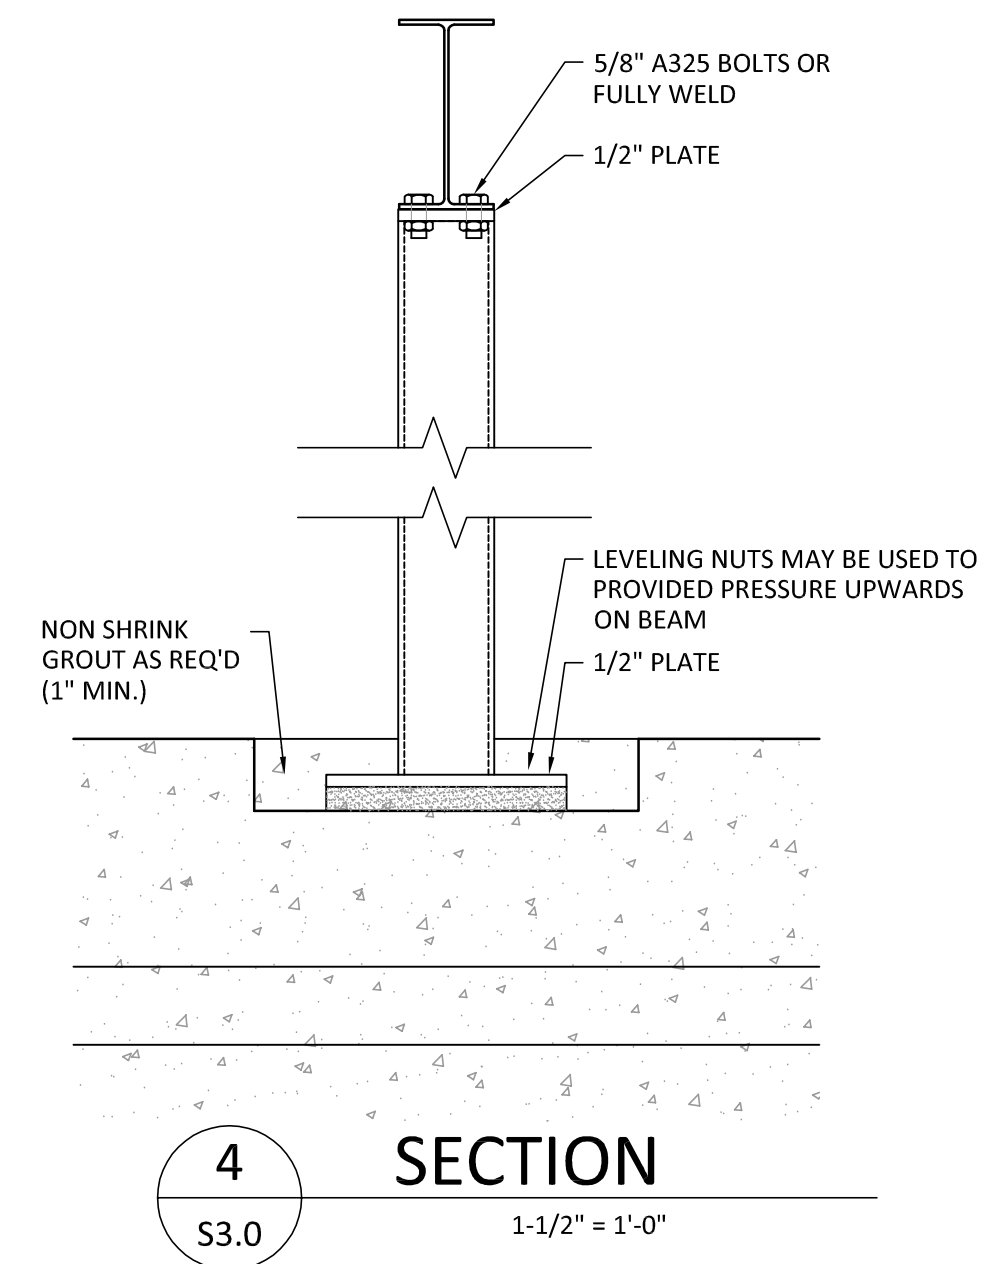
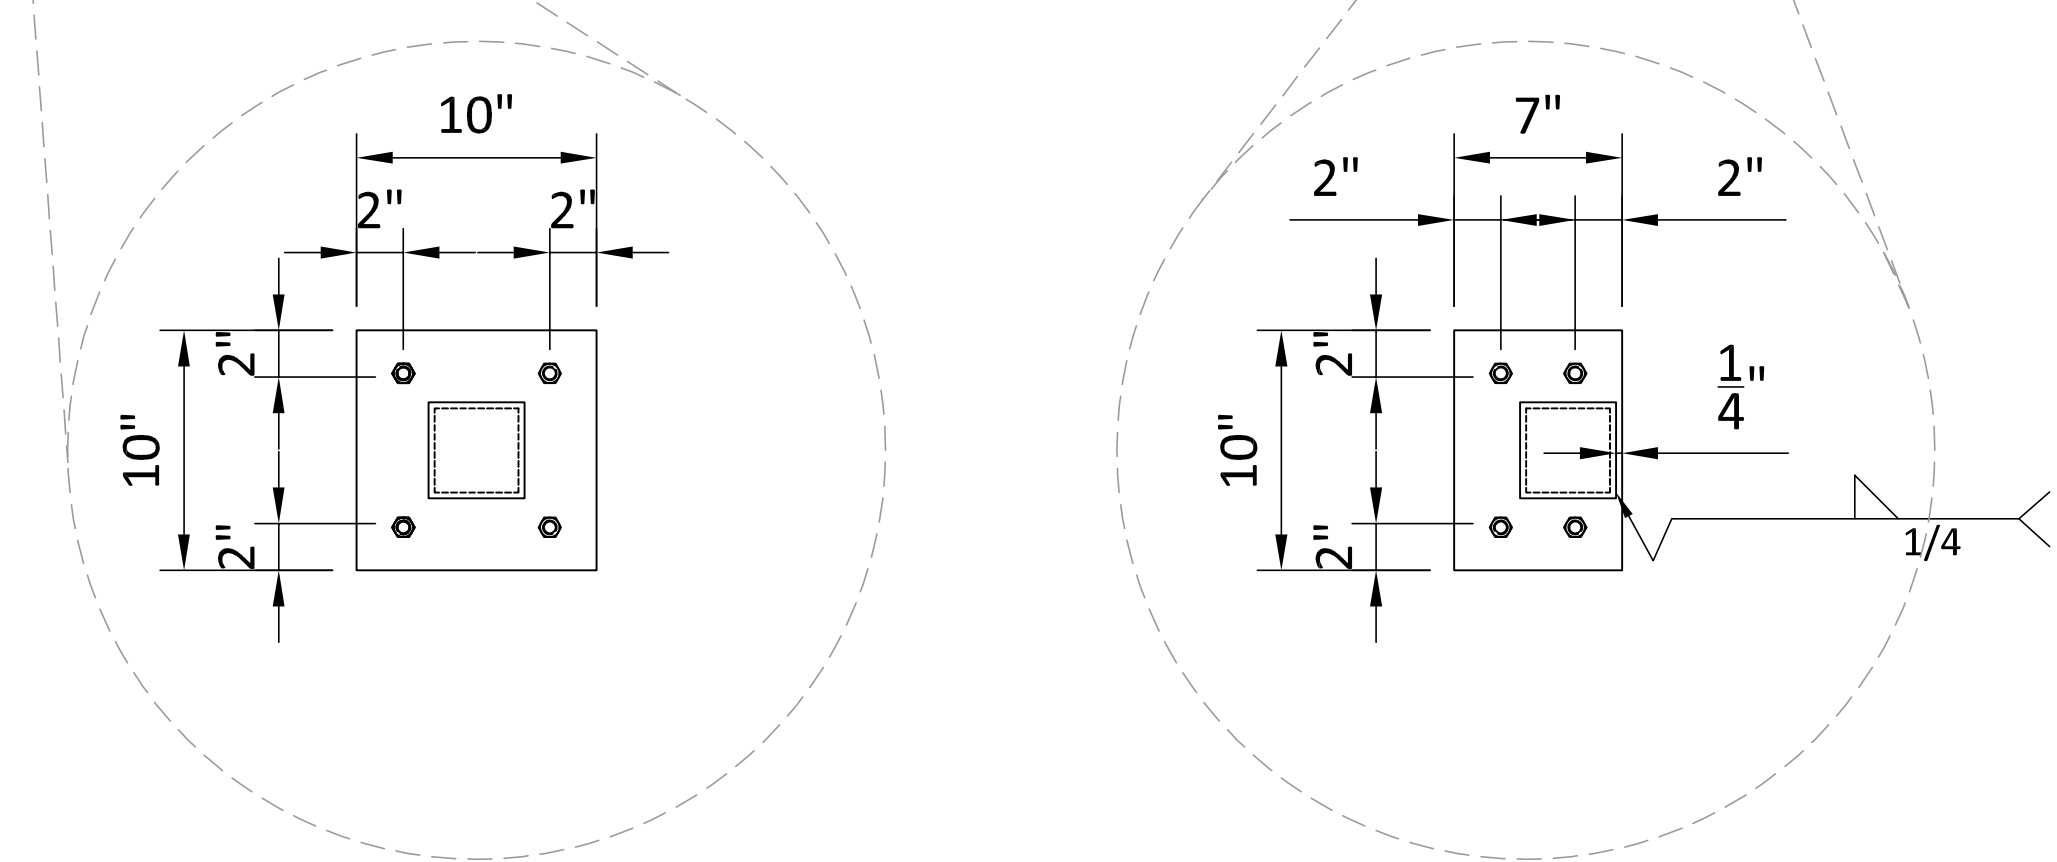
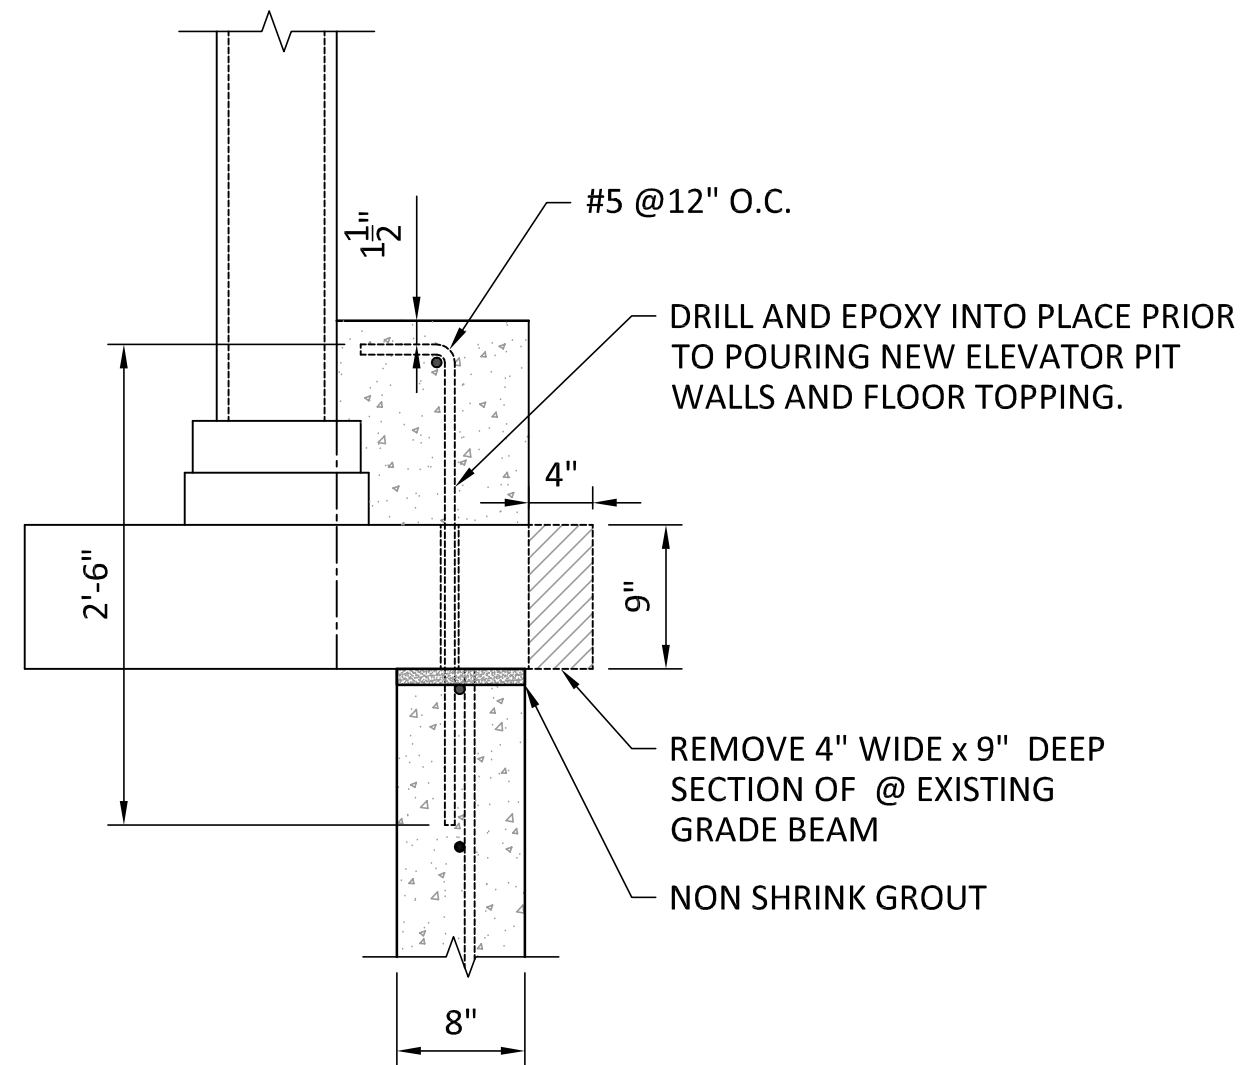


3
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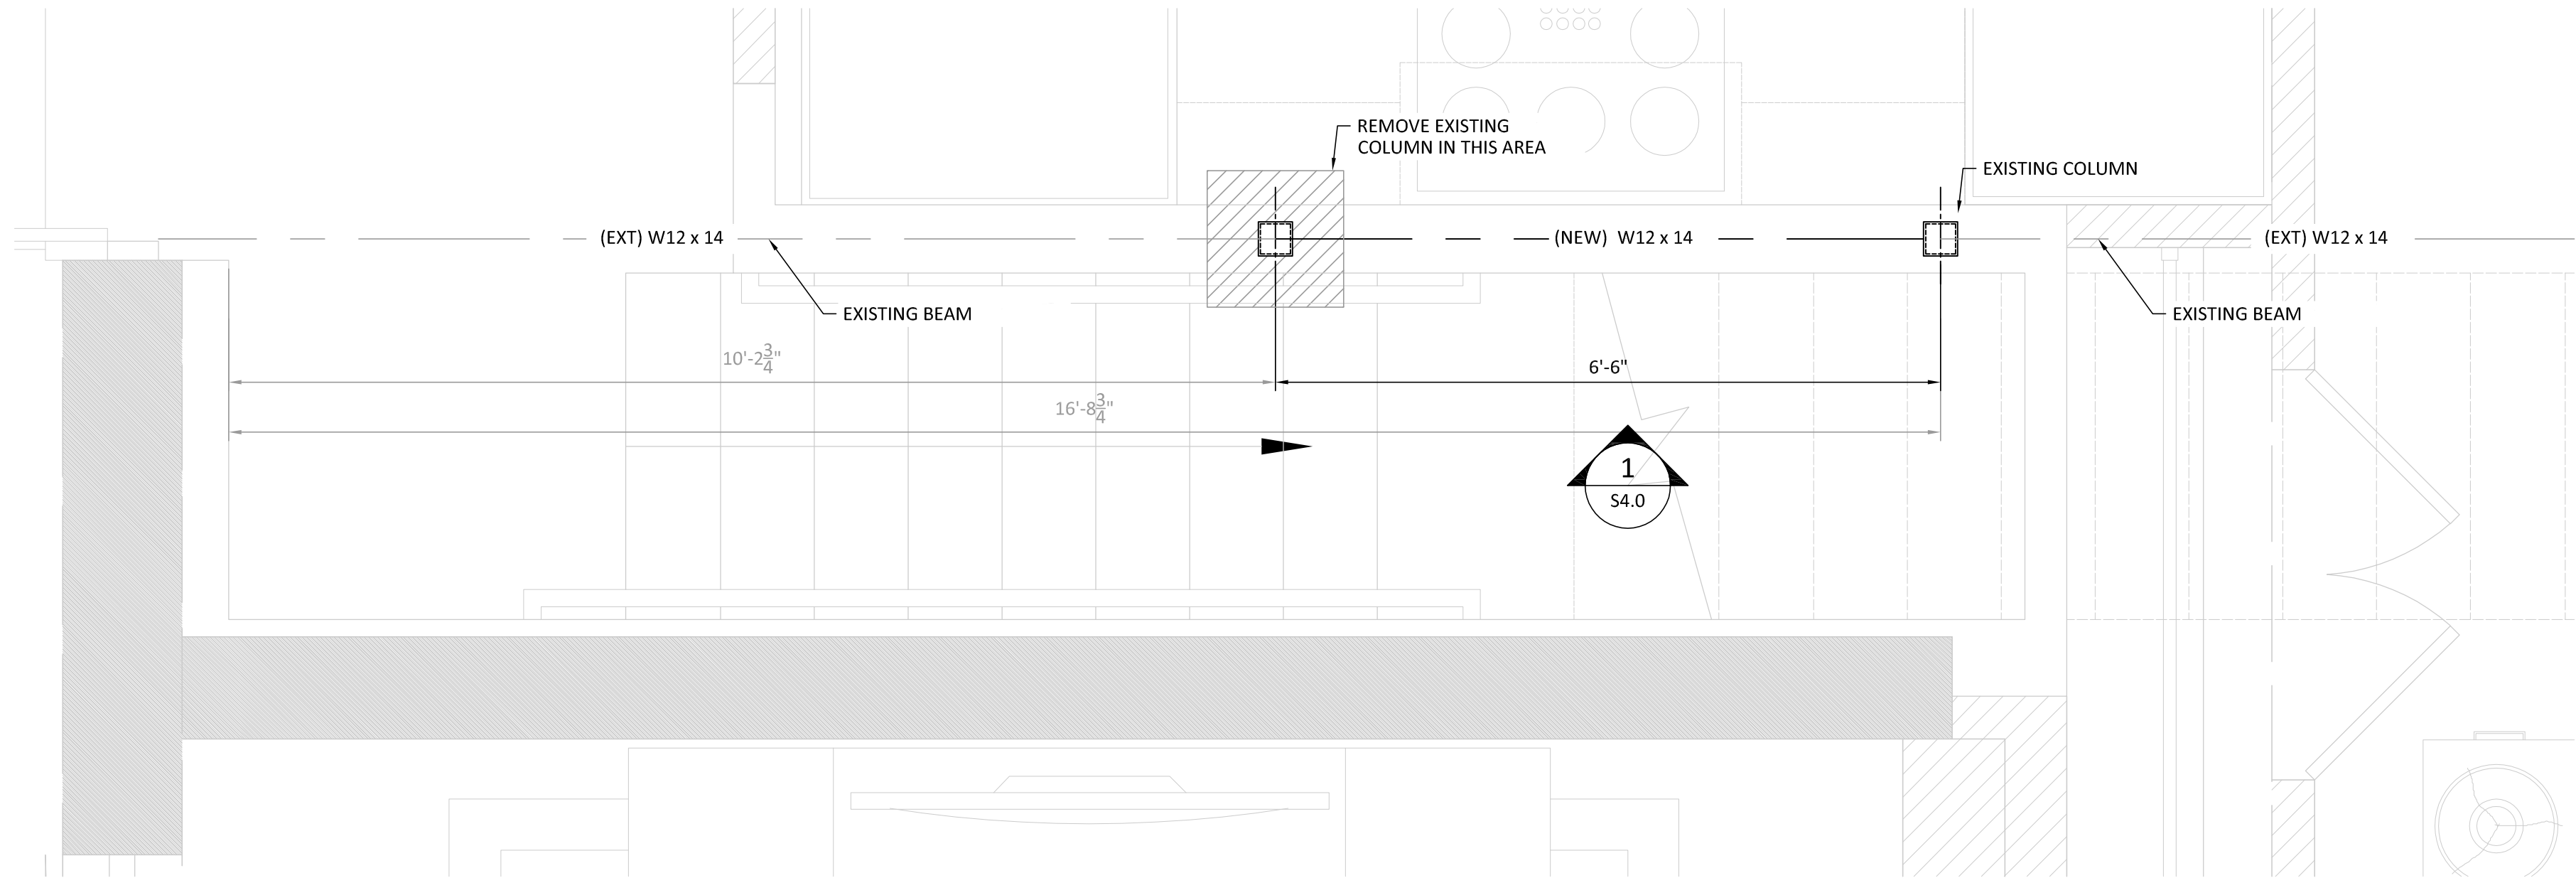
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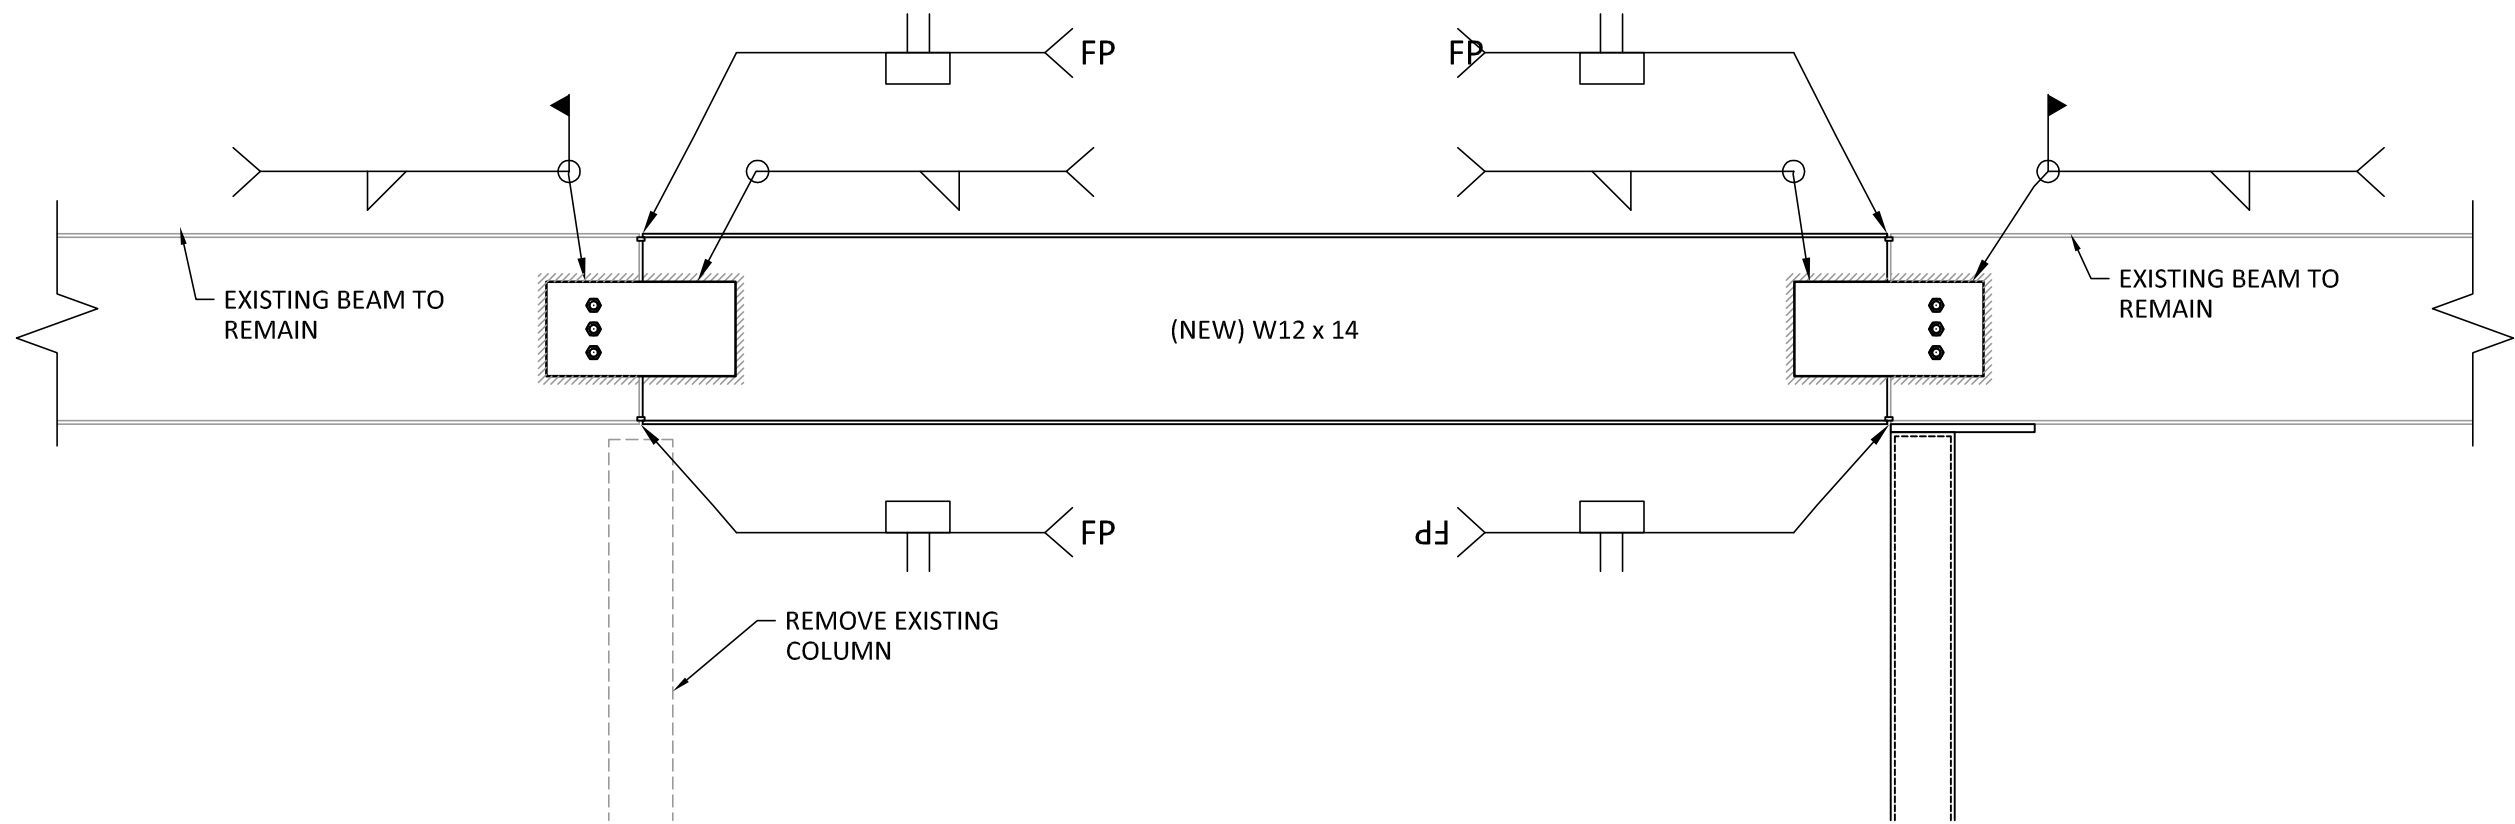
1" = 1'-0"





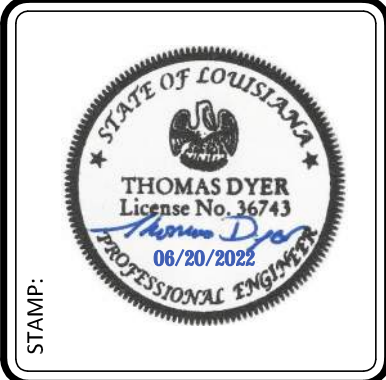

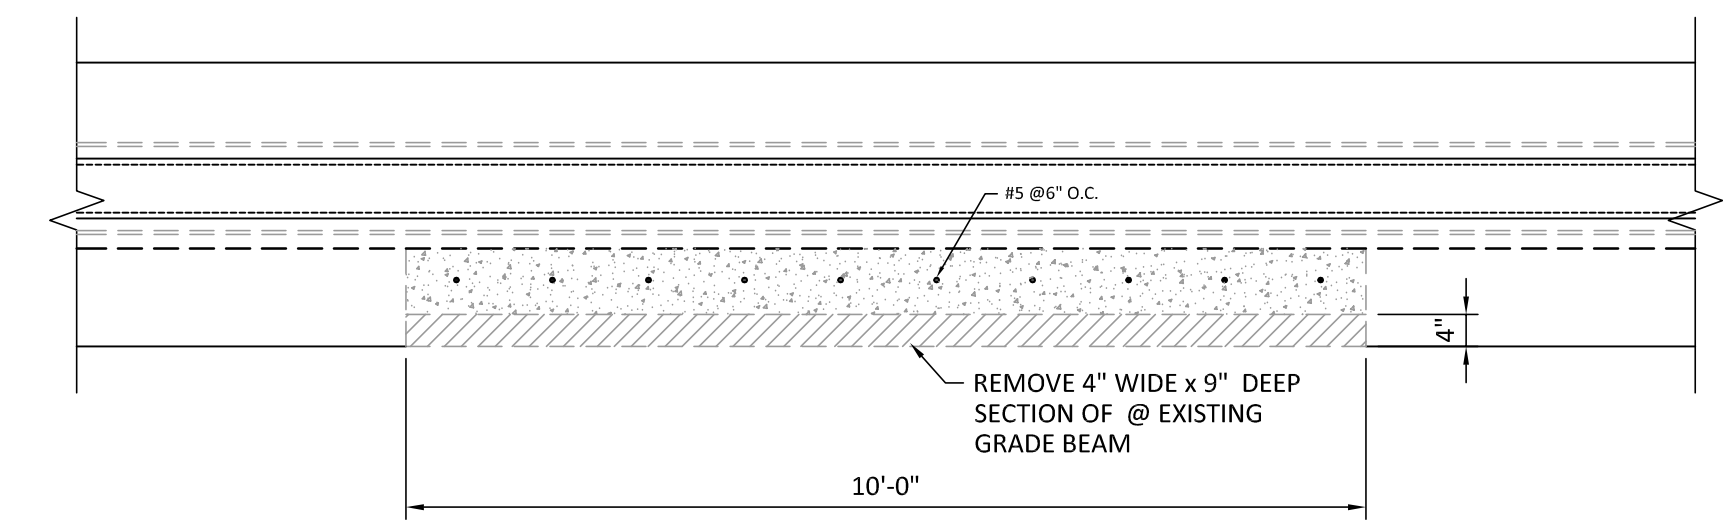REAR STAIR  
3/4" = 1'-0"





1 ELEVATION  
S4.0  
1" = 1'-0"

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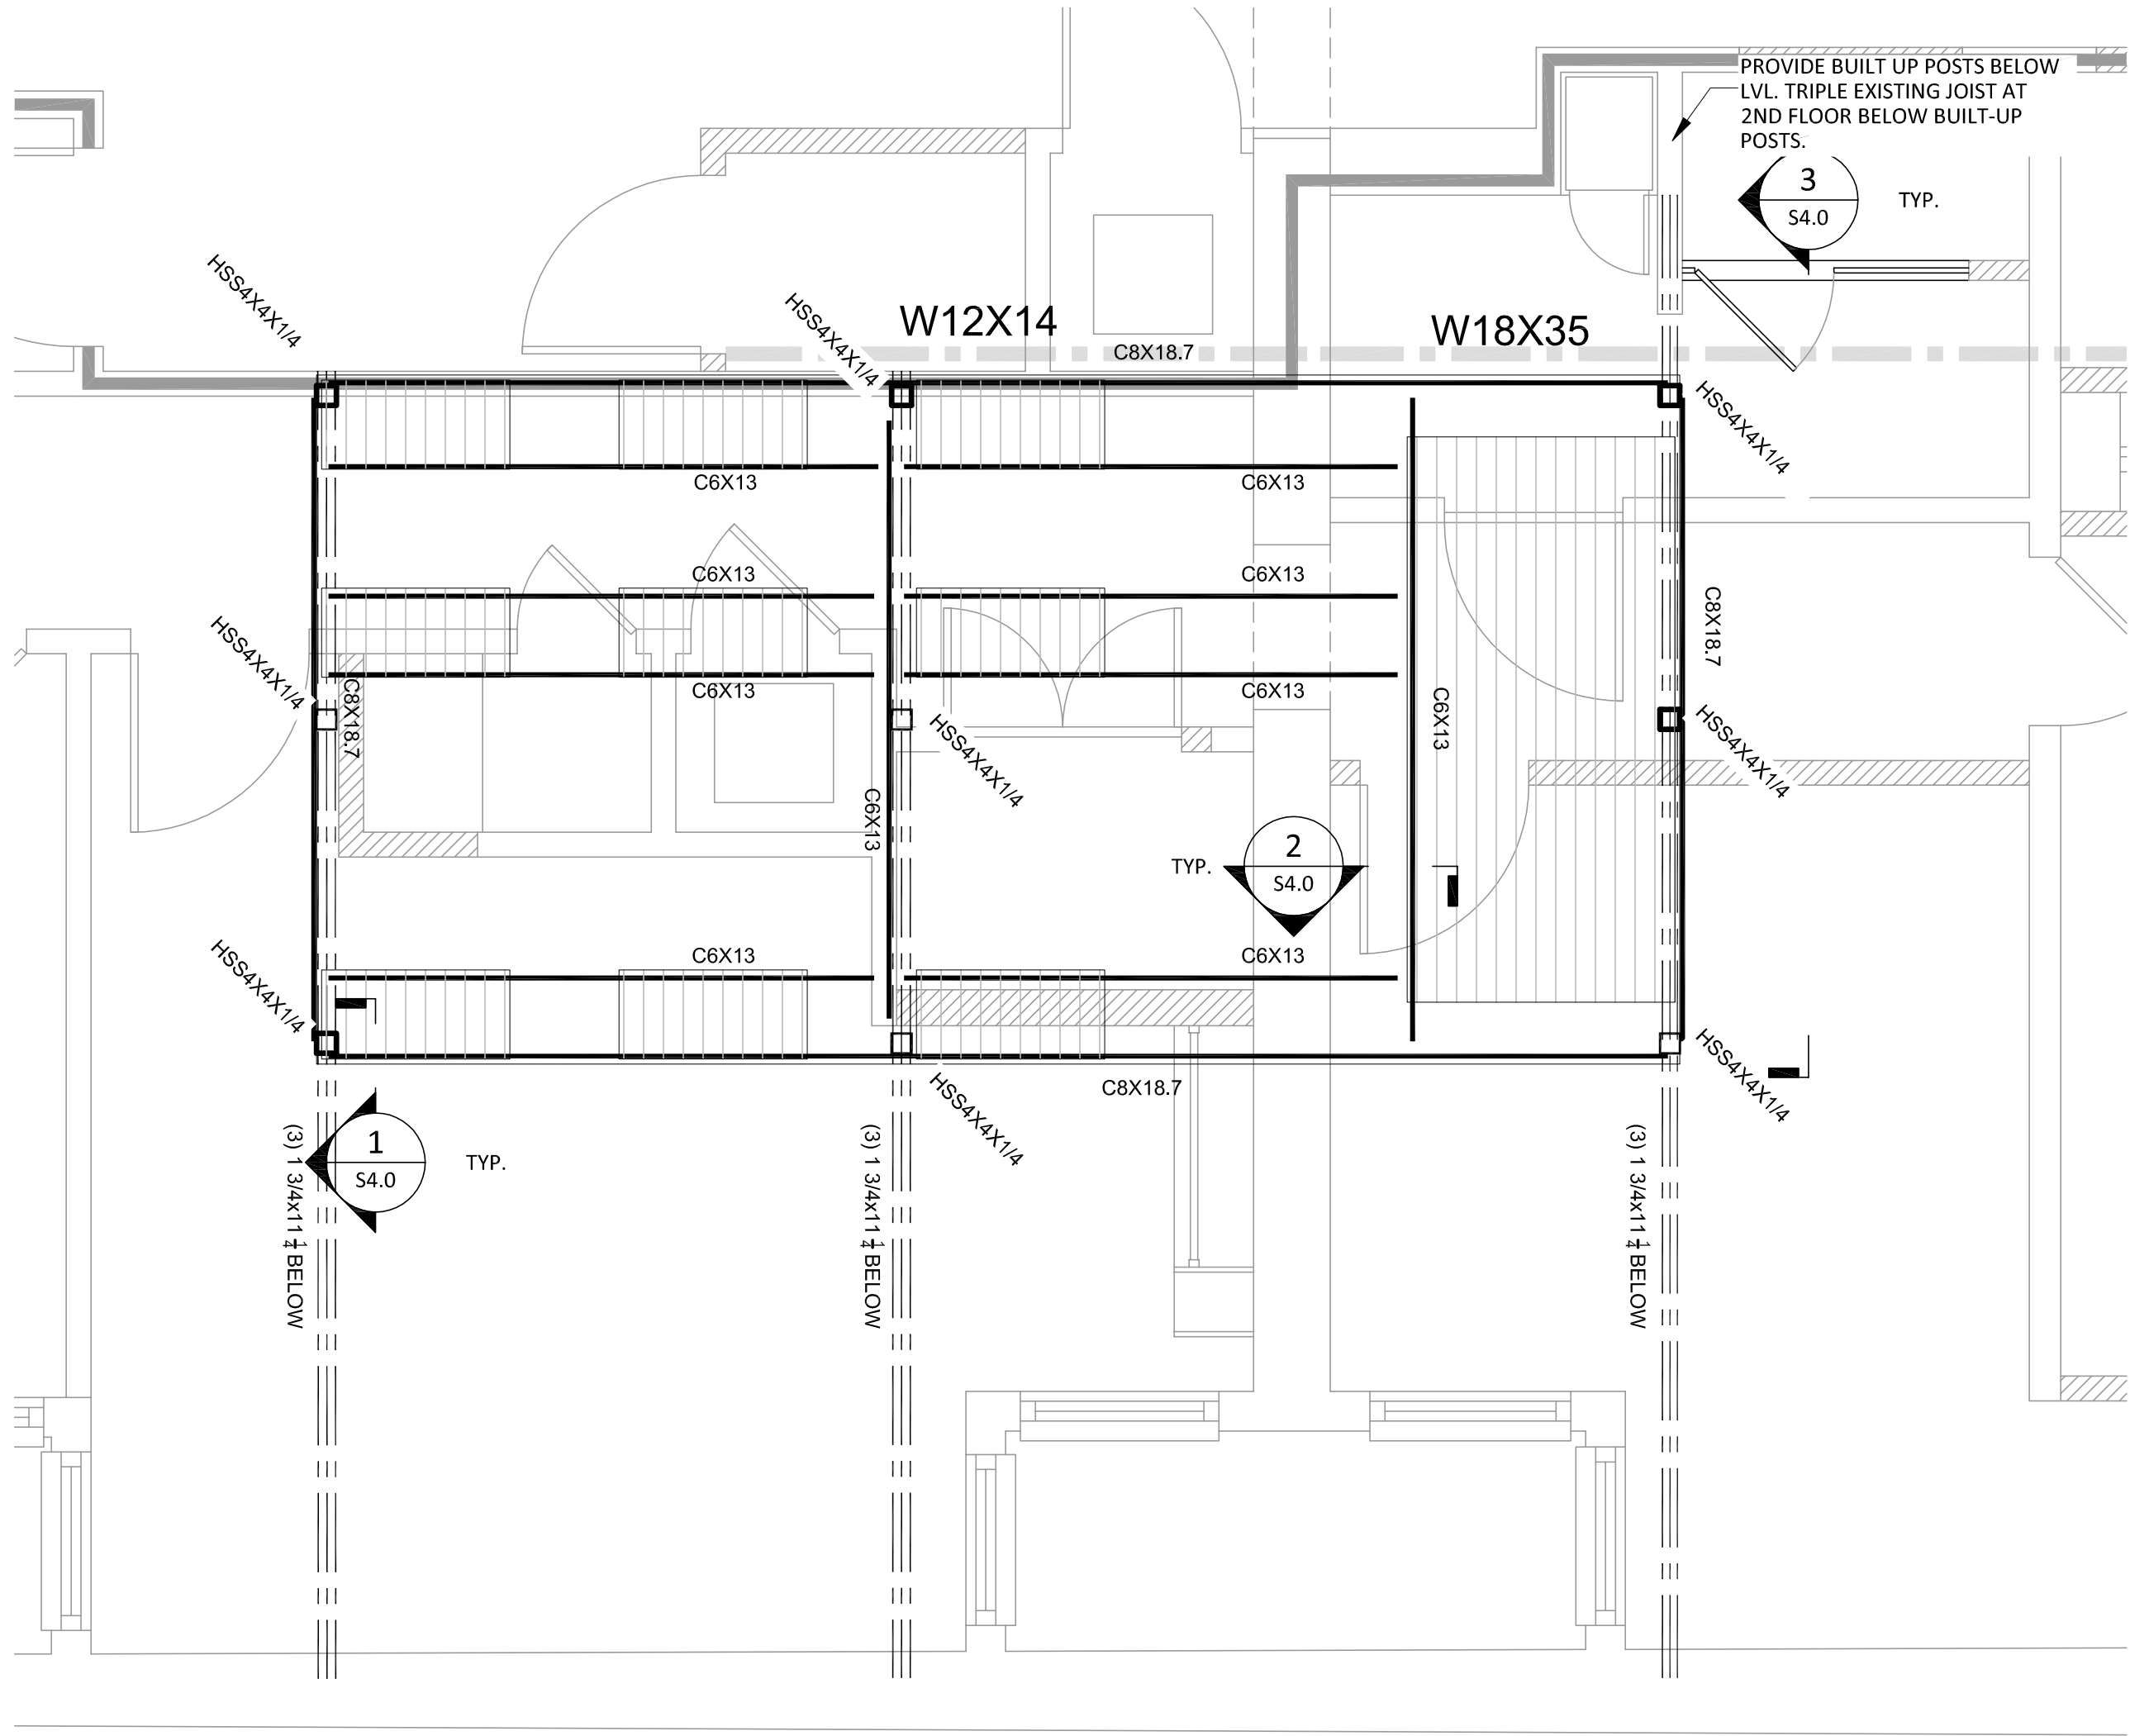
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JOB NO. 21020	DATE: 04/15/2021

747 ST CHARLES AVE  
RENOVATION - HOTEL PROJECT  
747 ST CHARLES AVE  
NEW ORLEANS, LA  
ELEVATOR DETAILS




NO.	DATE	REVISIONS	APP'D

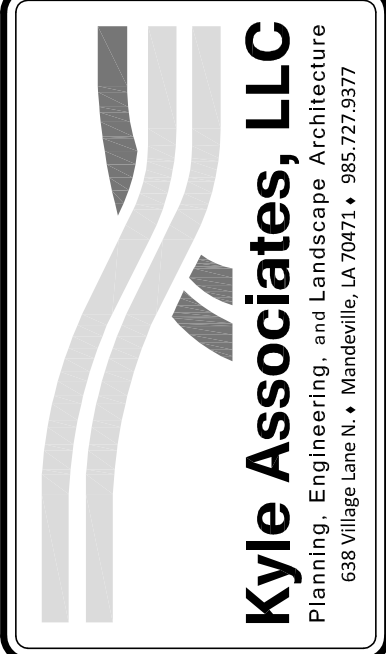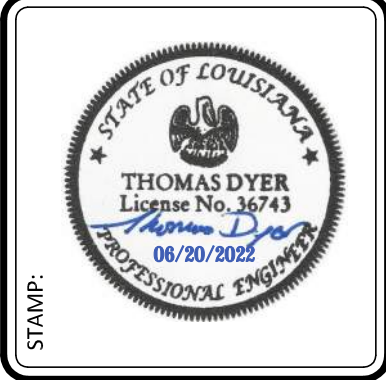

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S4.0



ROOFTOP MECHANICAL PLAN  
3/8" = 1'-0"

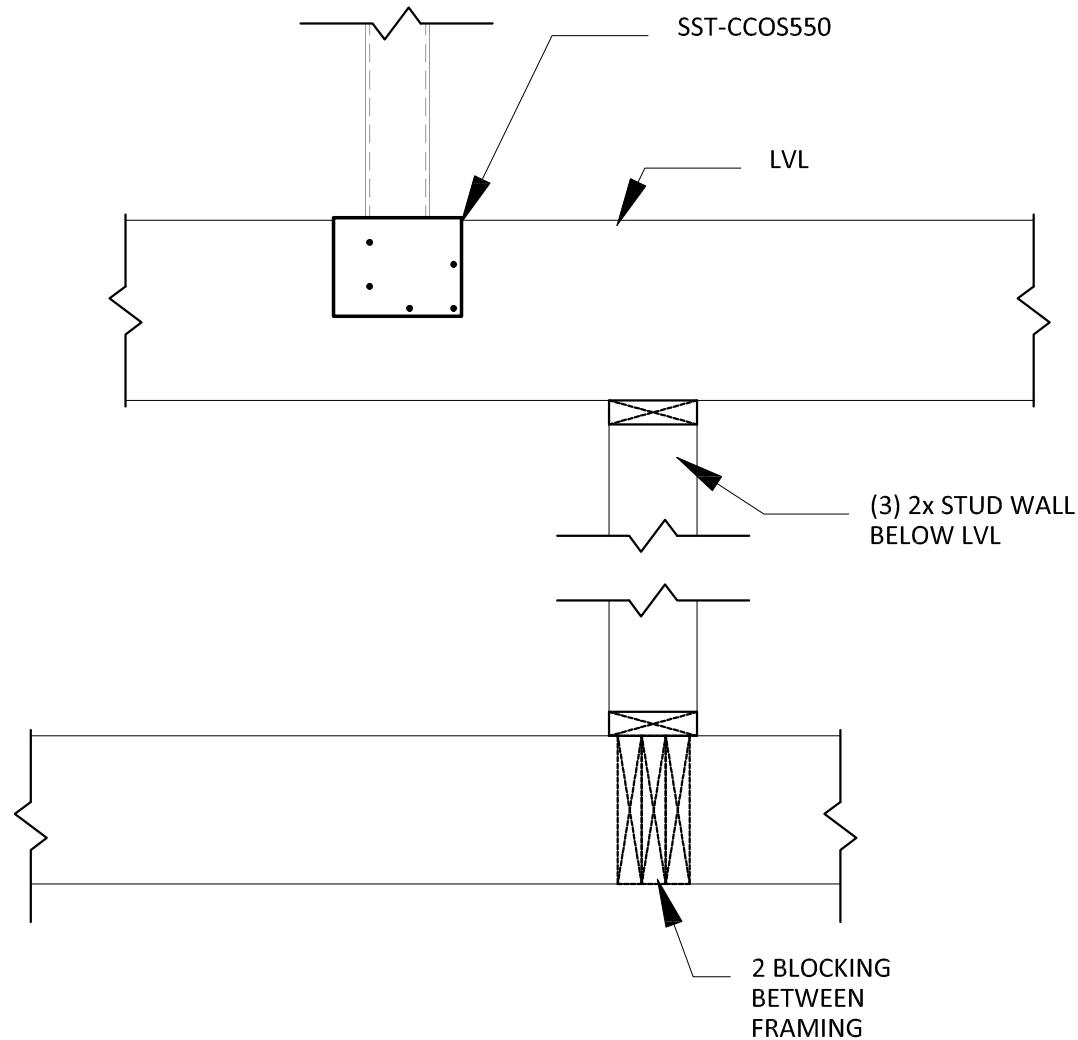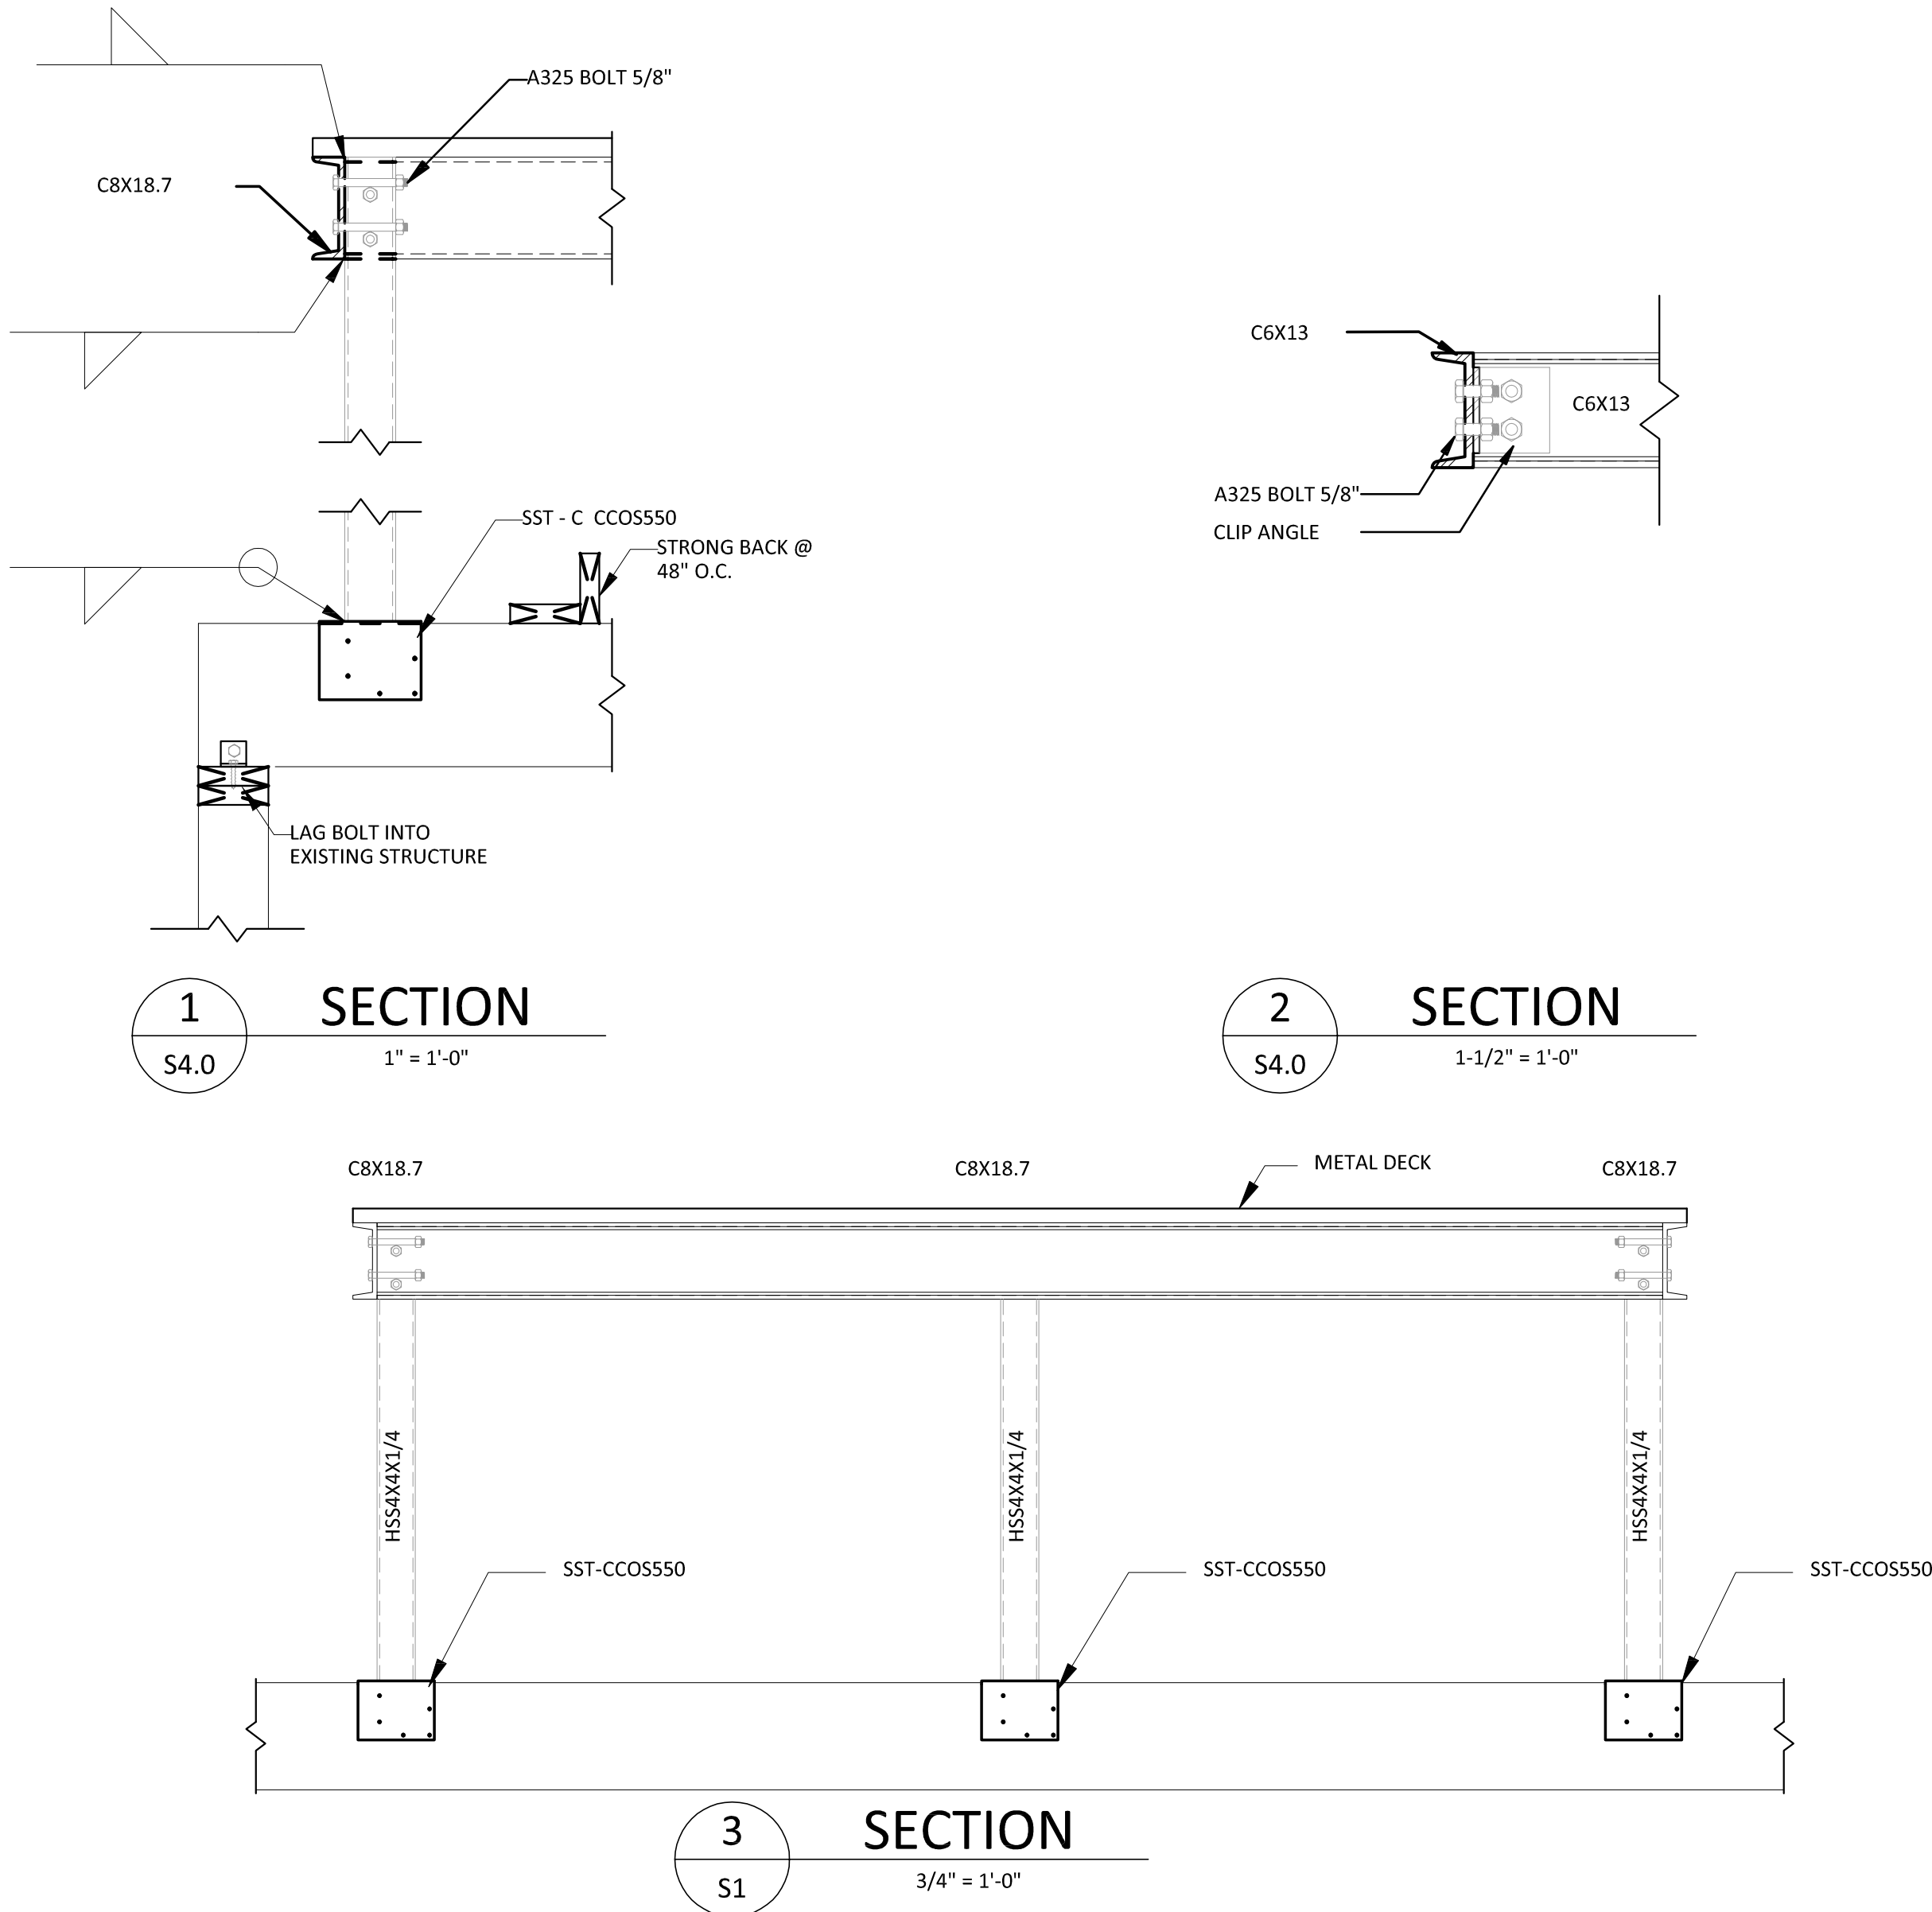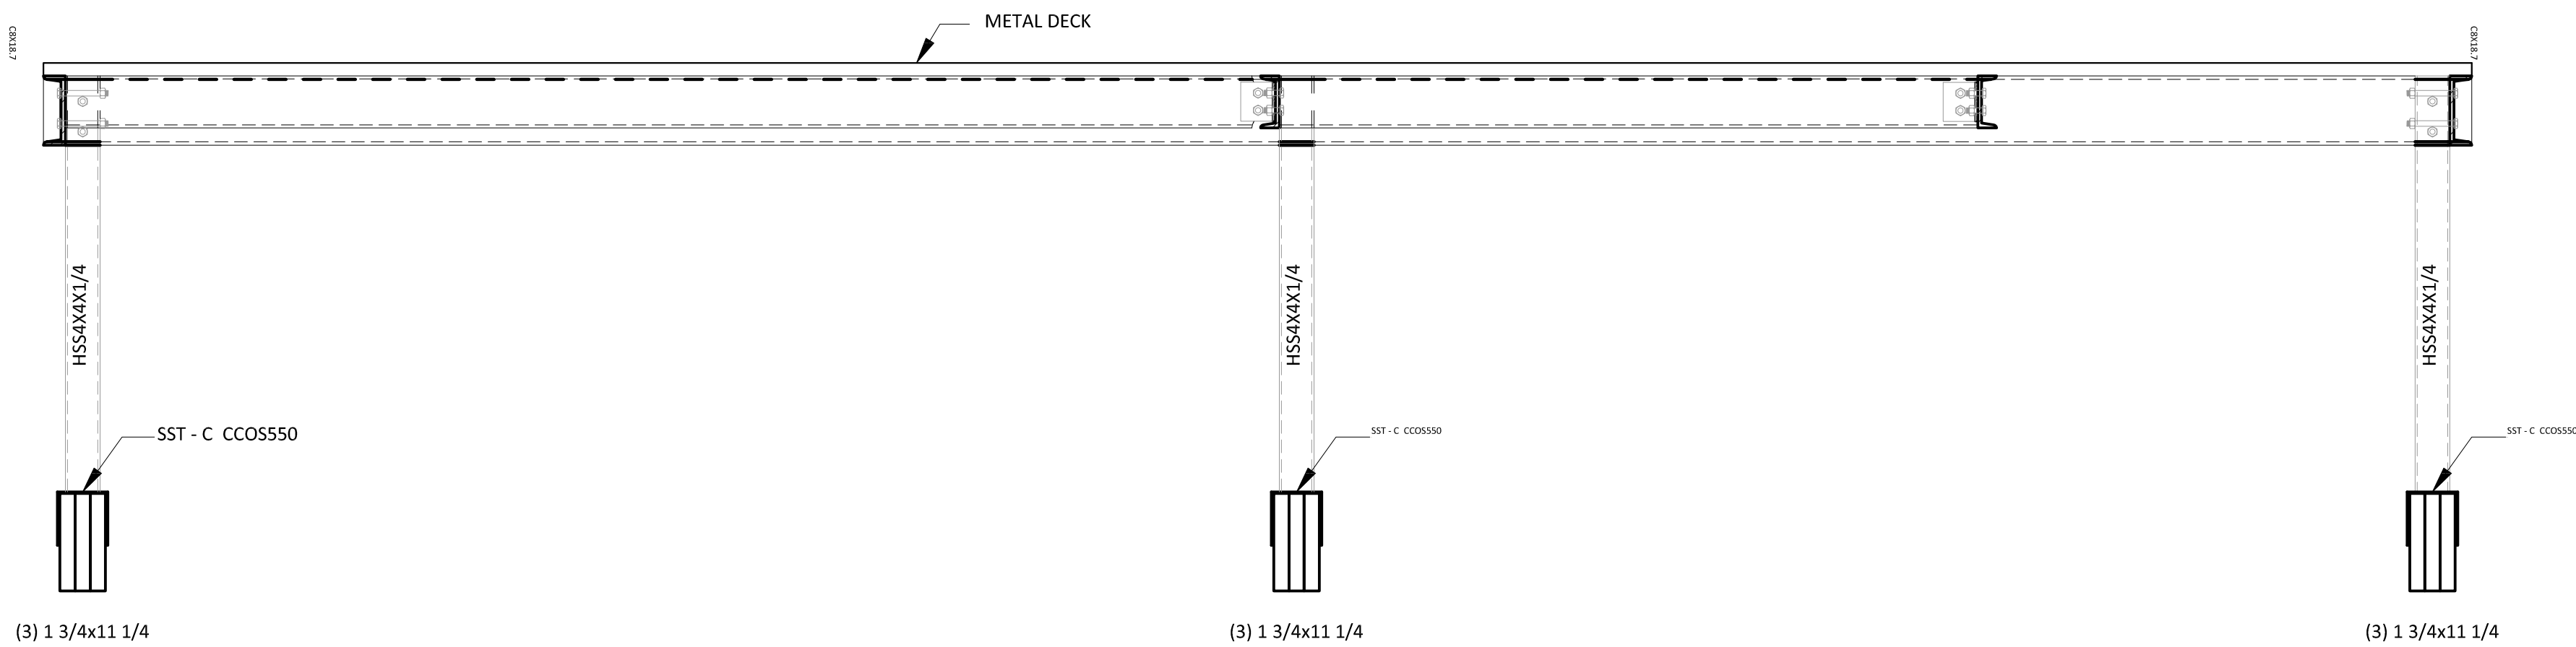


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747 ST CHARLES AVE  
RENOVATION - HOTEL PROJECT  
747 ST CHARLES AVE  
NEW ORLEANS, LA

MECHANICAL PLATFORM

NO.	DATE:	REVISIONS	APP'D




**Kyle Associates, LLC**  
Planning, Engineering, and Landscape Architecture  
635 Village Lane N. • Mandeville, LA 70471 • 985.272.2577

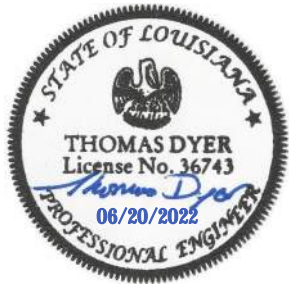SHEET NO.


S5.0



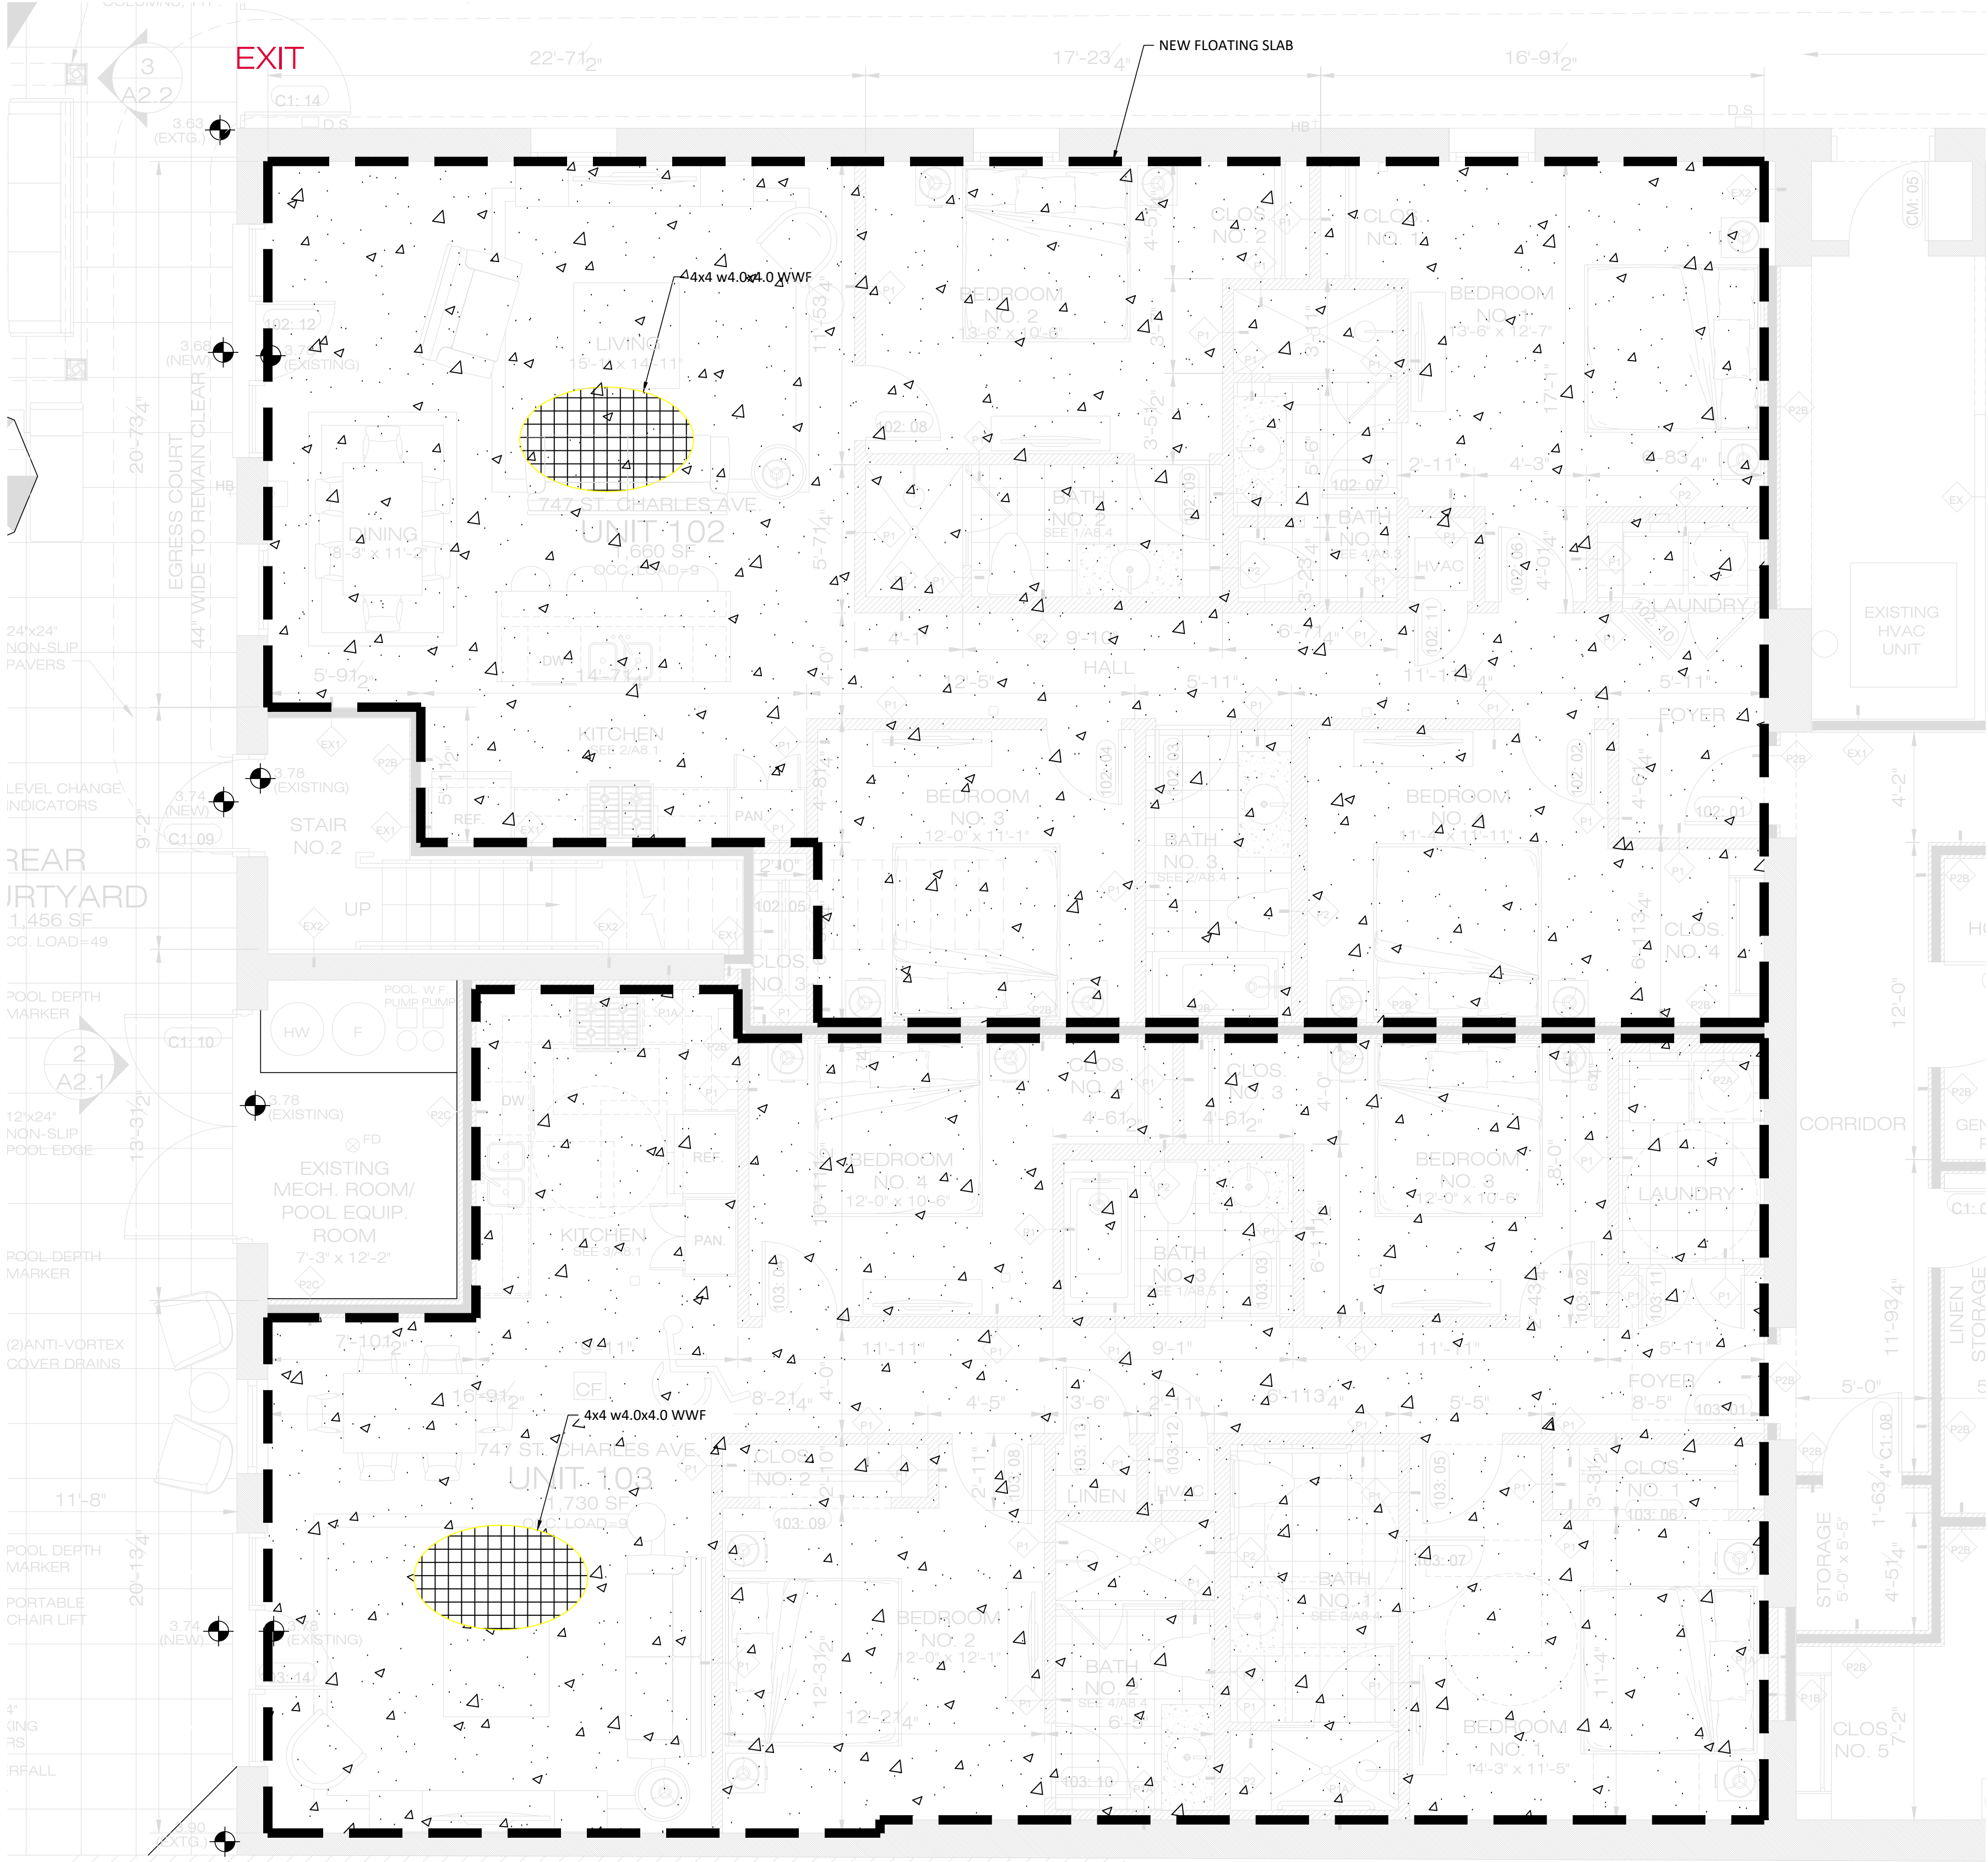

SLAB REPLACEMENT

1" = 1'-0"

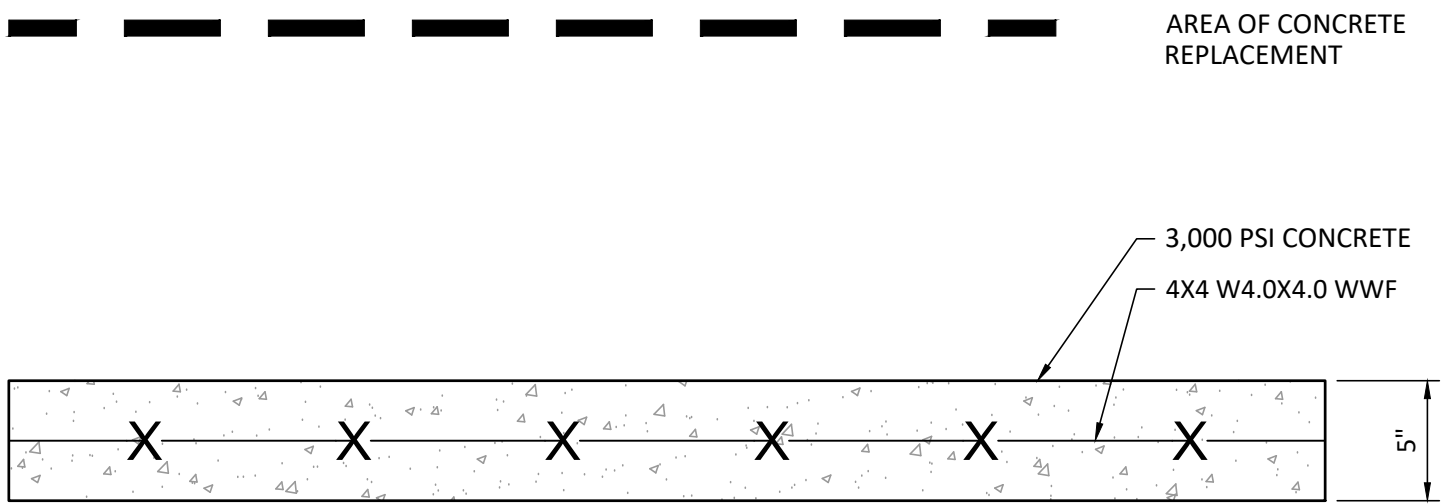

1 SECTION

S3.0 1" = 1'-0"

CADD FILE NAME:  
S6.0.dwg

DESIGNED BY:  
SAD

DRAWN BY:  
SAD

CHECKED BY:  
TD

JOB NO.  
21020

SCALE: (2X/3X)  
VARIES

SCALE: (1/16X/17)  
-

DATE:  
05/25/2022

747 ST CHARLES AVE  
RENOVATION - HOTEL PROJECT  
747 ST CHARLES AVE  
NEW ORLEANS, LA


TOILET ROOM & SHELTER FOUNDATION

NO.






DATE:

APPROVED

STATE OF LOUISIANA  
THOMAS DYER  
License No. 36743  
06/20/2022  
PROFESSIONAL ENGINEER

**Kyle Associates, LLC**  
Planning, Engineering, and Landscape Architecture  
605 Village Lane N. • Metairie, LA 70001 • 985.221.2377

SHEET NO.  
S6.0

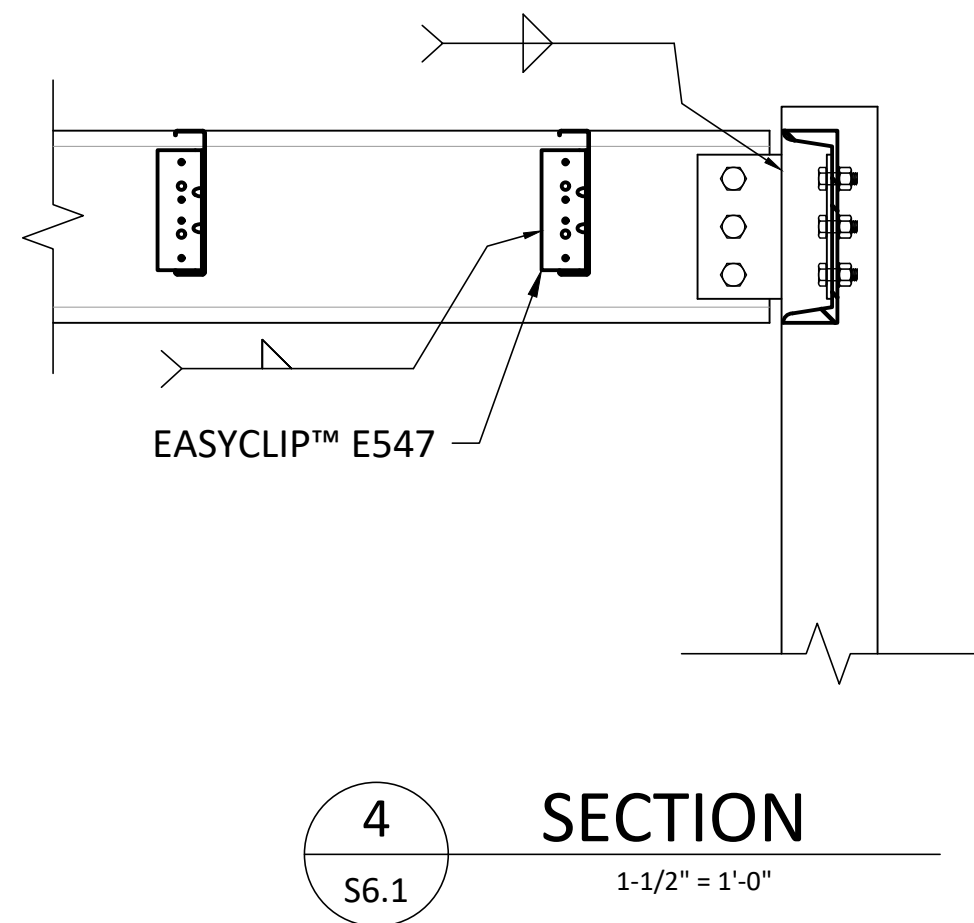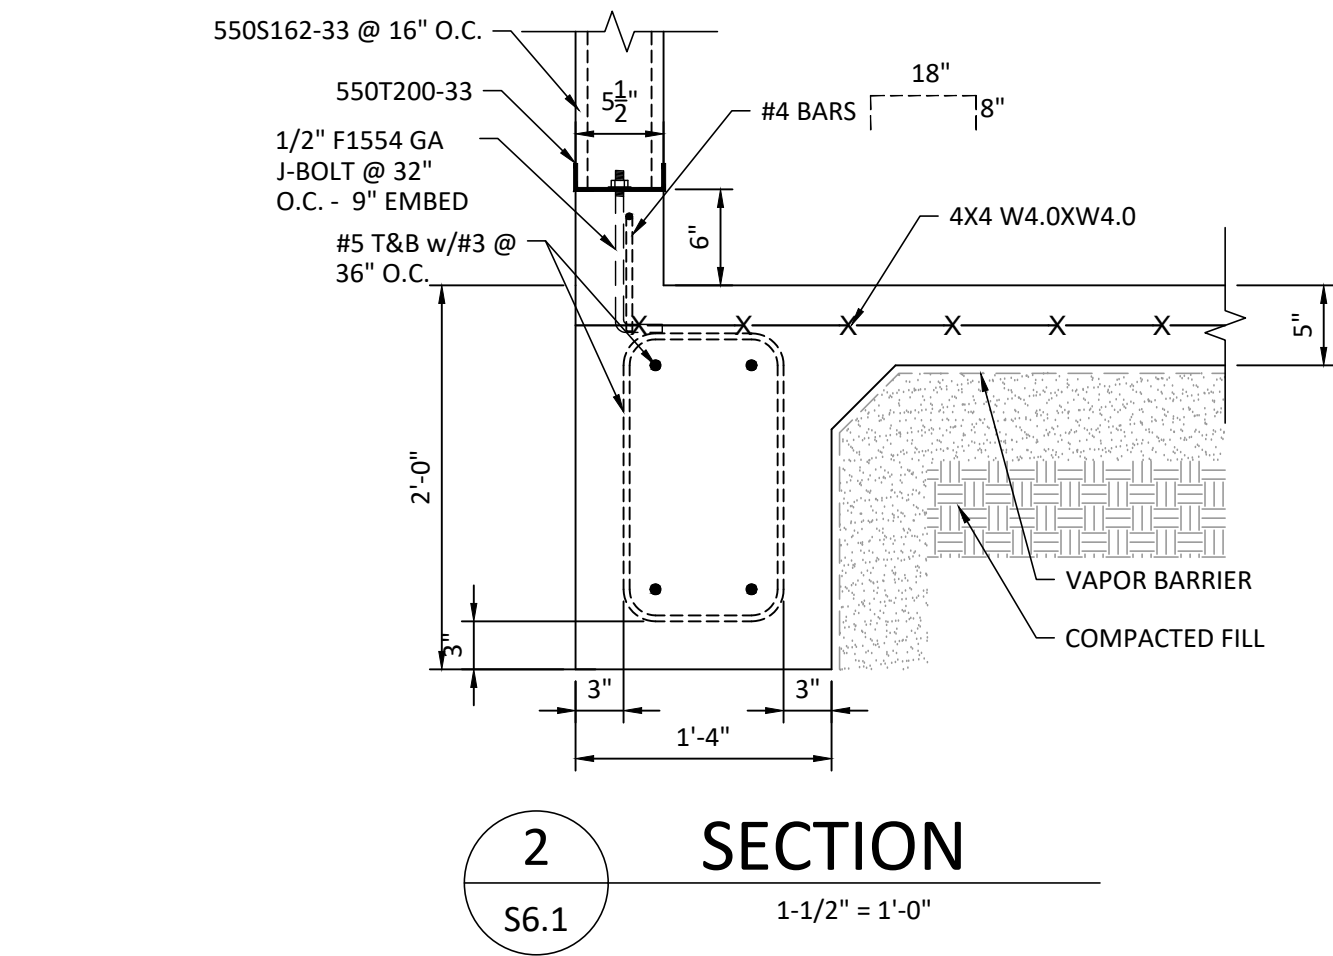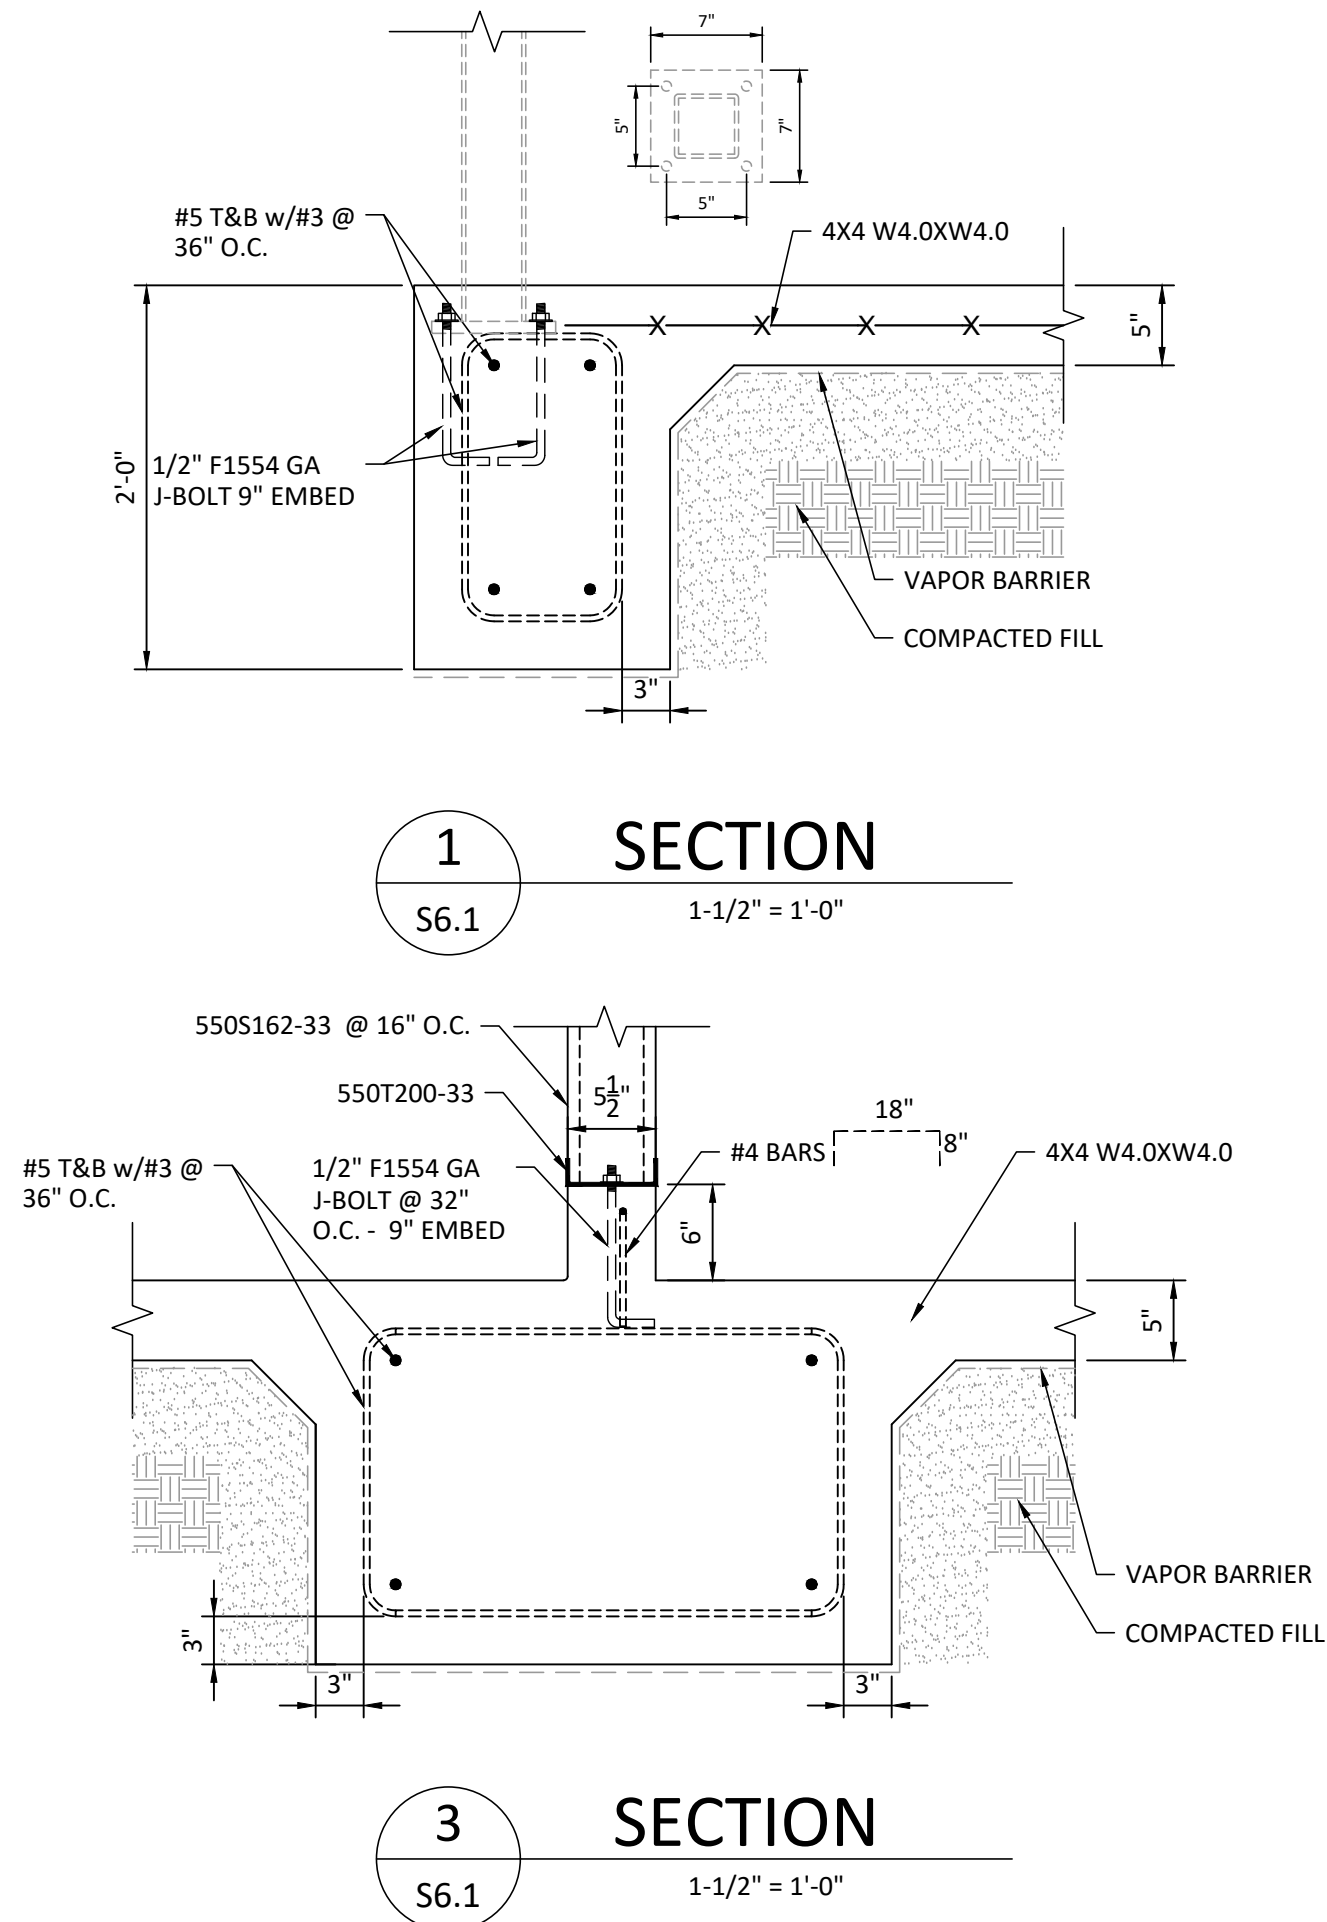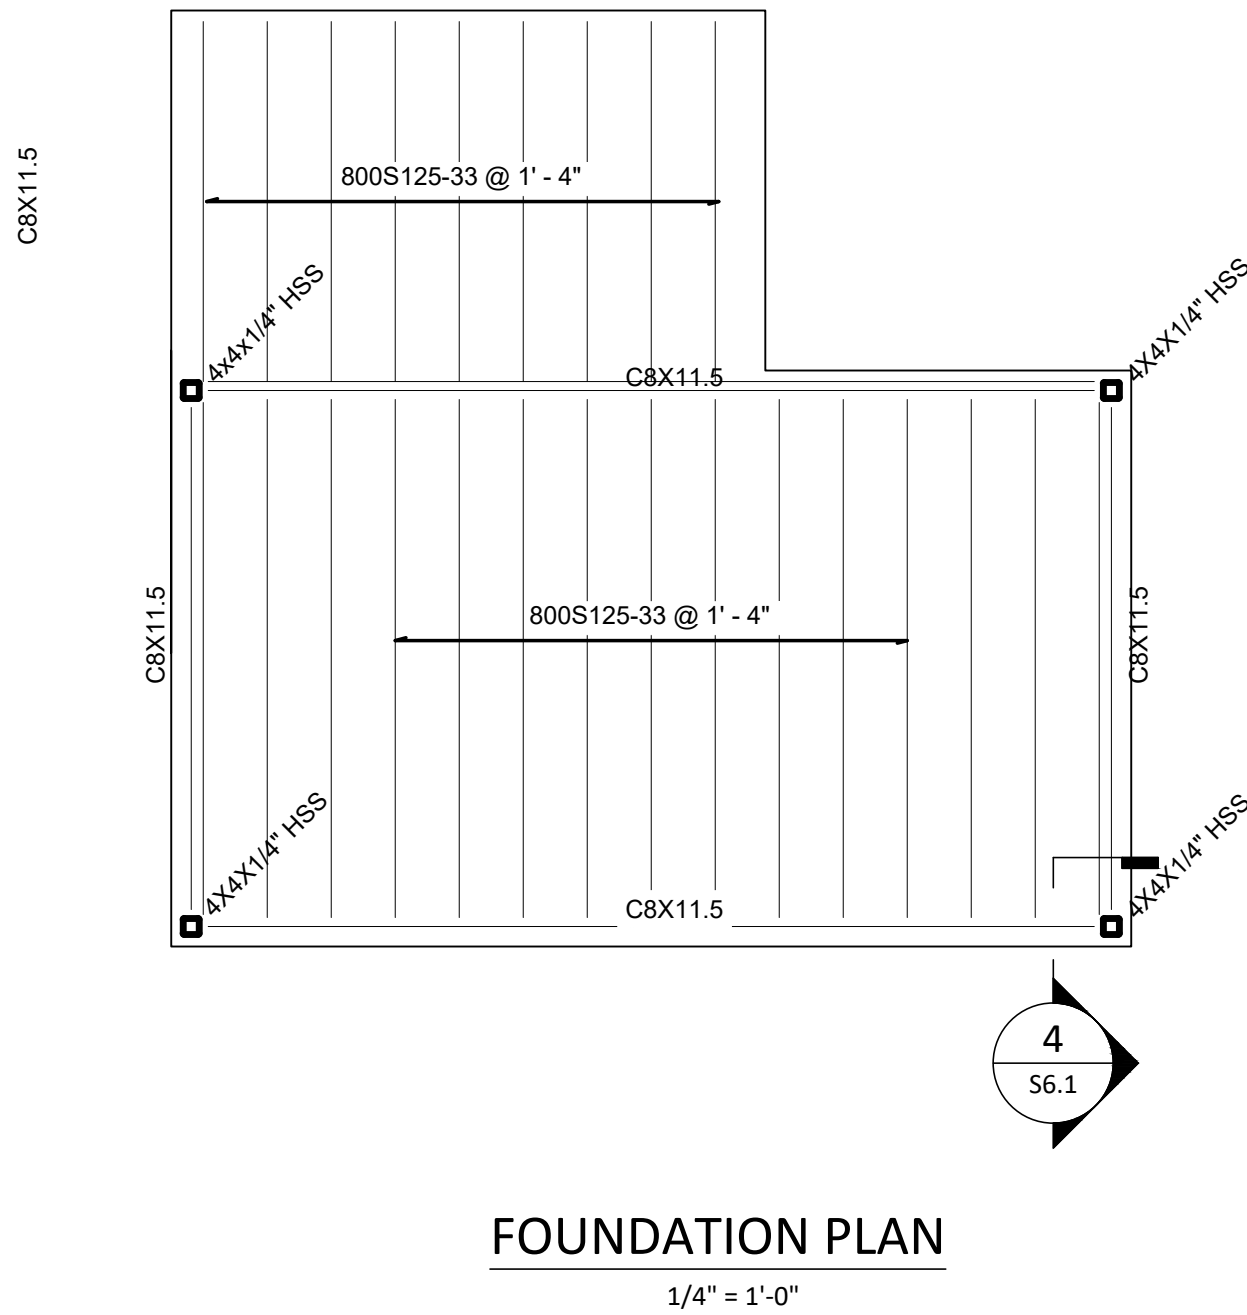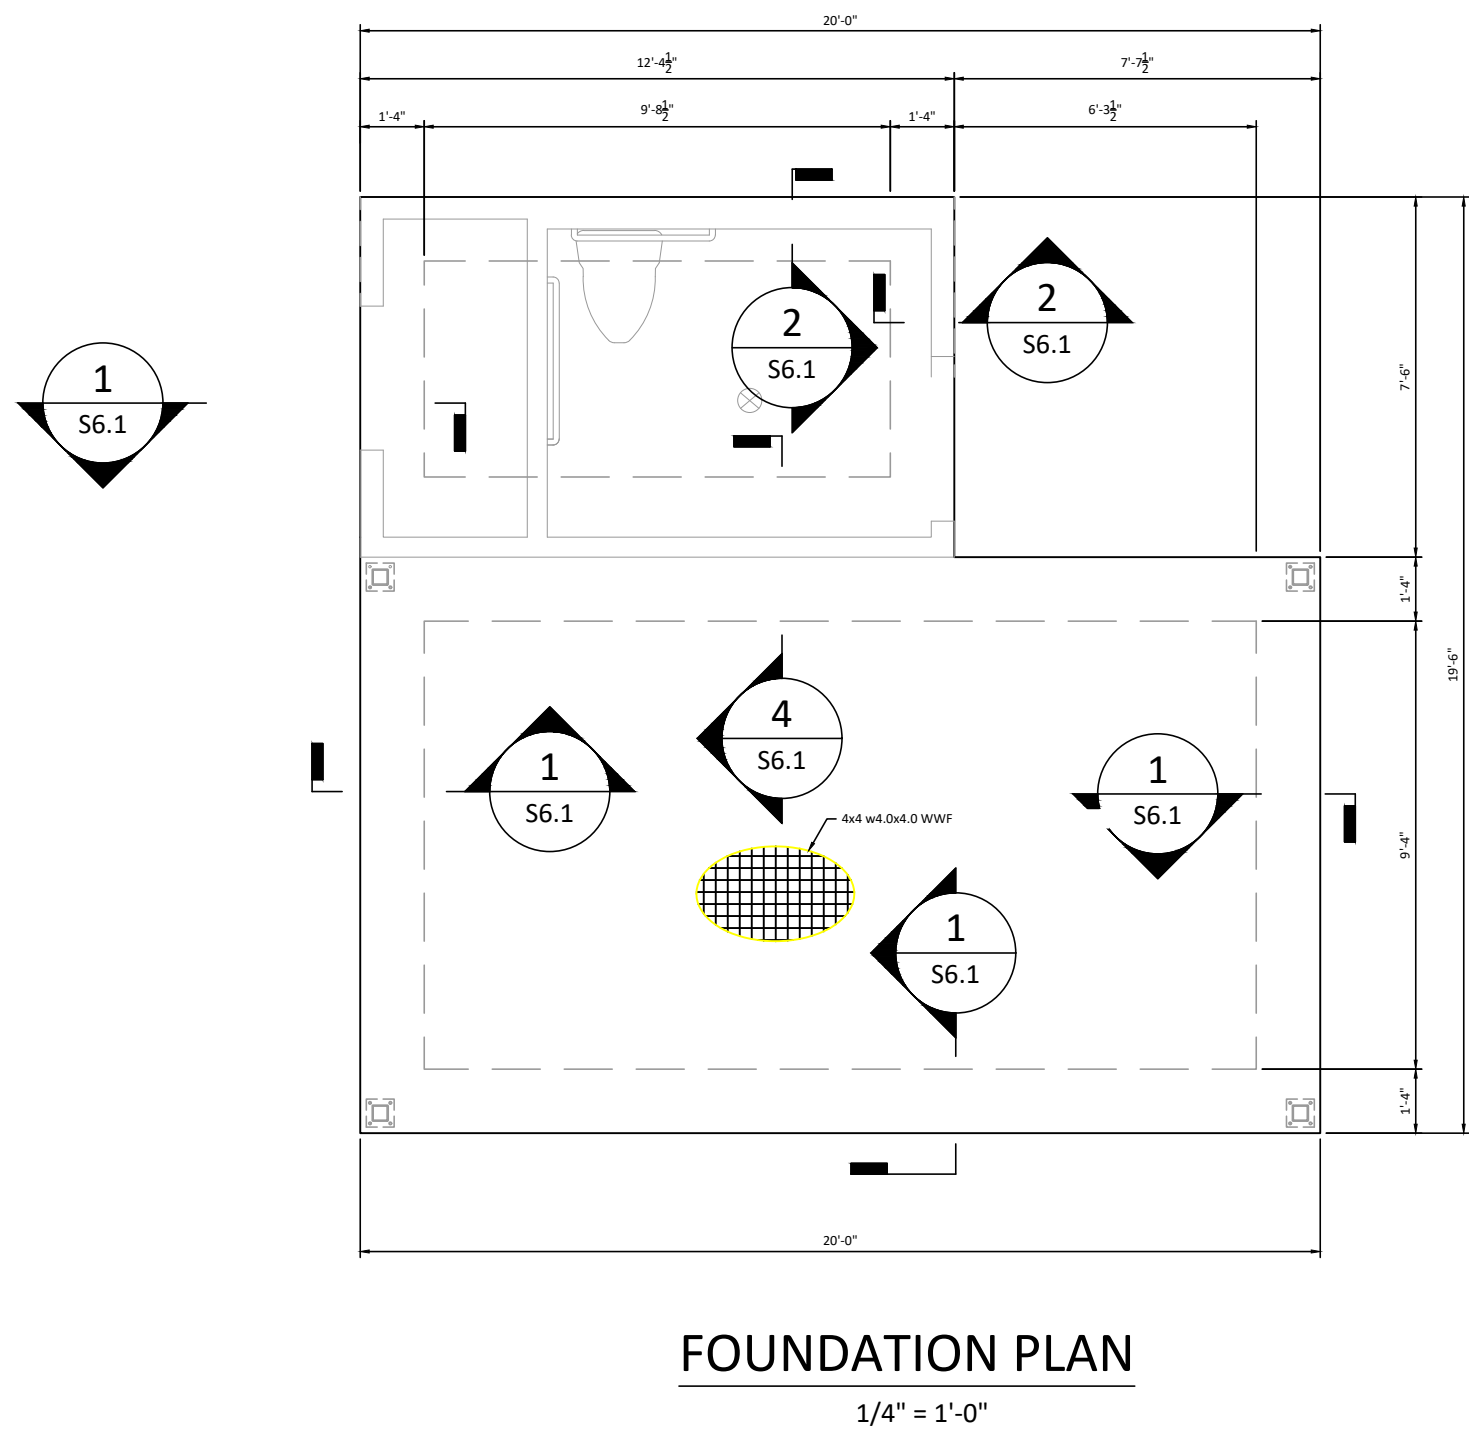

DESIGNED BY:	SAD	SCALE: (2X/3X)	VARIABLES
DRAWN BY:	SAD	SCALE: (11X/17)	
CHECKED BY:	TD		
JOB NO.	21020	DATE:	05/25/2022

747 ST CHARLES AVE  
RENOVATION - HOTEL PROJECT  
747 ST CHARLES AVE  
NEW ORLEANS, LA

TOILET ROOM & SHELTER FOUNDATION

NO.	DATE:	REVISIONS	APP'D

