#### **MAY VERSION 1**

LEFT SIDE WALL EXTRUSION EXTENDS TO GROUND

CUTOUT ON GROUND FLOOR HAS VERTICAL SHEATHING TO RELATE TO THE ADJACENT VERTICAL SCREEN



#### APRIL ARC MEETING RENDERING


The ARC voted to defer your application for additional review. The ARC agreed that the following changes should be made:

- · Extend the left side of the cantilevered second story wall down to the first floor to break up the massing on the front façade.
- Remove the Juliet balcony and make it either a true balcony or a deeply recessed window.
- At the side hall area at the first-floor entry, extend the vertical pickets up to give the impression of an enclosed space. Allow the pickets to frame the space like a gate.
- Add more operable windows throughout.


#### **MAY VERSION 2**

CONCRETE PLANTER BASE WRAPS AS PLINTH FOR LEFT SIDE WALL EXTRUSION

HORIZONTAL SIDING ON GROUND FLOOR WRAPS INSIDE CORNER AROUND LEFT SIDE WALL EXTRUSION

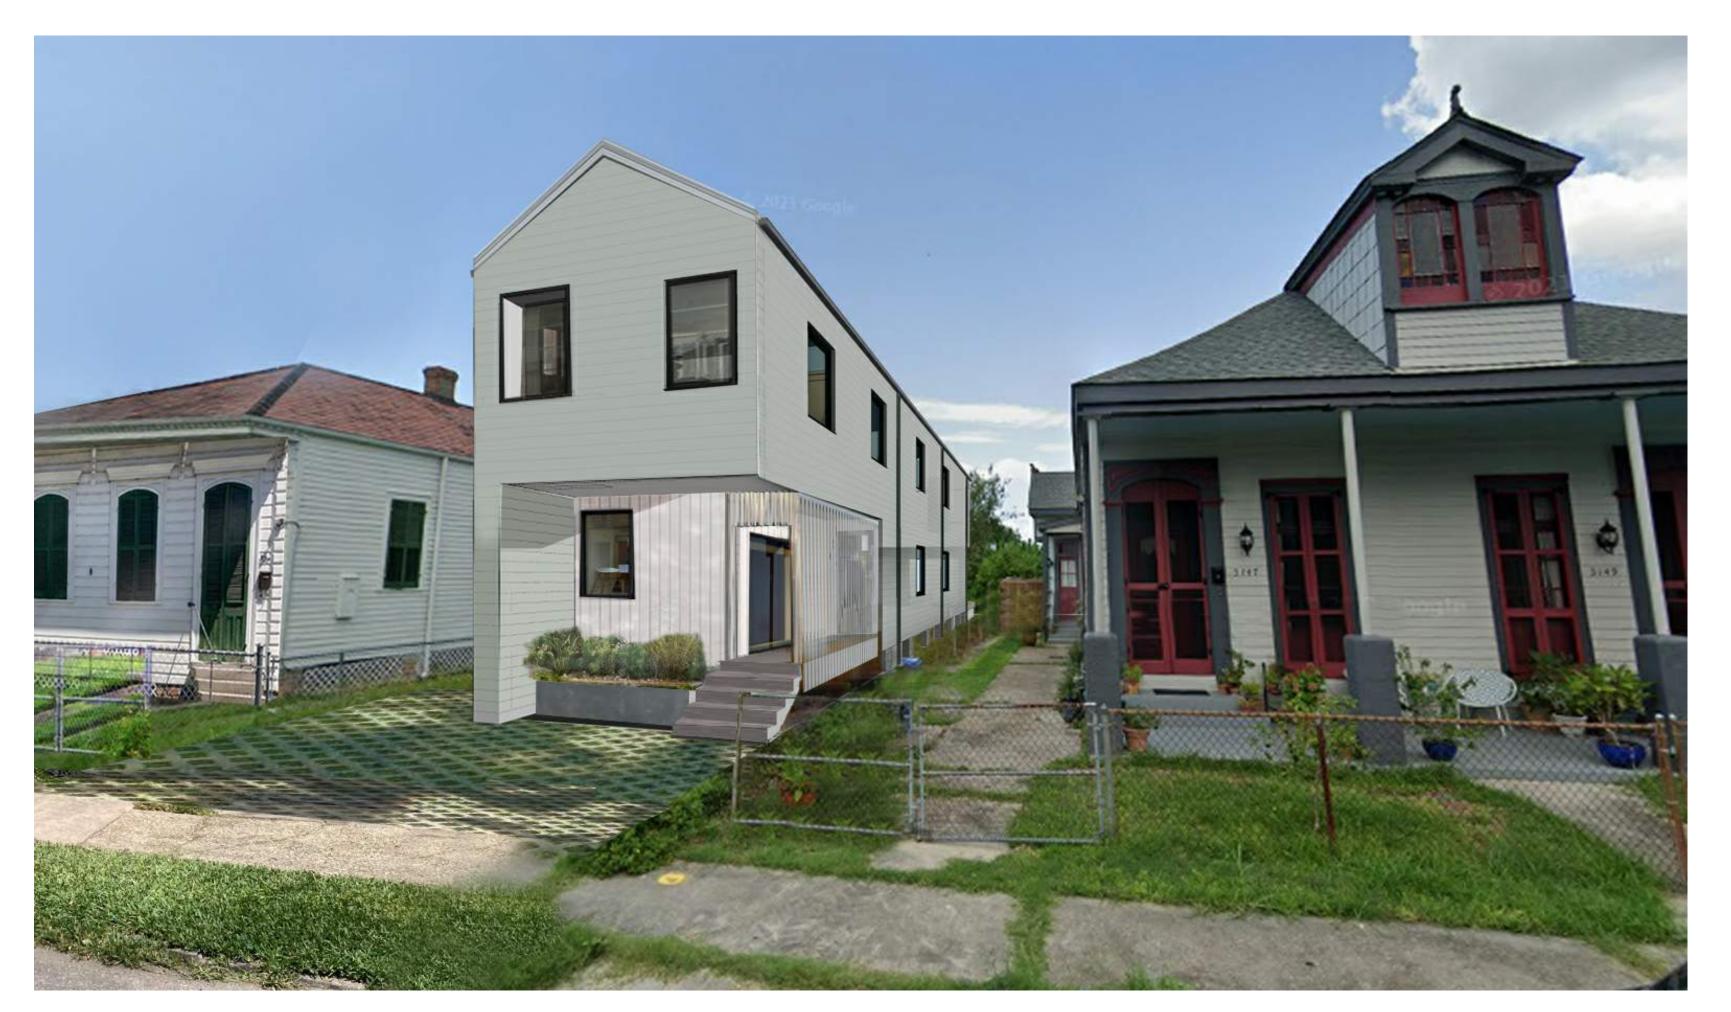

FRONT FENCE REMOVED FOR CLARITY

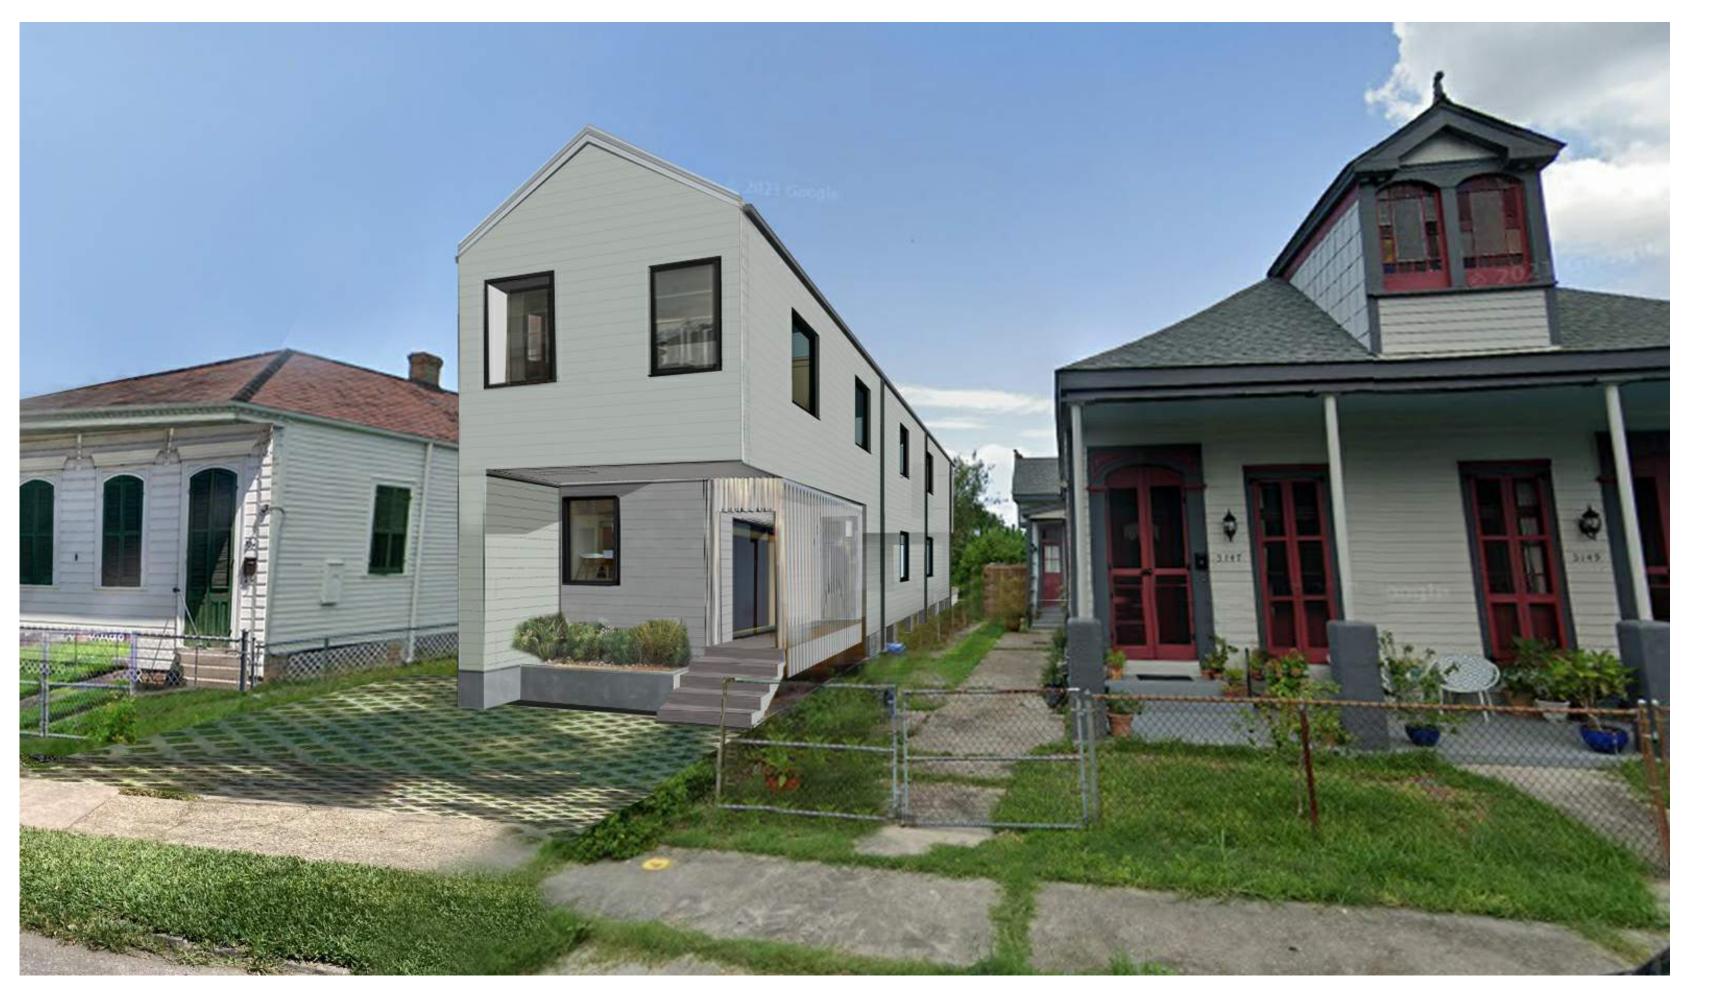

FRONT FENCE REMOVED FOR CLARITY

### **URQUHART HOUSE**

3145 Urquhart St. New Orleans, LA, 70117

## marais

marais architects llc

ARCHITECT: MARAIS ARCHITECTS, LLC jared@maraisdesignbuild.com

**ISSUANCE:** 

ARC REVIEW MAY 05.17.22

SHEET TITLE:

Rendering

SHEET NUMBER:


ARC-1

DATE:

SCALE:

FOR PERMIT

1 1/2" =

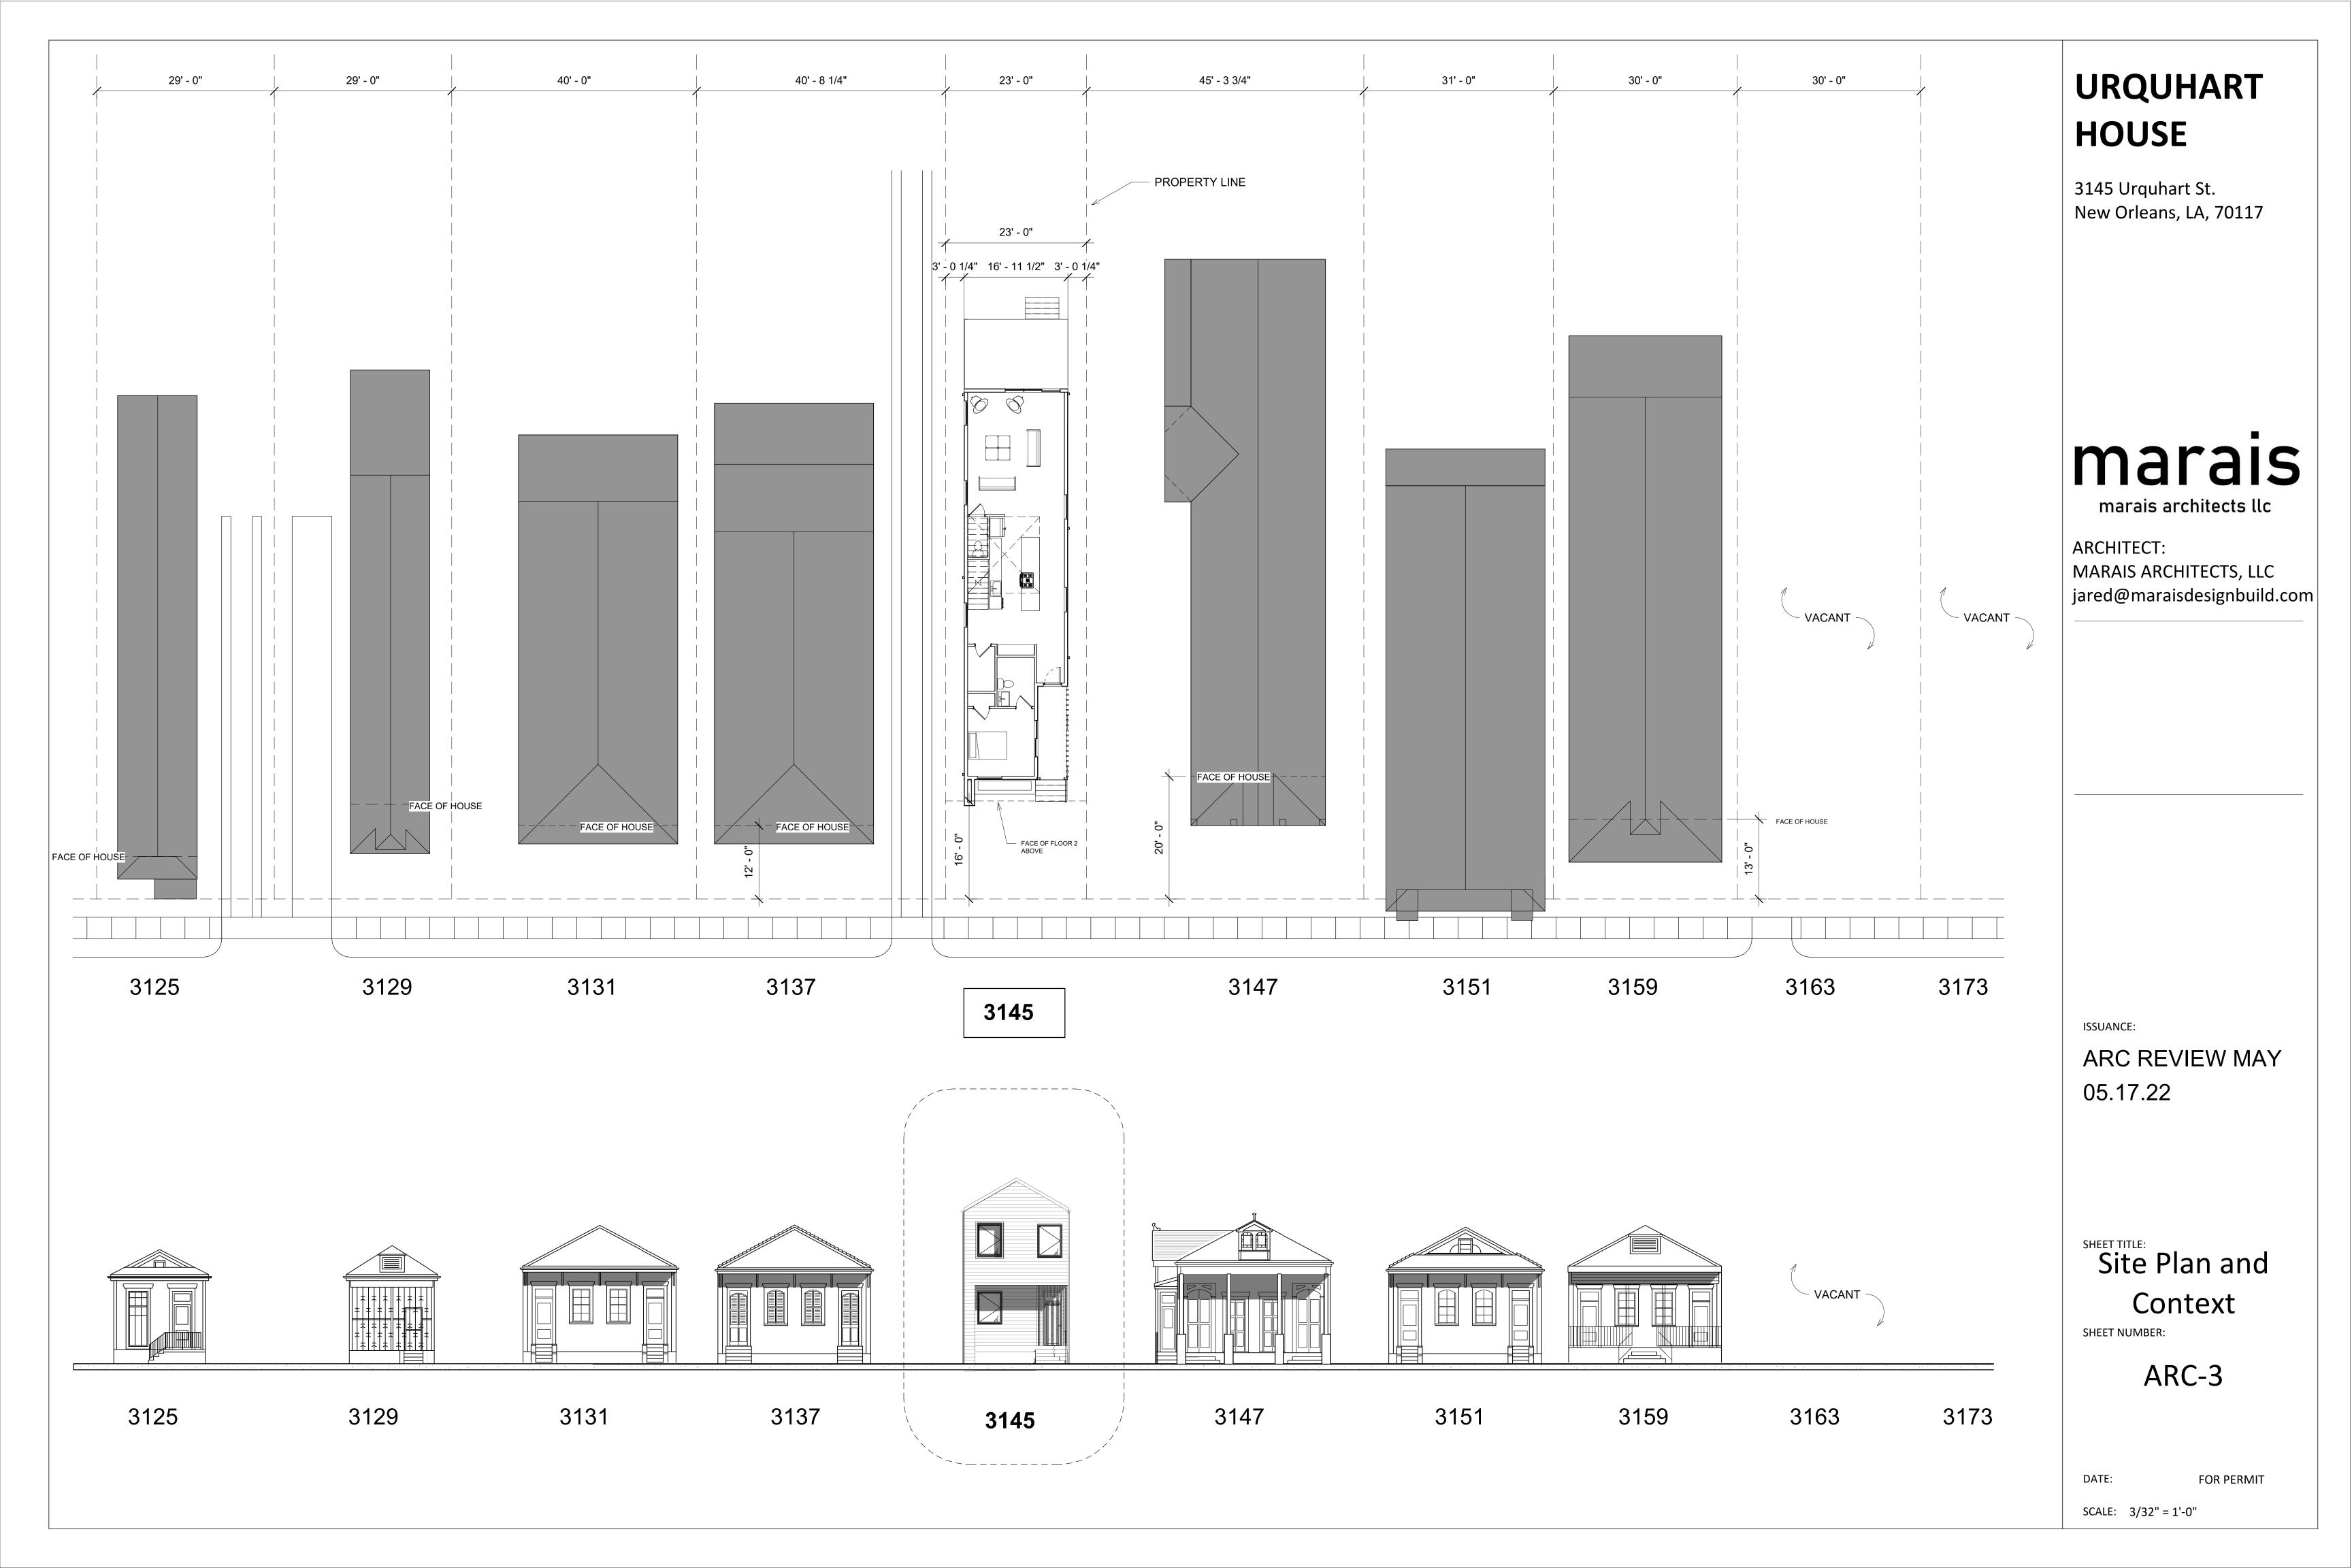





Urquhart - Rear Elevation

2 Urquhart - Right Side



Urquhart - Right Side



3 Urquhart - Front Elevation

## URQUHART HOUSE

3145 Urquhart St. New Orleans, LA, 70117

## marais

marais architects llc

ARCHITECT:
MARAIS ARCHITECTS, LLC
jared@maraisdesignbuild.com

ISSUANCE:

ARC REVIEW MAY 05.17.22

SHEET TITLE:

### Renderings


SHEET NUMBER:


ARC-4

DATE:


SCALE:

FOR PERMIT

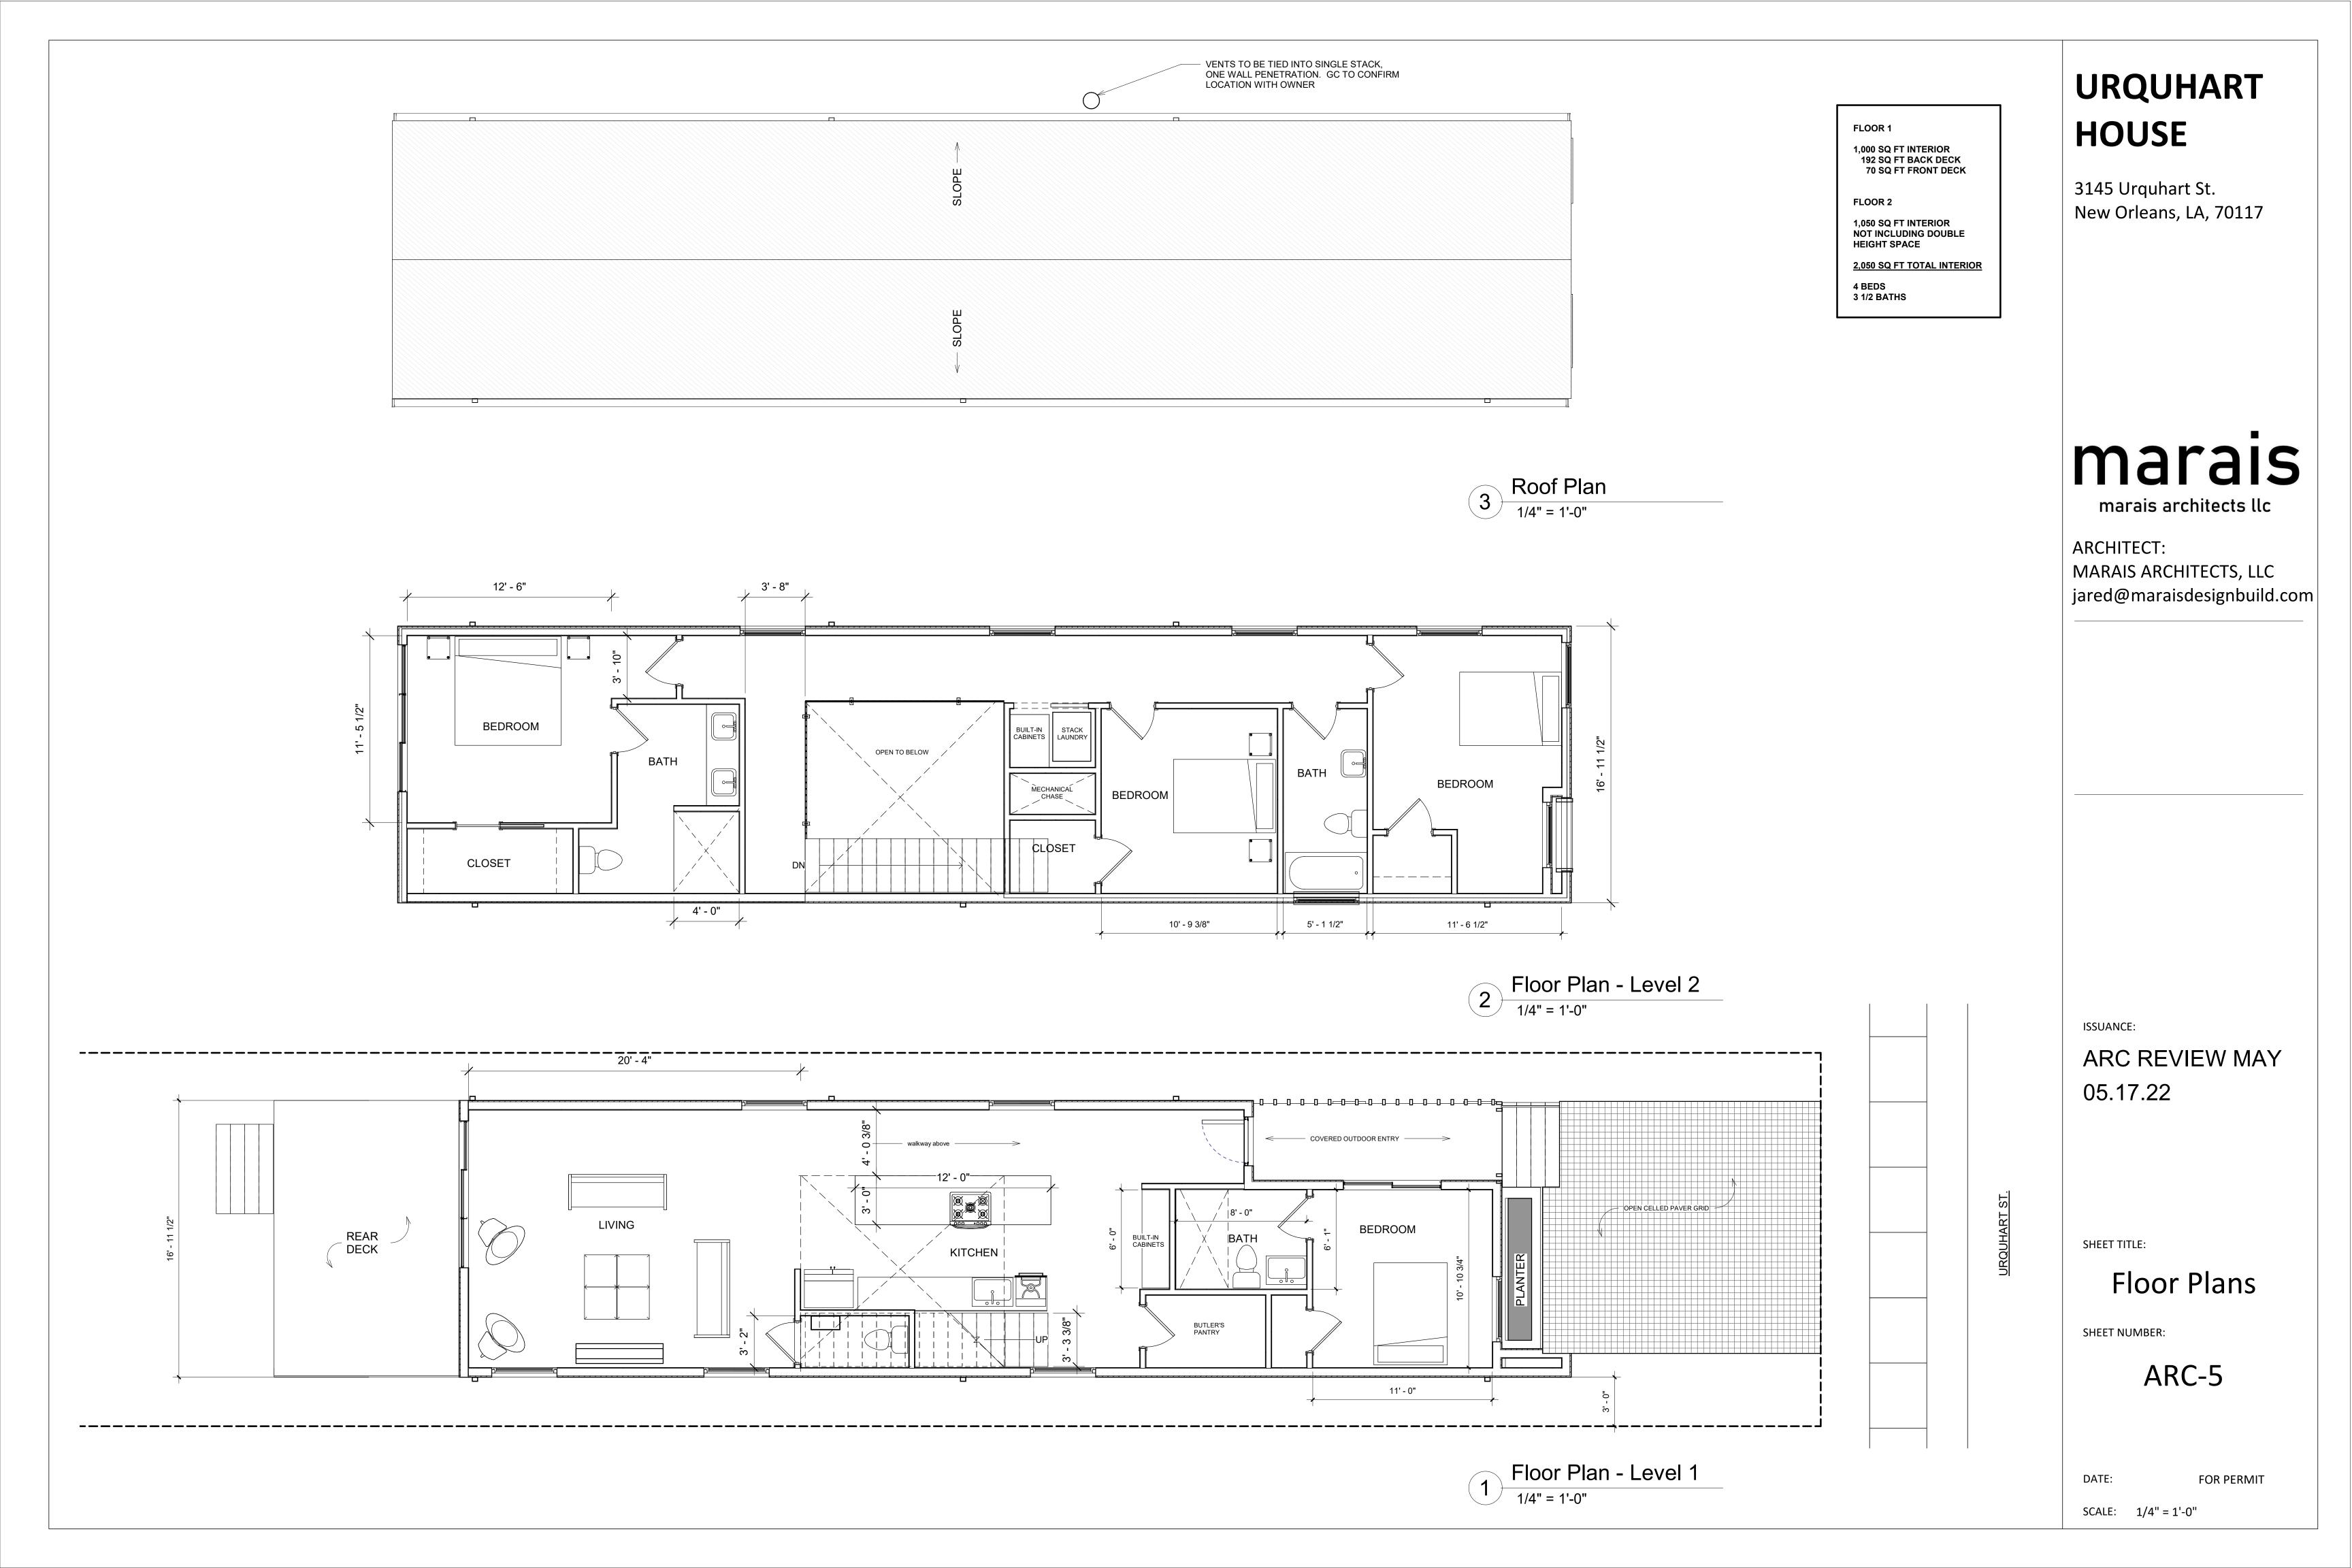

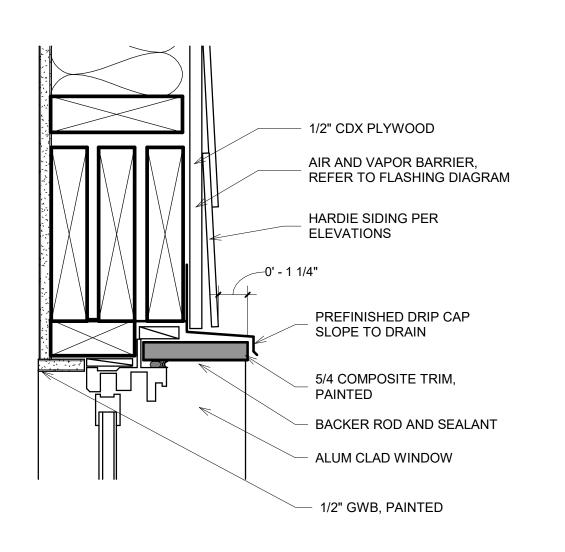


## WINDOW DETAIL - HEAD 3" = 1'-0"

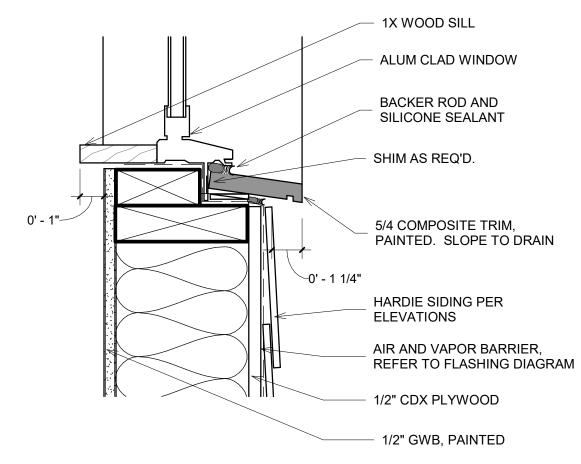


WINDOW DETAIL - SILL


3" = 1'-0"

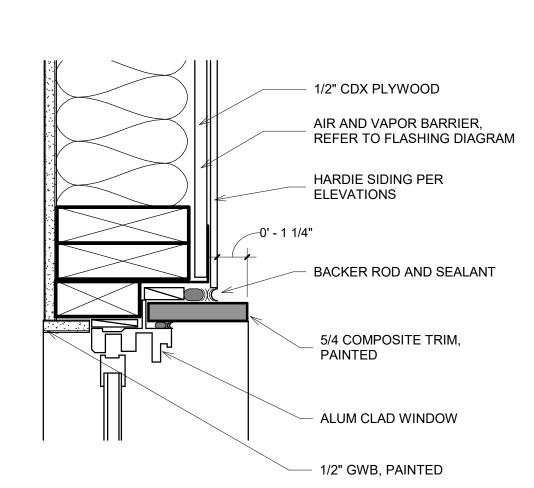

WINDOW DETAIL - JAMB

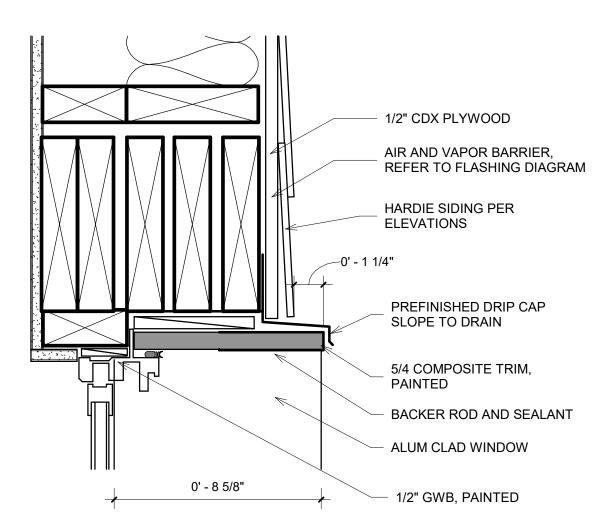

6 WINDOW DETAIL DEEP - HEAD
3" = 1'-0"

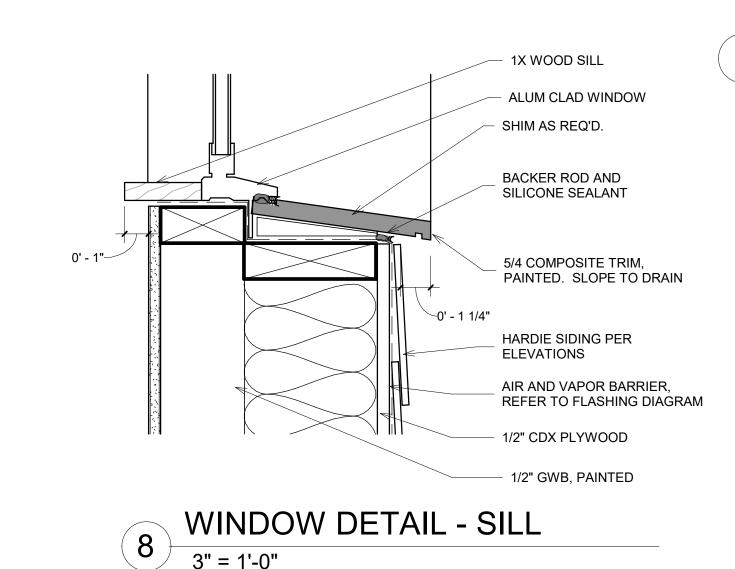

AIR AND VAPOR BARRIER, REFER TO FLASHING DIAGRAM

HARDIE SIDING PER ELEVATIONS

O'-11/4"

PREFINISHED DRIP CAP SLOPE TO DRAIN

5/4 COMPOSITE TRIM, PAINTED

BACKER ROD AND SEALANT


ALUM CLAD WINDOW

1/2" CDX PLYWOOD

1/2" GWB, PAINTED

7 WINDOW DETAIL DEEP - JAMB

0' - 8 5/8"

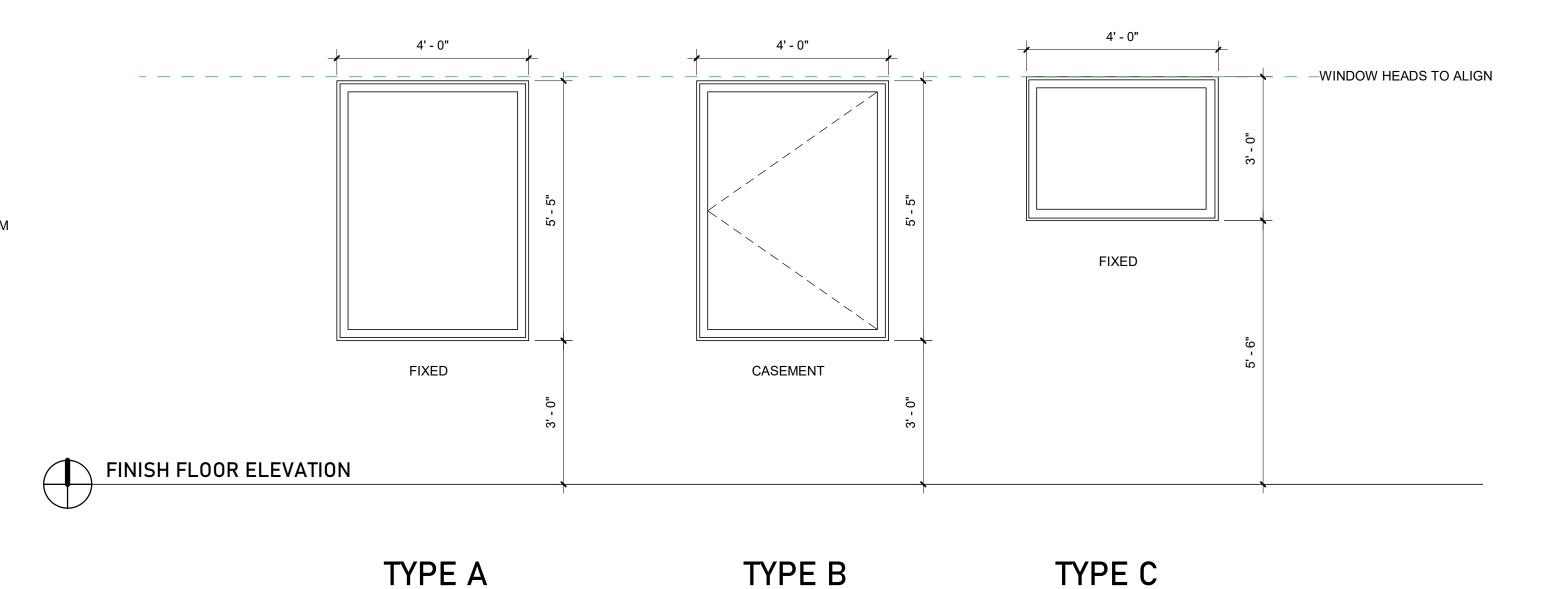

**QUANTITY: 6** 

QUANTITY: 6

1/2" = 1'-0" QUANTITIES TO BE VERIFIED BY GC

Window Elevations - Urquhart

EXTERIOR FINISH MATERIAL. SEE
ELEVATIONS FOR MATERIAL. TYPE AND
TRANSITIONS

CONTINUOUS VAPOR PERMEABLE
AIR BARRIER

1/2" CDX PLYWOOD, GLUED AND NAILED

EXTERIOR FRAMING. SEE STRUCTURAL
FOR MORE INFORMATION

PREFINISHED FRY REGLET OC PROFILE
AT ALL CORNERS. U.N.O. ON
ELEVATIONS. FINISH COLOR TO BE
INSTALLED AT EXTERIOR RISIDE CORNERS
UNLESS NOTED OTHERWISE.

**QUANTITY: 1** 

5 EXTERIOR CORNER TRIM
3" = 1'-0"

### URQUHART HOUSE

3145 Urquhart St. New Orleans, LA, 70117

# marais

marais architects llc

ARCHITECT:

MARAIS ARCHITECTS, LLC

jared@maraisdesignbuild.com

ISSUANCE:

ARC REVIEW MAY 05.17.22

SHEET TITLE:

Details

SHEET NUMBER:

ARC-6

DATE: FOR PERMIT

SCALE: As indicated



