# **INDEX OF DRAWINGS**

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- A3.0: EXTERIOR ELEVATIONS BUILDING
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- A4.0: TRANSVERSE SECTIONS; DETAILS
- A5.0: DOOR & FINISH SCHEDULES; DOOR & WINDOW TYPE ELEVATIONS; DETAILS
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- ME1.0: H.V.A.C. PLANS; ELECTRICAL PLANS

# PROJECT INFORMATION

- **LOCATION:** 323 Octavis Street New Orleans, LA 70115
- II. PROJECT DESCRIPTION:


787 SF Second Story Addition to an existing 2 Story Building. Existing Use: Offices. Proposed Use: Offices.

- III. ZONING:
- HU-MU
- IV. SQUARE FOOTAGE:

Existing First Floor: Reginelli's: 1,631.7 SF Restaurant Space: 1,258.8 SF Existing Second Floor: Residential (3 Units): 2,074.3 SF Balcony & Stair: 393.7 SF Second Floor Addition: Offices: 787.3 SF New Balcony & Stair: 299.7 SF

- V. APPLICABLE CODES:
  - A. N.O.B.C. / IBC-2015
    - 1. Occupancy Group: Group "B" (Business); Group "A-2" (Assembly);
    - Group "R-2" (Residential)
  - 2. Occupancy Load: Business: 25; Assembly: 22; Residential: 11.
  - B. NFPA 101-2015
    - Occupancy Type: Business; Assembly<300; Apartment Building Occupancy Load: Business: 25; Assembly: 27; Residential: 11.
  - C. 2010 ADAAG
  - D. 2015 INTERNATIONAL PLUMBING CODE
  - E. 2015 INTERNATIONAL MECHANICAL CODE
  - F. 2015 INTERNATIONAL FUEL & GAS CODE
  - G. 2014 NATIONAL ELECTRICAL CODE
- VI. AUTOMATIC SPRINKLER SYSTEM: NO
- VII. FIRE ALARM SYSTEM: Not Required

# **SYMBOLS**

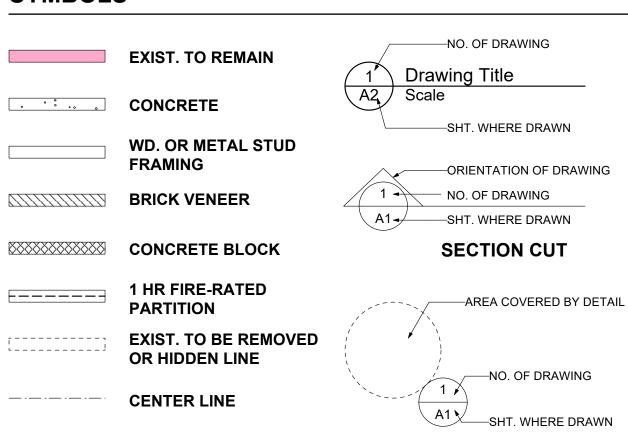

PROPERTY LINE

**DIMENSION LINE** 

**EXIST. ELECTRICAL OUTLET** 

**NEW DUPLEX OUTLET** 

GROUND FAULT CIRCUIT

WATERPROOF DUPLEX

1) = NEW DOOR NUMBER

101 = ROOM NUMBER

W-1 = WINDOW TYPE

INTERRUPT

**QUAD OUTLET** 

**DUPLEX FLOOR** 

(E) = EXIST. DOOR TO REMAIN

ORIENTATION OF DRAWING NO. OF DRAWING SHT. WHERE DRAWN **ELEVATION** 

**DETAIL** 

RE: 5/A5 = REFER TO TO DRAWING NO. 5 ON SHT. A5

D1 = DEMOLITION KEY NOTE SD = SMOKE DETECTOR

**WALL SWITCH** 

THREE WAY WALL SWITCH

WALL SWITCH - DIMMER

# **ABBREVIATION**

INSIDE FACE

INSULATION

**MATCH EXISTING MANUFACTURER** 

INTERIOR

MATERIAL

**INSIDE FACE OF STUD** 

A/C	AIR CONDITIONING	M.C.	MEDICINE CABINET
		M.O.	MASONRY OPENING
	ABOVE FINISH FLOOR ALUMINUM	MTL.	METAL
	AT	MLD.	MOULDING
@ BD		N.I.C.	NOT IN CONTRACT
BD.	BOARD	OPG.	OPENING
BET. BLK'G.	BETWEEN	NO.	NUMBER
	BLOCKING	O.C.	ON CENTER
вот.	BOTTOM	O.D.	OUTSIDE DIAMETER
B.L.	BRICK LEDGE	O.F.	OUTSIDE FACE
B.V.	BRICK VENEER	O.F.S.	OUTSIDE FACE OF STUD
BLDG.	BUILDING		PANEL
C.T.	CERAMIC TILE		PLYWOOD
CLG.	CEILING	PCF	
C.J.		PSI	POUNDS PER SQUARE INCH
COL.		RE:	REFER TO
	CONCRETE	REF.	
	CONTINUOUS	REF.	RETURN AIR
CMU	CONCRETE MASONRY UNIT		_
DET.	DETAIL	RM.	ROOM
DBL.	DOUBLE	R.O.	ROUGH OPENING
DN.	DOWN	R	RISER
DRWG.	DRAWING	SHT.	SHEET
DW	DISHWASHER	SIM.	<del></del>
D	DRYER	S.O.H.	
EA.	EACH	S	SINK
	EXTERIOR INSULATION AND		SOLID CORE
	FINISH SYSTEM		SPECIFICATIONS
ELEC.	ELECTRICAL	S.S.	STAINLESS STEEL
ELEV.		STL.	STEEL
EL.	ELEVATION(GRADE)		STRUCTURE/STRUCTURAL
EQ.	EQUAL	T.S.	THIN SET
EXIST.	EXISTING	T & G	TONGUE & GROOVE
EXT.	EXTERIOR	T.O.S.	TOP OF SLAB
FIN.	FINISH	Т	TREAD
FLR.	FLOOR	TRTD.	TREATED
		TYP.	TYPICAL
	FLOOR JOIST	U.O.N.	UNLESS OTHERWISE NOTED
F.V.	FIELD VERIFY	VERT.	VERTICAL
FR.	FREEZER	V.C.T.	VINYL COMPOSITION TILE
FTG.	FOOTING	W	WASHER
GA.	GAUGE	W.C.	WATER CLOSET
GALV.	GALVANIZED	WH	WATER HEATER
GALVM.	GALVALUME	WP	WATERPROOF
GR.	GRADE	w/	WITH
GYP.BD.	GYPSUM BOARD	WD.	WOOD.
HT.	HEIGHT	WD.	1100D.
HORIZ.	HORIZONTAL		
H.B.	HOSE BIBB		

These plans and specifications have been prepared by me, or under my direct supervision. To the best of my knowledge the requirements of the applicable building codes have been



KRASNOW E C T, L L C z'⊢

GARY
A R C H

AS NOTED

T1.0

I will make site observation visits during construction

# Exist. SF Residential Bldg. — 18'-3" 101'-0 1/8" — Exist. Chain Link Fence Relocated from roof Exist. Wood Fence — over Storage rm. — Exist. conc. sidewalk Exist. WH Enclosure Edge of exist. pavement EXIST. RESTAURANT (HAIRY DOG/SECRET BIRRIA) Exist. Gravel NO WORK 1,258.8 SF –EXIST. REGINELLI'S OFFICES⊸ \_\_\_\_1,631.7 SF\_\_ Exist. Elec. Service — EXIST. CONC. PATIO ── 2nd Flr. Balcony abv. Exist. Gravel — Exist. Open Ext. Stair -— New Open Ext. Stair EXIST. SHED Property Line — – Exist. Conc. Paving – Exist. SF Residential Bldg.

ANNUNCIATION ST. (SIDE)

TCHOUPITOULAS ST. (SIDE)





LOT 'Y' SQUARE NO. 129, RICKERVILLE SIXTH DISTRICT NEW ORLEANS, LA **ORLEANS PARISH** 

ZONED: MU-MU

#### **LEGEND**

Indicates slope in the finish grade of new paving.

Indicates the top of the new paving or sidewalk

M.E. Match existing grade elevation.

00.00 (E) Existing grade elevation.

**D.I.:** Drop Inlet (24" x 24" Frame & Grate)

**DMH:** Drain Manhole CB: Catch Basin

**F.H.:** Fire Hydrant P.P.: Power Pole


L.P.: Light Pole **SMH:** Sewer Manhole

GR: Grass/Planting Area

**(E):** Following/preceeding other designations indicates that item is

#### **SITE PLAN NOTES**

- 1. ALL conditions shown on the Site Plan are existing to remain, u.o.n.
- 2. All dirveways shown on the plan(s) are existing.

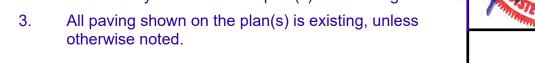

SITE AREA: 7,005 SF

PERMEABLE OPEN SPACE: 2,008 SF / 28.7%

**IMPERVIOUS AREA: 4,997 SF** 

### **OFF-STREET PARKING**

**EXISTING: 1** NEW: 0

# **NOTE**

1. NOCZO, Article 22.5, Par. A, 6: The first five-thousand (5,000) square feet in gross floor area for commercial uses in the HU-B1, HU-MU and MU-1 Districts are exempt from the vehicle parking requirements of Table 22-1.





>		4/4/2022	
<b>&gt;</b> 0	Drawn By GNK	Revision	
125	Checked By GNK	Project ID 21-27	
	Reviewed By GNK	Drawing Code C1.0 [Site Plan (General)]	
1774	Submitted By	CAD File Name 21-27_Prelim.vwx	⋖
	Project Manager	Plot Date	
	GNK	4/4/2022	ž

N. KRASNON GARY ARCH

AS NOTED

C1.0

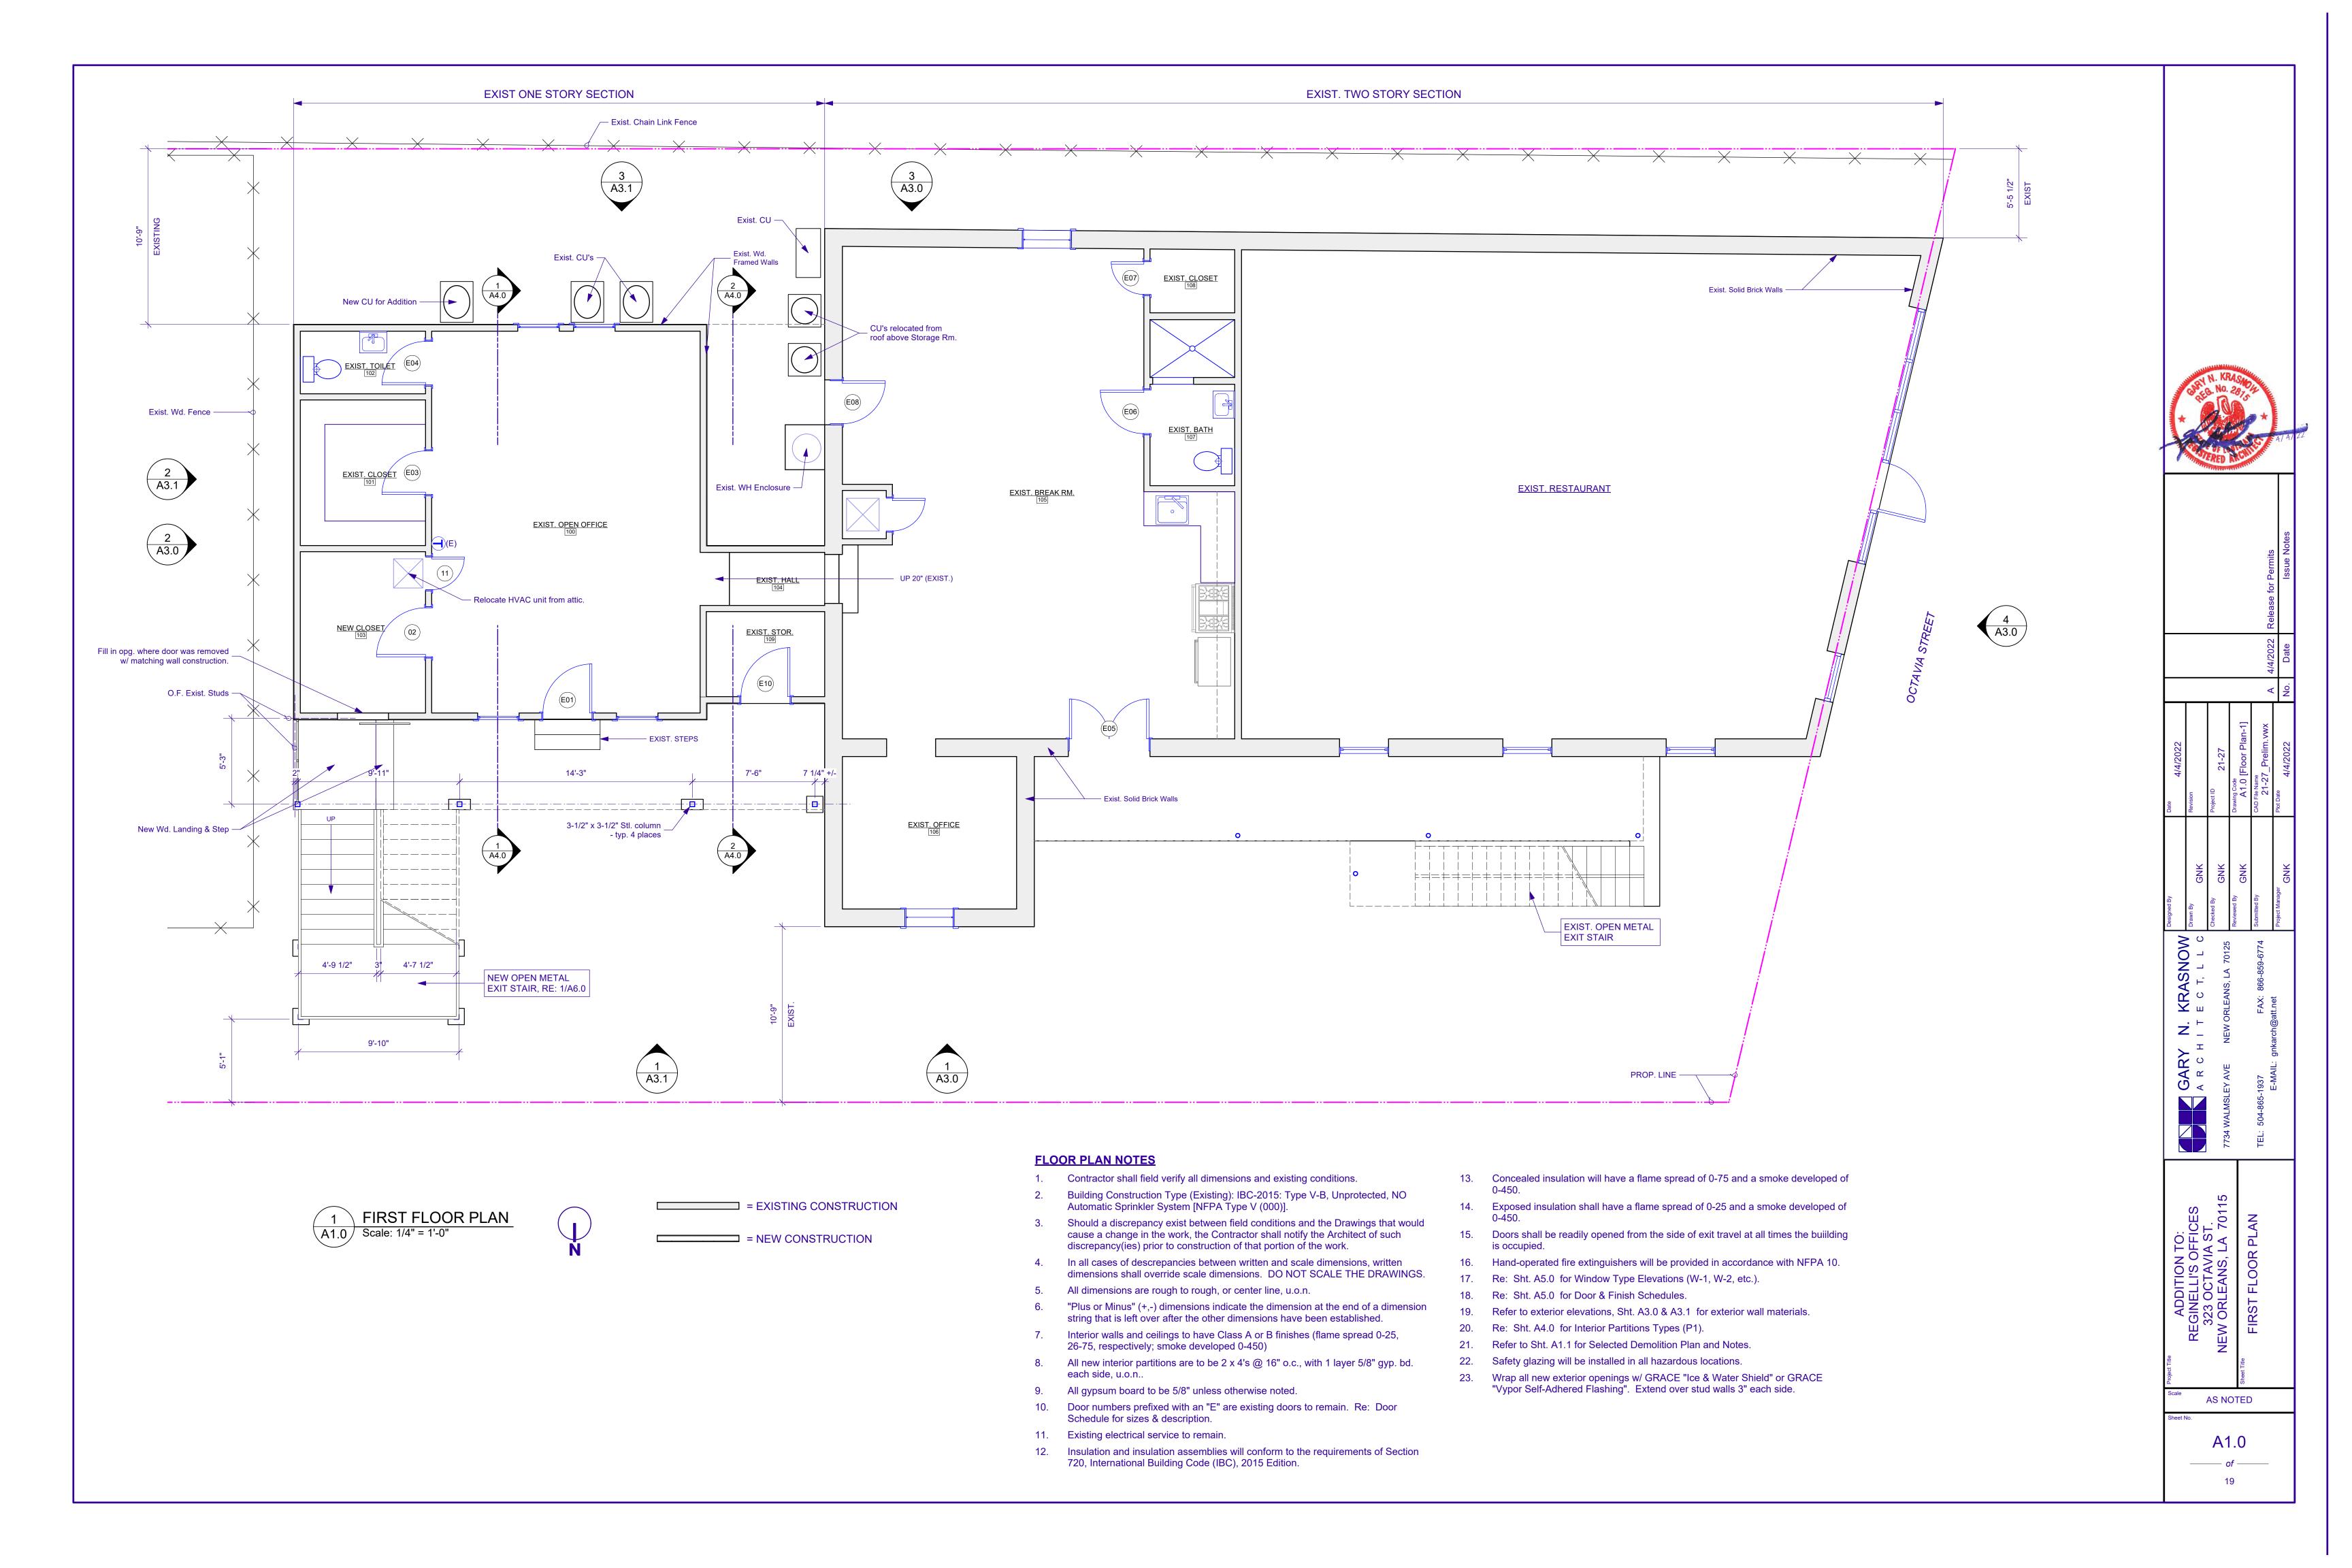

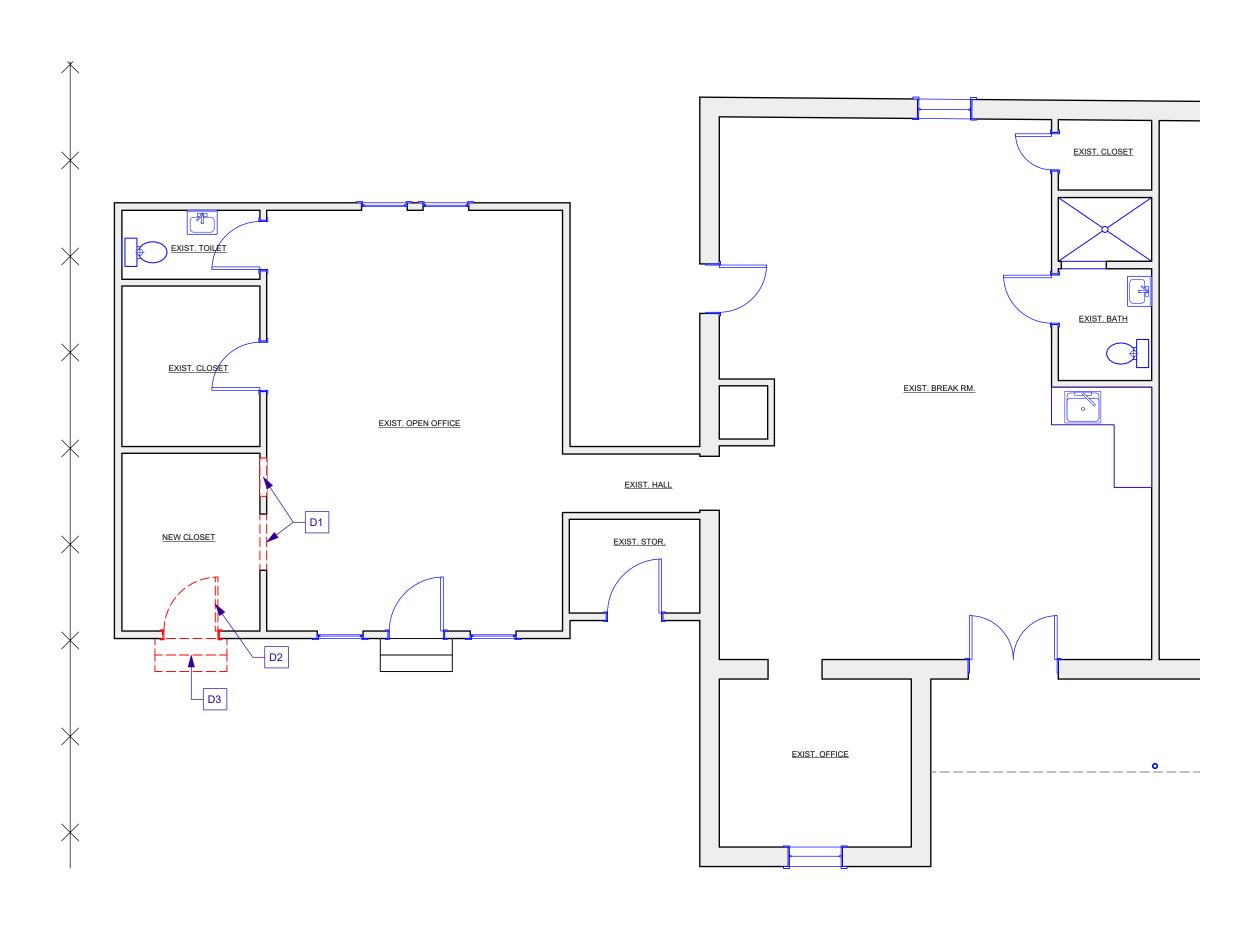






### **GENERAL DEMOLITION NOTES**

- 1. It is the intent of these demolition notes to remove all the existing construction as indicated on the drawings which conflict with the intent of the new construction.
- Conduct demolition operations and remove debris to ensure minimal interference with roads, streets, walks and other adjacent occupied and used facilities. Remove and transport debris in a manner that will prevent spillage on adjacent surfaces and areas. Promptly dispose of all demolished materials. Do not allow demolished materials to accumulate on site. Legally transport and dispose of all demolished materials.
- 3. Contractor shall coordinate all demolition work, whether indicated on the drawings or not, with new construction.
- 4. Demolition Constractor to survey the condition of the building to determine whether removing any element might result in a structural deficiency or unplanned collapse of any portion of the structure or adjacent structures during selective demolition. Do not demolish any load bearing walls or construction that will compromise the structural integrity of the structure. Notify the Architect of any structural issues arising from demolition.
- Contractor shall notify the Architect of any existing conditions that are exposed during construction that may affect or interfere with any new work.
- 6. Demolish and remove components in an orderly and careful manner.
- 7. Existing utilities are to remain in service during selective demolition.
- 8. Demolition of electrical deivices, wiring, conduit, etc. to be performed by an electrican licensed in the state of Louisiana.
- 9. Removal of plumbing fixtures, supply and drain lines to be performed by a plumber licensed in the state of Louisiana.
- 10. Protect existing items which are not indicated to be removed.
- 11. Protect existing supporting structural elements and adjacent area not scheduled for work.
- 12. Erect and maintain weatherproof airtight closures for exterior openings.
- 13. Thoroughly clean building upon completion of selective demoition.
- 14. Total scope of demolition may not be covered on this sheet. Review all sheets in the Construction Documents to determine total scope of demolition.


# **KEY DEMOLITION NOTES**


- D1 Remove portion of wall as required to install new door, re: Door Schedule for size of door opg.
- D2 Remove existing door and frame and fill in opening with construction to match surrounding wall.
- D3 Remove existing steps.
- D4 Remove roof and roof structure from 1-story section.
- D5 Remove roof overhang.
- D6 Remove existing window and patch wall.
- D7 Remove existing double window and replace with single window to match existing.
- D8 Remove existing siding this wall as required to construct addition.

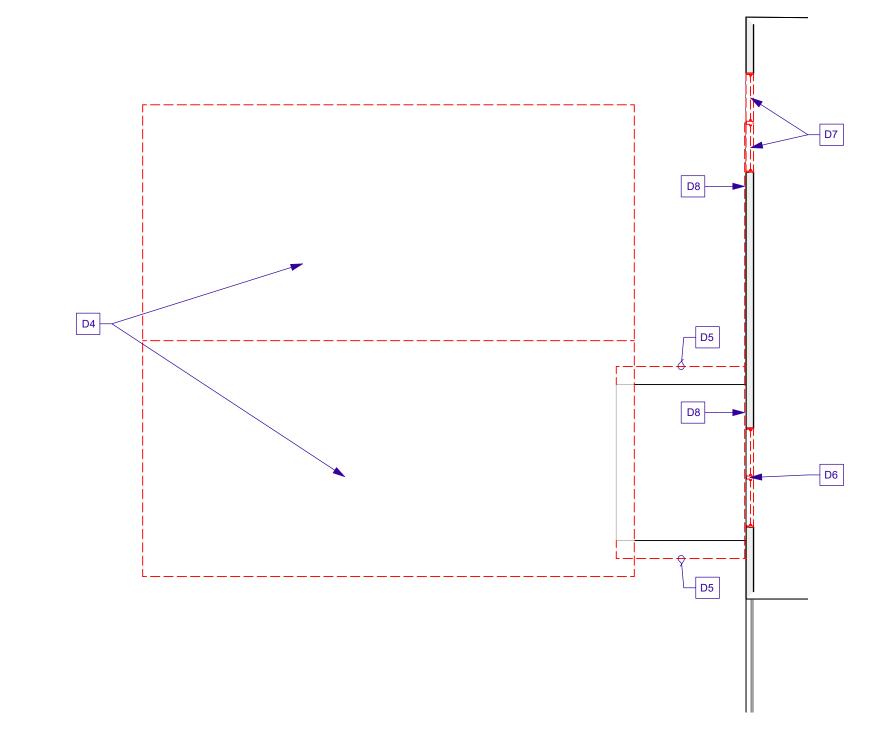






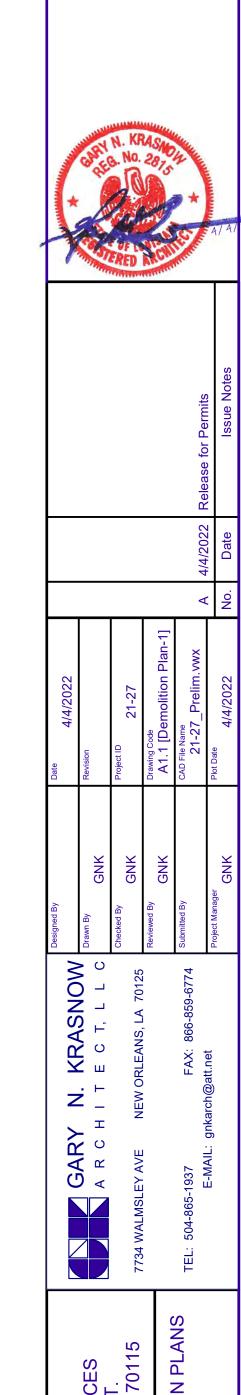

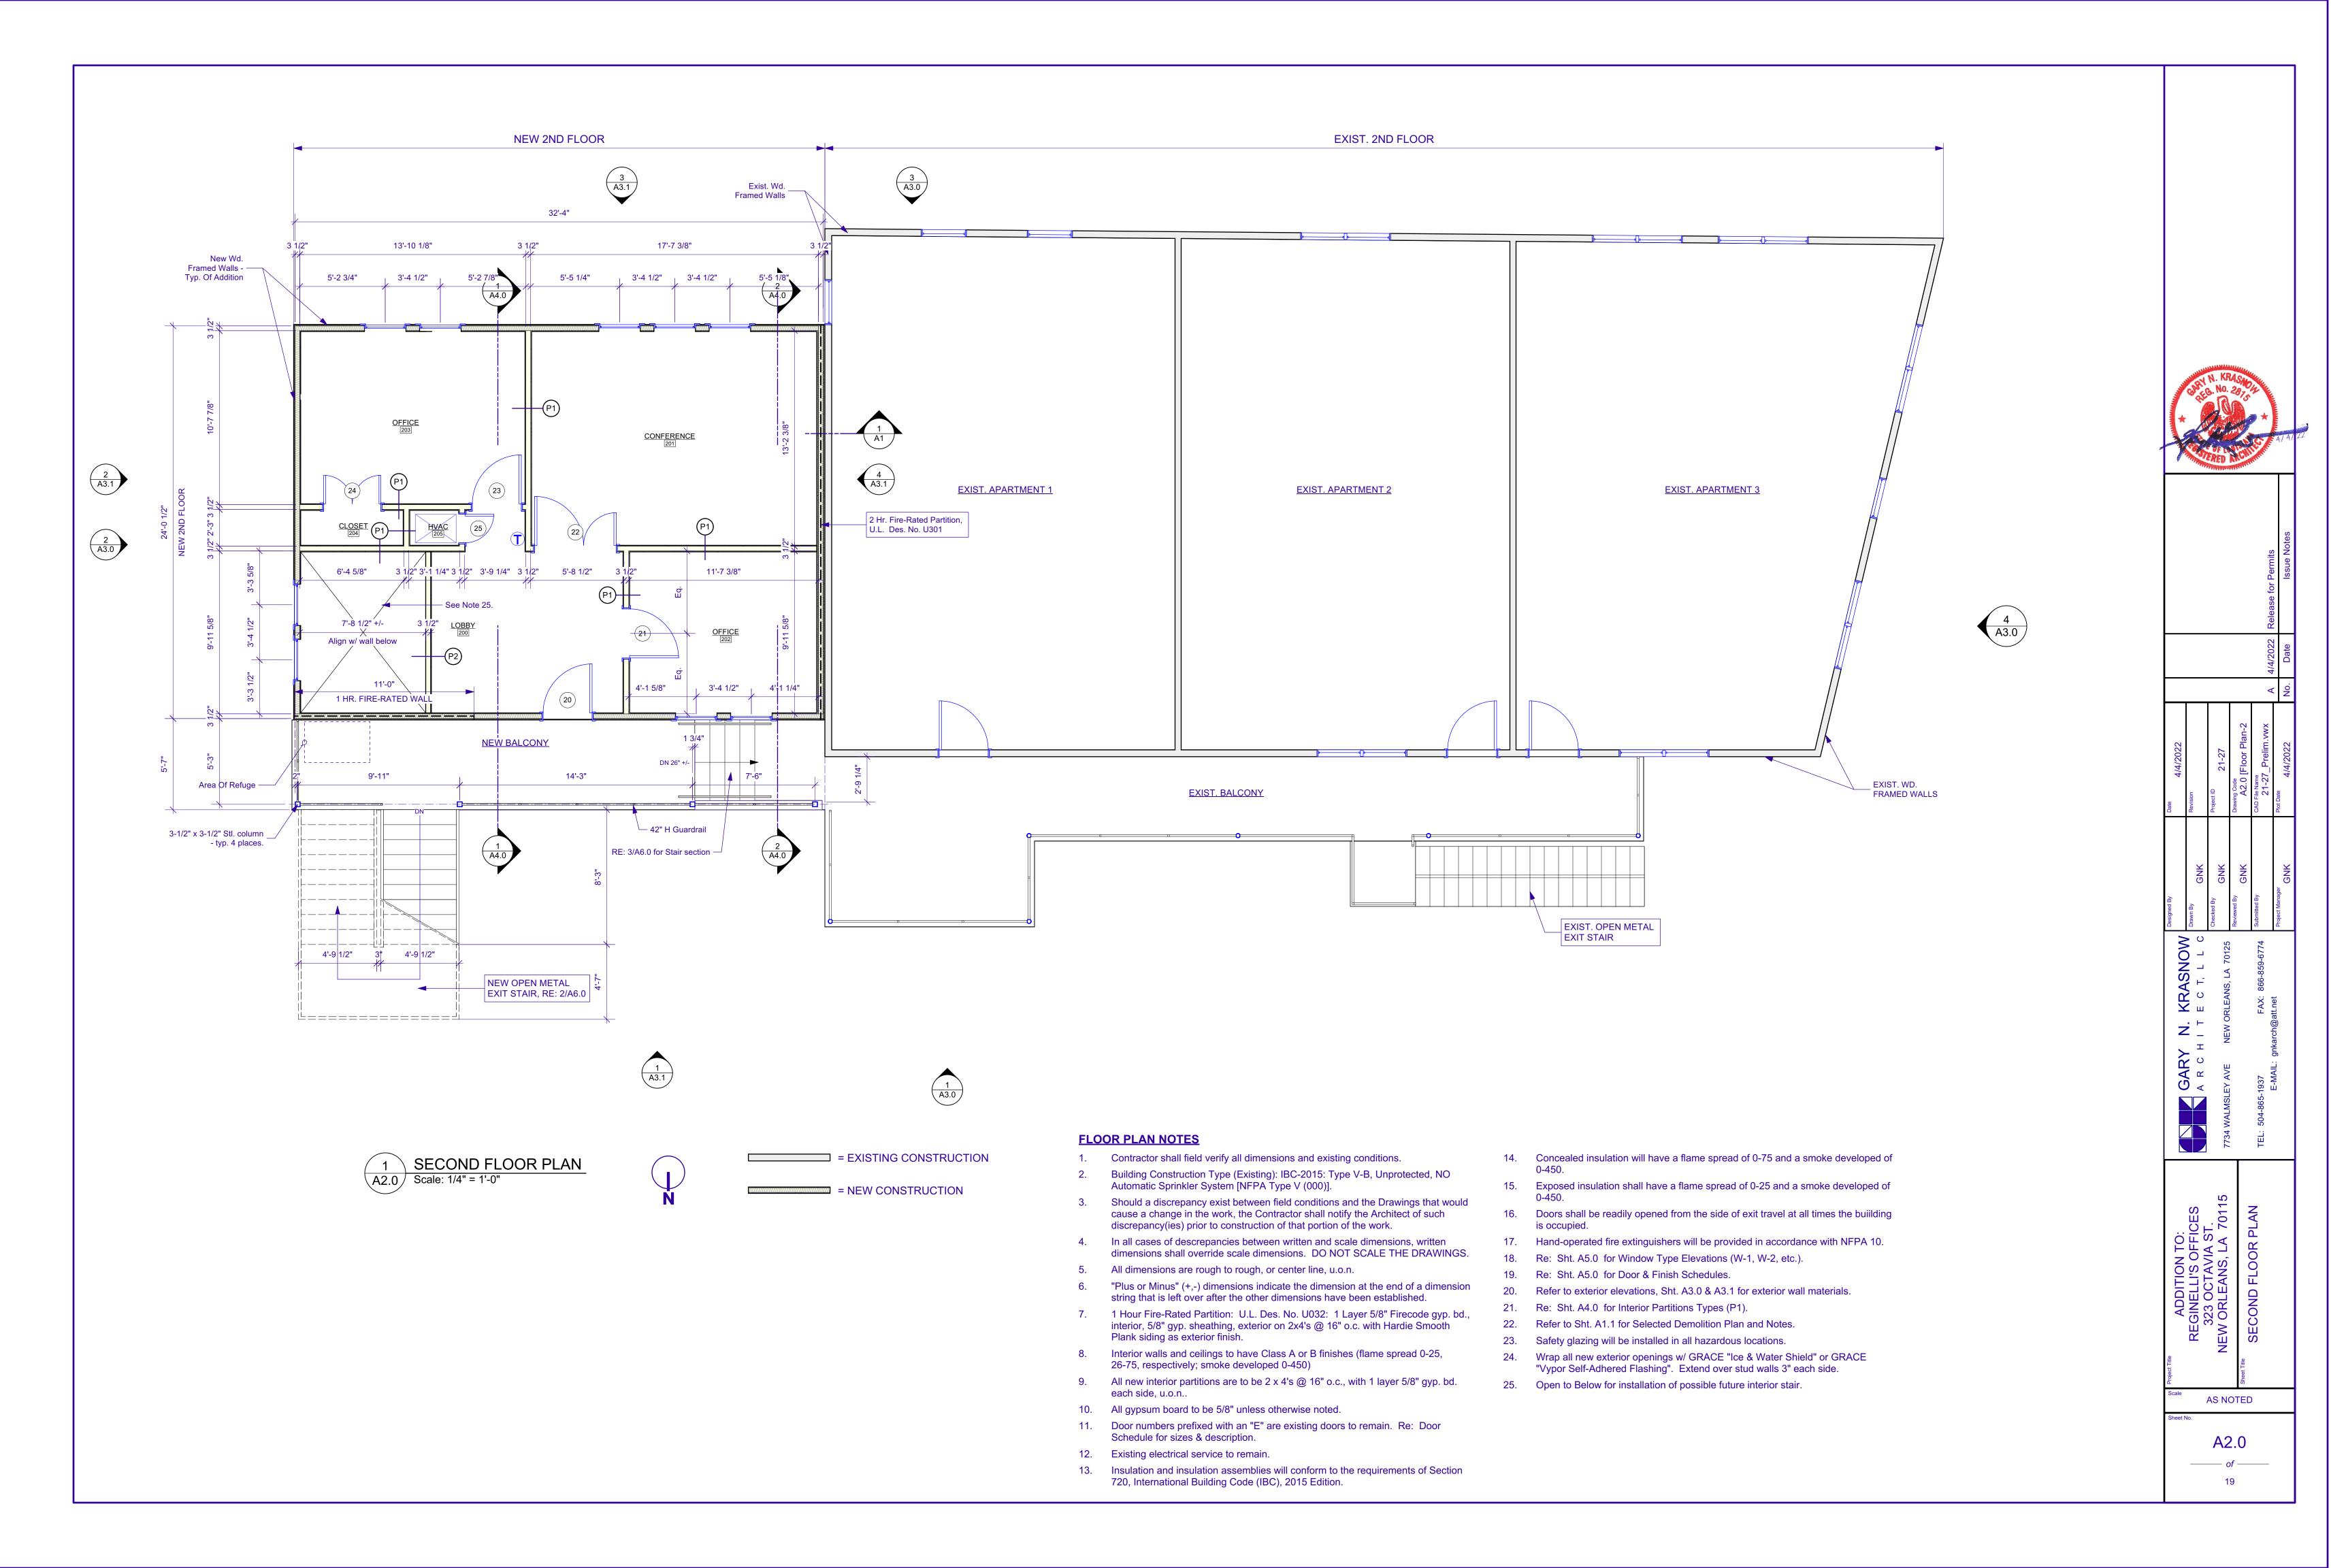

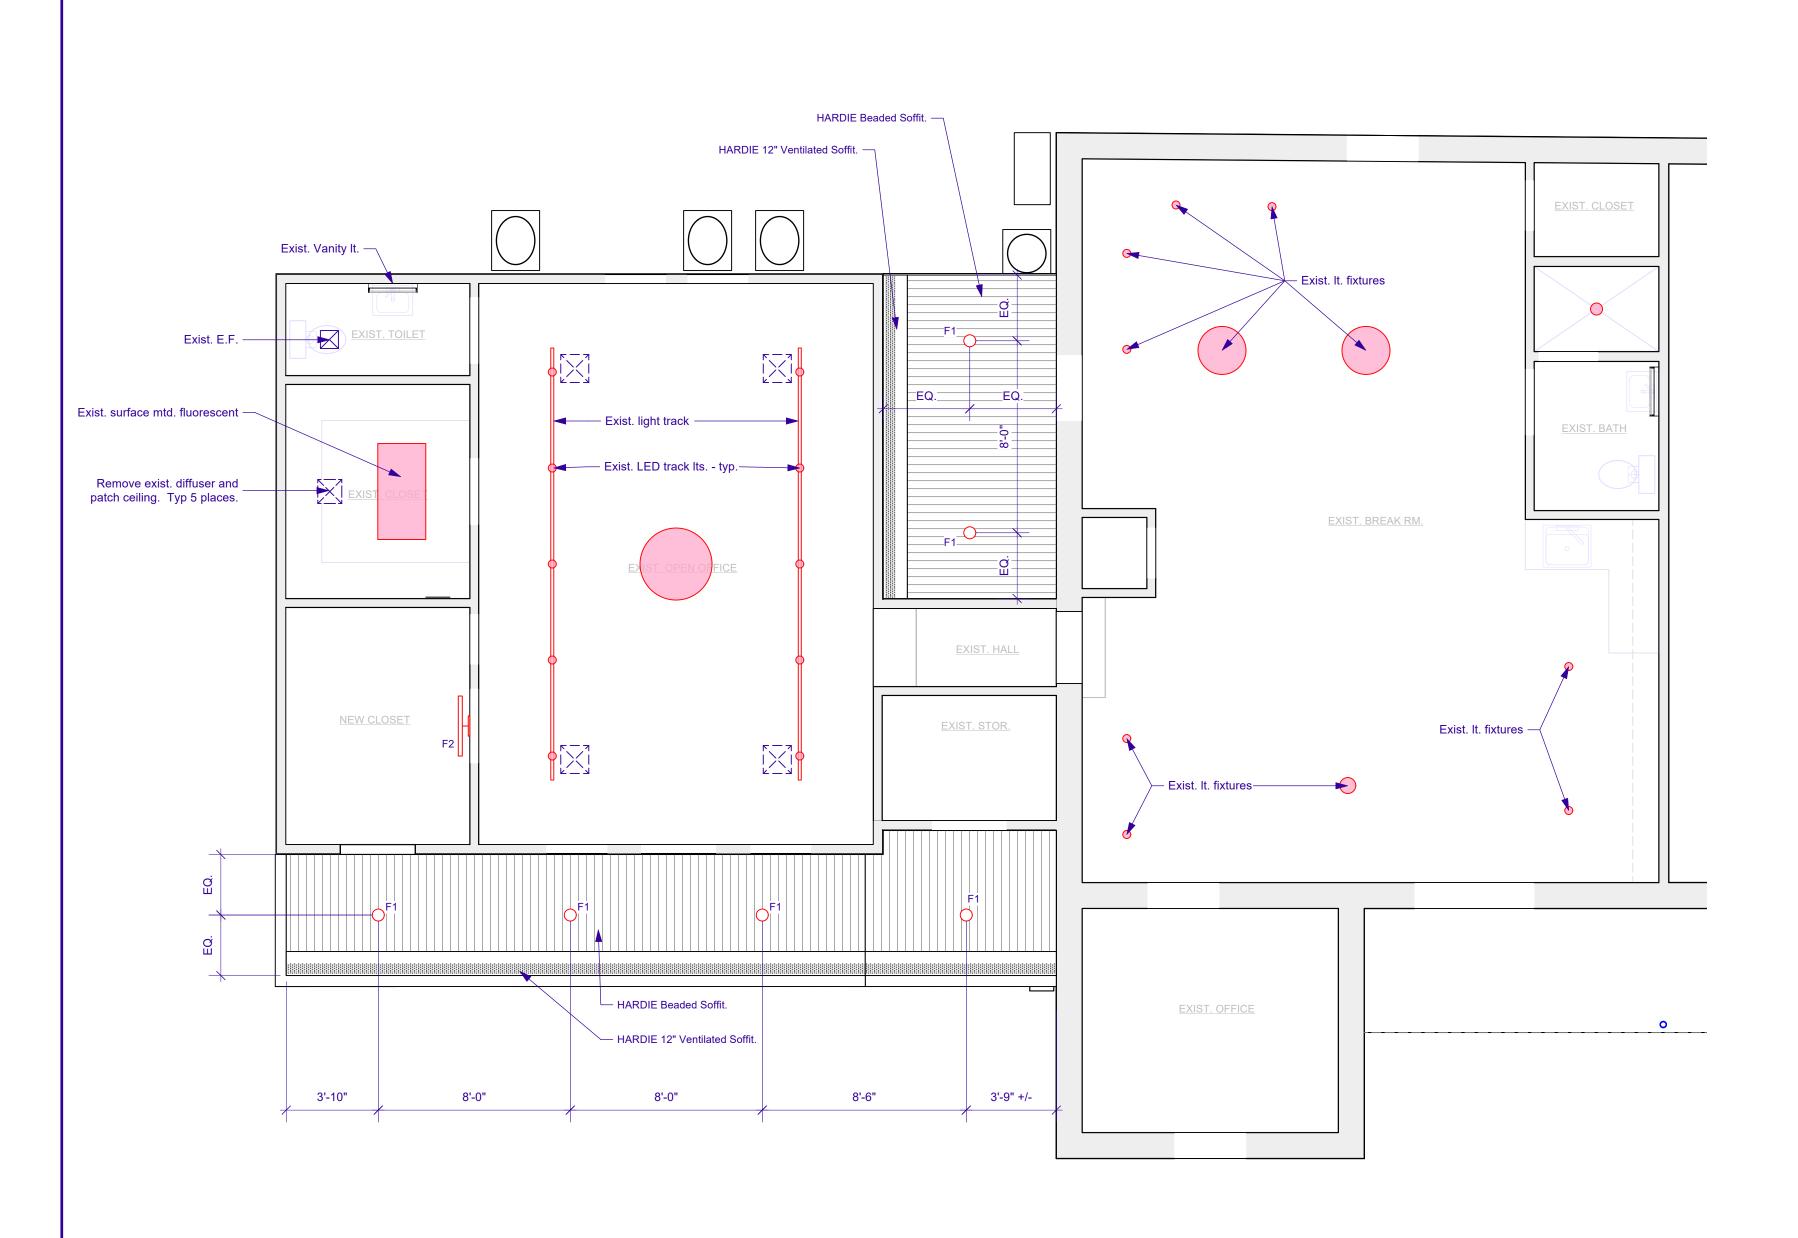






# REFLECTED CEILING PLAN NOTES

- ALL New Light Fixtures shall be furnished by the Owner, installed be Contractor.
- 2. Verify all Light Fixture Types with the Owner.
- 3. Verify w/ Owner number of fixtures per light track.


# LIGHT FIXTURE TYPES

- 1. F1: Recessed 4 inch diameter LED downlight.
- 2. F2: Wall Mounted LED utility light.
- F3: Pendant Mounted Light track with length in feet (F4/12'). Match existing track on 1st floor. Number of fixtures (LED) to be determined by the Owner.
- 4. F4: Pendant LED fixture for Lobby. Furnished by the Owner.
- 5. F5: Pendant LED fixture for Conference. Furnished by the Owner.
- 6. FXE: Existing combination Exit/Emergency light w/ battery pack.

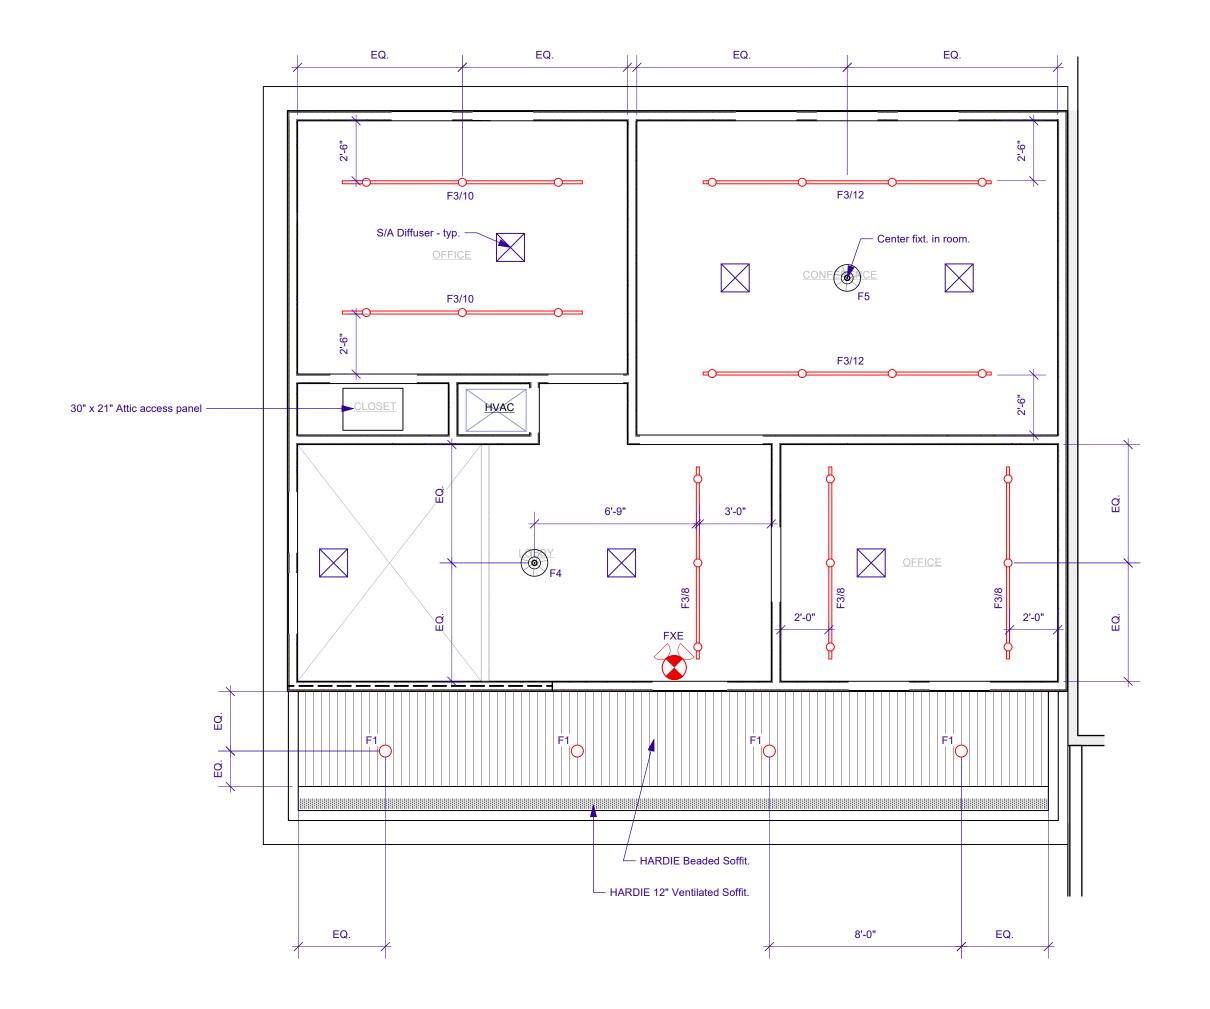








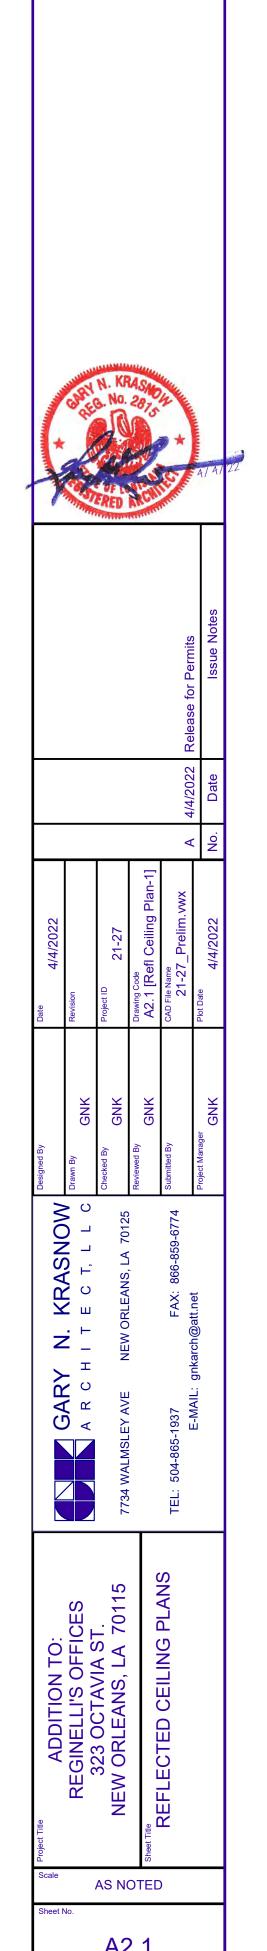



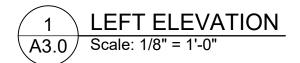


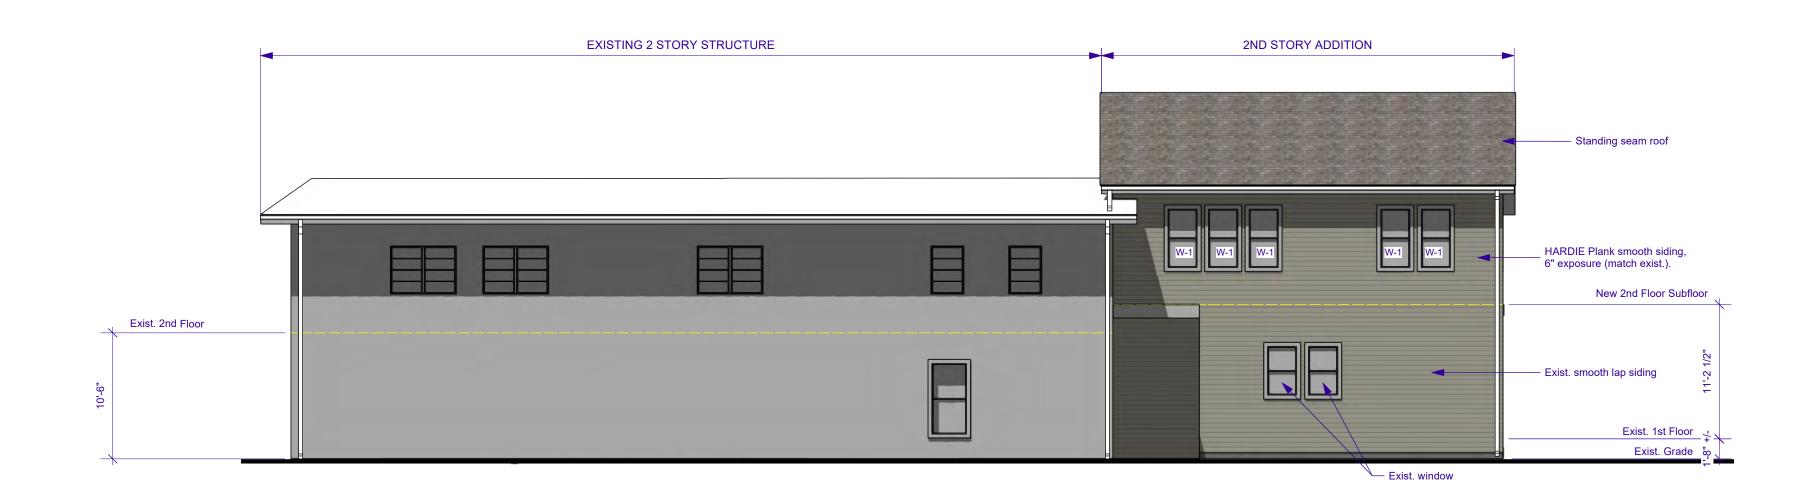


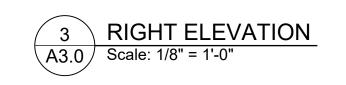


# **EXTERIOR ELEVATION NOTES**

- 1. Exterior colors to be selected by the Owner.
- 2. Re: Sht. A5.0 for WindowType Elevations (W-1).
- 3. Re: Sht. A7.0 for Roof Plan.

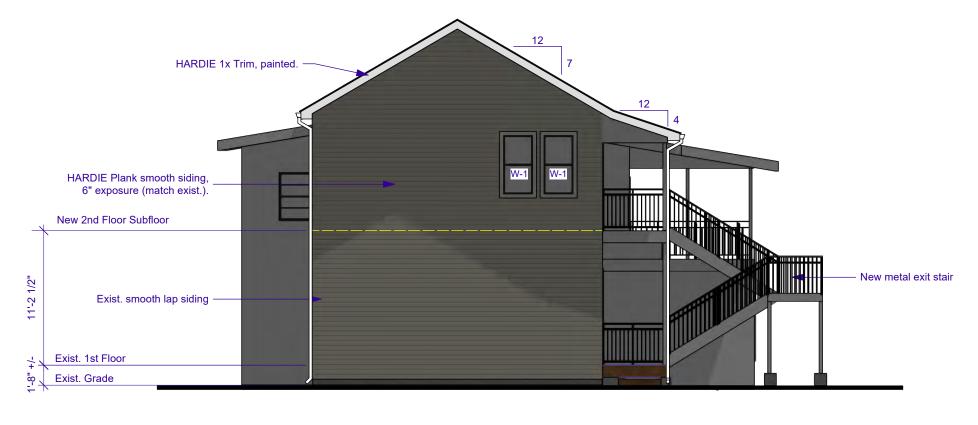

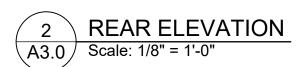


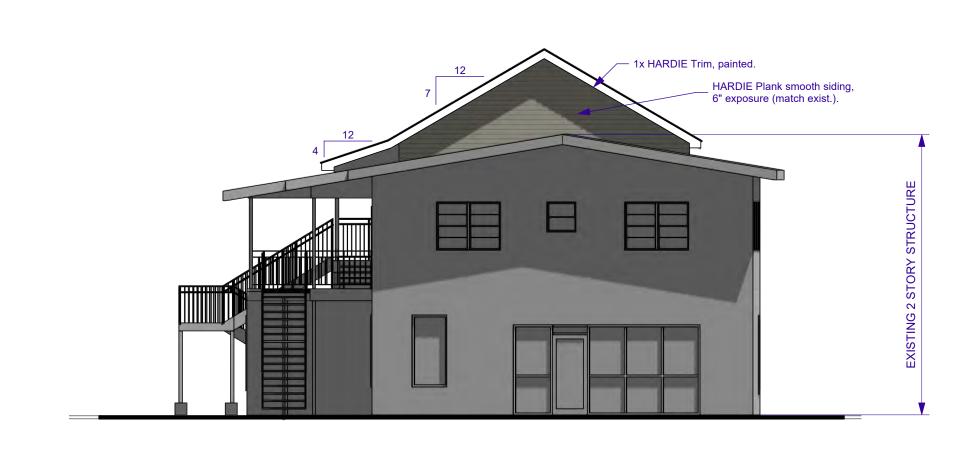






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				A 4/4/2022 Release for Permits		Issue Notes
				4/4/2022	770711	Date
				٥	,	No.
Date 4/4/2022	Revision	Project ID 21-27	Drawing Code A3.0 [Elevations-M-1]	CAD File Name 21-27_Prelim.vwx		4/4/2022
Designed By	Drawn By GNK	Checked By GNK	Reviewed By GNK	Submitted By	Droject Manager	GNK
GARY N KRASNOW		WALMSLEY AVE NEW ORLEANS, LA 70125		FAX: 866-859-6774	E-IMAIL: gnkarcn@att.net	
		WALMS		504-865-1937		

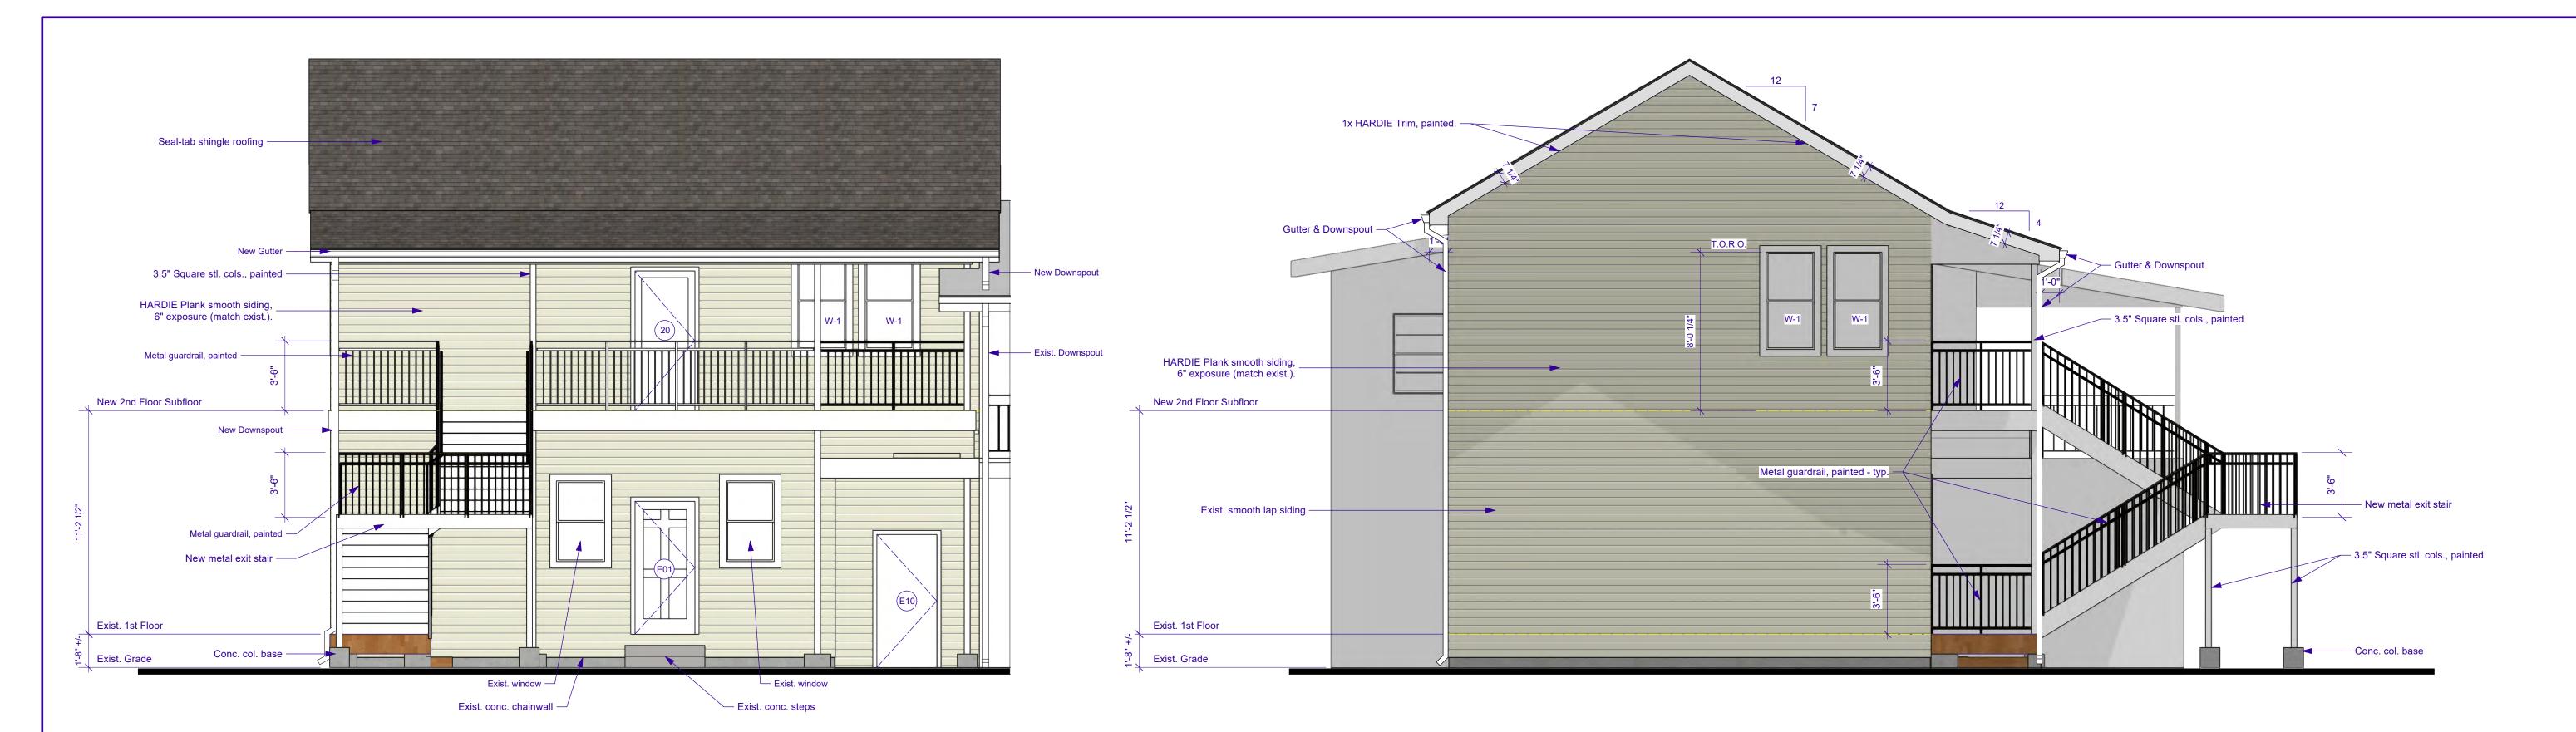


1 ADDITION - FRONT ELEVATION
A3.1 Scale: 1/4" = 1'-0"

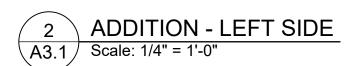


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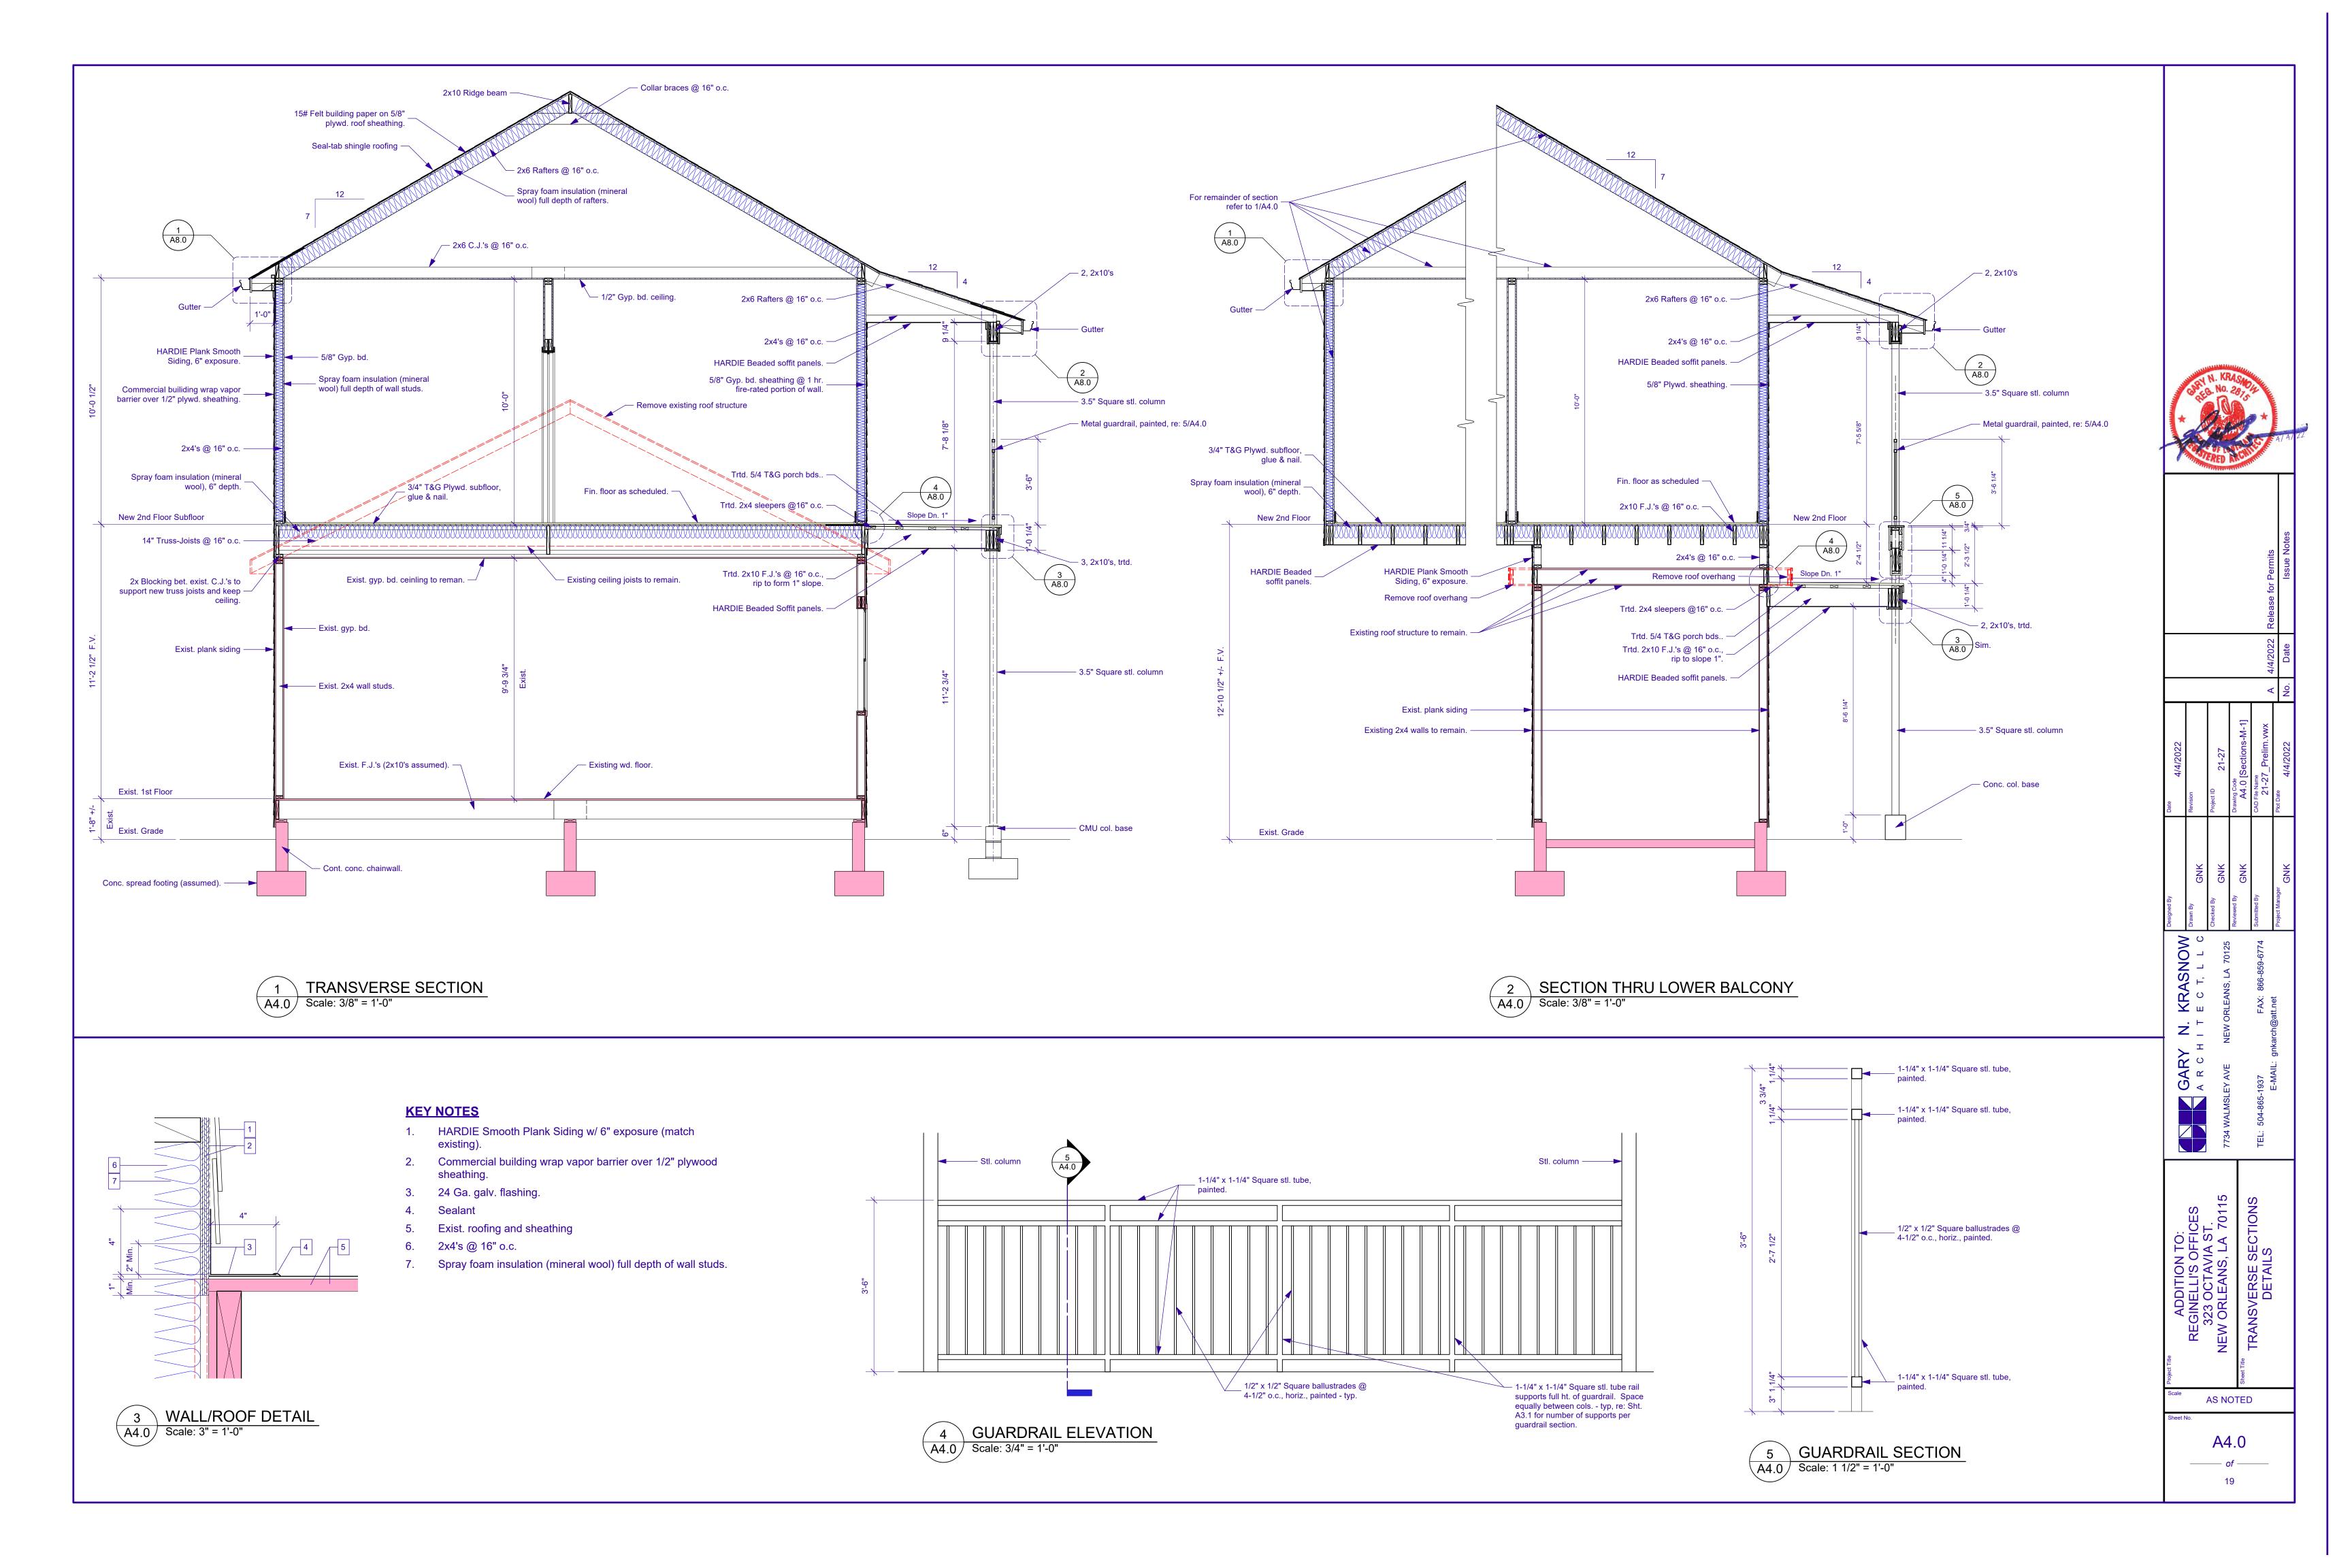




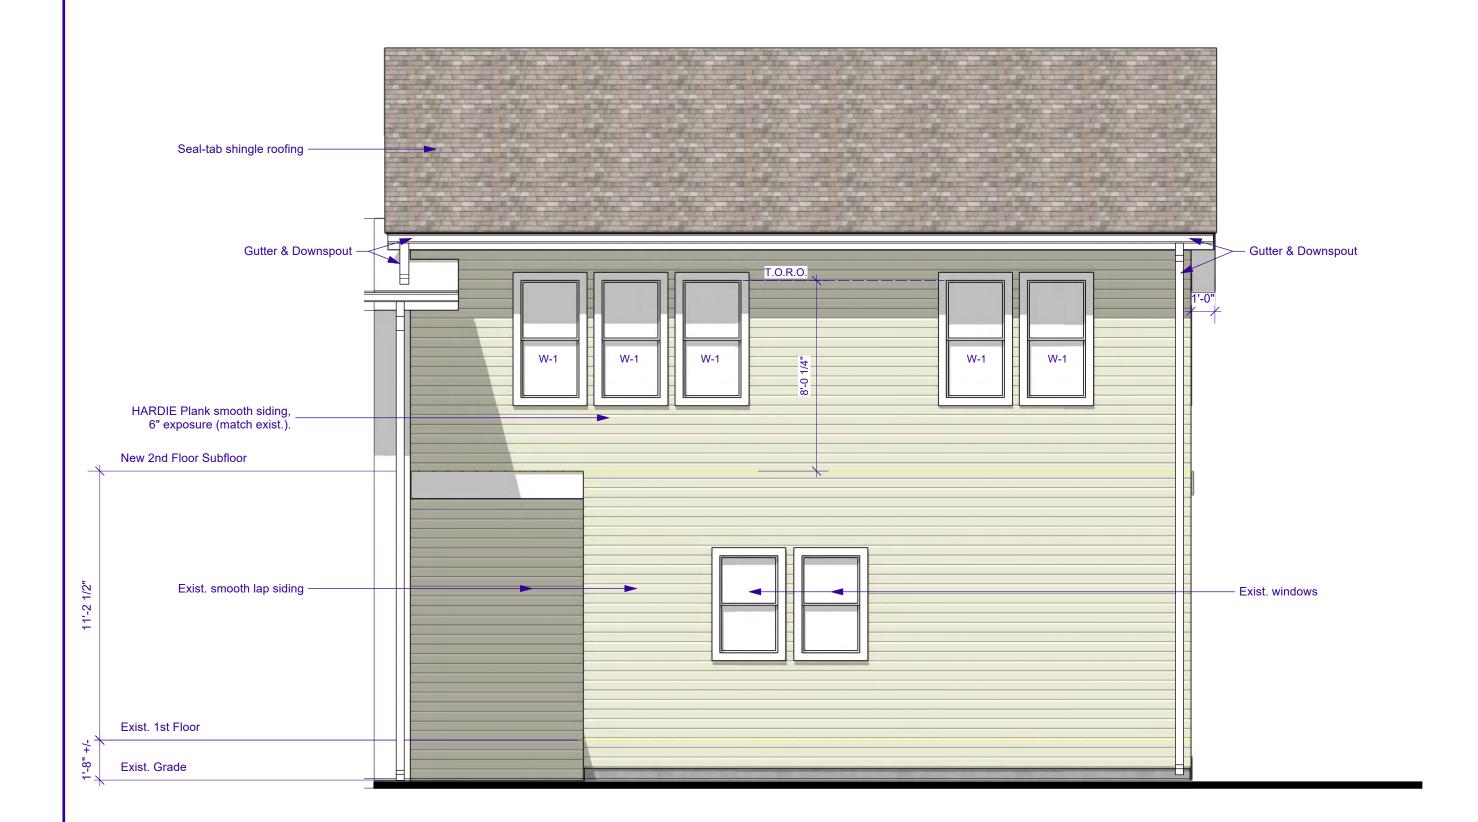

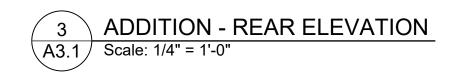

GARY ARCH



	No	minal Siz	ze Door Style				Door Fran	ne		Fire Rating						
Vlark	Width	Height	ss Unick Door Operation	Slab Style	Side Lights	L Sidelt Wid	R Sidelt Wid Head Detail	Jamb Detail	Sill Detail	Frame	Door Slab	Accessories	Door Elev. Type	e Description	Hardware Set Desc.	Comments
01	3'0"	6'8"	1 3/4" Swing Simple	Panel	-	0"	0"						A	Existing raised panel	Existing	See note 4
02	3'0"	6'8"	1 3/4" Swing Simple	Solid	-	0"	0"						В	Int., wd., s.c., flush	Storage	See notes 1,2,3.
03	2'8"	6'8"	1 3/4" Swing Simple	Solid	-	0"	0"						В	Exist. Int., wd., s.c., flush	Existing	See note 4
04	2'8"	6'8"	1 3/4" Swing Simple	Solid	-	0"	0"						В	Exist. Int., wd., s.c., flush	Existing	See note 4.
05	4'10 1/2"	6'8"	1 3/4" Swing Bi-part	Solid	-	0"	0"						С	Exist. raised panel	Existing	See note 4.
06	2'8"	6'8"	1 3/4" Swing Simple	Solid	-	0"	0"						В	Exist. Int., wd., s.c., flush	Existing	See note 4.
07	2'0"	6'8"	1 3/4" Swing Simple	Solid	-	0"	0"						В	Exist. Int., wd., s.c., flush	Existing	See note 4.
08	2'7 1/2"	6'8"		Solid	-	0"	0"						Α	Exist. raised panel	Existing	See note 4.
10	3'0"	6'8"	1 3/4" Swing Simple	Solid	-	0"	0"						В	Exist. Ext., wd., s.c., flush	Existing	See note 4.
11	2'0"	4'0"	1 3/8" Swing Simple	Solid	-	0"	0"						D	Int., wd., s.c., flush	Passage	See notes 1,2,3.
20	3'0"	7'0"	1 3/4" Swing Simple	Glass	-	0"	0" 9/A8/0	9/A8.0 S	in				E	Ext., wd., full-glazed	Entry	See notes 1,2,3.
21	3'0"	7'0"	1 3/4" Swing Simple	Solid	-	0"	0" 1/A5.0	Sim 1/A5.0					В	Int., wd., s.c., flush	Office	See notes 1,2,3.
22	5'0"	7'0"	1 3/4" Swing Bi-part	Solid	-	0"	0" 1/A5.0	Sim 1/A5.0					F	Int., wd., s.c., flush	Passage; Flush Bolts	See notes 1,2,3.
23	3'0"	7'0"	1 3/4" Swing Simple	Solid		0"	0" 1/A5.0	Sim 1/A5.0					В	Int., wd., s.c., flush	Office	See notes 1,2,3.
24	3'6"	7'0"		Solid	-	0"		Sim 1/A5.0					G	Int., wd., s.c., flush	Passage	
25	1'9"	4'0"	1 3/8" Swing Simple	Solid	-	0"	0" 1/A5.0	Sim 1/A5.0 S	in				D	Int., wd., s.c., flush	Passage	See notes 1,2,3.


NOTES: 1. All lock / latchsets to have lever handles.

- 2. Paint door & frame.
- 3. Verify all door hardware with the Owner.

3. Verify finish flooring with the Owner.

4. All doors w/ an "E" preffix are existing doors to remain.

R	oom Finish	Sche	edule	9							Roon	n Finish Legend
		F	loor		V	Nall						
Numb	er Room Name	Matl	Base	North	East	South	West	Ceiling	Ceiling Ht.	Remarks	Ceiling	
100	EXIST. OPEN OFFICE	Exist.	Exist.	EGB-1	EGB-1	EGB-1	EGB-1	EGB-1	9'9 3/4"	See note 1.	EGB-1	Existing gyp. bd. ceiling
101	EXIST. CLOSET	Exist.	Exist.	EGB-1	EGB-1	EGB-1	EGB-1	EGB-1	9'9 3/4"	See note 1.	EXP-1	Exposed roof structure
102	EXIST. TOILET	Exist.	Exist.	EGB-1	EGB-1	EGB-1	EGB-1	EGB-1	9'9 3/4"	See note 1.	GB-1	1/2" gypsum board, primed and painted, directly screwed to joists above
103	NEW CLOSET	SUB-1	N/A	GB-2	GB-2	GB-2	GB-2	EGB-1	21'2 1/2"	See notes 1,3.	92.	ma gypeani acara, printed and painted, and any observation foliate accre
104	EXIST. HALL	Exist.	Exist.	EGB-1	EGB-1	EGB-1	EGB-1	EGB-1	0"	See notes 1,2.	NA/a II	
105	EXIST. BREAK RM.	Exist.	Exist.	EGB-1	EGB-1	EGB-1	EGB-1	EGB-1	9'6"	See note 1.	Wall	
106	EXIST. OFFICE	Exist.	Exist.	Exist.	Exist.	Exist.	Exist.	EGB-1	9'6"	See note 1.	EGB-1	Existing gyp. bd. to remain.
107	EXIST. BATH	Exist.	Exist.	EGB-1	EGB-1	EGB-1	EGB-1	EGB-1	9'6"	See notes 1.	Exist.	existing finish to remain
108	EXIST. CLOSET	Exist.	Exist.	EGB-1	EGB-1	EGB-1	EGB-1	EGB-1	9'6"	See notes 1.	GB-2	5/8" gypsum board, primed and painted
109	EXIST. STOR.	SC-1	N/A	Exist.	Exist.	Exist.	Exist.	EGB-1	9'8"	See note 1.		
200	LOBBY	WD-1	BW-1	GB-2	GB-2	GB-2	GB-2	GB-1	10'0"	See notes 1,3.	Dana	
201	CONFERENCE	WD-1	BW-1	GB-2	GB-2	GB-2	GB-2	GB-1	10'0"	See notes 1,3.	Base	
202	OFFICE	WD-1	BW-1	GB-2	GB-2	GB-2	GB-2	GB-1	10'0"	See notes 1,3.	BW-1	Finish 1x6 with base shoe, painted.
203	OFFICE	WD-1	BW-1	GB-2	GB-2	GB-2	GB-2	GB-1	10'0"	See notes 1,3.	Exist.	existing finish to remain
204	CLOSET	WD-1	BW-1	GB-2	GB-2	GB-2	GB-2	GB-1	10'0"	See notes 1,3.	N/A	Not Applicable / None
205	HVAC	SUB-1	N/A	GB-2	GB-2	GB-2	GB-2	EXP-1	0"	See notes 1,2,3.		
N/C	NTEO: 4 All	:::: <b>.c</b> : :		- 01 !	IAII IIDII	/El C	3	05 00 75	h O l		Floor	
INC	DTES: 1. All wall & o Developed	_	snes to b	e Class	A or B	(Flame S	Spread U-	25, 26-75 respective	ely; Smoke		Exist.	existing finish to remain
		•									SC-1	Sealed Concrete
	<ol><li>Ceiling he</li></ol>	ight varies									SUB-1	Exposed plywood subfloor.

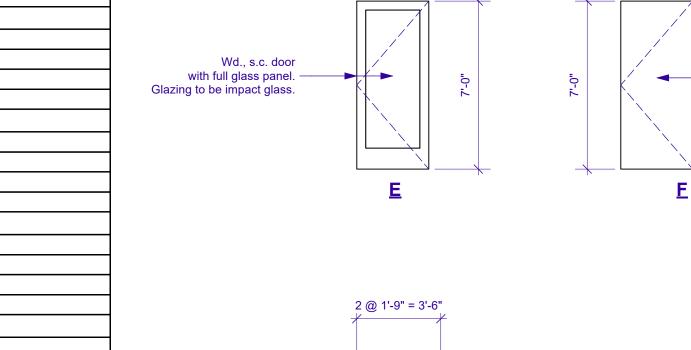

**Door Elevation Types** 

Exist. raised panel door -


Exist. raised panel doors —

1/4" = 1'-0"

— Exist. or new wd., s.c., flush


----- Wd., s.c., flush

Wd., s.c. door with full glass panel. ——— Glazing to be impact glass.	<u>E</u>	E.
	2 @ 1'-9" = 3'-6"	
Wd., s.c., flush ———	0-,2	

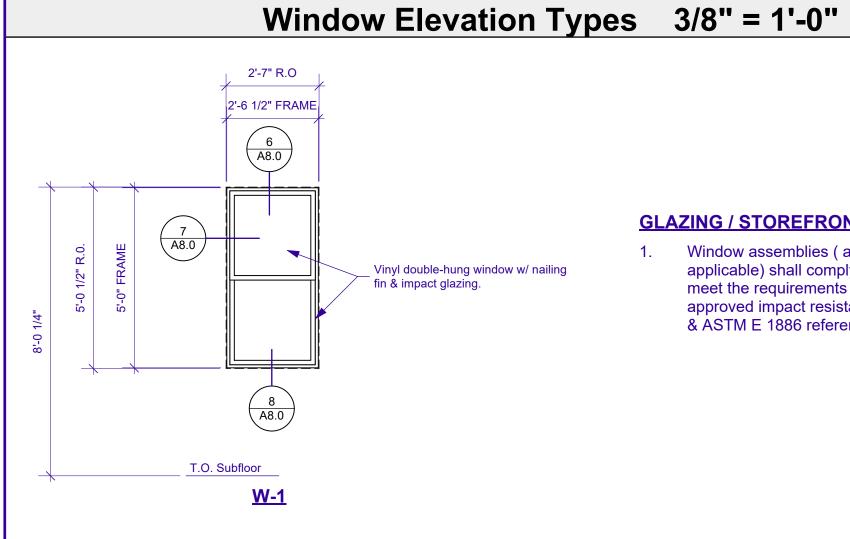



# **GLAZING / STOREFRONT NOTES**


Window assemblies ( and door assemblies as applicable) shall comply w/ IBC-2015:1609.1.2 - shall meet the requirements of the Large Missile Test of an approved impact resistant standard of ASTM E 1996 & ASTM E 1886 referenced therein.

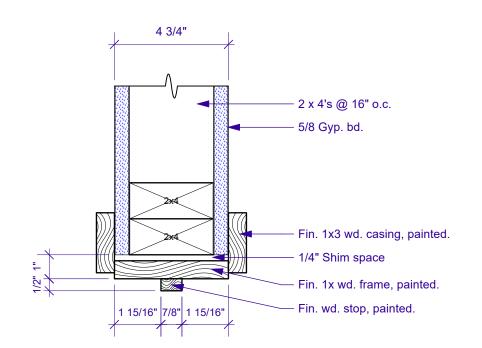

3/4" Blind nailed T&G oak wood flooring.

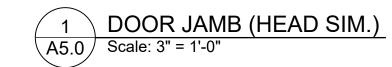

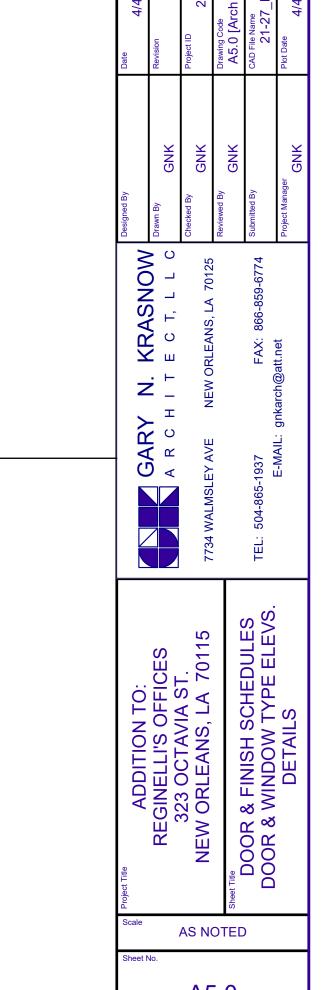

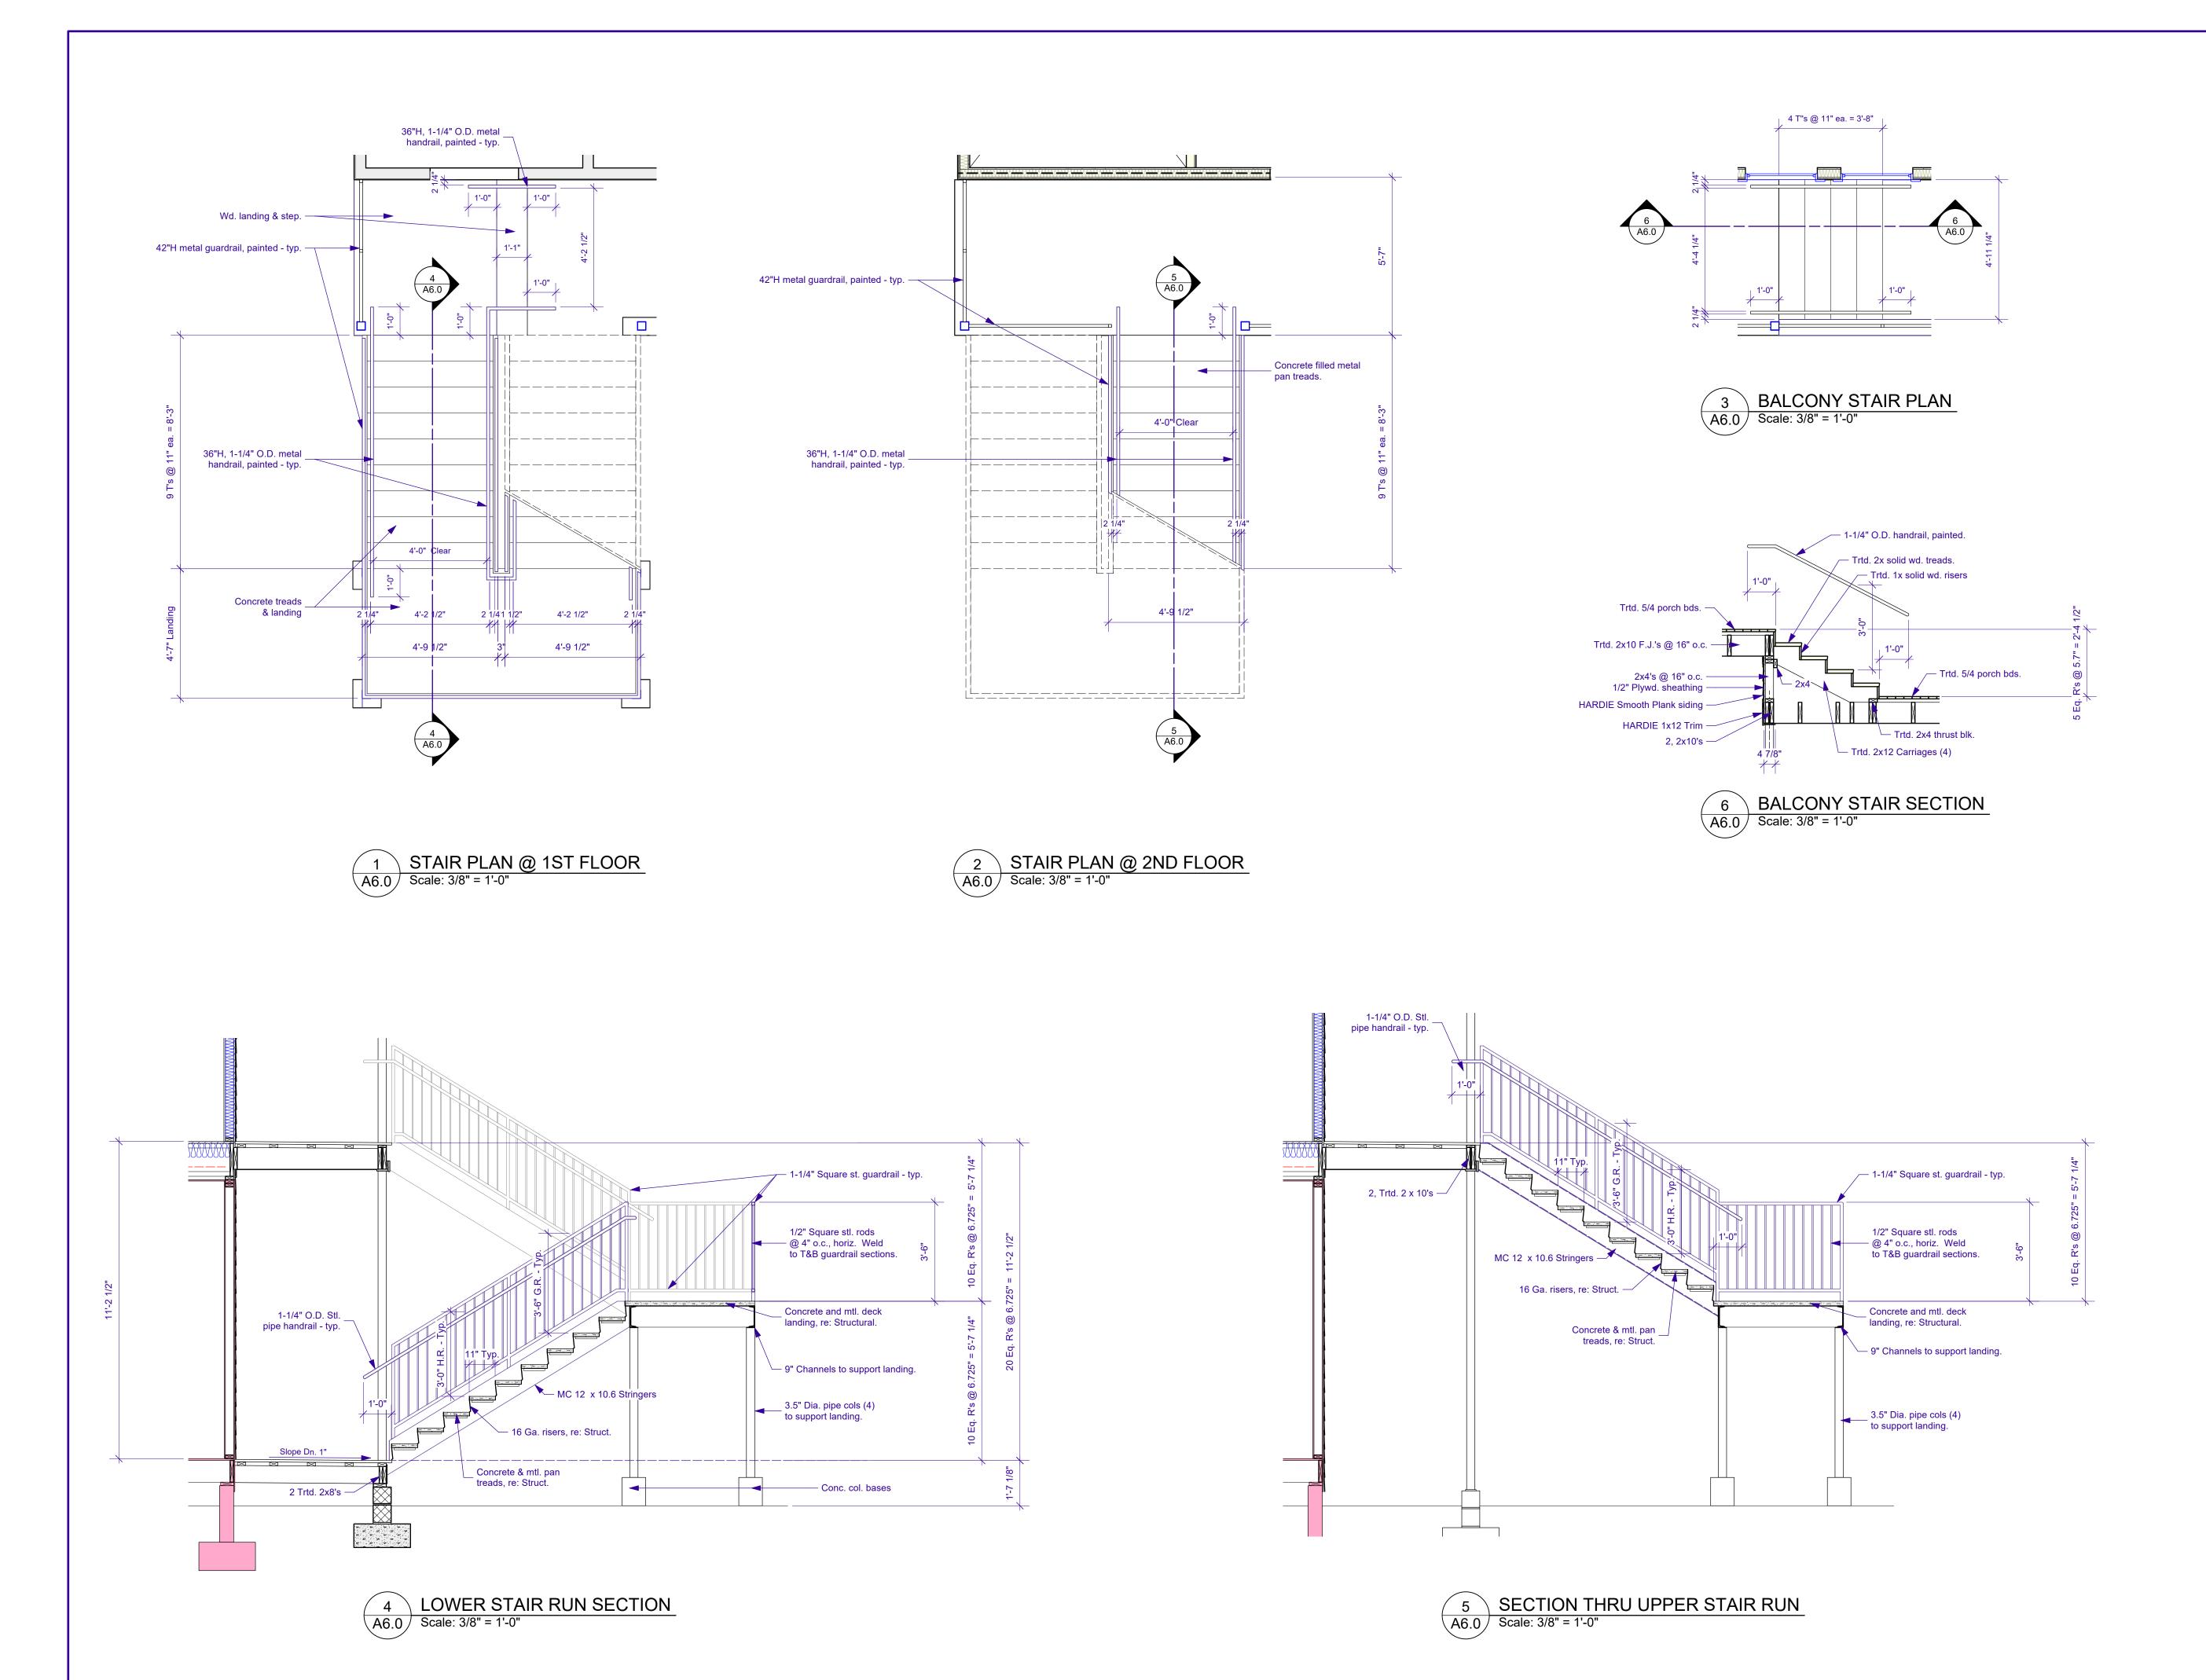



DITION TO:

CLI'S OFFICES

CTAVIA ST.

EANS, LA 70115

TEL: 504-865-1837

E-MAIL: gnkarch@att.net

CARRY N. KRASNOW

Designed By

Designed By

Drawn By

Checked By

GNK

A6.0 [Enlarged Plans-1]

Submitted By

CAD File Name

21-27 Prelim.vwx

A 4/4

A14/2022

AND

TEL: 504-865-1837


E-MAIL: gnkarch@att.net


Project Manager

CAD File Name

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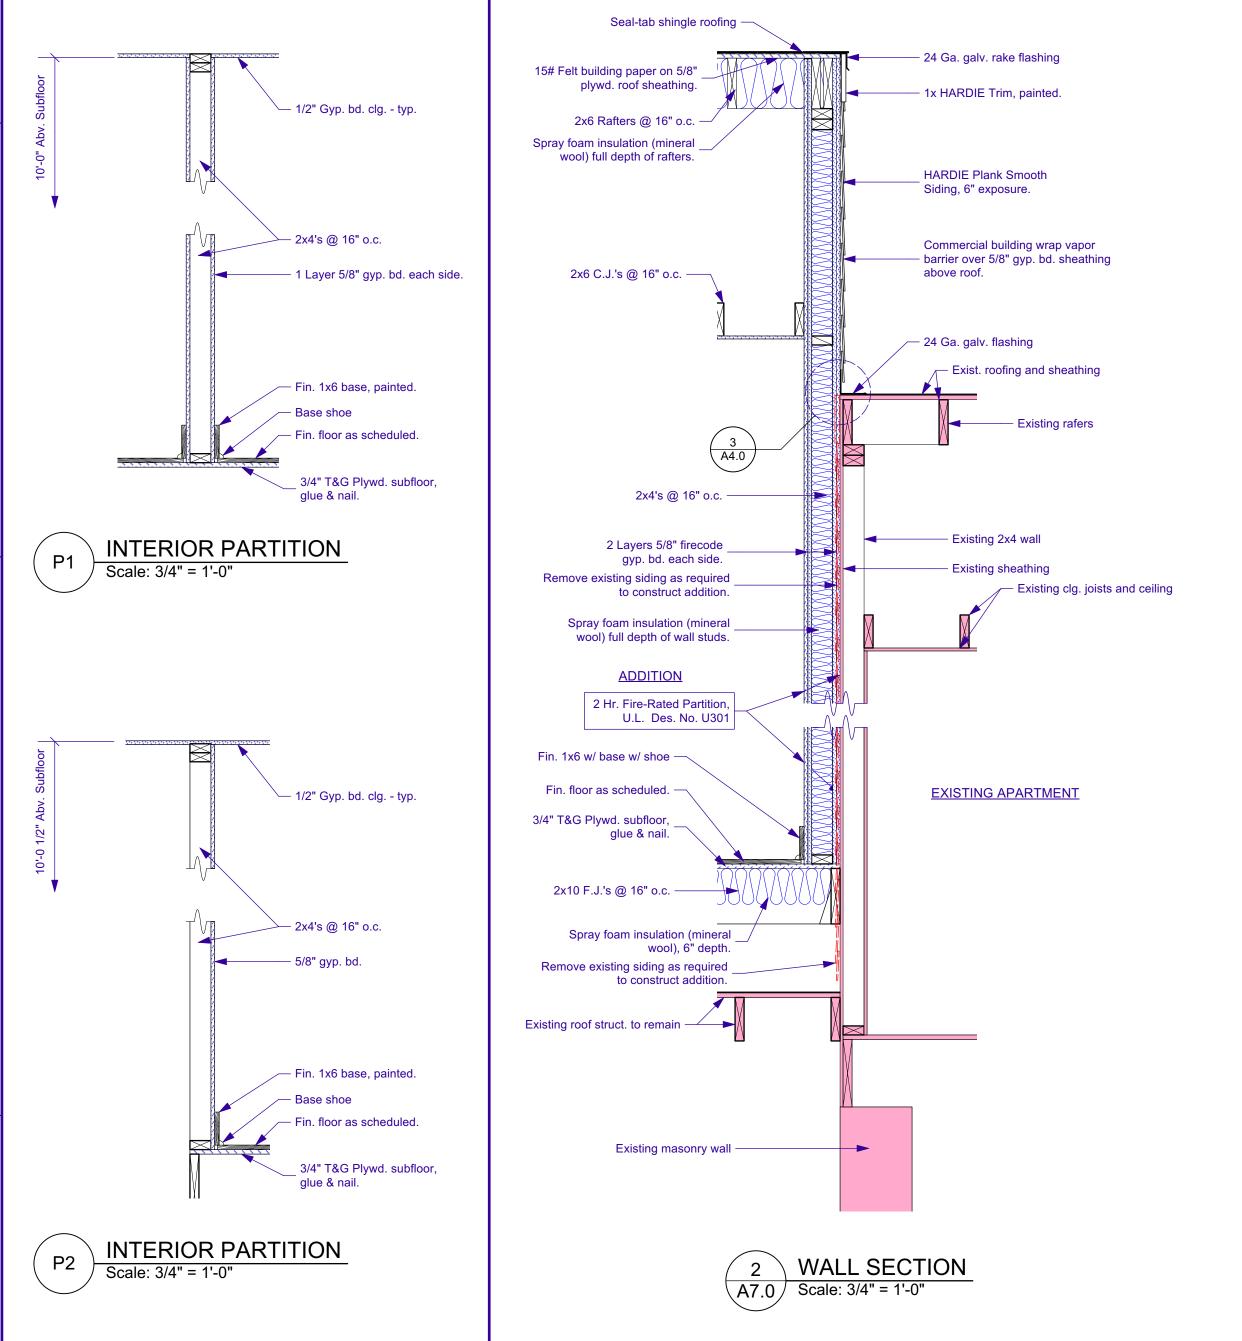




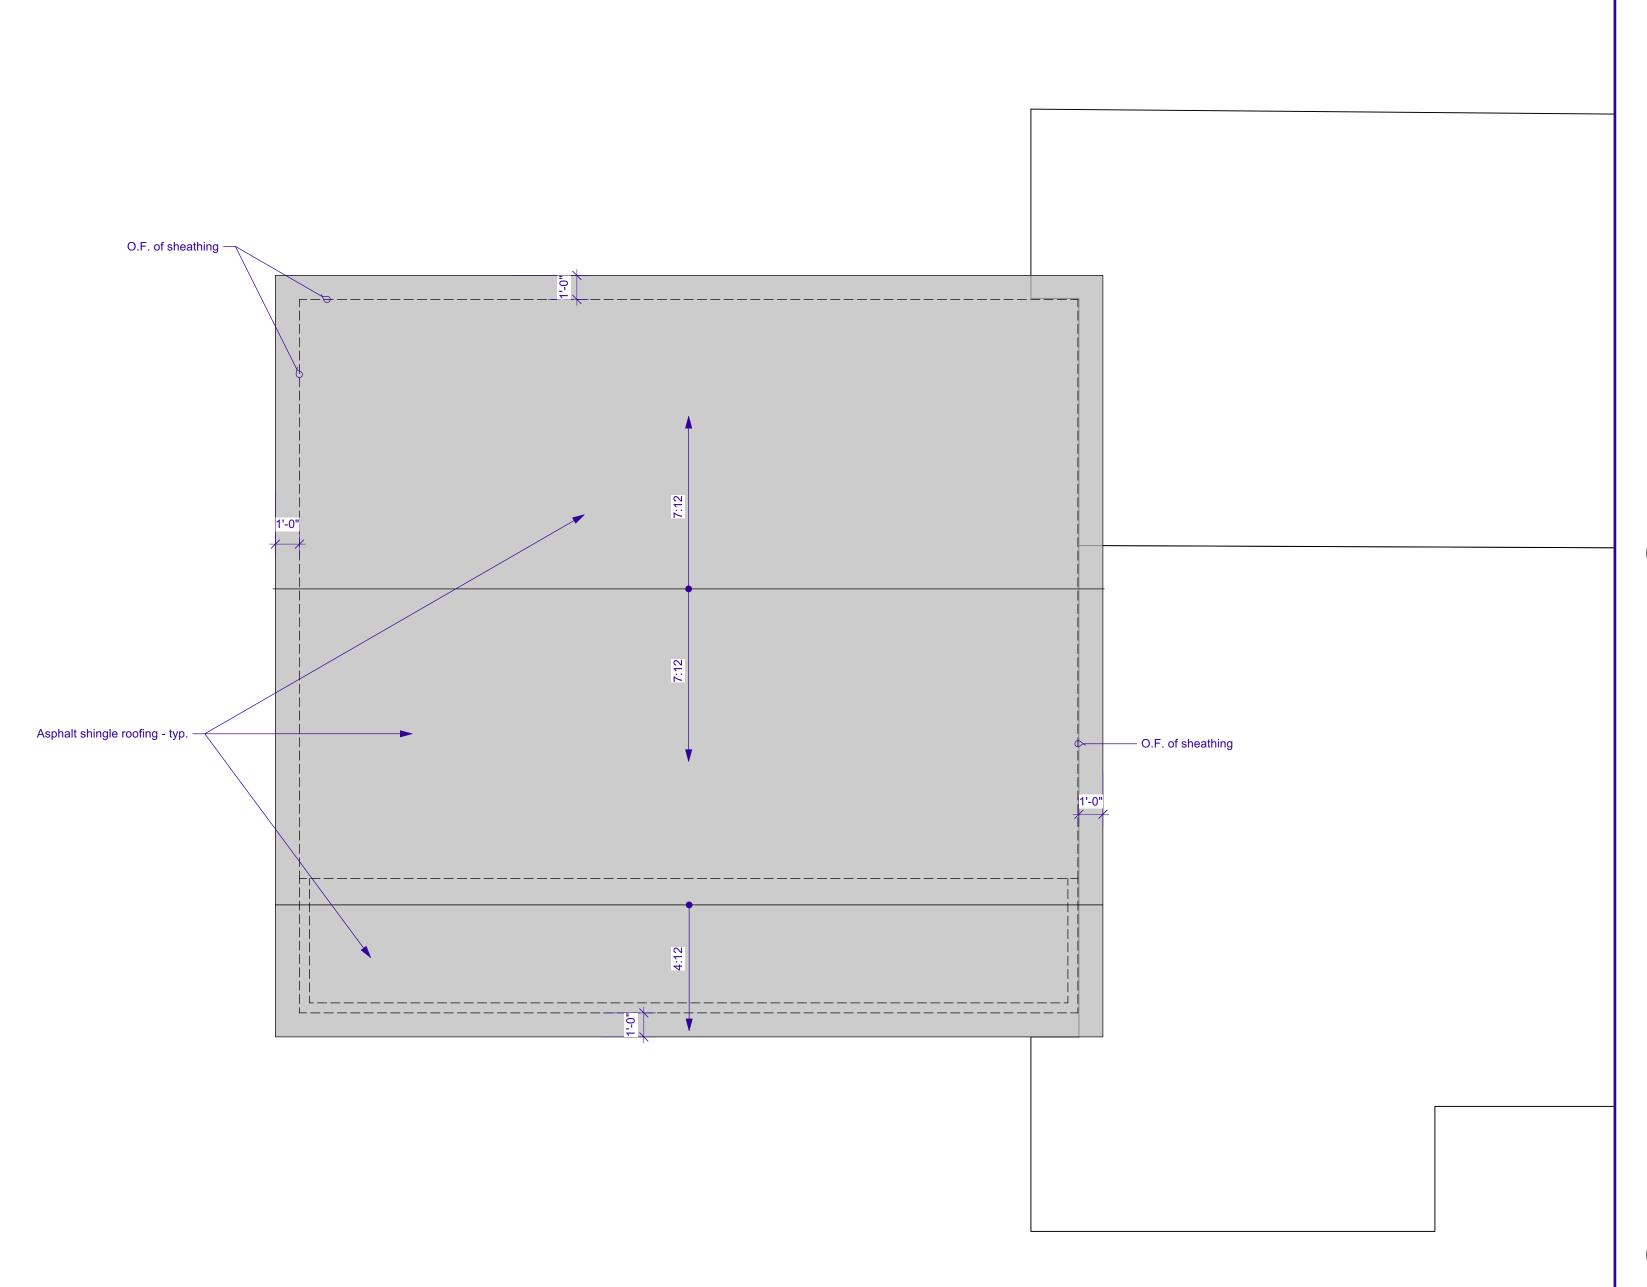
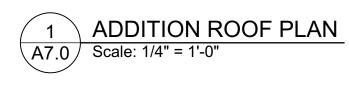
# **ADDITION ROOF PLAN NOTES**

- 1. All roofing to be shingle roofing u.o.n.
- Roof Shingles are to meet the following requirements: Class "A" rating; UL 997; Lifetime limited transferable warranty. GAF "Grand Timberline" shingles or approved equivalent. Owner to select color.
- 3. Provide 24" wide, 24 ga. galvanized valley flashing @ all roof valleys.
- At all Roof-to-Wall intersections provide 24 ga., galv. flashing. Extend up wall behind siding a min. of 4 inches, and extend over existing roof a min. of 4"
- 5. Refer to Exterior Elevations, Sht. A3.0 & A3.1 for downspout locations.
- 6. Provide 30# felt or 2 layers of 15 # felt building paper vapor barrier at roof sections with a slope of 4:12 or less.



GARY N. KRASNOW

A R C H I T E C T, L L C

7734 WALMSLEY AVE NEW ORLEANS, LA 70125

Sheet Title

REGINELLI'S OFFICES
323 OCTAVIA ST.

NEW ORLEANS, LA 70115


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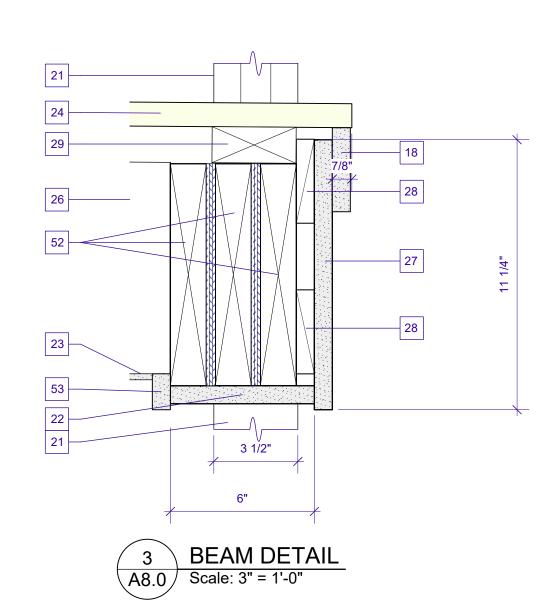
ADDITION ROOF PLAN
INTERIOR PARTITION


MALL SECTION

AS NOTED


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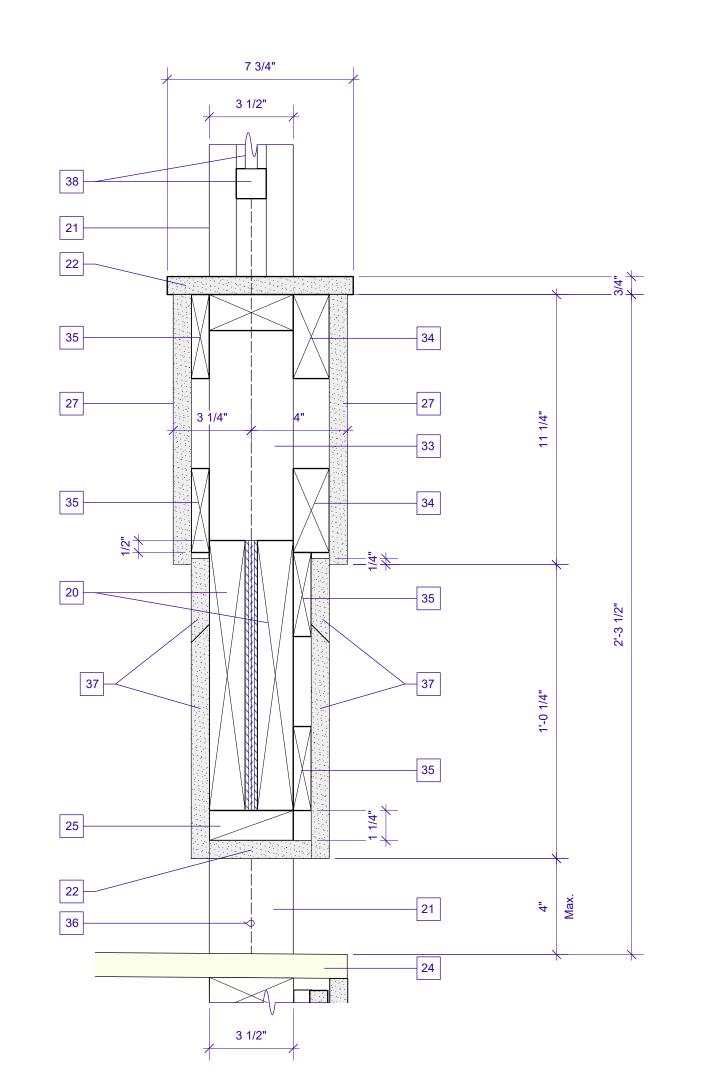





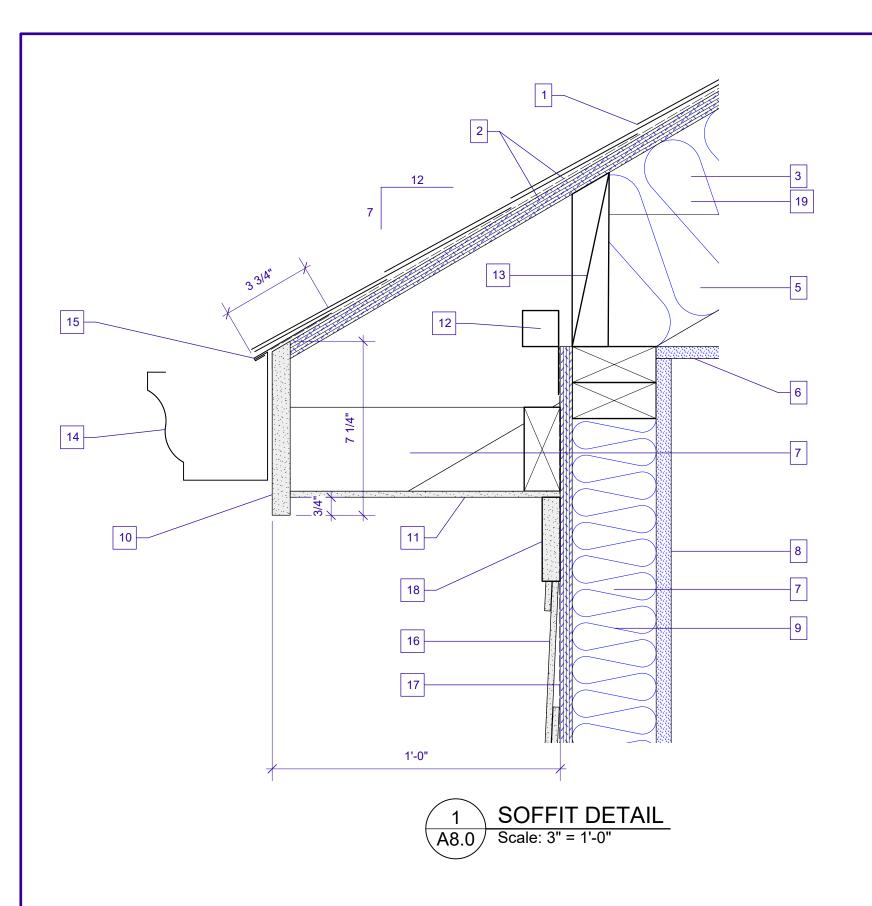


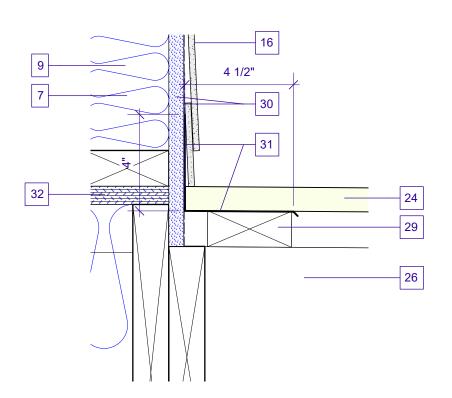





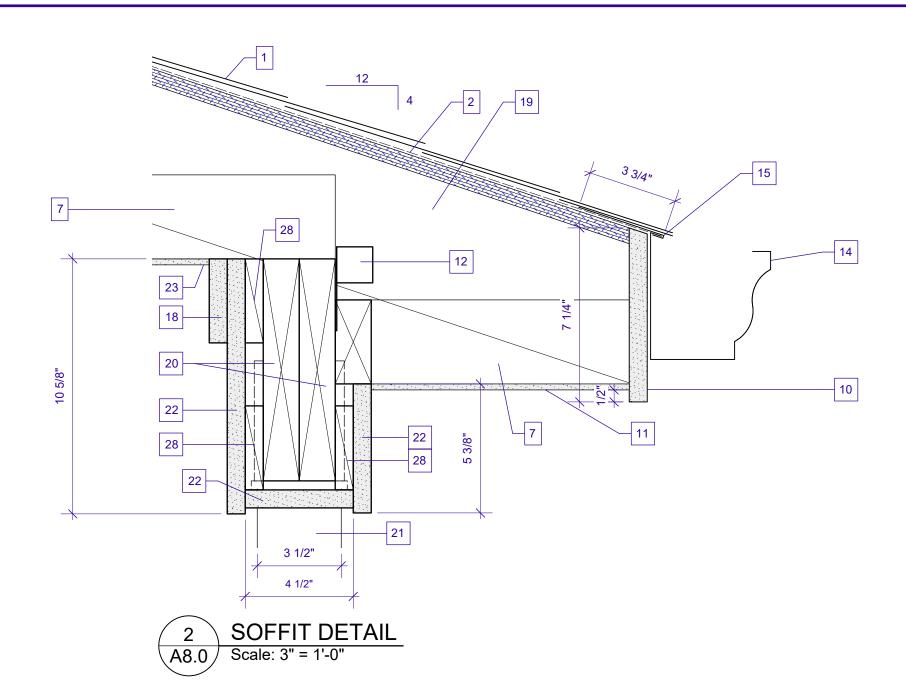


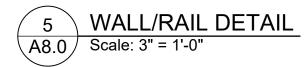


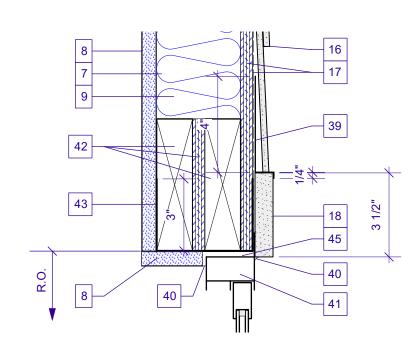


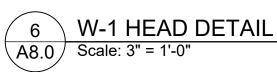


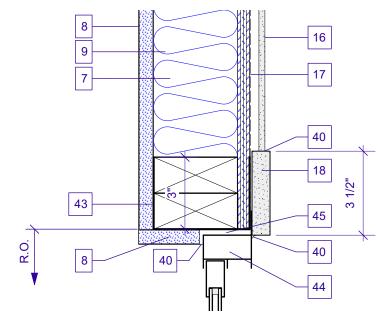

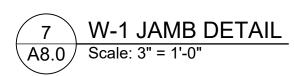

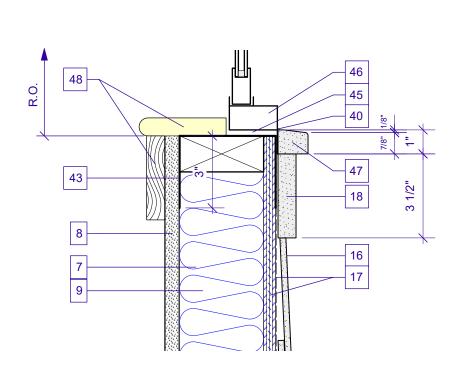

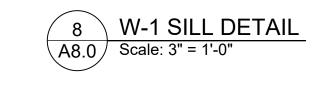

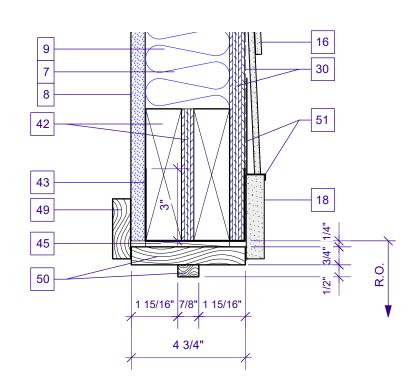


9 HEAD DETAIL DOOR 20 (JAMB SIM.)
A8.0 Scale: 3" = 1'-0"

### **KEY NOTES**

- 1. Seal-tab shingle roofing
- 2. 15# Felt building paper on 5/8" plywd. roof sheathing.
- 3. Spray foam insulation (mineral wool) full depth of rafters.
- 4. N/A
- 5. 2x6 Ceiling Joists @ 16" o.c.
- 6. 1/2" Gyp. bd. ceiling.
- 7. 2x4's @ 16" o.c. 8. 5/8" Gyp. bd.

studs.

- Spray foam insulation (mineral wool) full depth of wall
- 10. 1x8 HARDIE Smooth Trim fascia bd.
- 11. HARDIE Smooth Soffit board.
- 12. Hurricane ties @ each rafter, re: structural drawings.
- 13. 2x Insulation block.
- 14. Aluminum gutters and downspouts match existing.
- 15. 0.024" Aluminum edge flashing.
- 16. HARDIE Smooth Plank Siding w/ 6" exposure (match
- 17. Commercial building wrap vapor barrier over 1/2" plywood sheathing.
- 18. 1x4 HARDIE Smooth Trim bd., painted.
- 19. 2x6 Rafters @ 16" o.c.
- 20. 2, 2x10's, trtd.
- 21. 3.5" Square stl. column
- 22. 1x HARDIE Smooth Trim bd., rip to size shown, painted.
- 23. HARDIE Smooth Perforated Soffit bd., 1st twelve inches, Beaded Soffit bd, remainder of ceiling. Re: Reflected Ceiling Plans, Sht. A2.1
- 24. Trtd. 5/4 T&G porch bds., painted.
- 25. Trtd. blkg.
- 26. Trtd. 2x10 F.J.'s @ 16" o.c. Rip to form 1" slope.
- 27. 1x 12 HARDIE Smooth Trim bd., painted.
- 28. Trtd. 1x4 blkg.
- 29. Trtd. 2x4 sleepers @ 16" o.c.
- 30. Commercial building wrap vapor barrier over 5/8" plywood sheathing @ front wall. 5/8" Firecode gyp. sheathing @ fire-rated portion of the front wall.
- 31. 24 Ga. galv. flashing.
- 32. 3/4" T&G Plywd. subfloor, glue & nail.
- 33. Trtd. 2x4's @ 16" o.c.
- 34. Trtd. 2x4
- 35. Trtd. 1x4 Centerline of column
- 37. 1x HARDIE Trim spliced to create width shown. Miter splice. Painted.
- 38. 42"H Metal guardrail, painted. Re: 3/A7.0
- 39. 24 Ga. galv. flashing, painted.
- 40. Sealant
- 41. W-1 Window head section w/ nailing fin.
- 42. 2,2x6 Lintel w/ 1/2" plywood spacer.
- 43. Wrap opgs. w/ self-adhered membrane flashing.
- 44. W-1 Window jamb section w/ nailing fin.
- 1/4" Shim space.
- 46. W-1 Window sill section w/ nailing fin.
- 47. 5/4 HARDIE Smooth Trim window sill, painted.
- 48. Fin. wood window stool and casing. Match existing window trim on 1st floor.
- 49. Fin. 1x3 wood casing, painted. Verify w/ the Owner.
- 50. Fin. 1x Wood casing and stop, painted,
- 51. 24 Ga. galv. flashing, painted. Omit @ jamb.
- 52. 3, 2x10's Trtd. w/ 3/8" plywood plates, or 2, 2x10's w/ 2x blkg. See structural drawings for beam sizes.
- 53. 1x2 HARDIE Trim, painted.

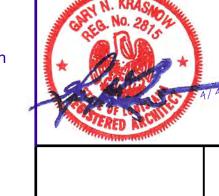

NO N		4/4/2022			
	Drawn By GNK	Revision			
A 70125	Checked By GNK	Project ID 21-27			
	Reviewed By GNK	Drawing Code A7.1 [Arch Detl/Sched-2]			
359-6774	Submitted By	CAD File Name 21-27_Prelim.vwx	٥	4/4/2022	Release for Permits
	Project Manager	Plot Date	, ,	1112022	Tologoo lol i ollino
	GNK	4/4/2022	No.	Date	Issue No

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AS NOTED

A8.0

#### I. GENERAL

- A. Contractor Responsibility Construction documents represent the finished structure. Contractor is responsible for construction means, methods, sequences and safety precautions, including but not limited to shoring and temporary bracing.
- B. Omissions & Conflicts Omissions or conflicts between various elements of the construction documents should be brought to the attention of the design team. If certain features are not fully delineated in the construction documents, their construction shall be of the same character as for similar conditions that are delineated.
- C. Existing Conditions The Contractor shall verify the existing conditions and dimensions in the field. The Contractor shall report any discrepancies between the drawings and the actual existing conditions and dimensions to the Engineer.

#### II. DESIGN BASIS

- A. Applicable Codes and Standards International Residential Code 2015 ASCE 7-2010
- B. Design Loads

Roof High Slope	
Live Load	18 psf
Dead Load	7 psf
Porch Roof	-
Live Load	20 psf
Dead Load	6 psf
Attic	_
Live Load	10 psf
Dead Load	4 psf
Porch Ceiling	
Live Load	10 psf
Dead Load	4 psf
2nd Floor	
Live Load	50 psf
Dead Load	16 psf
2nd Porch	
Live Load	80 psf
Dead Load	7 psf
1st Floor	
Live Load	50 psf
Dead Load	7 psf
Stair	
Live Load	100 psf
Dead Load	10 psf

# Wind Load

The criteria is based on ASCE 7-2010 Minimum Design Loads for Buildings and Other Structures:

<b>Basic Wind Velocity</b>	143 mph
Risk Category	II
Exposure	В

# III. MATERIALS

# A. EARTHWORK

Place footings on undisturbed soil. Notify the Engineer if "soft spots", underground obstructions, or any unusual condition is encountered during stripping, excavation or filling. Soil bearing capacity is 800 psf.

# B. CONCRETE

All concrete work shall conform to ACI 301 Specification for Structural Concrete for Buildings and meet the following requirements: Concrete - Type I cement ASTM C 150, normal weight aggregates ASTM C 33, 3000 psi at 28 days, 5" slump. Reinforcing Steel - ASTM A615 grade 60, welded wire fabric ASTM A185. **Reinforcing Steel Details** - Except as noted otherwise where continuous reinforcing is specified, hook bars at non-continuous ends. Lap bars as indicated below: Lap Splices #3 1'4" #4 1'4" #5 1'7" Welded wire fabric - two spaces. Provide the following cover for reinforcing: Footings 3" bottom and sides.

# C. CONCRETE MASONRY UNITS

All concrete masonry work shall conform to ACI 531.1 Specification for Masonry Construction. Concrete Masonry Units - ASTM C90, grade N, type 1, lightweight units. Mortar - ASTM C270, type S. Grout - ASTM C476. Reinforcing Steel - ASTM 615 grade 60, wire steel shall be ASTM A82. **Reinforcing Details** Lap reinforcing as indicated below: Lap splices Wire joint reinforcing - 1'0" The masonry assemble shall achieve a unit strength (fm') = 1500 psi.

#### D. STRUCTURAL STEEL

All detailing, fabrication and erection of structural steel shall conform to AISC Specification for the Design, Fabrication and Erection of Structural Steel for Buildings, the AWS D1.1 Structural Welding Code and meet the following requirements: Steel Channels, Angles, Rods and Plates: ASTM A 36, yield strength 36 ksi except

where noted otherwise in sections.

**Tube** - ASTM A500 Grade B. **Anchor Bolts** - ASTM A307 Welding Materials - E70XX.

**Paint** - One coat shop applied red oxide, Type 1 primer - 2 mils thick. Do not paint surfaces to be welded, embedded in concrete or masonry, or contact surfaces of friction connections.

All welding by certified welders and in accordance with AWS D1.1, structural welding code. All electrodes used for submerged arc and shielded metal arc welding shall be compatible with the structural steel as specified in AWS and AISC.

#### E. LIGHT GAUGE METAL FRAMING ACCESSORIES

Joists hangers shall be type "U" unless indicated otherwise on the drawings as manufactured by the Simpson Strong-Tie Company. Install joists hangers where beams frame into beams at the same elevation and in strict accordance with the manufacturer's specifications. All steel parts for wood connections in contact with treated lumber shall be hot-dipped galvanized coated conforming to ASTM A653 Class G-185 minimum required weight of zinc coating total both sides of 1.85 ounces per square foot:

#### F. BOISE CASCADE ENGINEERED WOOD PRODUCTS

All structural members fabricated by the Boise Cascade Corporation shall be erected and braced in strict accordance with the manufacturer's specifications. All members designated as "LVL" shall be laminated veneer lumber having properties and strengths equal to the Boise Cascade Corporation "VERSA-LAM".

#### G. WOOD FRAMING

All wood framing fabrication and erection shall conform to the National Design Specification for Wood Construction by the NFPA, the Plywood Design Specification by the APA and meet the requirements below. Unless noted otherwise all wood connections shall be in accordance with the fastening schedule of the International Residential Code. All lumber in contact with concrete or masonry shall be treated:

**Framing Lumber** - Southern Yellow Pine, S4S, No. 2, maximum moisture content

**Floor Framing** - Provide bridging for dimensioned lumber floor joists at 8'-0" o.c.

**Plywood Flooring** - APA rated 48/24, 3/4" thick. Nail with 12d nails spaced at 6" o.c. at panel ends and 12" o.c. at intermediate supports. **Plywood Roofing** - APA rated 32/16, 5/8" thick. Nail with 10d ring shank nails spaced at 6" o.c. at panel edges and 12" o.c. at intermediate supports. **Wall Sheathing** - APA rated 32/16, 1/2" on all the exterior walls to brace the structure for wind loads. Nail plywood edges with 8d nails at 6" o.c. at panel edges and 12" o.c. at intermediate supports. Provide solid blocking at all panel edges.

# IV.ab**MISCELLANEOUS**

- No change in size or dimension of structural members shall be made without the written approval of the professional of record.
- The contractor is responsible for limiting the amount of construction load imposed upon structural framing. Construction loads shall not exceed the design capacity of the
- framing at the time the loads are imposed. The structure is designed to function as a unit upon completion. The contractor is responsible for furnishing all temporary bracing and/or support that may be required as the result of the contractor's construction methods and/or sequences.
- The contractor shall inform the professional of record in writing of any deviation from the contract documents. The contractor shall not be relieved of the responsibility of such deviation by the professional of record review of shop drawings, product data, etc., unless the contractor has specifically informed the professional of record of such deviation at the time of submission, and the professional of record has given written approval to the specific deviation.

# ∀. QUALITY CONTROL

A. The following work requires inspections:

1. Reinforcing Steel 2. Concrete Placement 3. CMU Piers and Walls 4. Structural Steel 5. Wood Framing

B No work shall be done without inspectors knowledge.

REVISIONS:



oh

ENGINEER Y COMPANY

CONSULTING E BOSE, JOHN C. A PROFES


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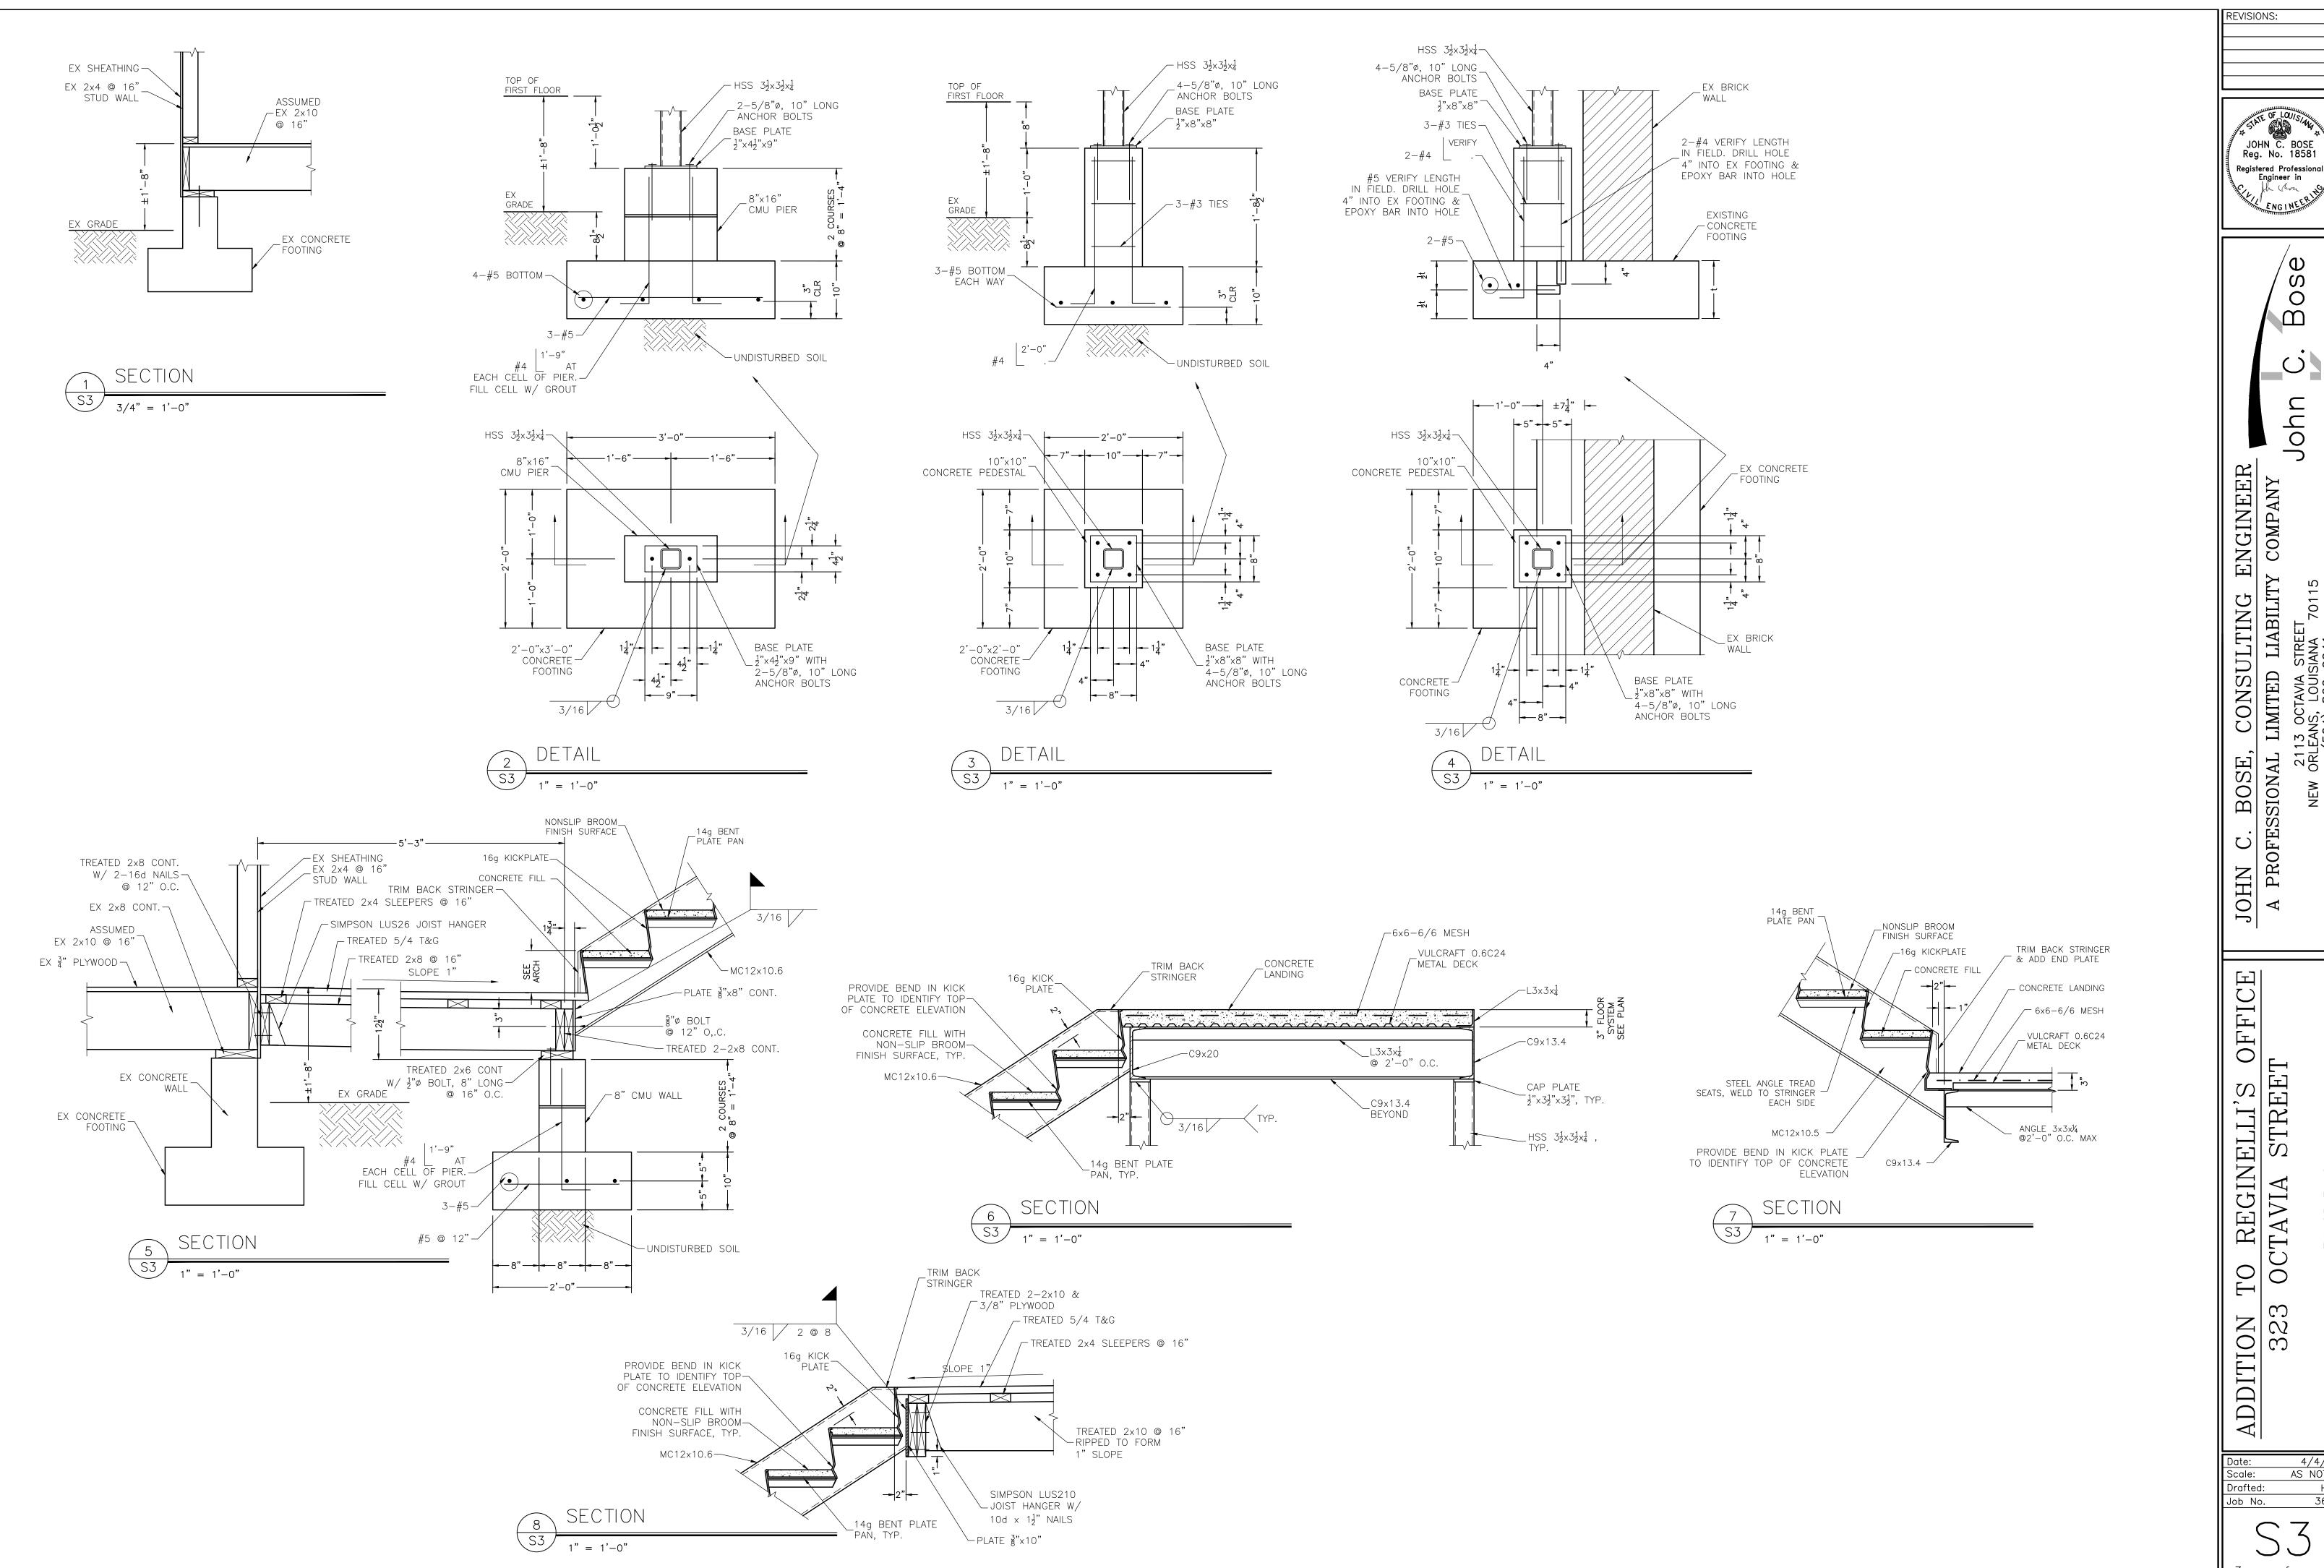
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ADDITION

Scale: AS NOTE Drafted: Job No.





ohn BOSE, CONSULTING ENGINEER
SSIONAL LIMITED LIABILITY COMPANY

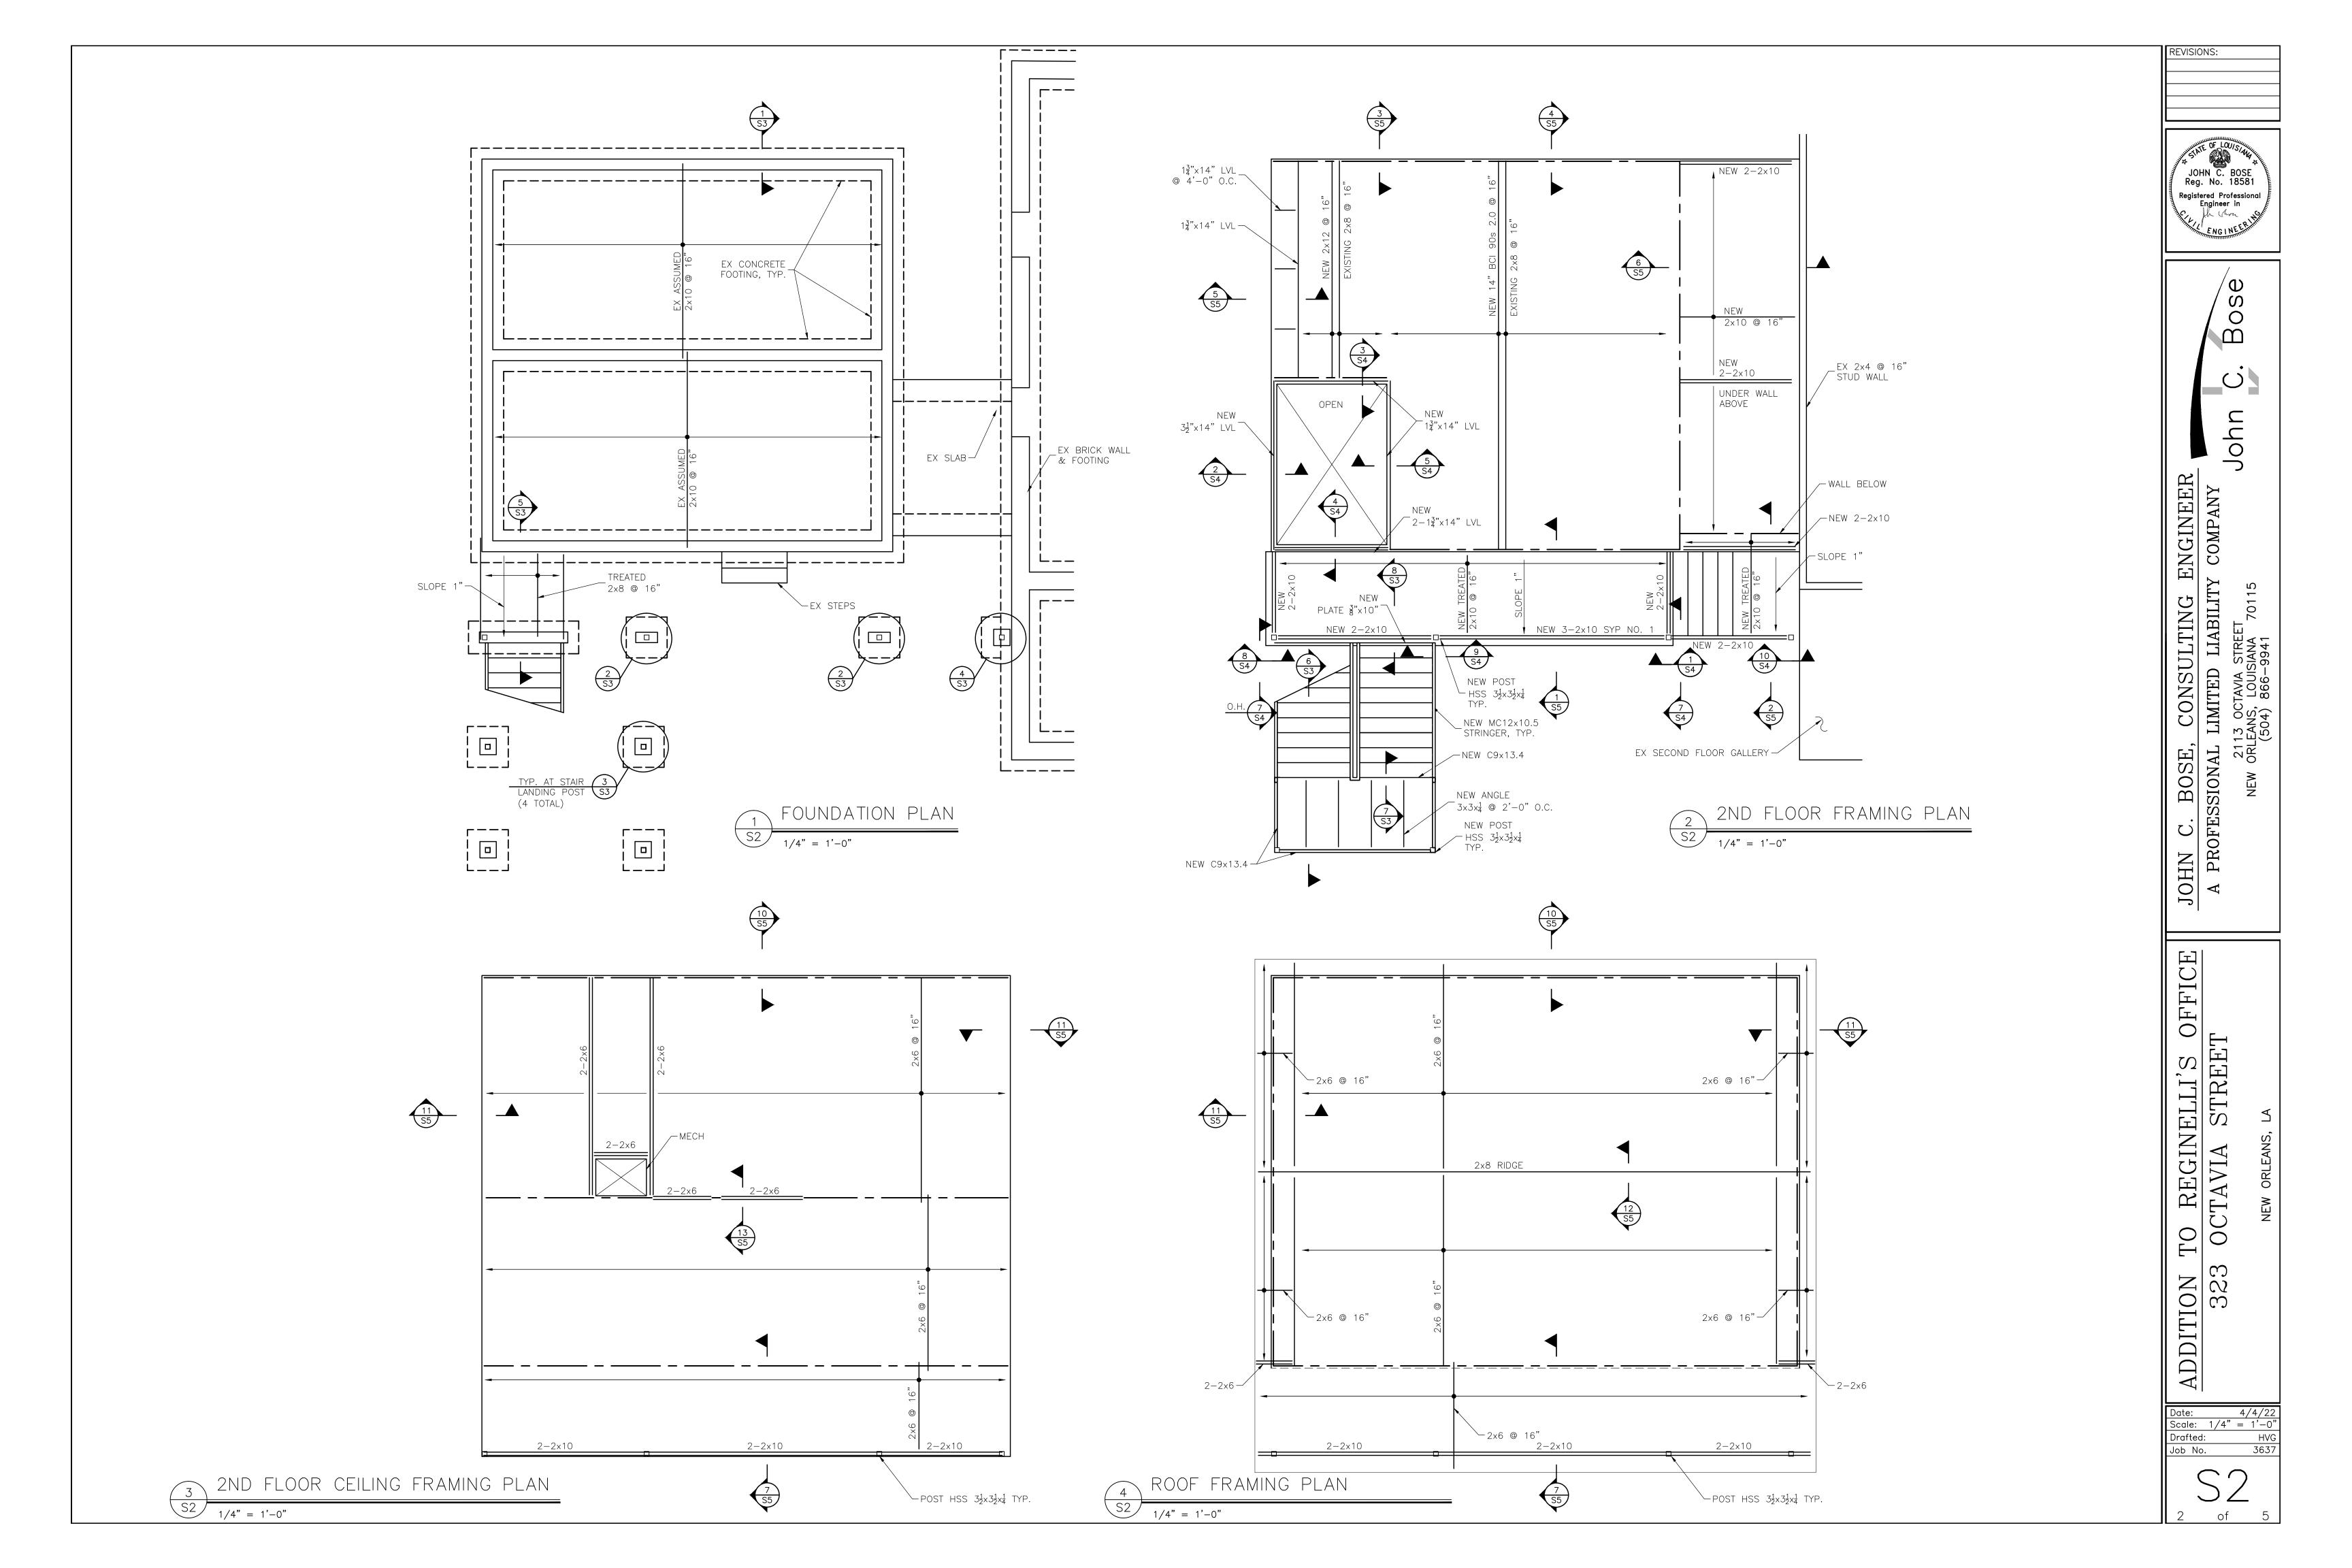2113 OCTAVIA STREET


NEW ORLEANS, LOUISIANA 70115
(504) 866–9941 JOHN C. A PROFES

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ADDITION 323

4/4/22 Scale: AS NOTE Drafted: Job No.



JOHN C. A PROFES ADDITION TO REGINELLI'S OFFICE 323 OCTAVIA STREET

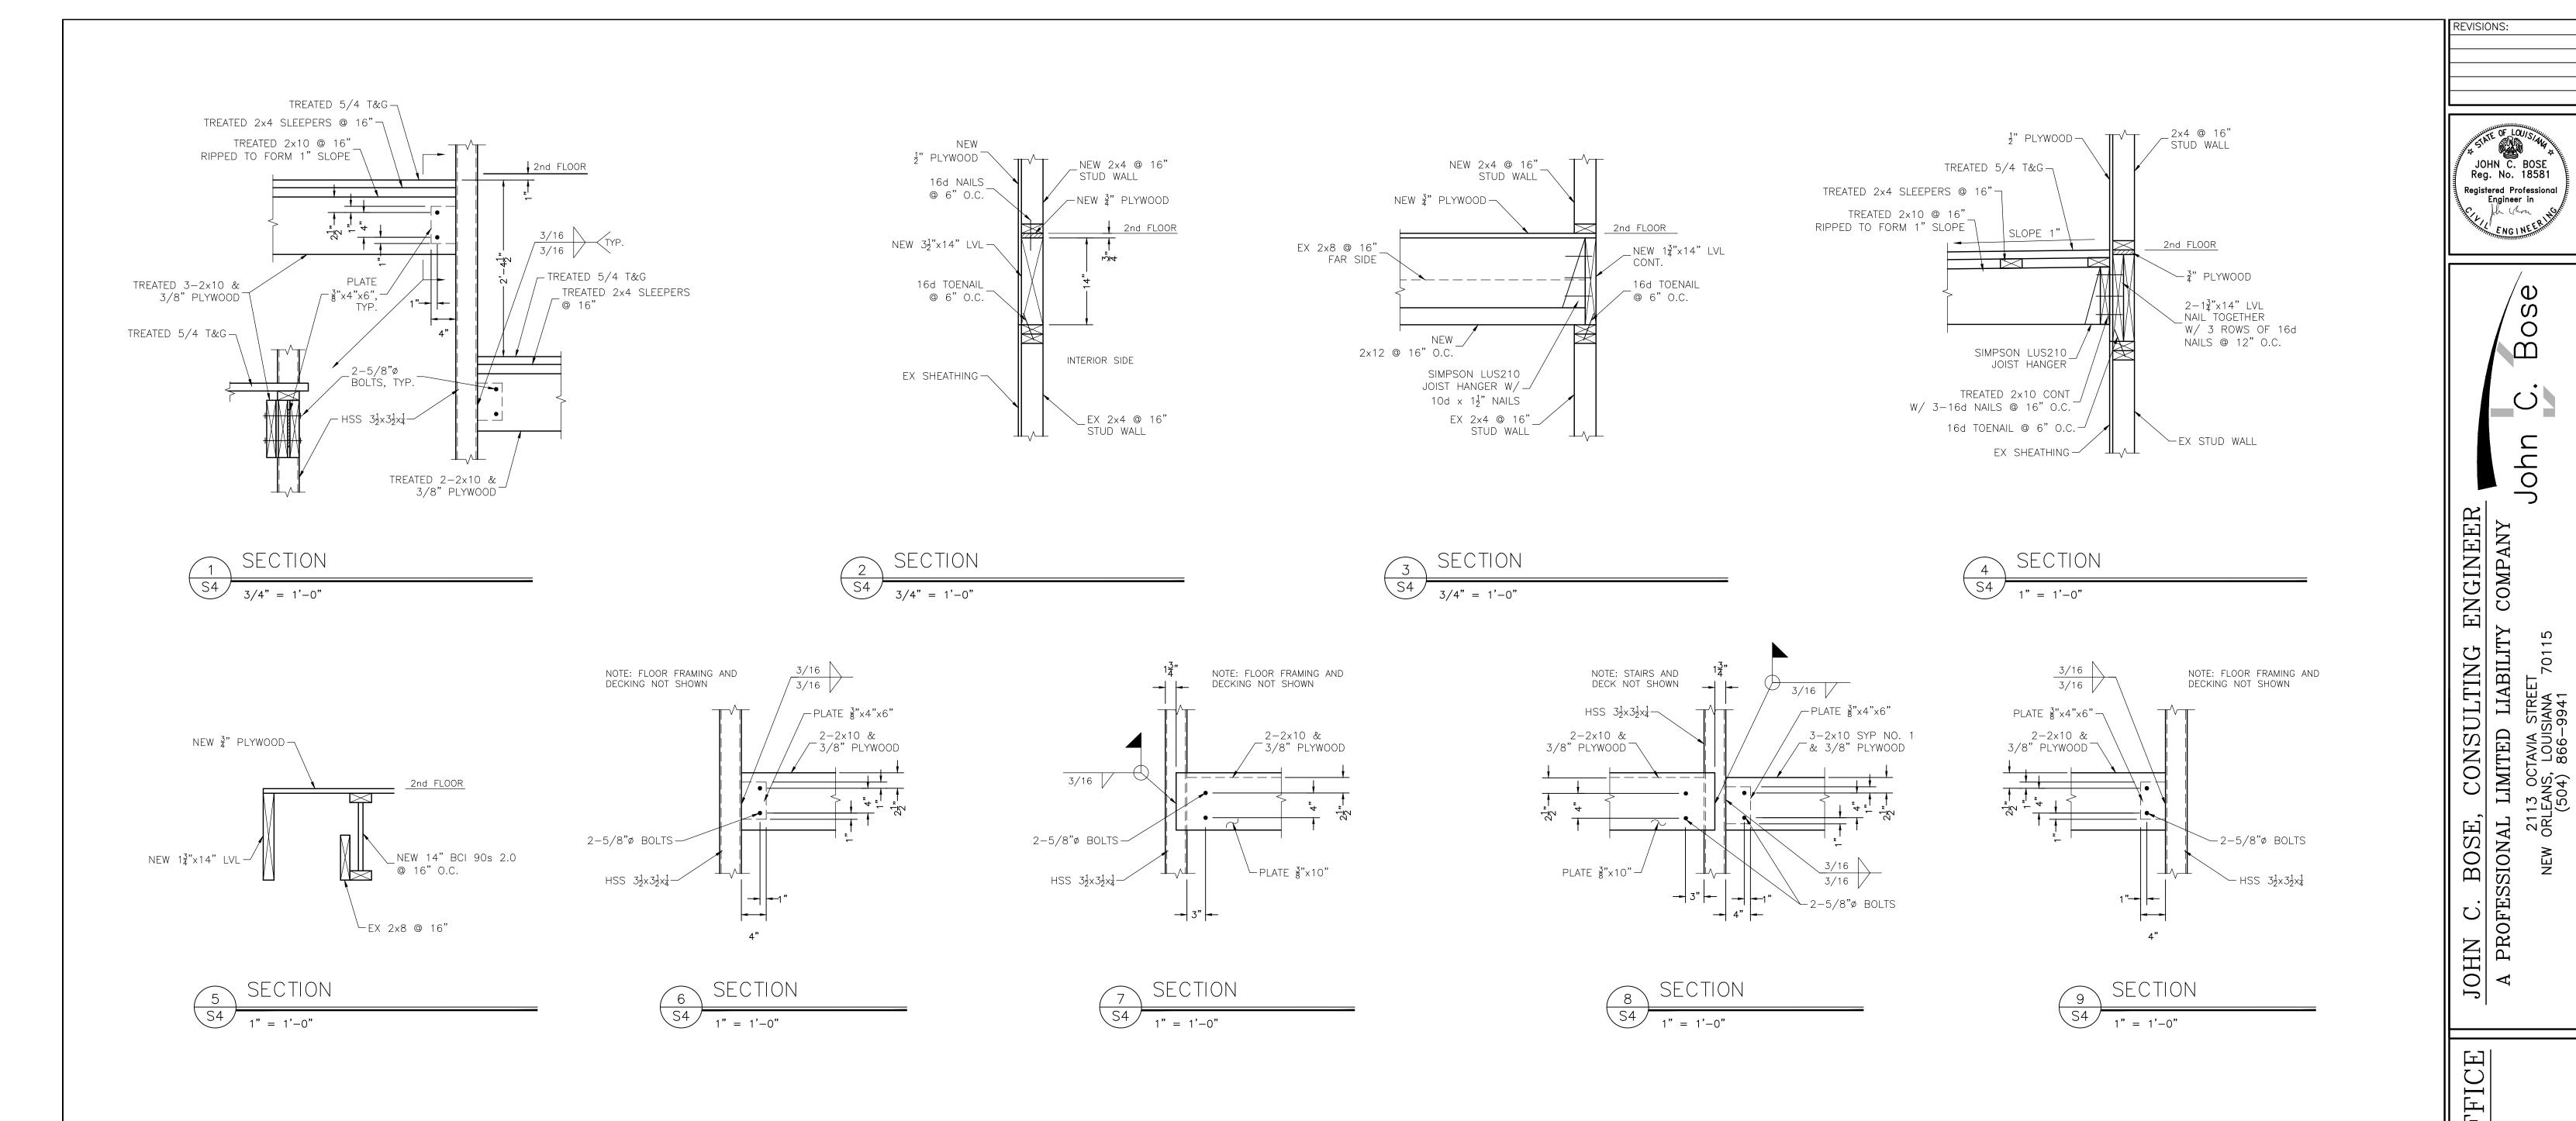
JOHN C. BOSE Reg. No. 18581


Registered Professional Engineer in


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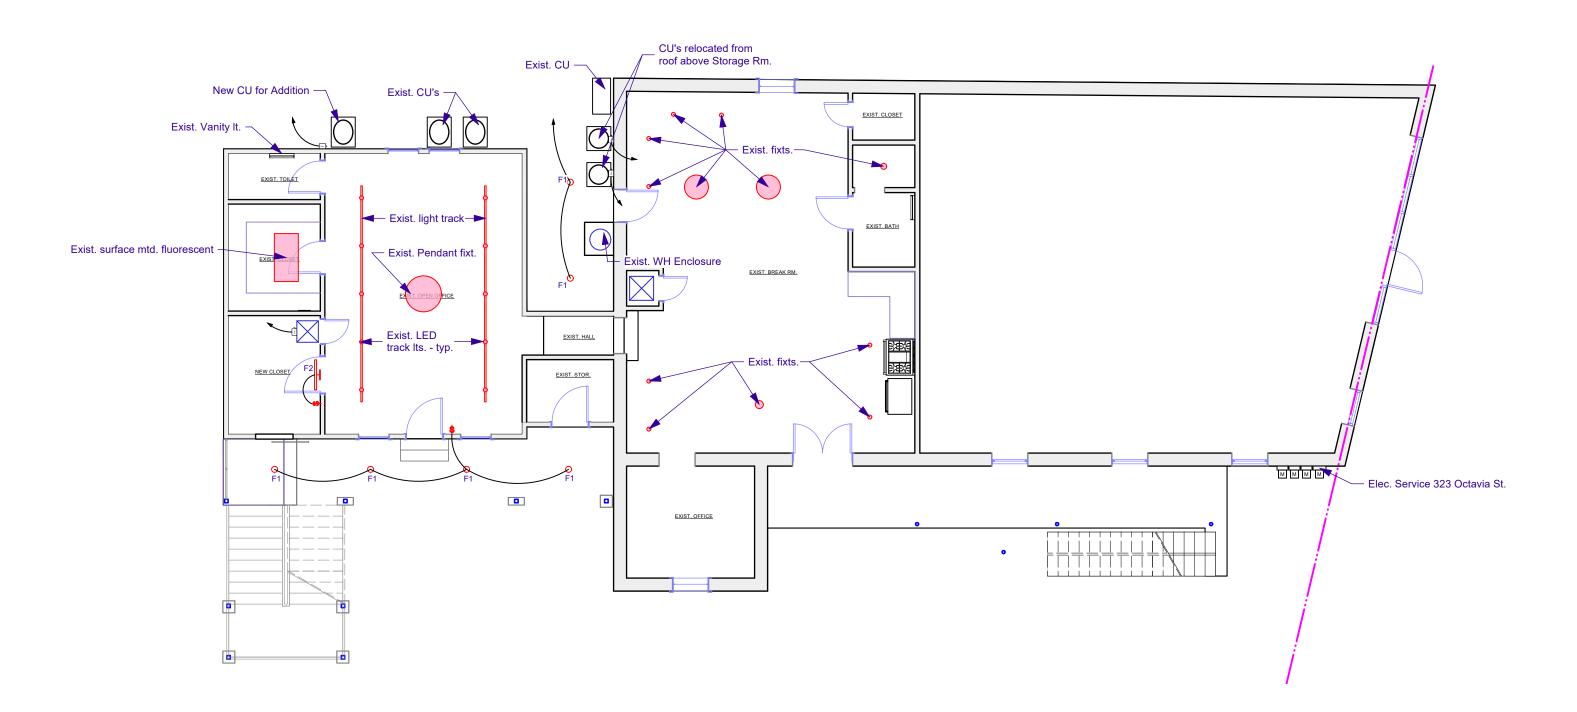





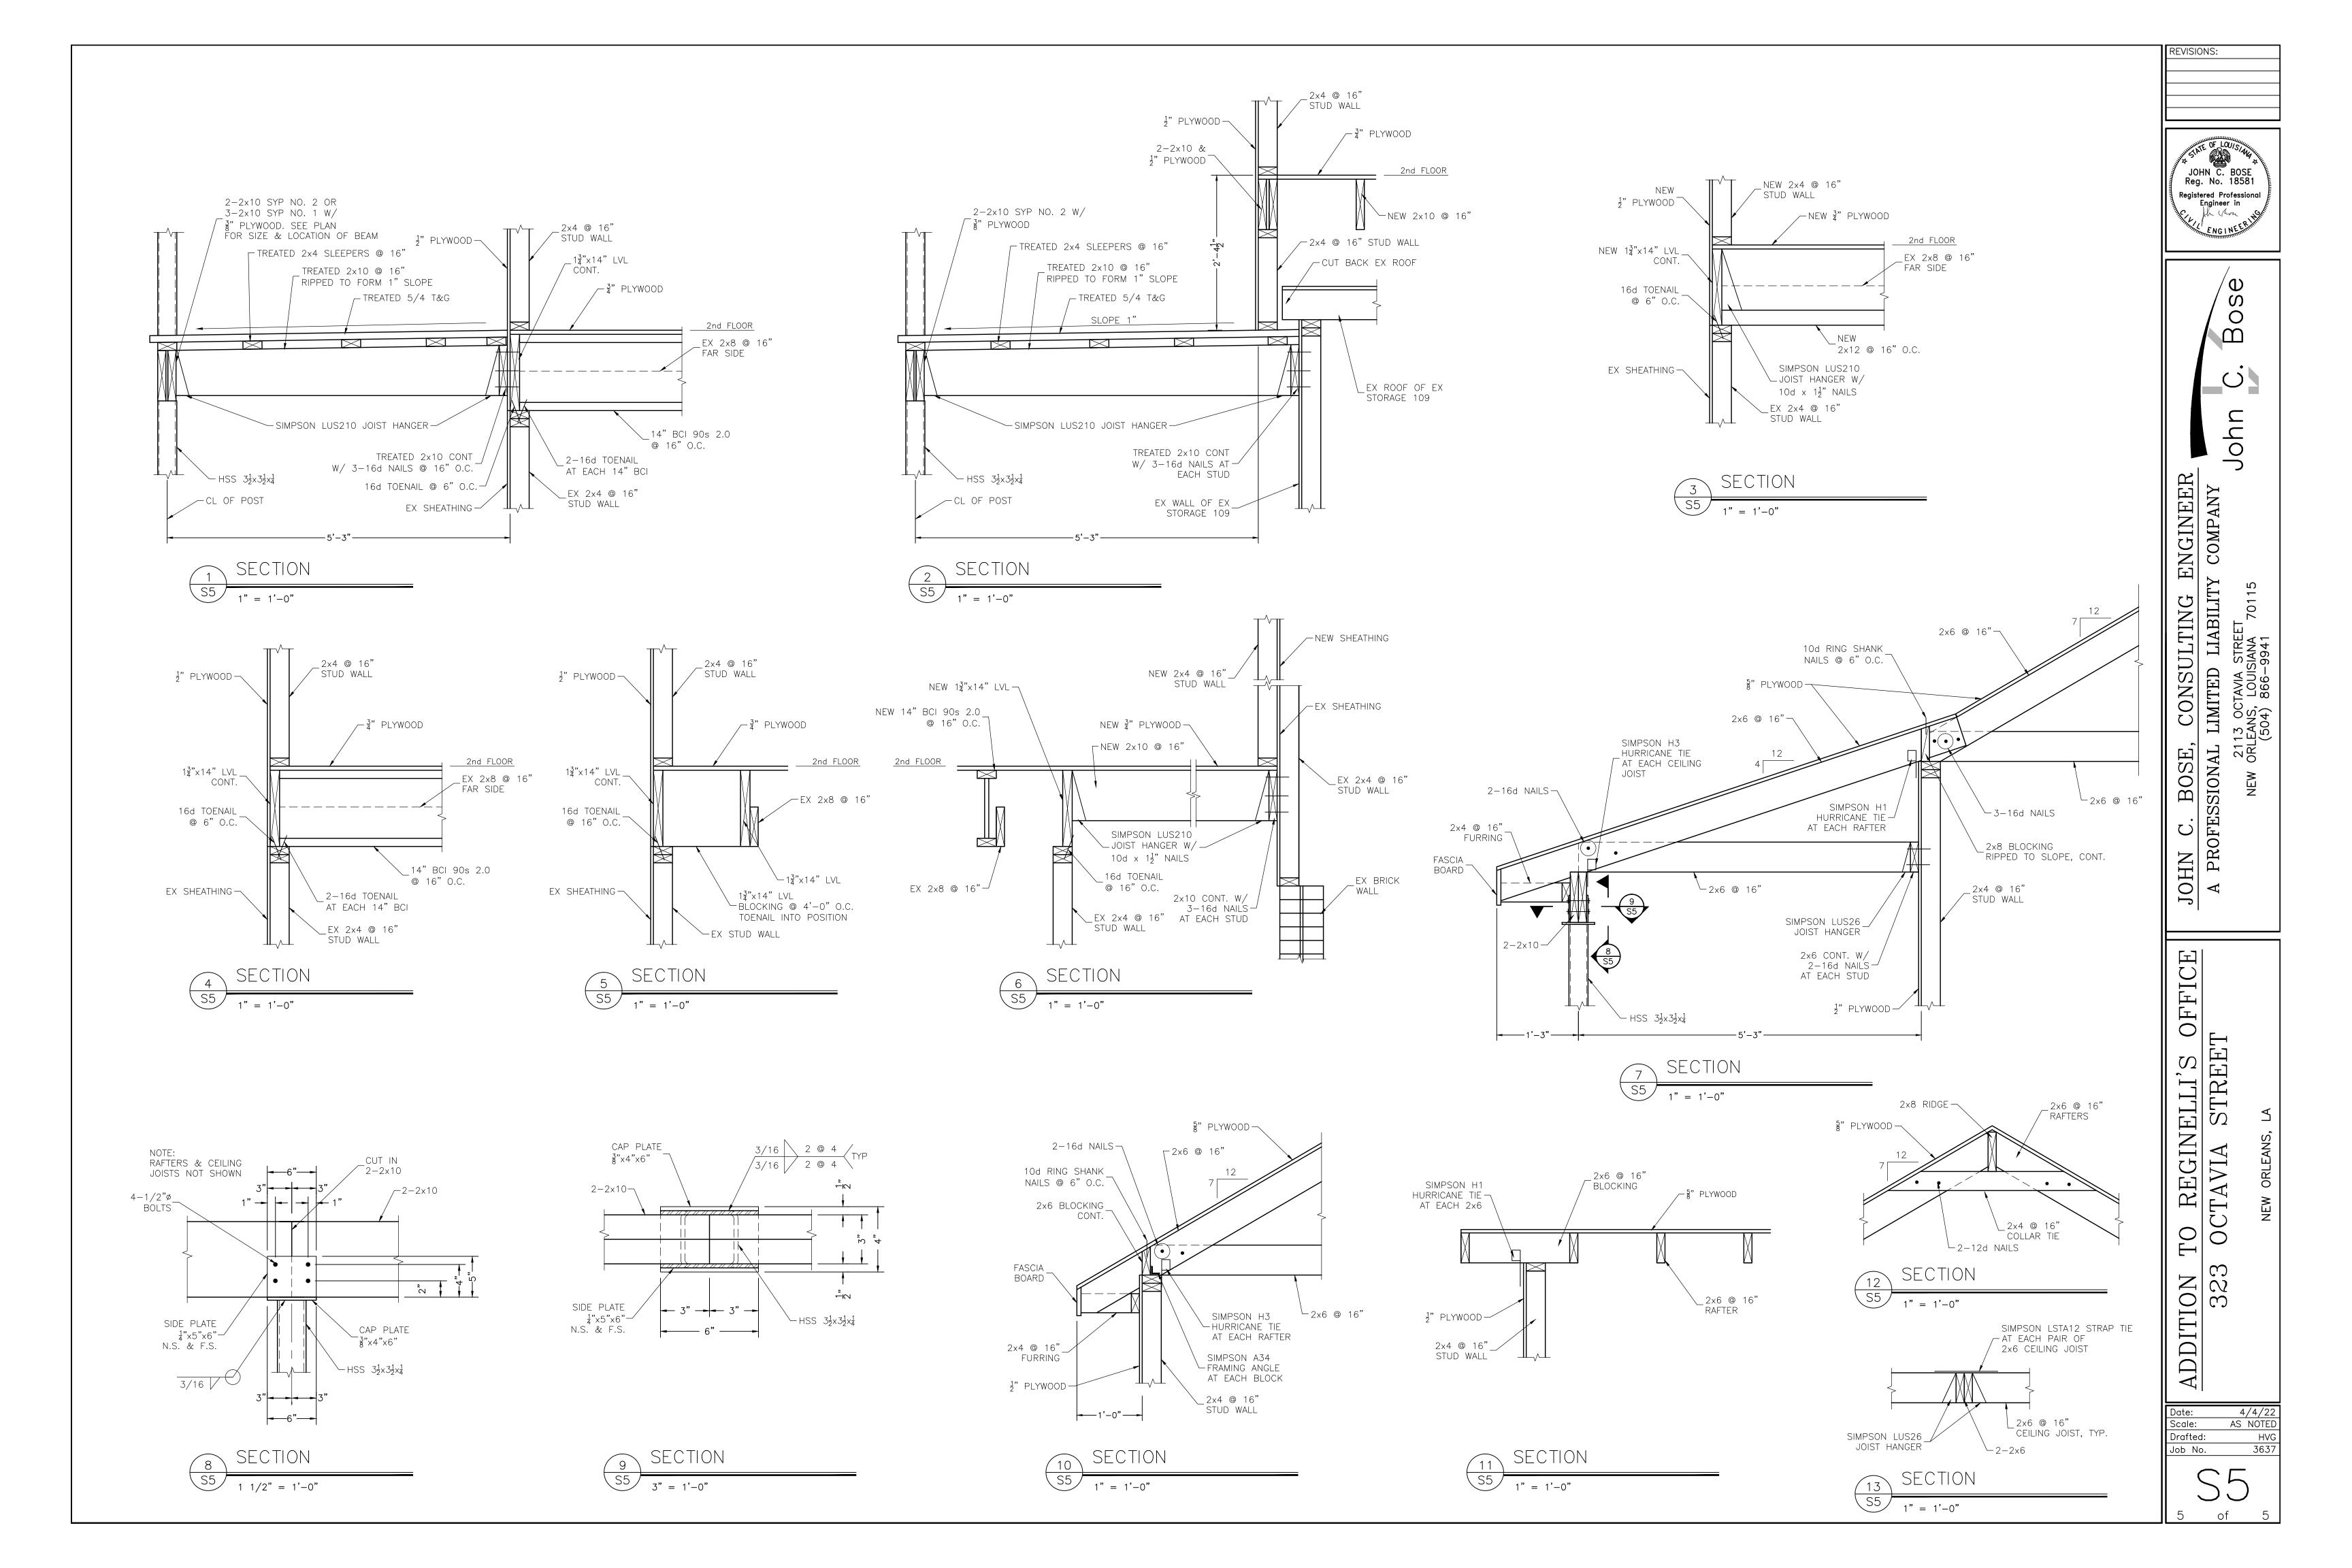

### **HVAC PLAN NOTES**

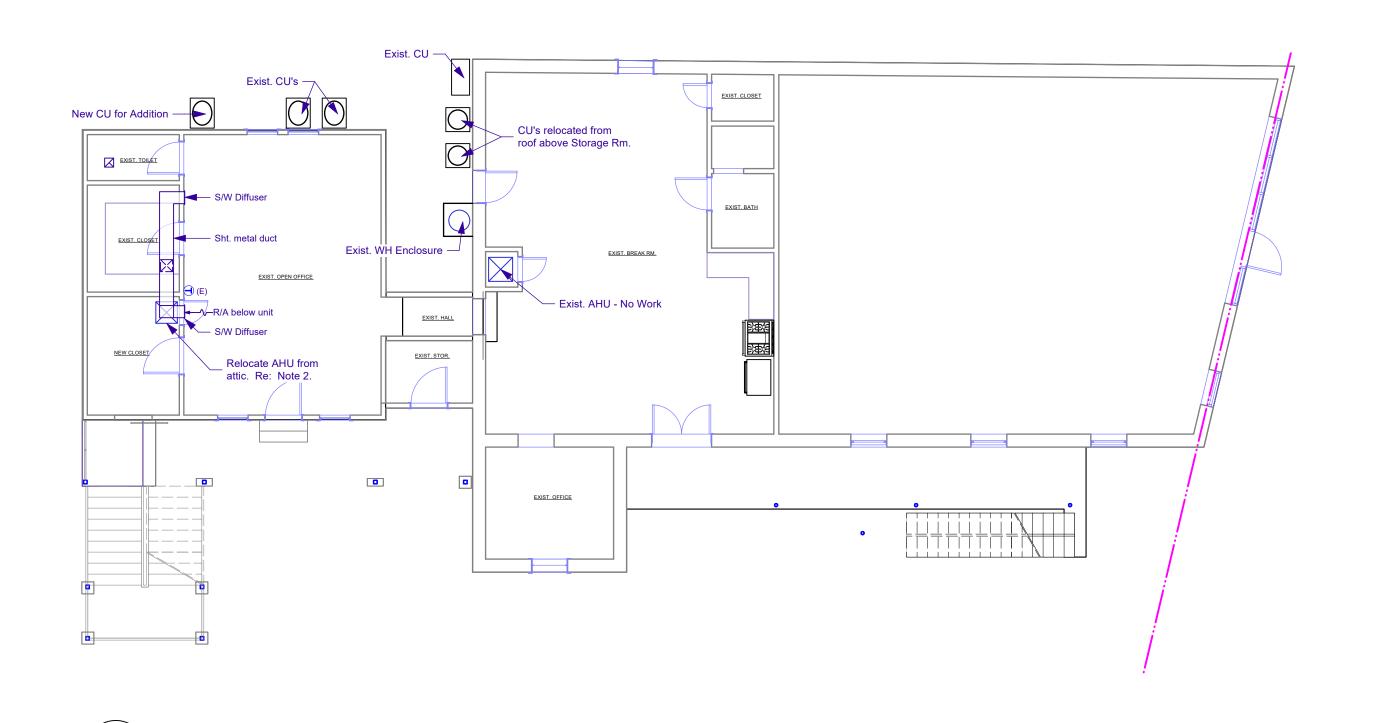- All A/C equipment shall be installed in accordance with NFPA Bulletin 90A and with local authorities rules and regualtions.
- 2. 1st Floor H.V.A.C.: Relocate existing AHU from attic space that is scheduled to be removed. Provide sheet metal duct to feed S/A Diffusers. Maintain existing CFM's.
- 3. 2nd Floor H.V.A.C.: Mech. Subcontractor to determine size of AHU/CU. Main S/A duct to be sheet metal w/ flex duct to each S/A diffuser. All S/A ductwork yo be runin the attic space of 2nd floor addition.
- 4. Mechanical Subcontractor shall perform Manual J-Load calculations to determine size of new 2nd floor unit.
- 5. All equipment will be installed as per manufacturer's specifications.
- 6. All ducts shall be constructed in accordance with SMACNA manual for low pressure ductwork or as per ASHRAE guide.
- 7. Metal gauges as per SMACNA recommendations.
- 8. All rectangular duct to be lined with 1" fiberglass, 1-1/2 lb. density with full coat adhesive.
- 9. Flexible duct connections to fan-coil units.
- 10. Flexible round duct to be class I, UL 181 listed. Wrap with 2" fiberglass witht vapor seal.
- 11. When required, smoke detectors will be installed to stop the fan in HVAC duct systems larger than 2000 cfm.
- 12. Each return air duct will have a 125 degree firestat to stop
- 13. Fire dampers will be installed in all outside air ducts.
- 14. Each take-off will have a manual damper.
- 15. Safe pan under each fan-coil unit.
- 16. Refrigerant lines sized as per manufacturer's recommendations.
- 17. Suction lines and condensate drain lines to be insulated with 1/2" Rubbertex, or approved equivalent.

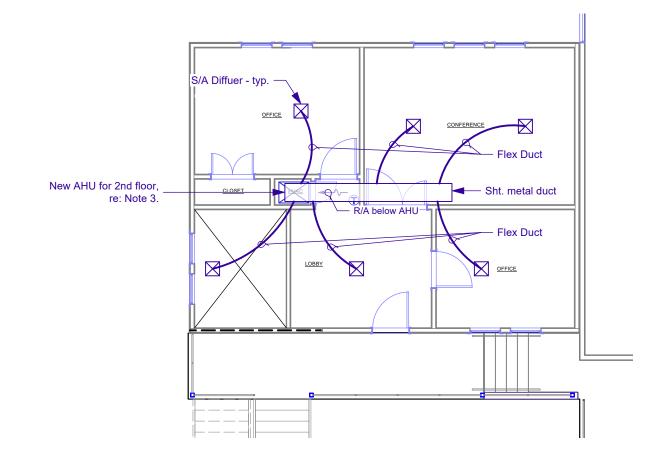

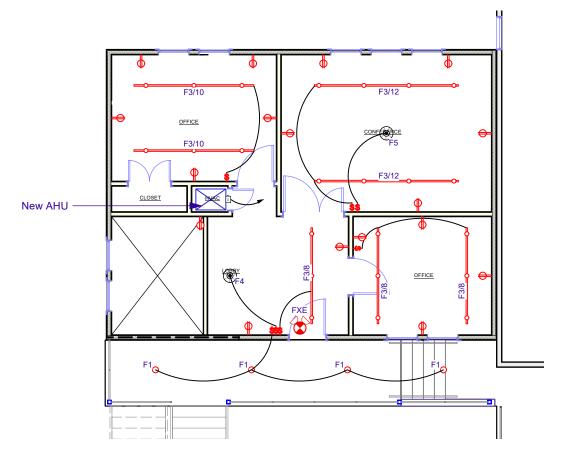



1ST FLOOR HVAC PLAN

ME1.0 Scale: 1/8" = 1'-0"







# **ELECTRICAL PLAN NOTES**

- All electrical work shall comply with NFPA 70, National Electrical Code.
- Comply with local and state codes, OSHA requirements, and national electrical code.
- All equipment, material, wire, switches and devices must be U.L. approved for service intended.
- 4. All wiring to be done by a licensed contractor. No sub-licensing will be allowed.
- All wiring to be copper.
- 6. All receptacle circuits up to 100'-0" shall utilize #12 conductors minimum. All receptacle circuits from 101'-0" to 150'-0" in length utilize #10 conductors minimum. All receptacle circuits from 151'-0" to 250'-0" in length utilize #8 conductors minimum. Circuits above 251'-0" shall utilize #6 conductors minimum.
- 7. Existing electrical service is existing to remain.
- 8. All A/C condensers and air handlers (new & existing) to have visible means to disconnect (fused).
- Contractor to coordinate with the Owner location of all Telelphone jacks and Data outlets.
- 10. All electrical outlets to be mounted @ 18" a.f.f., unless otherwise noted.
- 11. Verify with Owner location of all electrical outlets and switches prior to rough-in.
- 12. Electrical contractor shall make all final connections as required for a fully complete and operable system.
- 13. All receptacles to be mounted vertically, not horizontally.

# LIGHT FIXTURE TYPES

- 1. F1: Recessed 4 inch diameter LED downlight.
- 2. F2: Wall Mounted LED utility light.
- 3. F3: Pendant Mounted Light track with length in feet (F4/12'). Match existing track on 1st floor. Number of fixtures (LED) to be determined by the Owner.
- 4. F4: Pendant LED fixture for Lobby. Furnished by the Owner.
- 5. F5: Pendant LED fixture for Conference. Furnished by the Owner.
- FXE: Existing combination Exit/Emergency light w/ battery pack.



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ewed By GNK	Drawing Code ME1.0 [HVAC Duct Plan-1]			
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oct Mapager	Plot Date		414.602.5	Tological Collins
GNK	4/4/2022	No.	Date	Issue Notes

GARY N. KRASNO A R C H I T E C T, L L

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E-MAIL: gnkarch@att.net

ADDITION TO:
REGINELLI'S OFFICES
323 OCTAVIA ST.
NEW ORLEANS, LA 70115
H.V.A.C. PLANS; ELECTRICAL PLANS

Scale AS NOTED

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